

1 Cityplace Dr, Suite 490

Creve Coeur, MO 63141

Phone: (314) 513-0147

www.crowncastle.com

October 7th, 2022

Melanie A. Bachman Executive Director Connecticut Siting Council 10 Franklin Square New Britain, CT 06051

RE: Notice of Exempt Modification for Verizon Wireless

Crown Site ID# 876392; Verizon Site ID# 468137 115 Industrial Park Road, New Hartford, CT 06057 Latitude: 41° 53' 10.48" /Longitude: -72° 57' 58.10"

Dear Ms. Bachman:

Verizon currently maintains (12) antennas at the 147-foot mounts on the existing 168-foot Monopole Tower located at 115 Industrial Park Road, New Hartford, CT 06057. The property and the tower are owned by Crown Castle. Verizon now intends to remove (12) antennas and replace them with (9) antennas. This modification/proposal includes hardware that is both 4G(LTE) and 5G capable through remote software configuration and either or both services may be turned on or off at various times.

Planned Modifications:

Tower:

REMOVE AND REPLACE

- (6) Antel LPA-80080/CF antennas (**REMOVE**) (3) Samsung MT6407-77A Antennas with integrated RRUs (**REPLACE**)
- (3) Antel BXA-700-6CF Antennas (**REMOVE**); (3) Spare antennas (**REMOVE**); (6) JMA MX06FRO660-03 (**REPLACE**)

INSTALL

- (1) OVP: RFS DB-C1-12C-24AB-0Z
- (3) Commscope TD-8508-LTE78-43 Diplexers
- (3) Samsung RF4439D-25A RRH's

New mounting brackets

Ground:

REMOVE

(3) spare RRH's

This facility was approved by the Town of New Hartford Planning & Zoning Commission on August 9th, 2000 via Grant of Special Exception.

Creve Coeur, MO 63141

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Please accept this letter as notification pursuant to Regulations of Connecticut State Agencies §16-50j-73, for construction that constitutes an exempt modification pursuant to R.C.S.A. §16-50j-72(b)(2). In accordance with R.C.S.A. §16-50j-73, a copy of this letter is being sent to First Selectman, Mr. Daniel V. Jerram, Town of New Hartford, Zoning Enforcement Officer, Mr. Michael Lucas, Town of New Hartford. Global Signal/Crown Castle is the property & tower owner

- 1. The proposed modifications will not result in an increase in the height of the existing tower.
- 2. The proposed modifications will not require the extension of the site boundary.
- 3. The proposed modification will not increase noise levels at the facility by six decibels or more, or to levels that exceed state and local criteria.
- 4. The operation of the replacement antennas will not increase radio frequency emissions at the facility to a level at or above the Federal Communication Commission safety standard.
- 5. The proposed modifications will not cause a change or alteration in the physical or environmental characteristics of the site.
- 6. The existing structure and its foundation can support the proposed loading.

For the foregoing reasons, Verizon Wireless respectfully submits that the proposed modifications to the above- reference telecommunications facility constitutes an exempt modification under R.C.S.A. §16-50j-72(b)(2).

Sincerely, Katie Adams Crown Castle, Agent for Verizon Wireless kadams@nbcllc.com (781) 392-7547 cc:

> Daniel V. Jerram, First Selectman (Via Federal Express) 350 Main Street New Hartford, CT 06057 (860)-379-3389

Mr. Michael Lucas, Zoning Enforcement Officer (Via Federal Express) 350 Main Street New Hartford, CT 06057 (860)-379-7677

Crown Castle, Property Owner



1 Cityplace Dr, Suite 490

Creve Coeur, MO 63141

Phone: (314) 513-0147

www.crowncastle.com

Katie Adams

From: TrackingUpdates@fedex.com

Sent: Thursday, October 13, 2022 9:20 AM

To: Katie Adams

Subject: FedEx Shipment 770147396685: Your package is now out for delivery today



Hi. Your package is now out for delivery today.

SCHEDULED DELIVERY

Thu, 10/13/2022 before 4:30pm



OUT FOR DELIVERY WATERTOWN, CT

MANAGE DELIVERY

TRACKING NUMBER 770147396685

FROM NB+C

100 Apollo Drive

Suite 303

CHELMSFORD, MA, US, 01824

TO Town of New Hartford

Mr. Daniel V. Jerram, First Selectm

350 Main Street

NEW HARTFORD, CT, US, 06057

REFERENCE 100788

SHIPPER REFERENCE 100788

SHIP DATE Wed 10/12/2022 06:10 PM

PACKAGING TYPE FedEx Pak

ORIGIN CHELMSFORD, MA, US, 01824

DESTINATION NEW HARTFORD, CT, US, 06057


SPECIAL HANDLING Deliver Weekday

STANDARD TRANSIT Thu, 10/13/2022 by 4:30pm

NUMBER OF PIECES 1

TOTAL SHIPMENT WEIGHT 3.00 LB

SERVICE TYPE FedEx Standard Overnight

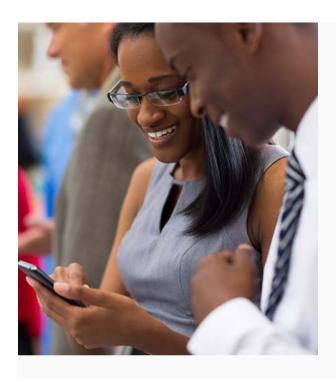

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- Download now.



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Please do not respond to this message. This email was sent from an unattended mailbox. This report was generated at approximately 8:19 AM CDT 10/13/2022.

All weights are estimated.

To track the latest status of your shipment, click on the tracking number above.

Standard transit is the date and time the package is scheduled to be delivered by, based on the selected service, destination and ship date. Limitations and exceptions may apply. Please see the FedEx Service Guide for terms and conditions of service, including the FedEx Money-Back Guarantee, or contact your FedEx Customer Support representative.

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Thank you for your business.

Katie Adams

From: TrackingUpdates@fedex.com

Sent: Thursday, October 13, 2022 9:13 AM

To: Katie Adams

Subject: FedEx Shipment 770147382987: Your package is now out for delivery today



Hi. Your package is now out for delivery today.

SCHEDULED DELIVERY

Thu, 10/13/2022 before 4:30pm



OUT FOR DELIVERY WATERTOWN, CT

MANAGE DELIVERY

TRACKING NUMBER 770147382987

FROM NB+C

100 Apollo Drive

Suite 303

CHELMSFORD, MA, US, 01824

TO Town of New Hartford

Mr. Michael Lucas, Zoning

350 Main Street

NEW HARTFORD, CT, US, 06057

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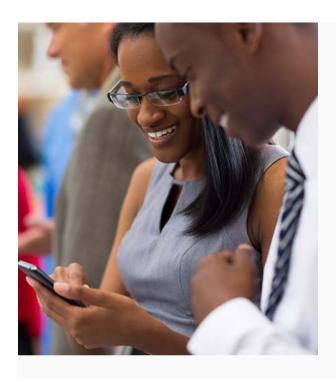
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Thank you for your business.

Exhibit A

Original Facility Approval



FAX COVER SHEET

DATE:

August 16, 2000

This transmission consists of this cover sheet and 1 page(s).

DELIVER 10:	COMPANY FIRM:	PAN NUMBER:	PHONE NUMBER:
Karen J. Nielsen	SPRINT PCS	201/ 684-4070	(201) 684-4064
RICH FEELEY	ATLANTIC WESTERN CONSULTING, INC.	401/949-8096	401/949-1605

FROM:

THOMAS J. REGAN

TELEPHONE:

DIRECT DIAL: (860) 509-6522

OUR FACSIMILE NUMBER IS: (860) 509-6501.

80563/1916/825



Attached is a copy of the Nonce of Decision "as published in the Hartford Courage on Wednesday August 16, 2000. The appeal period on this matter express on 8/31/00, as which time the Nonce will be recorded on the New Hartford Land Records.

IF YOU DO NOT RECEIVE ALL PAGES, PLEASE CALL (860) 509-6542 AND ASK FOR OFFICE SERVICES.

******CONFIDENTIALITY NOTE****

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A PARTNERSHIP OF PROFESSIONAL CORPORATIONS

City Place I 185 Asylum Street Hartford, CT Tel:(860)509-6500 Fax:(860)509-6501

Accusion Abhished (New Hartferd) 8/16/00



NOTICE OF DECISIONS TOWN OF NEW HARTFORD FLANKING AND ZOUING COMMISSION

The Planning and Zoning commission of a sec-cial meeting. Answell fin, Stanta Baricah he Hall, Bro-die Park, made the following decisions:

By untained vote, by approve the coplication of Mark & Helly Emps, positioninglish Childs, super-1 Lot State visits with a special exception for an interior in in R.2 2010-Town HIII Conductions condition.

By unablement upts, to oppose the application of Sprint Aperican L.P. Diff. Sprint PCS application of Sprint PCS applications like. Owner - Special Exception for the learn appropriate for the learn appropriate for the Peris Access Rocal with Site Pian approprial with 2 conditions.

Copiet of the applications are at file in the airless of the Planning and Zaning Commission of the New Harttand Town Hall, Broade Pank, West Hill Road, New Hartbard.

Daled this 18th day of Arquet, 2000 by Picnológ med Zoylas Commission Chairman, David Xrintoti.



NEW HARTFORD, CT 06057

Planning and Zoning Commission (860) 379-7677

August 14, 2000

Sprint Spectrum LP dba Sprint PCS, applicant Executive Greetings, Inc., owner 9 Barnes Industrial Road Wallingford, CT. 06492

Dear Sirs,

The Planning and Zoning Commission at a "Special" meeting, August 9, 2000 at Borkshire Hall, Brodie Park, made the following decision:

By unanimous approval, , that the application of Sprint Spectrum L.P. DBA Sprint PCS applicant/Executive Greetings Inc., Owner — Special Exception for a telecommunications tower in a IP zone — 115 Industrial Park Access Road be approved in the method described in the written and oral testimony of the applicant and its representative and according to the site plan supplied "Sprint PCS Wireless Communications Facility — CT33xC588, New Hartford, 115 Industrial Park Access Road, New Hartford, CT. prepared for Sprint Spectrum LP by Natcomm LLC, Branford, CT., dated 1/28/00, revised 2/24/00 (issued for zoning) and 4/14/200 (modified for wetlands commission and easement location) with the following conditions;

- That the review comments of the Town Engineer (3/15/00 & 6/29/200), the Town Planner (7/7/2000), and the radio frequency engineer (7/12/00 & 8/9/00) shall be incorporated into the plans with final determination for compliance by the Zoning Enforcement Officer.
- 2. Soil testing (as provided for in the regulations) shall be furnished prior to the issuance of a building permit.
- That the maximum 160 foot high monopole telecommunications tower be designed and constructed to allow additional co-locators.

The special exception for the telecommunications tower is approved according to the standards and criteria as set forth in Article VI, Antennas, Towers, and Wireless Communications Facilities of the Town of New Hartford Zoning Regulations and all of the above conditions as relating to special exception shall be in addition to the pertinent standards and criteria of Article V, Section 2. "General Standards and Requirements.

588

Fran BRFFE)

Appeal Period

Expires \$131100

Cert to be recorded

All (File for BP)

ICEPTION that corresponds with

Enclosed please find a GRANT OF SPECIAL EXCEPTION that corresponds with your approval. This Grant of Special Exception should be filed in the Town Clerk's Office at your earliest convenience. This filing ensures that your permit is made a permanent record on the land records in the Town of New Hartford. A \$18.00 fee payable to the Town of New Hartford is due upon filing of the permit.

Please contact Karl Nilsen, ZEO, in New Hartford Town Hall if you have any questions concerning this matter.

Respectfully yours,

David Krimmel, Chairman Planning and Zoning Commission

DK/kgn

BOOK 186 PAGE 0899

T-737 P.02/04 Job-449

000344

TOWN OF NEW HARTFORD GRANT OF SPECIAL EXCEPTION

On the application of

Sprint Spectrum LP dbs Sprint PCS applicant Executive Greetings Inc, owner 9 Barnes Industrial Road Wallingford, CT. 06492

the PLANNING AND ZONING COMMISSION

did grant a	Special Permit
	XXX Special Exception for a telecommunications tower in a IP zon
	115 Industrial Park Road
De	scription of Premises: Assessor's Aerial Map 038
	Assessor's Aerial Map 038

Block 134 Lot 15C Volume 145 page 451

Owners of record: Executive Greetings Inc.

The application of Sprint Spectrum L.P. DBA Sprint PCS applicant/Executive Greetings Inc., Owner — Special Exception for a telecommunications tower in a IP zone — 115 Industrial Park Access Road is approved in the method described in the written and oral testimony of the applicant and its representative and according to the site plan supplied "Sprint PCS Wireless Communications Facility — CT33xC588, New Hartford, 115 Industrial Park Access Road, New Hartford, CT, prepared for Sprint Spectrum LP by Natcomm LLC, Branford, CT., dated 1/28/00, revised 2/24/00(issued for zoning) and 4/14/200 (modified for wetlands commission and easement location) with the following conditions;

1. That the review comments of the Town Engineer (3/15/00 & 6/29/200), the Town Planner (7/7/2000), and the radio frequency engineer (7/12/00 & 8/9/00) shall be incorporated into the plans with final determination for compliance by the Zoning Enforcement Officer.

2. Soil testing (as provided for in the regulations) shall be furnished prior to the

issuance of a building permit.

**

3. That the maximum 160 foot high monopole telecommunications tower be designed and constructed to allow additional co-locators.


186 PAGE U 900 BUUK

The special exception for the telecommunications tower is approved according to the standards and criteria as set forth in Article VI, Antennas, Towers, and Wireless Communications Facilities of the Town of New Hartford Zoning Regulations and all of the above conditions as relating to special exception shall be in addition to the pertinent standards and criteria of Article V, Section 2. "General Standards and Requirements.

Certified this 10th day of August, 2000

David Krimmel, Chairman

Planning and Zoning Commission

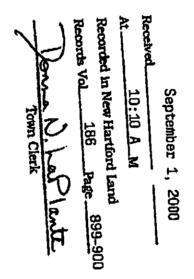

AFTER RECORDING, PLEASE RETURN TO: Thomas J. Regan, Esquire Brown Rudnick Freed & Gesmer 185 Asylum Street, 38th Floor Hartford, CT 06103-3402

TOWN OF NEW HARTFORD

530 MAIN STREET- TOWN HALL NEW HARTFORD, CT. 06057

INLAND WETLANDS COMMISSION (860-379-8830)

April 26, 2000

Sprint Spectrum LP.
9 Barnes Industrial Road
Wallingford, CT. 06492

To whom it may concern:

The Inland Wetlands Commission, at its regular meeting at Berkshire Hall, Brodie Park, on April 24th, 2000, made the following decision:

By a majority vote, to approve the application of Sprint Spectrum LP., applicant/
Executive Greetings, owner - Crossing of an intermittent watercourse for
the construction of a telecommunications tower - 120 Industrial Park Access Road as
presented as the method described in the written and oral testimony of the applicant and
according to the revised site plan provided as the method shows that there will no adverse
effects to the watercourse or wetlands on the property.

Feasible and prudent alternatives were explored and the commission's approval is based on the belief that the revised application as presented is the most reasonable and prudent available. As part of the permit granted, proper soil and erosion controls must be in place prior to the start of any construction and those controls are to inspected and approved by the Inland Wetlands Enforcement Officer prior to and during all phases of construction

Any information or assistance required concerning this decision should be directed to Mr. Paul Volovski, Inland Wetlands Enforcement officer at 379-8830 during regular Town Hall business hours.

Respectfully yours,

Alden Ringklib, Chairman

Inland Wetlands Commission

AR/kgn

Cc/Thomas J Regan, Brown Rudnick Freed & Gesmer

Exhibit B

Property Card



Property Listing Report

Map Block Lot

038-134-15C Bldg # **1** Sec #

1 PID 184722 Account

00284401

Property Information

Property Location	115 INDUSTRIAL PARK ROAD			
Owner	FRAMINGHAM COMMONS LLC			
Co-Owner	C/O GLOBAL SIGNAL ACQUISITION PMB 331			
Mailing Address	4017 WASHINGTON ROAD MCMURRAY PA 15317			
Land Use	4400 IND VACANT			
Land Class	I			
Zoning Code	IP			
Census Tract	3061/1002			

Neighborhood	С
Acreage	0.4
Utilities	Well,Septic
Lot Setting/Desc	Rural Level
Book / Page	0234/0515
Fire District	1

Primary Construction Details

0
IND VACANT
UNKNOWN
NA
NA
NA

Heating Fuel	
Heating Type	
AC Type	
Bedrooms	0
Full Bathrooms	0
Half Bathrooms	0
Extra Fixtures	0
Total Rooms	0
Bath Style	NA
Kitchen Style	NA
Fin Bsmt Area	
Fin Bsmt Quality	
Bsmt Gar	
Fireplaces	

Photo



Sketch



(*Industrial / Commercial Details)

,	
Building Use	Vacant
Building Condition	
Sprinkler %	NA
Heat / AC	NA
Frame Type	NA
Baths / Plumbing	NA
Ceiling / Wall	NA
Rooms / Prtns	NA
Wall Height	NA
First Floor Use	NA
Foundation	NA

Report Created On

3/25/2021

Town of New Hartford, CT

Property Listing Report

FRAMINGHAM COMMONS LLC

Map Block Lot

038-134-15C Bldg # **1** Sec #

1 PID 184722 Account

00284401

Valuation Sumr	mary (Ass	sessed value = 70	% of Appraised Value)	Sub Areas		
Item	Appra	aised	Assessed	Subarea Type	Gross Area (sq ft)	Living Area (sq ft)
Buildings	0		0			
Extras	0		0			
Improvements						
Outbuildings	98700		69090			
Land	324000		226800			
Total	422700		295890			
Outbuilding ar	nd Extra Fo	eatures				
Туре		Description	on			
Pre Cast Cell		300 S.F.				
Pre Cast Cell		240 S.F.				
Fence-8' Chain 400 L.		400 L.F.				
				Total Area	0	0
Sales History					1	•
Owner of Record				Book/ Page Sale	e Date Sale Pri	ce

0234/0515

2005-05-10

Exhibit C

Construction Drawings

verizon

VERIZON SITE NUMBER: 468137 VERIZON SITE NAME:

SITE TYPE:

TOWER HEIGHT:

NEW HARTFORD EXECUTIVE GREET MONOPOLE

168'-0"

BUSINESS UNIT #: 876392

115 INDUSTRIAL PARK RD **SITE ADDRESS:** NEW HARTFORD, CT 06057

COUNTY: LITCHFIELD

JURISDICTION: CT - CONNECTICUT

SITING COUNCIL

VERIZON FUZE PROJECT #: 16271985

SITE INFORMATION

LITCHFIELD

VERIEY

TBD

NEW HARTFORD N CT

41° 53' 10.5" N (41.88625°)

72° 57' 58.1004" W (-72.966139°)

CROWN CASTLE USA INC.

SITE ADDRESS: 115 INDUSTRIAL PARK RD NEW HARTFORD, CT 06057

COUNTY: MAP/PARCEL#: AREA OF CONSTRUCTION:

LONGITUDE

EXISTING LATITUDE:

LAT/LONG TYPE: NAD83 GROUND ELEVATION: 574.0'

CURRENT ZONING:

IURISDICTION CT - CONNECTICUT SITING COUNCIL OCCUPANCY CLASSIFICATION: U

TYPE OF CONSTRUCTION:

A.D.A. COMPLIANCE:

FACILITY IS UNMANNED AND NOT FOR

PROPERTY OWNER:

TOWER OWNER: CCATT LLC

1500 CORPORATE DRIVE

CANONSBURG, PA 15317

VERIZON WIRELESS CARRIER/APPLICANT: 180 WASHINGTON VALLEY ROAD

BEDMINSTER, NJ 07921

ELECTRIC PROVIDER

TELCO PROVIDER:

DRAWING INDEX

SHEET #	SHEET DESCRIPTION
T-1	TITLE SHEET
T-2	GENERAL NOTES
C-1	SITE PLAN
C-2	TOWER ELEVATION & ANTENNA PLANS
C-3	EQUIPMENT SCHEDULES
C-4	EQUIPMENT DETAILS
C-5	EQUIPMENT DETAILS
C-6	COLOR CODE
C-7	PLUMBING DIAGRAM
G-1	GROUNDING DETAILS
G-2	GROUNDING DETAILS

ALL DRAWINGS CONTAINED HEREIN ARE FORMATTED FOR 1X17. CONTRACTOR SHALL VERIFY ALL PLANS AND EXISTING DIMENSIONS AND CONDITIONS ON THE JOB SITE AND SHALL IMMEDIATELY NOTIFY THE ENGINEER IN WRITING OF ANY DISCREPANCIES BEFORE PROCEEDING WITH THE WORK OF BE RESPONSIBLE FOR SAME

APPROVALS

SIGNATURE DATE

PROJECT TEAM

A&E FIRM:

INFINIGY

500 WEST OFFICE CENTER DRIVE / SUITE 150 FORT WASHINGTON, PA 19034

CROWN CASTLE USA INC. DISTRICT CONTACTS:

3 CORPORATE PARK DRIVE, SUITE 101 CLIFTON PARK, NY 12065

TBD - PROIECT MANAGER

TBD - CONSTRUCTION MANAGER

VERIZON

ALEONE@STRUCTURECONSULTING.NET

CONTRACTOR PMI REQUIREMENTS

PMLACCESSED AT SMART TOOL VENDOR PROJECT NUMBER

VzW LOCATION CODE (PSLC)

6039-Z0001-C 468137

https://pmi.vxwsmart.com

*** PMI AND REQUIREMENTS ALSO EMBEDDED IN MOUNT

MOUNT MODIFICATION REQUIRED

VzW APPROVED SMART KIT VENDORS

REFER TO MOUNT MODIFICATION DRAWINGS PAGE FOR VzW SMART KIT APPROVED VENDORS



LOCATION MAP

DRIVING DIRECTIONS FROM VERIZON LOCAL OFFICE (180 WASHINGTON VALLEY RD, BEDMINSTER, NJ 07921) DEPART AND HEAD TOWARD WASHINGTON VALLEY RD / COUNTY HWY-620. TURN LEFT ONTO WASHINGTON VALLEY RD / COUNTY HWY-620. BEAR RIGHT ONTO US-206 N / US-202 N / US HIGHWAY 202 206. BEAR RIGH ONTO US-202 N / US-206 N / US HIGHWAY 202 206, TURN RIGHT ONTO SCHLEY MOUNTAIN RD, TAKE THE RAMP ON THE RIGHT FOR I-287 N, TAKE THE RAMP ON THE RIGHT FOR 1-287 / I-87 SOUTH AND HEAD TOWARD NEW YORK CITY / TAPPAN ZEE BR. TAKE THE RAMP ON THE RIGHT FOR I-87 SOUTH AND HEAD TOWARD NEW YORK CITY / SAW MILL PKWY S, TAKE THE RAMP FOR I-684 N, HEAD RIGHT ON THE RAMP FOR I-84 EAST TOWARD DANBURY, TAKE THE RAMP ON THE RIGHT FOR 84 EAST AND HEAD TOWARD WATERBURY, HEAD LEFT ON THE RAMP FOR CT-8 NORTH TOWARD TORRINGTON, TAKE THE RAMP AND HEAD TOWARD NEW IARTFORD / SKI AREA, TURN LEFT ONTO US-44 E / CT-183 / CT-8 / S MAIN ST TOWARD NEW HARTFORD / SKI AREA, TURN LEFT ONTO CT-219 / RESERVOIR RD, URN LEFT ONTO INDUSTRIAL PARK RD, ARRIVE AT 115 INDUSTRIAL PARK RD, NEW HARTFORD, CT 06057

APPLICABLE CODES/REFERENCE **DOCUMENTS**

ALL WORK SHALL BE PERFORMED AND MATERIALS INSTALLED IN ACCORDANCE WITH THE CURRENT EDITIONS OF THE FOLLOWING CODES AS ADOPTED BY THE LOCAL GOVERNING AUTHORITIES. NOTHING IN THESE PLANS IS TO BE CONSTRUED TO PERMIT WORK NOT CONFORMING TO THESE CODES:

CODE TYPE 2018 CT STATE BUILDING CODE

MECHANICAL

ELECTRICAL

REFERENCE DOCUMENTS:

STRUCTURAL ANALYSIS: TBD DATED:

MOUNT ANALYSIS: MASER CONSULTING

DATED: 04/25/2022 RFDS REVISION:

DATED: 12/16/2021 ORDER ID: 552670

CALL CONNECTICUT ONE CALL

PROJECT DESCRIPTION

THE PURPOSE OF THIS PROJECT IS TO ENHANCE BROADBAND CONNECTIVITY AND CAPACITY TO THE EXISTING ELIGIBLE

TOWER SCOPE OF WORK:

- REMOVE (12) ANTENNAS INSTALL (3) MT6407-77A INTEGRATED RADIO/ANTENNAS • INSTALL (6) ANTENNAS
- INSTALL (3) DIPLEXERS
- INSTALL (6) RRUS
- INSTALL (1) OVP
- INSTALL (1) HYBRID CABLE • INSTALL (1) KICKER KIT
- INSTALL (3) SUPPORT RAIL CORNER BRACKET

GROUND SCOPE OF WORK:

PRIOR TO ACCESSING/ENTERING THE SITE YOU MUST CONTACT THE CROWN NOC AT (800) 788-7011 & CROWN CONSTRUCTION MANAGER





CLIFTON PARK, NY 12065

500 West Office Center Dr. Suite 150 | Fort Washington, PA 19034 www.infinigy.com

VERIZON SITE NUMBER: 468137

BU #: 876392 NEW HARTFORD N CT

115 INDUSTRIAL PARK RD NEW HARTFORD, CT 06057

EXISTING 168'-0" MONOPOLE

	ISSUED FOR:					
REV	DATE	DRWN	DESCRIPTION	DES./QA		
0	06/21/2021	RCD	FINAL CDs			
1	04/08/2021	PEG	FINAL CDs			
2	05/13/2022	RCD	FINAL CDs			
1						



IT IS A VIOLATION OF LAW FOR ANY PERSON UNLESS THEY ARE ACTING UNDER THE DIRECTION OF A LICENSED PROFESSIONAL ENGINEER,

CROWN CASTLE USA INC. SITE ACTIVITY REQUIREMENTS:

- NOTICE TO PROCEED- NO WORK SHALL COMMENCE PRIOR TO CROWN CASTLE USA INC. WRITTEN NOTICE TO PROCEED (NTP) AND THE ISSUANCE OF A PURCHASE ORDER. PRIOR TO ACCESSING/ENTERING THE STUDY OF THE CROWN CASTLE USA INC. NOC AT 800-788-7011 & THE CROWN CASTLE USA INC. CONSTRUCTION MANAGER.
- "LOOK UP" CROWN CASTLE USA INC. SAFETY CLIMB REQUIREMENT: THE INTEGRITY OF THE SAFETY CLIMB AND ALL COMPONENTS OF THE CLIMBING FACILITY SHALL BE CONSIDERED DURING ALL STAGES OF DESIGN, INSTALLATION, AND INSPECTION. TOWER MODIFICATION, MOUNT REINFORCEMENTS, AND/OR EQUIPMENT INSTALLATIONS SHALL NOT COMPROMISE THE INTEGRITY OR FUNCTIONAL USE OF THE SAFETY CLIMB OR ANY COMPONENTS OF THE CLIMBING FACILITY ON THE STRUCTURE. THIS SHALL INCLUDE, BUT NOT BE LIMITED TO: PINCHING OF THE WIRE ROPE, BENDING OF THE WIRE ROPE FROM ITS SUPPORTS, DIRECT CONTACT OR CLOSE PROXIMITY TO THE WIRE ROPE WHICH MAY CAUSE FRICTIONAL WEAR, IMPACT TO THE ANCHORAGE POINTS IN ANY WAY, OR TO IMPEDE/BLOCK ITS INTENDED USE. ANY COMPROMISED SAFETY CLIMB, INCLUDING EXISTING CONDITIONS MUST BE TAGGE AND REPORTED TO YOUR CROWN CASTLE USA INC. POC OR CALL THE NOC TO GENERATE A SAFET MAINTENANCE AND CONTRACTOR NOTICE TICKET.
- PRIOR TO THE START OF CONSTRUCTION, ALL REQUIRED JURISDICTIONAL PERMITS SHALL BE OBTAINED. THIS INCLUDES, BUT IS NOT LIMITED TO, BUILDING, ELECTRICAL, MECHANICAL, FIRE, FLOOD ZONE, ENVIRONMENTAL, AND ZONING. AFTER ONSITE ACTIVITIES AND CONSTRUCTION ARE COMPLETED, ALL REQUIRED PERMITS SHALL BE SATISFIED AND CLOSED OUT ACCORDING TO LOCAL JURISDICTIONAL REQUIREMENTS
- ALL CONSTRUCTION MEANS AND METHODS; INCLUDING BUT NOT LIMITED TO, ERECTION PLANS, RIGGING PLANS, CILMBING PLANS, AND RESCUE PLANS SHALL BE THE RESPONSIBILITY OF THE GENERAL CONTRACTOR RESPONSIBLE FOR THE EXECUTION OF THE WORK CONTAINED HEREIN, AND SHALL MEET ANSI/ASSE A10.48 (LATEST EDITION); FEDERAL, STATE, AND LOCAL REGULATIONS; AND ANY APPLICABLE INDUSTRY CONSENSUS STANDARDS RELATED TO THE CONSTRUCTION ACTIVITIES BEING PERFORMED. ALL RIGGING PLANS SHALL ADHERE TO ANSI/ASSE A10.48 (LATEST EDITION) AND CROWN CASTLE USA INC. STANDARD CED-STD-10253, INCLUDING THE REQUIRED INVOLVEMENT OF A QUALIFIED ENGINEER FOR CLASS IV CONSTRUCTION, TO CERTIFY THE SUPPORTING STRUCTURE(S) IN ACCORDANCE WITH ANSI/TIA-322
- ALL SITE WORK TO COMPLY WITH DAS-STD-10068 "INSTALLATION STANDARDS FOR CONSTRUCTION ACTIVITIES ON CROWN CASTLE USA INC. TOWER SITE," CED-STD-10294 "STANDARD FOR INSTALLATION OF MOUNTS AND APPURTENANCES," AND LATEST VERSION OF ANSI/TIA-1019-A-2012 "STANDARD FOR INSTALLATION, ALTERATION, AND MAINTENANCE OF ANTENNA SUPPORTING STRUCTURES AND ANTENNAS." IF THE SPECIFIED EQUIPMENT CAN NOT BE INSTALLED AS SHOWN ON THESE DRAWINGS, THE CONTRACTOR
- SHALL PROPOSE AN ALTERNATIVE INSTALLATION FOR APPROVAL BY CROWN CASTLE USA INC. PRIOR TO PROCEEDING WITH ANY SUCH CHANGE OF INSTALLATION.
- ALL MATERIALS FURNISHED AND INSTALLED SHALL BE IN STRICT ACCORDANCE WITH ALL APPLICABLE CODES, REGULATIONS AND ORDINANCES. CONTRACTOR SHALL ISSUE ALL APPROPRIATE NOTICES AND COMPLY WITH ALL LAWS, ORDINANCES, RULES, REGULATIONS AND LAWFUL ORDERS OF ANY PUBLIC AUTHORITY REGARDING THE PERFORMANCE OF THE WORK, ALL WORK CARRIED OUT SHALL COMPLY V ALL APPLICABLE MUNICIPAL AND UTILITY COMPANY SPECIFICATIONS AND LOCAL JURISDICTIONAL CODES. ORDINANCES AND APPLICABLE REGULATIONS
- THE CONTRACTOR SHALL INSTALL ALL EQUIPMENT AND MATERIALS IN ACCORDANCE WITH MANUFACTURER'S RECOMMENDATIONS UNLESS SPECIFICALLY STATED OTHERWISE.
- RECOMMENDATIONS UNLESS SPECIFICALLY STATED OTHERWISE.

 9. THE CONTRACTOR SHALL CONTACT UTILITY LOCATING SERVICES PRIOR TO THE START OF CONSTRUCTION.

 10. ALL EXISTING ACTIVE SEWER, WATER, GAS, ELECTRIC AND OTHER UTILITIES WHERE ENCOUNTERED IN THE WORK, SHALL BE PROTECTED AT ALL TIMES AND WHERE REQUIRED FOR THE PROPER EXECUTION OF THE WORK, SHALL BE RELOCATED AS DIRECTED BY CONTRACTOR EXTREME CAUTION SHOULD BE USED BY THE CONTRACTOR WHEN EXCAVATING OR DRILLING PIERS AROUND OR NEAR UTILITIES. CONTRACTOR SHALL PROVIDE SAFETY TRAINING FOR THE WORKING CREW. THIS WILL INCLUDE BUT NOT BE LIMITED TO A) FALL PROTECTION B) CONSINTED REASES. PROTECTION B) CONFINED SPACE C) ELECTRICAL SAFETY D) TRENCHING AND EXCAVATION E) CONSTRUCTION SAFFTY PROCEDURES
- ALL SITE WORK SHALL BE AS INDICATED ON THE STAMPED CONSTRUCTION DRAWINGS AND PROJECT SPECIFICATIONS, LATEST APPROVED REVISION.
- CONTRACTOR SHALL KEEP THE SITE FREE FROM ACCUMULATING WASTE MATERIAL, DEBRIS, AND TRASH AT THE COMPLETION OF THE WORK. IF NECESSARY, RUBBISH, STUMPS, DEBRIS, STICKS, STONES AND OTHER REFUSE SHALL BE REMOYED FROM THE SITE AND DISPOSED OF LEGALI, PARTIES AND STREET OF LEGALIES FROM THE SITE AND DISPOSED OF LEGALIES. WHICH INTERFERE WITH THE ALL EXISTING INACTIVE SEWER, WATER, GAS, ELECTRIC AND OTHER UTILITIES, WHICH INTERFERE WITH THE
- EXECUTION OF THE WORK, SHALL BE REMOVED AND/OR CAPPED, PLUGGED OR OTHERWISE DISCONTINUED AT POINTS WHICH WILL NOT INTERFERE WITH THE EXECUTION OF THE WORK, SUBJECT TO THE APPROVAL OF CONTRACTOR, TOWER OWNER, CROWN CASTLE USA INC., AND/OR LOCAL UTILITIES.
- THE CONTRACTOR SHALL PROVIDE SITE SIGNAGE IN ACCORDANCE WITH THE TECHNICAL SPECIFICATION FOR SITE SIGNAGE REQUIRED BY LOCAL JURISDICTION AND SIGNAGE REQUIRED ON INDIVIDUAL PIECES OF EQUIPMENT, ROOMS, AND SHELTERS.
- THE SITE SHALL BE GRADED TO CAUSE SURFACE WATER TO FLOW AWAY FROM THE CARRIER'S EQUIPMENT
- 16. THE SUB GRADE SHALL BE COMPACTED AND BROUGHT TO A SMOOTH UNIFORM GRADE PRIOR TO FINISHED SURFACE APPLICATION.

CONTRACTOR SHALL MINIMIZE DISTURBANCE TO EXISTING SITE DURING CONSTRUCTION, EROSION CONTRO

- THE AREAS OF THE OWNERS PROPERTY DISTURBED BY THE WORK AND NOT COVERED BY THE TOWER, EQUIPMENT OR DRIVEWAY, SHALL BE GRADED TO A UNIFORM SLOPE, AND STABILIZED TO PREVENT EROSION AS SPECIFIED ON THE CONSTRUCTION DRAWINGS AND/OR PROJECT SPECIFICATIONS.
- MEASURES, IF REQUIRED DURING CONSTRUCTION, SHALL BE IN CONFORMANCE WITH THE LOCAL GUIDELINES FOR EROSION AND SEDIMENT CONTROL. THE CONTRACTOR SHALL PROTECT EXISTING IMPROVEMENTS, PAVEMENTS, CURBS, LANDSCAPING AND
- STRUCTURES. ANY DAMAGED PART SHALL BE REPAIRED AT CONTRACTOR'S EXPENSE TO THE SATISFACTION 20. CONTRACTOR SHALL LEGALLY AND PROPERLY DISPOSE OF ALL SCRAP MATERIALS SUCH AS COAXIAL
- CABLES AND OTHER ITEMS REMOVED FROM THE EXISTING FACILITY. ANTENNAS REMOVED SHALL BE RETURNED TO THE OWNER'S DESIGNATED LOCATION.
- CONTRACTOR SHALL LEAVE PREMISES IN CLEAN CONDITION. TRASH AND DEBRIS SHOULD BE REMOVED FROM SITE ON A DAILY BASIS.
- NO FILL OR EMBANKMENT MATERIAL SHALL BE PLACED ON FROZEN GROUND. FROZEN MATERIALS, SNOW OR ICE SHALL NOT BE PLACED IN ANY FILL OR EMBANKMENT.

GENERAL NOTES:

- FOR THE PURPOSE OF CONSTRUCTION DRAWING, THE FOLLOWING DEFINITIONS SHALL APPLY:
 CONTRACTOR: GENERAL CONTRACTOR RESPONSIBLE FOR CONSTRUCTION
 CARRIER: VERIZON
 - FOWER OWNER: CROWN CASTLE USA INC.
- TOWER OWNER: CROWN CASTLE USA INC.
 THESE DRAWINGS HAVE BEEN PREPARED USING STANDARDS OF PROFESSIONAL CARE AND COMPLETENESS NORMALLY
 EXERCISED UNDER SIMILAR CIRCUMSTANCES BY REPUTABLE ENGINEERS IN THIS OR SIMILAR LOCALITIES. IT IS
 ASSUMED THAT THE WORK DEPICTED WILL BE PERFORMED BY AN EXPERIENCED CONTRACTOR AND/OR WORKPEOPLE
 WHO HAVE A WORKING KNOWLEDGE OF THE APPLICABLE CODE STANDARDS AND REQUIREMENTS AND OF INDUSTRY
 ACCEPTED STANDARD GOOD PRACTICE. AS NOT EVERY CONDITION OR ELEMENT IS (OR CAN BE) EXPLICITLY SHOWN ON THESE DRAWINGS, THE CONTRACTOR SHALL USE INDUSTRY ACCEPTED STANDARD GOOD PRACTICE FOR MISCELLANEOUS WORK NOT EXPLICITLY SHOWN.
- MISCELLANEOUS WORK NOT EXPLICITLY SHOWN.
 THESE DRAWINGS REPRESENT THE FINISHED STRUCTURE. THEY DO NOT INDICATE THE MEANS OR METHODS OF
 CONSTRUCTION. THE CONTRACTOR SHALL BE SOLELY RESPONSIBLE FOR THE CONSTRUCTION MEANS, METHODS,
 TECHNIQUES, SEQUENCES, AND PROCEDURES. THE CONTRACTOR SHALL PROVIDE ALL MEASURES NECESSARY FOR
 PROTECTION OF LIFE AND PROPERTY DURING CONSTRUCTION. SUCH MEASURES SHALL INCLUDE, BUT NOT BE LIMITED
 TO, BRACING, FORMWORK, SHORING, ETC. SITE VISITS BY THE ENGINEER OR HIS REPRESENTATIVE WILL NOT INCLUDE
 INSPECTION OF THESE ITEMS AND IS FOR STRUCTURAL OBSERVATION OF THE FINISHED STRUCTURE ONLY.
 NOTES AND DETAILS IN THE CONSTRUCTION DRAWINGS SHALL TAKE PRECEDENCE OVER GENERAL NOTES AND TYPICAL
 DETAILS. WHERE NO DETAILS ARE SHOWN, CONSTRUCTION SHALL CONFORM TO SIMILAR WORK ON THE PROJECT,
 AND/OR AS PROVIDED FOR IN THE CONTRACT DOCUMENTS. WHERE DISCREPANCIES OCCUR BETWEEN PLANS, DETAILS,
 GENERAL NOTES, AND SPECIFICATIONS, THE GREATER, MORE STRICT REQUIREMENTS, SHALL GOVERN. IF FURTHER
 CLARIFICATION IS REQUIRED CONTACT THE ENGINEER OF RECORD.
 SUBSTANTIAL EFFORT HAS BEEN MADE TO PROVIDE ACCURATE DIMENSIONS AND MEASUREMENTS ON THE DRAWINGS TO
 ASSIST IN THE FABRICATION AND OR PLACEMENT OF CONSTRUCTION ELEMENTS BUT IT IS THE SOLE RESPONSIBILITY.
- ASSIST IN THE FABRICATION AND/OR PLACEMENT OF CONSTRUCTION ELEMENTS BUT IT IS THE SOLE RESPONSIBILITY OF THE CONTRACTOR TO FIELD VERIFY THE DIMENSIONS, MEASUREMENTS, AND/OR CLEARANCES SHOWN IN THE CONSTRUCTION DRAWINGS PRIOR TO FABRICATION OR CUTTING OF ANY NEW OR EXISTING CONSTRUCTION ELEMENTS.
- OF THE CONTINGATION TO FIELD VERIFY THE DIMENSIONS, MEASUREMENTS, AND/OR CLEAKARALES SHOWN IN THE CONSTRUCTION DRAWINGS PRIOR TO FABRICATION OR CUTTING OF ANY NEW OR EXISTING CONSTRUCTION ELEMENTS. IF IT IS DETERMINED THAT THERE ARE DISCREPANCIES AND/OR CONFLICTS WITH THE CONSTRUCTION DRAWINGS THE ENGINEER OF RECORD IS TO BE NOTIFIED AS SOON AS POSSIBLE. PRIOR TO THE SUBMISSION OF BIDS, THE BIDDING CONTRACTOR SHALL WISIT THE CELL SITE TO FAMILIARIZE WITH THE EXISTING CONDITIONS AND TO CONFIRM THAT THE WORK CAN BE ACCOMPLISHED AS SHOWN ON THE CONSTRUCTION DRAWINGS, ANY DISCREPANCY FOUND SHALL BE BROUGHT TO THE ATTENTION OF CROWN CASTLE. ALL MATERIALS FURNISHED AND INSTALLED SHALL BE BROUGHT TO THE ATTENTION OF CROWN CASTLE. ALL MATERIALS FURNISHED AND INSTALLED SHALL BE IN STRICT ACCORPOANCE WITH ALL APPLICABLE CODES, REGULATIONS AND ORDINANCES, CONTRACTOR SHALL ISSUE ALL APPROPRIATE NOTICES AND COMPLY WITH ALL LAWS, ORDINANCES, RULES, REGULATIONS AND LAWFUL ORDERS OF ANY PUBLIC AUTHORITY REGARDING THE PERFORMANCE OF THE WORK, ALL WORK CARRIED OUT SHALL COMPLY WITH ALL APPLICABLE MUNICIPAL AND UTILITY COMPANY SPECIFICATIONS AND LOCAL JURISDICTIONAL CODES, ORDINANCES AND APPLICABLE REGULATIONS. UNLESS NOTED OTHERWISE, THE WORK SHALL INCLUE FUNNISHING MATERIALS, EQUIPMENT, APPURTENANCES AND LABOR NECESSARY TO COMPLETE ALL INSTALLATIONS AS INDICATED ON THE DRAWINGS. THE CONTRACTOR SHALL INSTALLATIONS AND ATTERIALS IN ACCORDANCE WITH MANUFACTURER'S RECOMMENDATIONS UNLESS SPECIFICALLY STATED OTHERWISE.

 IF THE SPECIFIED EQUIPMENT CAN NOT BE INSTALLED AS SHOWN ON THESE DRAWINGS, THE CONTRACTOR SHALL PROPOSE AN ALTERNATIVE INSTALLATION FOR APPROVAL BY THE CARRIER AND CROWN CASTLE PRIOR TO PROCEEDING WITH ANY SUCH CHANGE OF INSTALLATION FOR APPROVAL BY THE CARRIER AND CROWN CASTLE PRIOR TO PROCEEDING WITH ANY SUCH CHANGE OF INSTALLATION FOR APPROVAL BY THE CARRIER AND CROWN CASTLE PRIOR TO PROCEEDING WITH ANY SUCH CHANGE OF INSTALLATION AND IS TO DETERMINE THE BEST ROUTING OF ALL CONDUITS FOR POWER, AND TELCO AND FOR GR

- THE CONTRACTOR SHALL PROTECT EXISTING IMPROVEM<mark>ENTS, PAVEMENTS, CURBS, LANDS</mark>CAPING AND STRUCTURES, ANY
- DAMAGED PART SHALL BE REPAIRED AT CONTRACTOR'S EXPENSE TO THE SATISFACTION OF CROWN CASTLE USA INC.
 CONTRACTOR SHALL LEGALLY AND PROPERLY DISPOSE OF ALL SCRAP MATERIALS SUCH AS COAXIAL CABLES AND
 OTHER ITEMS REMOVED FROM THE EXISTING FACILITY. ANTENNAS REMOVED SHALL BE RETURNED TO THE OWNER'S DESIGNATED LOCATION
- CONTRACTOR SHALL LEAVE PREMISES IN CLEAN CO<mark>NDITION. TRASH AND DEBRIS</mark> SHOULD BE REMOVED FROM SITE ON

CONCRETE, FOUNDATIONS, AND REINFORCING STEEL:

- ALL CONCRETE WORK SHALL BE IN ACCORDANCE WITH THE ACI 301, ACI 318, ACI 336, ASTM A184, ASTM A185 AND THE DESIGN AND CONSTRUCTION SPECIFICATION FOR CAST—IN—PLACE CONCRETE.

 UNLESS NOTED OTHERWISE, SOIL BEARING PRESSURE USED FOR DESIGN OF SLABS AND FOUNDATIONS IS ASSUMED TO BE 1000 psf.
- ALL CONCRETE SHALL HAVE A MINIMUM COMPRESSIVE STRENGTH (f'c) OF 3000 psi AT 28 DAYS, UNLESS NOTED OTHERWISE. NO MORE THAN 90 MINUTES SHALL ELAPSE FROM BATCH TIME TO TIME OF PLACEMENT UNLESS APPROVED BY THE ENGINEER OF RECORD. TEMPERATURE OF CONCRETE SHALL NOT EXCEED 90'F AT TIME OF
- CONCRETE EXPOSED TO FREEZE—THAW CYCLES SHALL CONTAIN AIR ENTRAINING ADMIXTURES. AMOUNT OF AIR ENTRAINMENT TO BE BASED ON SIZE OF AGGREGATE AND F3 CLASS EXPOSURE (VERY SEVERE). CEMENT USED TO BE TYPE II PORTLAND CEMENT WITH A MAXIMUM WATER-TO-CEMENT RATIO (W/C) OF 0.45.
- ALL STEEL REINFORCING SHALL CONFORM TO ASTM A615. ALL WELDED WIRE FARRIC (WWF) SHALL CONFORM TO ASTM A185. ALL SPLICES SHALL BE CLASS "B" TENSION SPLICES, UNLESS NOTED OTHERWISE. ALL HOOKS SHALL BE STANDARD 90 DEGREE HOOKS, UNLESS NOTED OTHERWISE. YIELD STRENGTH (Fy) OF STANDARD DEFORMED BARS ARE SECULOWED. AS FOLLOWS: #4 BARS AND SMALLER
- ON DRAWINGS
- CONCRETE CAST AGAINST AND PERMANENTLY EXPOSED TO EARTH... CONCRETE EXPOSED TO EARTH OR WEATHER
 #6 BARS AND LARGER.....
- #5 BARS AND SMALLER. $.1-1/2^{*}$ CONCRETE NOT EXPOSED TO FARTH OR WEATHER:
- SLAB AND WALLS. BEAMS AND COLUMNS. A TOOLED EDGE OR A 3/4" CHAMFER SHALL BE PROVIDED AT ALL EXPOSED EDGES OF CONCRETE, UNLESS NOTED OTHERWISE, IN ACCORDANCE WITH ACI 301 SECTION 4.2.4.

GREENFIELD GROUNDING NOTES:

- ALL GROUND ELECTRODE SYSTEMS (INCLUDING TELECOMMUNICATION, RADIO, LIGHTNING PROTECTION AND AC POWER GES'S) SHALL BE BONDED TOGETHER AT OR BELOW GRADE, BY TWO OR MORE COPPER BONDING CONDUCTORS IN ACCORDANCE WITH THE NEC
- ACCORDANCE WITH THE NEC.
 THE CONTRACTOR SHALL PERFORM IEEE FALL—OF—POTENTAL RESISTANCE TO EARTH TESTING (PER IEEE 1100 AND 81) FOR GROUND ELECTRODE SYSTEMS, THE CONTRACTOR SHALL FURNISH AND INSTALL SUPPLEMENTAL GROUND ELECTRODES AS NEEDED TO ACHIEVE A TEST RESULT OF 5 OHMS OR LESS.
 THE CONTRACTOR IS RESPONSIBLE FOR PROPERLY SEQUENCING GROUNDING AND UNDERGROUND CONDUIT INSTALLATION AS TO PREVENT ANY LOSS OF CONTINUITY IN THE GROUNDING SYSTEM OR DAMAGE TO THE CONDUIT AND PROVIDE
- METAL CONDUIT AND TRAY SHALL BE GROUNDED AND MADE ELECTRICALLY CONTINUOUS WITH LISTED BONDING FITTINGS OR BY BONDING ACROSS THE DISCONTINUITY WITH #6 COPPER WIRE UL APPROVED GROUNDING TYPE CONDUIT CLAMPS.

 METAL RACEWAY SHALL NOT BE USED AS THE NEC REQUIRED EQUIPMENT GROUND CONDUCTOR. STRANDED COPPER CONDUCTORS WITH GREEN INSULATION, SIZED IN ACCORDANCE WITH THE NEC, SHALL BE FURNISHED AND INSTALLED WITH THE POWER CIRCUITS TO BTS EQUIPMENT.
- EACH CABINET FRAME SHALL BE DIRECTLY CONNECTED TO THE MASTER GROUND BAR WITH GREEN INSULATED SUPPLEMENTAL EQUIPMENT GROUND WIRES, #6 STRANDED COPPER OR LARGER FOR INDOOR BTS: #2 BARE SOLID TINNED COPPER FOR OUTDOOR BTS.

 CONNECTIONS TO THE GROUND BUS SHALL NOT BE DOUBLED UP OR STACKED BACK TO BACK CONNECTIONS ON OPPOSITE SIDE OF THE GROUND BUS ARE PERMITTED.
- ALL EXTERIOR GROUND CONDUCTORS BETWEEN EQUIPMENT/GROUND BARS AND THE GROUND RING SHALL BE #2 SOLID TINNED COPPER UNLESS OTHERWISE INDICATED.
 ALUMINUM CONDUCTOR OR COPPER CLAD STEEL CONDUCTOR SHALL NOT BE USED FOR GROUNDING CONNECTIONS.
 USE OF 90' BENDS IN THE PROTECTION GROUNDING CONDUCTORS SHALL BE AVOIDED WHEN 45' BENDS CAN BE ADEQUATELY SUPPORTED.
 EXCITERMIC WELDS SHALL BE USED FOR ALL GROUNDING CONNECTIONS BELOW GRADE.

- ALL GROUND CONNECTIONS ABOVE GRADE (INTERIOR AND EXTERIOR) SHALL BE FORMED USING HIGH PRESS CRIMPS.

 COMPRESSION GROUND CONNECTIONS MAY BE REPLACED BY EXOTHERMIC WELD CONNECTIONS.

 ICE BRIDGE BONDING CONDUCTORS SHALL BE EXOTHERMICALLY BONDED OR BOLTED TO THE BRIDGE AND THE TOWER GROUND BAR.

- APPROVED ANTIOXIDANT COATINGS (i.e. CONDUCTIVE GEL OR PASTE) SHALL BE EXPERIENCE MATERIALS AND THE TOWER GROUND BAR.

 APPROVED ANTIOXIDANT COATINGS (i.e. CONDUCTIVE GEL OR PASTE) SHALL BE USED ON ALL COMPRESSION AND BOLTED GROUND CONNECTIONS.

 ALL EXTERIOR GROUND CONNECTIONS SHALL BE COATED WITH A CORROSION RESISTANT MATERIAL.

 MISCELLANGROUS ELECTRICAL AND NON-ELECTRICAL METAL BOXES, FRAMES AND SUPPORTS SHALL BE BONDED TO THE GROUND RING, IN ACCORDANCE WITH THE NEC.

 BOND ALL METALLIC OBJECTS WITHIN 6 ft OF MAIN GROUND RING WITH (1) #2 BARE SOLID TINNED COPPER GROUND CONDUCTORS.

 GROUND CONDUCTORS USED FOR THE FACILITY GROUNDING AND LICHTNING PROTECTION SYSTEMS SHALL NOT BE ROUTED THROUGH METALLIC OBJECTS THAT FORM A RING AROUND THE CONDUCTOR, SUCH AS METALLIC CONDUITS,

 METAL SUPPORT CLIPS OR SLEEVES THROUGH WALLS OR FLOORS. WHEN IT IS REQUIRED TO BE HOUSED IN CONDUIT TO MEET CODE REQUIREMENTS OR LOCAL CONDITIONS, NON-METALLIC MATERIAL SUCH AS PVC CONDUIT SHALL BE USED. WHERE USE OF METAL CONDUIT IS UNAVOIDABLE (i.e., NONMETALLIC CONDUIT PROHIBITED BY LOCAL CODE) THE GROUND CONDUCTOR SHALL BE BONDED TO EACH END OF THE METAL CONDUIT.

 ALL GROUNDS THAT TRANSITION FROM BELOW GRADE TO ABOVE GRADE MUST BE #2 BARE SOLID TINNED COPPER IN 3/4" NON-METALLIC, FLEXIBLE CONDUIT FROM 24" BELOW GRADE TO WITHIN 3" TO 6" OF CAD-WELD TERMINATION
- POINT. THE EXPOSED END OF THE CONDUIT MUST BE SEALED WITH SILICONE CAULK. (ADD TRANSITIONING GROUND STANDARD DETAIL AS WELL).
 BUILDINGS WHERE THE MAIN GROUNDING CONDUCTORS ARE REQUIRED TO BE ROUTED TO GRADE, THE CONTRACTOR SHALL ROUTE TWO GROUNDING CONDUCTORS FROM THE ROOFTOP, TOWERS, AND WATER TOWERS GROUNDING RING, TO THE EXISTING GROUNDING SYSTEM, THE GROUNDING CONDUCTORS SHALL NOT BE SMALLER THAN 2/O COPPER. ROOFTOP GROUNDING RING SHALL BE BONDED TO THE EXISTING GROUNDING SYSTEM, THE BUILDING STEEL COLUMNS, LIGHTNING PROTECTION SYSTEM, AND BUILDING MAIN WATER LINE (FERROUS OR NONFERROUS METAL PIPING ONLY).

ELECTRICAL INSTALLATION NOTES:

- ALL ELECTRICAL WORK SHALL BE PERFORMED IN ACCORDANCE WITH THE PROJECT SPECIFICATIONS, NEC AND ALL APPLICABLE
- FEDERAL, STATE, AND LOCAL CODES/ORDINANCES.
 CONDUIT ROUTINGS ARE SCHEMATIC. CONTRACTOR SHALL INSTALL CONDUITS SO THAT ACCESS TO EQUIPMENT IS NOT BLOCKED.
- AND TRIP HAZARDS ARE ELIMINATED

- AND INP HAZARDS ARE ELIMINATED.

 WRING, RACEWAY AND SUPPORT METHODS AND MATERIALS SHALL COMPLY WITH THE REQUIREMENTS OF THE NEC.

 ALL CIRCUITS SHALL BE SEGREGATED AND MAINTAIN MINIMUM CABLE SEPARATION AS REQUIRED BY THE NEC.

 ALL EQUIPMENT SHALL BEAR THE UNDERWRITERS LABORATORIES LABEL OF APPROVAL, AND SHALL CONFORM TO REQUIREMENT OF THE NATIONAL ELECTRICAL CODE.

 ALL OVERCURRENT DEVICES SHALL HAVE AN INTERRUPTING CURRENT RATING THAT SHALL BE GREATER THAN THE SHORT CIRCUIT CURRENT TO WHICH THEY ARE SUBJECTED, 22,000 AIC MINIMUM. VERYIFY AVAILABLE SHORT CIRCUIT CURRENT DOES NOT EXCEED THE RATING OF ELECTRICAL EQUIPMENT IN ACCORDANCE WITH ARTICLE 110.24 NEC OR THE MOST CURRENT ADDRETS CODE FIRE THE COVERNING UNEQUIPMENT IN ACCORDANCE WITH ARTICLE 110.24 NEC OR THE MOST CURRENT ADDRETS CODE FIRE THE COVERNING UNEQUIPMENT IN ACCORDANCE WITH ARTICLE 110.24 NEC OR THE MOST CURRENT
- ADDITED CODE PRE THE GOVERNING JURISDICTION.

 EACH END OF EVERY POWER PHASE CONDUCTOR, GROUNDING CONDUCTOR, AND TELCO CONDUCTOR OR CABLE SHALL BE
 LABELED WITH COLOR—CODED INSULATION OR ELECTRICAL TAPE (3M BRAND, 1/2" PLASTIC ELECTRICAL TAPE WITH UV
- PROTECTION, OR EQUAL). THE IDENTIFICATION METHOD SHALL CONFORM WITH NEC AND OSHA.

 ALL ELECTRICAL COMPONENTS SHALL BE CLEARLY LABELED WITH LAMICOID TAGS SHOWING THEIR RATED VOLTAGE, PHASE
 CONFIGURATION, WIRE CONFIGURATION, POWER OR AMPACITY RATING AND BRANCH CIRCUIT ID NUMBERS (i.e. PANEL BOARD AND CIRCUIT ID'S).

- PANEL BOARDS (ID NUMBERS) SHALL BE CLEARLY LABELED WITH PLASTIC LABELS.
 ALL TIE WRAPS SHALL BE CUT FLUSH WITH APPROVED CUTTING TOOL TO REMOVE SHARP EDGES.
 ALL POWER AND EQUIPMENT GROUND WIRING IN TUBING OR CONDUIT SHALL BE SINGLE COPPER CONDUCTOR (#14 OR LARGER) WITH TYPE THHW. THWN. THWN-2. XHHW. XHHW-2. THW. THW-2. RHW. OR RHW-2 INSULATION UNLESS OTHERWISE SPECIFIED
- SUPPLEMENTAL EQUIPMENT GROUND WIRING LOCATED INDOORS SHALL BE SINGLE COPPER CONDUCTOR (#6 OR LARGER) WITH TYPE THHW, THWN, THWN-2, XHHW, XHHW-2, THW, THW-2, RHW, OR RHW-2 INSULATION UNLESS OTHERWISE SPECIFIED.

 POWER AND CONTROL WIRING IN FLEXIBLE CORD SHALL BE MULTI-CONDUCTOR, TYPE SOOW CORD (#14 OR LARGER) UNLESS
- OTHERWISE SPECIFIED.
- OFFICIALLY CONTROL WIRING FOR USE IN CABLE TRAY SHALL BE MULTI—CONDUCTOR, TYPE TC CABLE (#14 OR LARGER), WITH TYPE THHW, THWN, THWN-2, XHHW, XHHW-2, THW, THW-2, RHW, OR RHW-2 INSULATION UNLESS OTHERWISE SPECIFIED. ALL POWER AND GROUNDING CONNECTIONS SHALL BE CRIMP—STYLE, COMPRESSION WIRE LUGS AND WIRE NUTS BY THOMAS AND BETTS (OR EQUAL). LUGS AND WIRE NUTS SHALL BE RATED FOR OPERATION NOT LESS THAN 75°C (90°C IF AVAILABLE).
- RACEWAY AND CABLE TRAY SHALL BE LISTED OR LABELED FOR ELECTRICAL USE IN ACCORDANCE WITH NEMA, UL, ANSI/IEEE
- 15. ELECTRICAL METALLIC TUBING (EMT), INTERMEDIATE METAL CONDUIT (IMC), OR RIGID METAL CONDUIT (RMC) SHALL BE USED FOR
- EXPOSED INDOOR LOCATIONS.
- ELECTRICAL METALLIC TUBING (EMT) OR METAL-CLAD CABLE (MC) SHALL BE USED FOR CONCEALED INDOOR LOCATIONS.

 SCHEDULE 40 PVC UNDERGROUND ON STRAIGHTS AND SCHEDULE 80 PVC FOR ALL ELBOWS/90s AND ALL APPROVED ABOVE GRADE PVC CONDUIT.
- LIQUID-TIGHT FLEXIBLE METALLIC CONDUIT (LIQUID-TITE FLEX) SHALL BE USED INDOORS AND OUTDOORS, WHERE VIBRATION
- COURS OR FLEXIBLE METALLIC CONDOIT (LIQUID-THE FLEX) SHALL BE USED INDOORS AND OUTDOORS, WHERE VIBRATION OCCURS OR FLEXIBILITY IS NEEDED.

 CONDUIT AND TUBING FITTINGS SHALL BE THREADED OR COMPRESSION—TYPE AND APPROVED FOR THE LOCATION USED. SET SCREW FITTINGS ARE NOT ACCEPTABLE.
- 20. CABINETS, BOXES AND WIRE WAYS SHALL BE LABELED FOR ELECTRICAL USE IN ACCORDANCE WITH NEMA, UL, ANSI/IEEE AND
- WIREWAYS SHALL BE METAL WITH AN ENAMEL FINISH AND INCLUDE A HINGED COVER, DESIGNED TO SWING OPEN DOWNWARDS
- (WIREMOLD SPECMATE WIREWAY).
 SLOTTED WIRING DUCT SHALL BE PVC AND INCLUDE COVER (PANDUIT TYPE E OR EQUAL).
- SLOTTED WIRING DUCT SHALL BE PVC AND INCLUDE COVER (PANDUIT TYPE E OR EQUAL).

 CONDUITS SHALL BE FASTENED SECURELY IN PLACE WITH APPROVED NON-PERFORATED STRAPS AND HANGERS. EXPLOSIVE

 DEVICES (i.e. POWDER-ACTUATED) FOR ATTACHING HANGERS TO STRUCTURE WILL NOT BE PERMITTED. CLOSELY FOLLOW THE

 LINES OF THE STRUCTURE, MAINTAIN CLOSE PROXIMITY TO THE STRUCTURE AND KEEP CONDUITS IN TIGHT ENVELOPES. CHANGES
 IN DIRECTION TO ROUTE AROUND OBSTACLES SHALL BE MADE WITH CONDUIT OUTLET BODIES. CONDUIT SHALL BE INSTALLED IN

 A NEAT AND WORKMANLIKE MANNER. PARALLEL AND PERFENDICULAR TO STRUCTURE WALL AND CEILING LINES. ALL CONDUIT A NEAT AND WORKMANLIKE MANNER, PARALLEL AND PERFENDICULAR TO STRUCTURE WALL AND CELLING LINES, ALL CONDUITS SHALL BE FERPENDED FLUSH TO FINISH GRADE TO PREVENT CONCRETE, PLASTER OR DIRT FROM ENTERING, CONDUITS SHALL BE RIGIDLY CLAMPED TO BOXES BY GALVANIZED MALLEABLE IRON LOCKNUT ON BUSHING ON INSIDE AND GALVANIZED MALLEABLE IRON LOCKNUT ON DISIDE AND INSIDE. EQUIPMENT CABINETS, TERMINAL BOXES, JUNCTION BOXES AND PULL BOXES SHALL BE GALVANIZED OR EPOXY—COATED SHEET STEEL. SHALL MEET OR EXCEED UL 50 AND BE RATED NEMA 1 (OR BETTER) FOR INTERIOR LOCATIONS AND NEMA 3R (OR
- BETTER) FOR EXTERIOR LOCATIONS
- METAL RECEPTACLE, SWITCH AND DEVICE BOXES SHALL BE GALVANIZED, EPOXY-COATED OR NON-CORRODING; SHALL MEET OR EXCEED UL 514A AND NEMA OS 1 AND BE RATED NEMA 1 (OR BETTER) FOR INTERIOR LOCATIONS AND WEATHER PROTECTED (WP OR BETTER) FOR EXTERIOR LOCATIONS
- NONMETALLIC RECEPTACLE, SWITCH AND DEVICE BOXES SHALL MEET OR EXCEED NEMA OS 2 (NEWEST REVISION) AND BE RATEL

 NEMA 1 (OR BETTER) FOR INTERIOR LOCATIONS AND WEATHER PROTECTED (WP OR BETTER) FOR EXTERIOR LOCATIONS.
- 27. THE CONTRACTOR SHALL NOTIFY AND OBTAIN NECESSARY AUTHORIZATION FROM THE CARRIER AND/OR CROWN CASTLE USA INC.
- BEFORE COMMENCING WORK ON THE AC POWER DISTRIBUTION PANELS.

 THE CONTRACTOR SHALL PROVIDE NECESSARY TAGGING ON THE BREAKERS, CABLES AND DISTRIBUTION PANELS IN ACCORDANCE WITH THE APPLICABLE CODES AND STANDARDS TO SAFEGUARD LIFE AND PROPERTY. 28. INSTALL LAMICOID LABEL ON THE METER CENTER TO SHOW "VERIZON"
- 30. ALL EMPTY/SPARE CONDUITS THAT ARE INSTALLED ARE TO HAVE A METERED MULE TAPE PULL CORD INSTALLED.

CONDUCTOR COLOR CODE					
SYSTEM	CONDUCTOR	COLOR			
	A PHASE	BLACK			
120/240V, 1Ø	B PHASE	RED			
120/2400, 10	NEUTRAL	WHITE			
	GROUND	GREEN			
	A PHASE	BLACK			
	B PHASE	RED			
120/208V, 3Ø	C PHASE	BLUE			
	NEUTRAL	WHITE			
	GROUND	GREEN			
	A PHASE	BROWN			
	B PHASE	ORANGE OR PURPLE			
277/480V, 3Ø	C PHASE	YELLOW			
	NEUTRAL	GREY			
	GROUND	GREEN			
DC VOLTAGE	POS (+)	RED**			
	NEG (-)	BLACK**			

* SEE NEC 210.5(C)(1) AND (2)
** POLARITY MARKED AT TERMINATION

WHITE PROPOSED EXCAVATION

APWA UNIFORM COLOR CODE:

TEMPORARY SURVEY MARKINGS ELECTRIC POWER LINES, CABLES, CONDUIT, AND LIGHTING CABLES

YELLOW GAS, OIL, STEAM, PETROLEUM, OR GASEOUS MATERIALS COMMUNICATION, ALARM OR SIGNAL LINES, CABLES, OR CONDUIT AND TRAFFIC LOOPS

POTABLE WATER RECLAIMED WATER, IRRIGATION, AND

SLURRY LINES SEWERS AND DRAIN LINES

WALLINGFORD, CT 06492



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CLIFTON PARK, NY 12065

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VERIZON SITE NUMBER: 468137

BU #: 876392 **NEW HARTFORD N CT**

115 INDUSTRIAL PARK RD NEW HARTFORD, CT 06057

EXISTING 168'-0" MONOPOLE

Έ	lſ	ISSUED FOR:					
	REV	DATE	DRWN	DESCRIPTION	DES./Q		
	0	06/21/2021	RCD	FINAL CDs			
	1	04/08/2021	PEG	FINAL CDs			
	2	05/13/2022	RCD	FINAL CDs			




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SHEET NUMBER

ANT	ANTENNA
(E)	EXISTING
	FACILITY INTERFACE FRAME
GEN	GENERATOR
GPS	GLOBAL POSITIONING SYSTEM
GSM	GLOBAL SYSTEM FOR MOBILE
	LONG TERM EVOLUTION
MGB	MASTER GROUND BAR
MW	MICROWAVE
(N)	NEW
ŇĖC	NATIONAL ELECTRIC CODE
(P)	PROPOSED
Ρ̈́Ρ	POWER PLANT
QTY	QUANTITY
RECT	RECTIFIER
RBS	RADIO BASE STATION
RET	REMOTE ELECTRIC TILT
RFDS	RADIO FREQUENCY DATA SHEET
RRH	REMOTE RADIO HEAD
DDII	PEMOTE PADIO LINIT

TOWER MOUNTED AMPLIFIER

UMTS UNIVERSAL MOBILE TELECOMMUNICATIONS SYSTEM



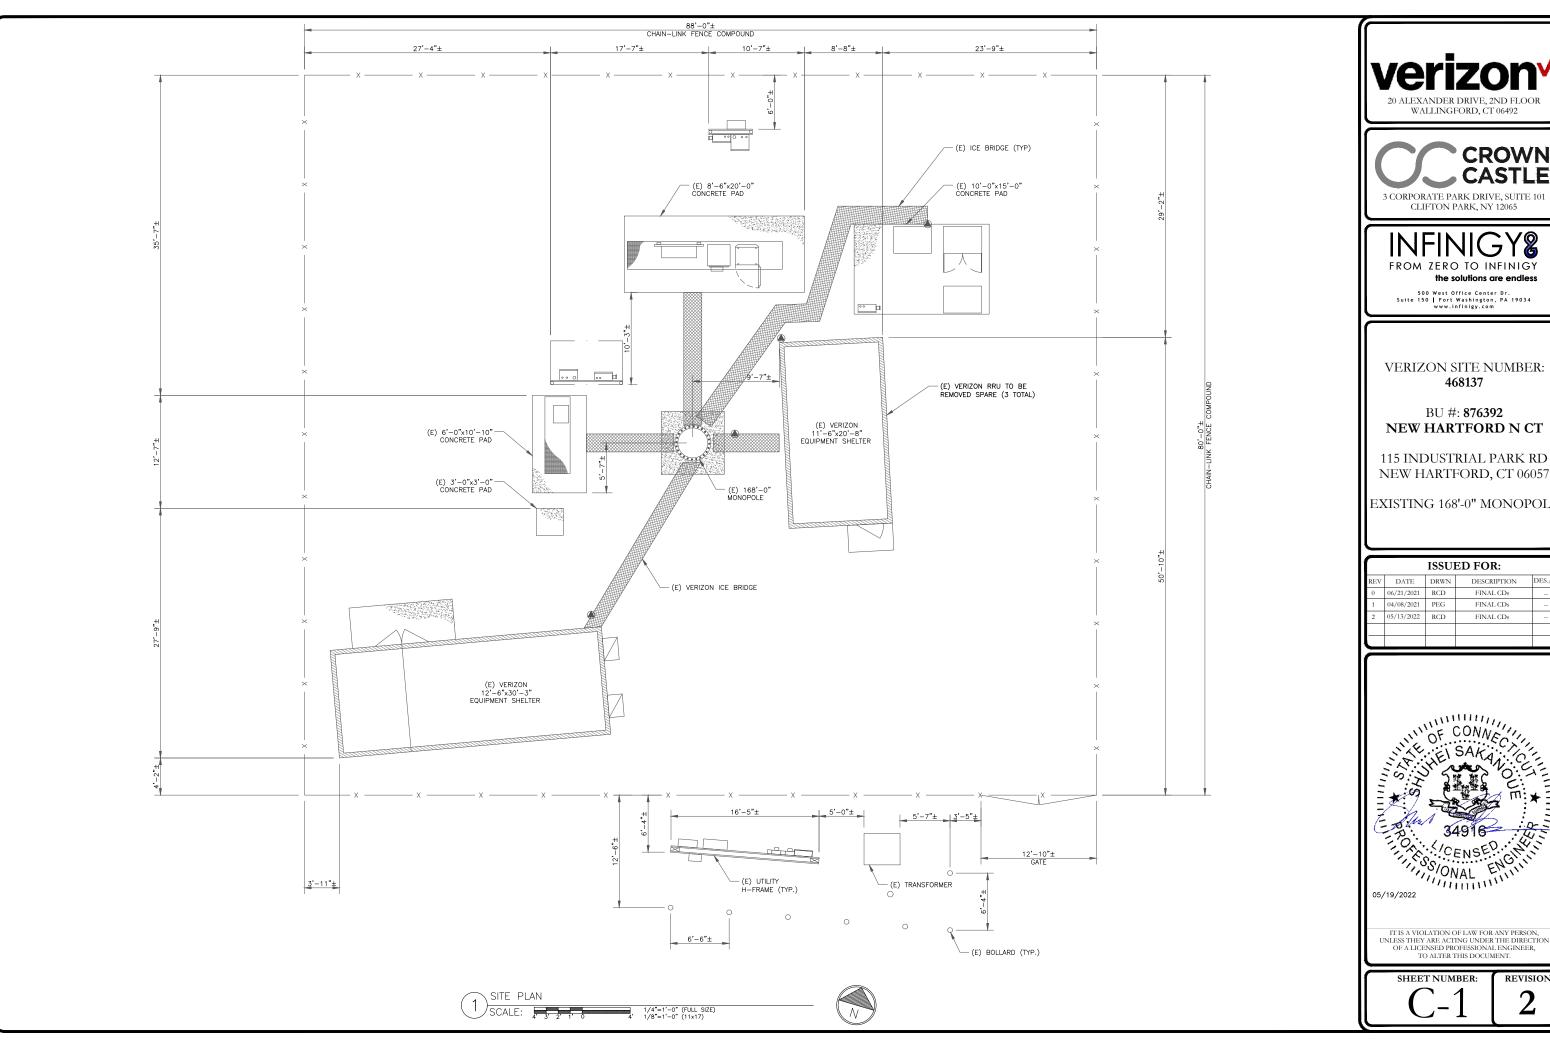



FROM ZERO TO INFINIGY

VERIZON SITE NUMBER:

BU #: **876392** NEW HARTFORD N CT


NEW HARTFORD, CT 06057

EXISTING 168'-0" MONOPOLE

Γ	ISSUED FOR:										
REV DATE DRWN DESCRIPTION DES./O											
0	06/21/2021	RCD	FINAL CDs								
1	04/08/2021	PEG	FINAL CDs								
2	05/13/2022	RCD	FINAL CDs								
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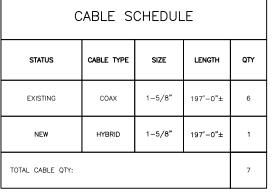
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ANTENNA/RRH SCHEDULE

SECTOR	STATUS	ANTENNA MANUFACTURER	ANTENNA MODEL	ANTENNA CENTERLINE	AZIMUTH	MECHANICAL DOWNTILTS	ELECTRICAL DOWNTILTS	TOWER EQUIPMENT MANUFACTURER	TOWER EQUIPMENT QTY/MODEL
A1	-	-	-	1	ı	-	ı	RFS	(1) DB-C1-12C-24AB-0Z
A2	NEW	JMA	(2) MX06FR0660-03	147'-0"	30°	0.	2*/2*/4*	SAMSUNG COMMSCOPE	(1) RRUS RF4439d-25A (1) TD-850B-LTE78-43
А3	ı	-	-	ı	I	ı	ı	SAMSUNG	(1) RRUS RF4440d-13A
A4	NEW	SAMSUNG	MT6407-77A	147'-0"	30°	0*	6	1	-
В1	ı	-	-	-	I	-	-	-	-
B2	NEW	JMA	(2) MX06FR0660-03	147'-0"	165*	0.	2*/2*/4*	SAMSUNG COMMSCOPE	(1) RRUS RF4439d-25A (1) TD-850B-LTE78-43
В3	ı	-	-	ı	I	ı	ı	SAMSUNG	(1) RRUS RF4440d-13A
B4	NEW	SAMSUNG	MT6407-77A	147'-0"	165 °	0*	6	1	1
C1	ı	-	-	ı	I	ı	ı	ı	-
C2	NEW	JMA	(2) MX06FR0660-03	147'-0"	270°	0.	2*/2*/4*	SAMSUNG COMMSCOPE	(1) RRUS RF4439d-25A (1) TD-850B-LTE78-43
C3	-	-	-	-	ı	-	-	SAMSUNG	(1) RRUS RF4440d-13A
C4	NEW	SAMSUNG	MT6407-77A	147'-0"	270°	0*	6*	-	-

CABLE SCHEDULE									
STATUS	CABLE TYPE	LENGTH	QTY						
EXISTING	COAX	1-5/8"	197'-0"±	6					
NEW	HYBRID	1-5/8"	197'-0"±	1					
TOTAL CABLE QTY:		7							

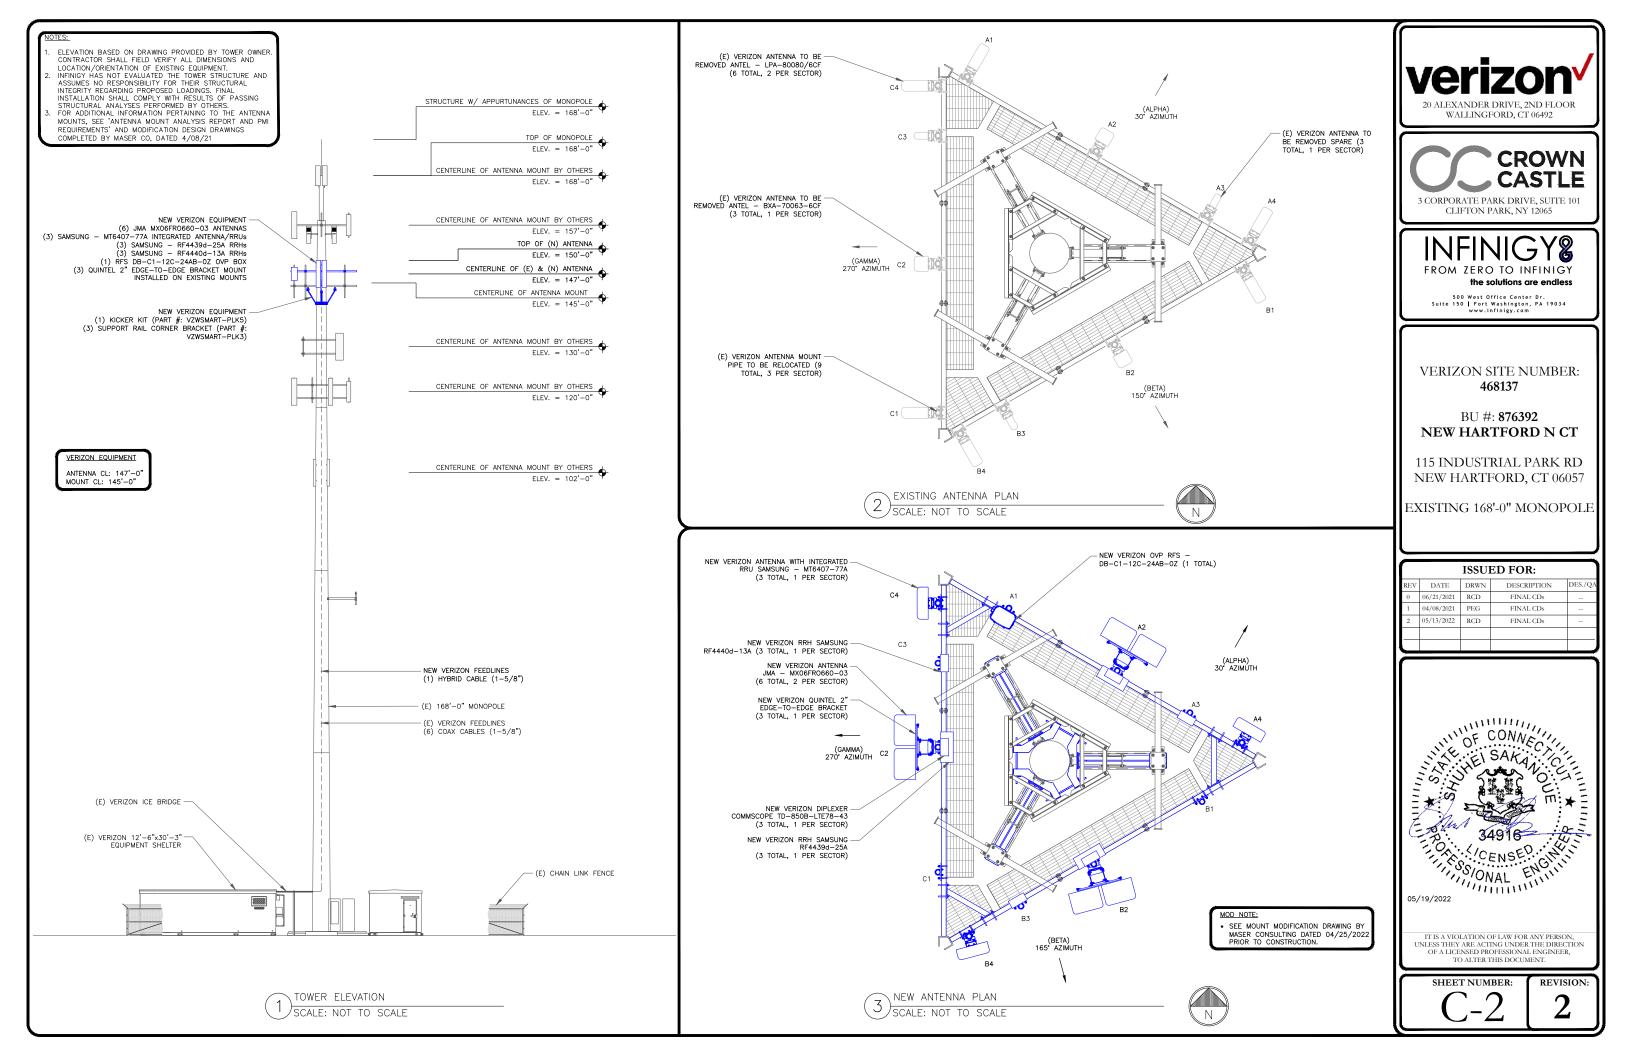





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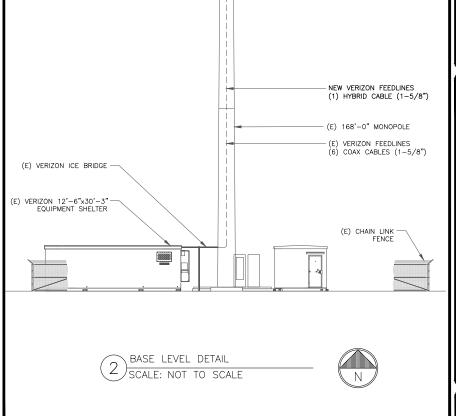
EXISTING 168'-0" MONOPOLE

THE		L				
	i	$oldsymbol{\Gamma}$	ISSUED FOR:			
		REV	DATE	DRWN	DESCRIPTION	DES./QA
		0	06/21/2021	RCD	FINAL CDs	
		1	04/08/2021	PEG	FINAL CDs	
		2	05/13/2022	RCD	FINAL CDs	
	l :	F				
	— NEW VERIZON FEEDLINES (1) HYBRID CABLE (1-5/8")					
	- (E) 168'-0" MONOPOLE					




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REVISION:



VERIZON TOWER EQUIPMENT SCHEDULE


(1) SCALE: NOT TO SCALE

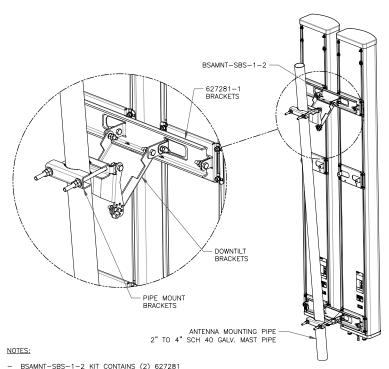


- BSAMNT-SBS-1-2 KIT CONTAINS (2) 627281 MOUNTING BRACKETS. TORQUE THE M10 BOLT ASSEMBLY TO 37 N.m. PER MANUFACTURE'S RECOMMENDATIONS.

COMMSCOPE - BSAMNT-SBS-1-2 SCALE: NOT TO SCALE

NOT USED (2) SCALE: NOT TO SCALE

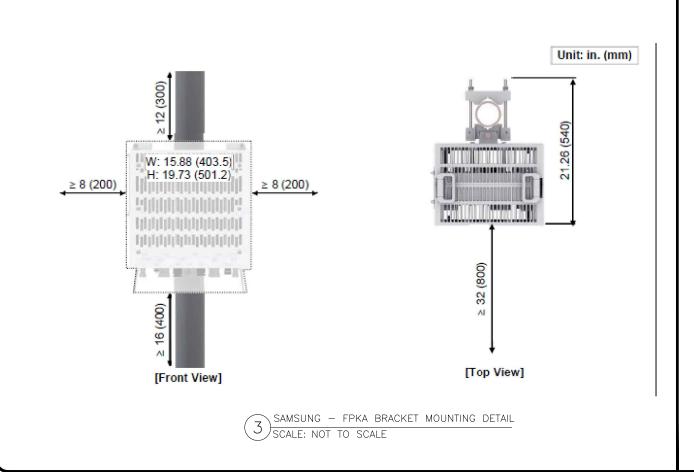

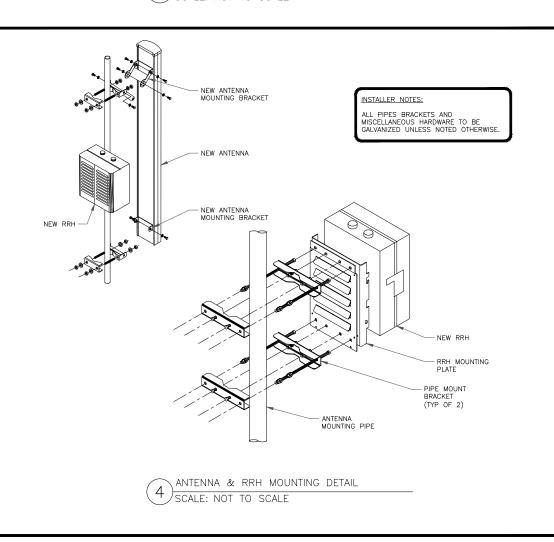





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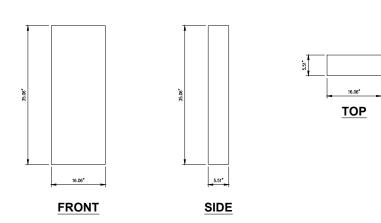
	ISSUED FOR:										
REV	DATE	DRWN	DESCRIPTION	DES./QA							
0	06/21/2021	RCD	FINAL CDs								
1	04/08/2021	PEG	FINAL CDs								
2	05/13/2022	RCD	FINAL CDs								



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SAMSUNG PANEL ANTENNA (MT6407-77A)


35.06"x16.06"x5.51" DIMENSIONS, HxWxD: WEIGHT, W/O BRACKETS: 81.57 lbs



SAMSUNG MT6407-77A ANTENNA DETAIL SCALE: NOT TO SCALE

JMA PANEL ANTENNA (MX06FR0660-03)

DIMENSIONS, HxWxD: 72"x15.4"x10.7" WEIGHT, W/O BRACKETS: 43.70 lbs

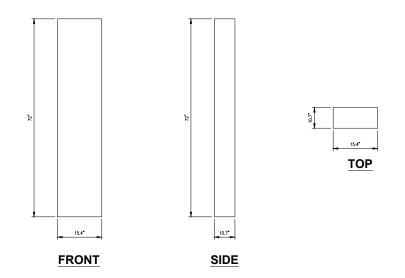


JMA - MX06FR0660-03 ANTENNA DETAIL SCALE: NOT TO SCALE

SAMSUNG RF4439D-25A

DIMENSIONS, WxDxH: 14.96" X 14.96" X 10.04"

74.70 lbs TOTAL WEIGHT: TEMPERATURE: -40° TO 55° C

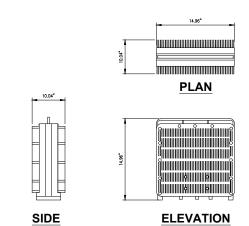

SAMSUNG RF4439D-25A DETAIL SCALE: NOT TO SCALE

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EXISTING 168'-0" MONOPOLE


Ξ	ISSUED FOR:										
REV DATE DRWN DESCRIPTION DES.											
0	06/21/2021	RCD	FINAL CDs								
1	04/08/2021	PEG	FINAL CDs								
2	05/13/2022	RCD	FINAL CDs								



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SAMSUNG RF4440D-13A RAYCAP DB-C1-12C-24AB-0Z DIMENSIONS, WxDxH: 14.96" X 14.96" X 9.06"


DIMENSIONS, LxWxH: 12.6"x16.5"x29.5" TOTAL WEIGHT: 72.50 lbs WEIGHT, W/O BRACKETS: 32.0 lbs

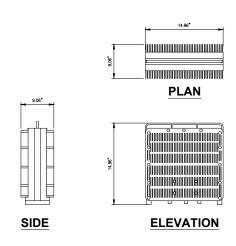


TEMPERATURE:

-40° TO 55° C

SAMSUNG RF4440D-13A DETAIL (4) SCALE: NOT TO SCALE

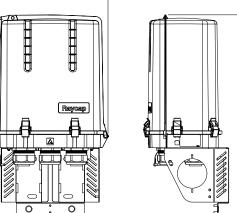

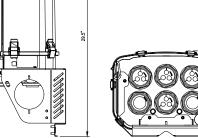

RAYCAP RVZDC-6627-PF-48 OVP DETAIL

Fiber Naming Convention							
Technology	(Equipment-Sector-OPTI #)						
DUPLEX FIE	BER RUN						
3rd Gen 5G CPRI 1	AEUA-A-1						
3rd Gen 5G CPRI 2	AEUA-A-2						
4th Gen 5G RF1	AEUB-A-1						
4th Gen 5G RF2	AEUB-A-2						
ASOD Backhaul EIF1	ASOD-A-1						
SINGLE FIE	BER RUN						
CBRS CPRI 1	CBRS-A-1						
CBRS CPRI 2	CBRS-A-2						
LAA	LAA-A-1						
High Band Dual Band CPRI 1	HB-A-1						
High Band Dual Band CPRI 2	HB-A-2						
Low Band Dual Band CPRI 1	LB-A-1						
Low Band Dual Band CPRI 2 - 5GNR	LB-5GNR-A-2						
FDMIMO AWS CPRI 1	FDM-AWS-A-1						
FDMIMO AWS CPRI 2	FDM-AWS-A-2						
FDMIMO PCS CPRI 1	FDM-PCS-A-1						
FDMIMO PCS CPRI 2	FDM-PCS-A-2						
Rev. 3/5	/2020						

FIBER NAMING CONVENTION (6) SCALE: NOT TO SCALE

SCALE: NOT TO SCALE

																 $\overline{}$
Alpha AWS				Į .		,	Beta AWS					GammaAWS				
	WHITE			ļ			Port 1					Port 1				
Port 2	WHITE) .			Port 2					Port 2				
Port 3	WHITE						Port 3					Port 3				
Port 4	WHITE						Port 4					Port 4				
Alpha PCS				i i			Beta PCS					Gamma PCS				
Port 1	WHITE						Port1					Port 1				$\overline{}$
Port 2	WHITE]					Port 2			ζ		Port 2				\Box
Port3	WHITE						Port 3					Port 3		10	1	\Box
Port 4	WHITE	1		V.			Port 4					Port 4		- 4		
Alpha LTE 700							Beta LTE 70	0				Gamma LTE 700	ř.			
Port 1.	WHITE		- 0				Port 1			4		Port 1			4	$\overline{}$
Port 2	WHITE						Port 2					Port 2				\Box
	WHITE				8		Port 3					Port 3				\Box
	WHITE						Port 4					Port 4				\Box
Alpha 850 LTE							Beta 850 LT	E		-		Gamma 850 LTE		1	4	 \Box
Port 1	WHITE						Port 1					Port 1		10		\Box
Port 2	WHITE		- 4				Port 2		1 3			Port 2				\Box
Port 3	WHITE						Port 3					Port 3				\Box
	WHITE				-		Port 4					Port 4				\neg
Alpha 850 CDMA							Beta 850 CD	MA				Gamma 850 CDMA				$\overline{}$
	WHITE						Port 1					Port 1				$\overline{}$
Port 2	WHITE						Port 2					Port 2				\Box
Alpha EVDO							Beta EVDO					Gamma EVDO				\Box
	WHITE	l il					Port 1		10			Port 1				$\overline{}$
	WHITE						Port 2					Port 2				\Box

Post 1	WHITE			H
Alpha 850 LTE + 700 LTE	$\overline{}$	1		Г
GPS 4		1		
GPS 3				
GPS 2				
OF 3.1				1

Alpha 850 LTE + 700 LTE							
Port1	WHITE						
Port 2	WHITE	La Di					
Port 3	WHITE			7			
Port 4	WHITE				0		
Beta 850 LTE + 700 LTE						-	
Port 1							
Port 2					4	E. 9.	
Port 3							
Port 4	7	f			100		
Gamma 850 LTE + 700 LTE							
Port1							
Port 2							
Port 3					1		
Port 4							

Alpha 850 NR Fiber	White	Ptouch - Alpha 850 NR
Beta 850 NR Fiber		Ptouch - Beta 850 NR
Gamma 850 NR Fiber		Ptouch - Gamma 850 NR

COLOR CODE MATRIX
SCALE: NOT TO SCALE





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VERIZON SITE NUMBER: 468137

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EXISTING 168'-0" MONOPOLE


ISSUED FOR:					
REV	DATE	DRWN	DESCRIPTION	DES./QA	
0	06/21/2021	RCD	FINAL CDs		
1	04/08/2021	PEG	FINAL CDs		
2	05/13/2022	RCD	FINAL CDs		
l					



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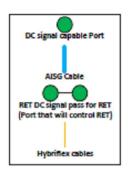
SHEET NUMBER:

C-6

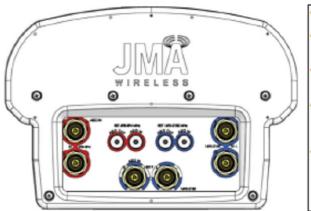


- Port 1 & 2 are for low band (698-896 MHz).
- Port 3,4,5, & 6 are for high band (1695-2360 MHz).
- Antenna Smart Bias Tee (SBT) is through port 1 for low band and port 3 for high band.
- AISG cable is only needed when drawn in the diagrams below, if it is not drawn then SBT is enough to control all RET motors.
- Not all SBT ports are needed to control RET, only green port connection to green port will control RET.

RET DC signal pass for RET (Port that will control RET)





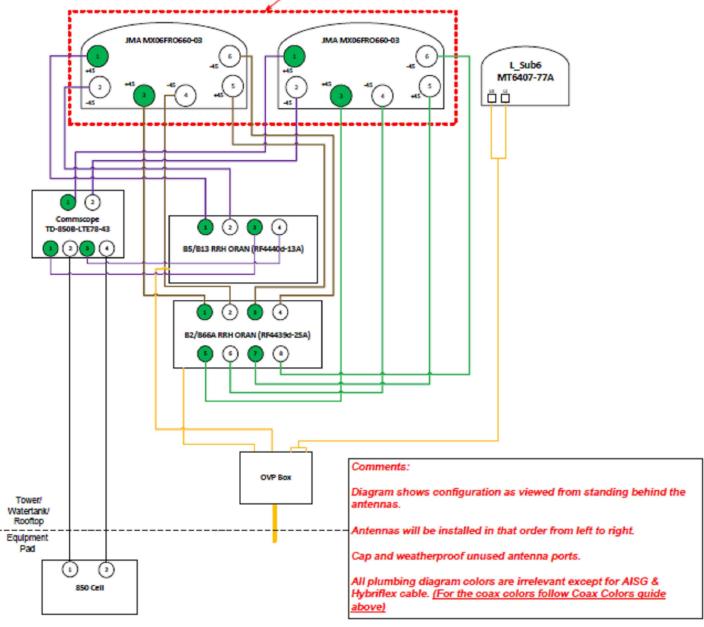

PLUMBING DIAGRAM
SCALE: NOT TO SCALE





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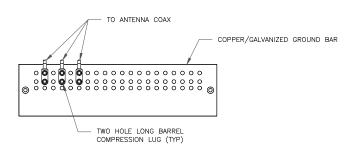
	ISSUED FOR:					
REV	DATE	DRWN	DESCRIPTION	DES./QA		
0	06/21/2021	RCD	FINAL CDs			
1	04/08/2021	PEG	FINAL CDs			
2	05/13/2022	RCD	FINAL CDs			



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SHEET NUMBER:

C-7



NOTES:

NOTES:

- 1. DOUBLING UP "OR STACKING" OF CONNECTIONS IS NOT PERMITTED.
- 2. EXTERIOR ANTIOXIDANT JOINT COMPOUND TO BE USED ON ALL EXTERIOR CONNECTIONS.
- 3. GROUND BAR SHALL NOT BE ISOLATED FROM TOWER. MOUNT DIRECTLY TO ANTENNA MOUNT STEEL.

ANTENNA SECTOR GROUND BAR DETAIL SCALE: NOT TO SCALE

NOT USED SCALE: NOT TO SCALE

NOT USED
SCALE: NOT TO SCALE


TO TOWER MOUNTED EQUIPMENT MONOPOLE TO ANTENNA -ANTENNA GROUND BAR LOCATED AT MCL (BONDED TO TOWER STEEL) STANDARD COAX CABLE GROUND KIT 2 HOLE LUG (TYP) PIIIII4 #6 STRANDED CU WIRE WITH-GREEN, 600V, THWN INSULATION (OR AS PROVIDED WITH GROUND KIT) (TYP) MECHANICAL CONNECTION COAX GROUND BAR WITH INSULATORS, CONNECTED DIRECTLY TO THE BOTTOM OF MONOPOLE. SEE NOTE 1. COAX CABLE-TO BTS EQUIPMENT VIA TRAY OR ICE BRIDGE 2/0 TINNED BARE COPPER WIRE MONOPOLE PIER GROUND WIRE SEE NOTE 3 GROUND WIRE NOTE 3 INSPECTION WELL

 NUMBER OF GROUNDING BARS MAY VARY DEPENDING ON THE TYPE OF TOWER, ANTENNA LOCATIONS AND CONNECTION ORIENTATION. COAXIAL CABLES EXCEEDING 200 FEET ON THE TOWER SHALL HAVE GROUND KITS AT THE MIDPOINT. PROVIDE AS REQUIRED.

- EXOTHERMIC WELD (TYP)

- ONLY MECHANICAL CONNECTIONS ARE ALLOWED TO BE MADE TO CROWN CASTLE USA INC. TOWERS. ALL MECHANICAL CONNECTIONS SHALL BE TREATED WITH AN ANTI-OXIDANT COATING.
- ALL TOWER GROUNDING SYSTEMS SHALL COMPLY WITH THE REQUIREMENTS OF THE RECOGNIZED EDITION OF ANSI/TIA 222 AND NFPA 780.

TYPICAL ANTENNA CABLE GROUNDING SCALE: NOT TO SCALE

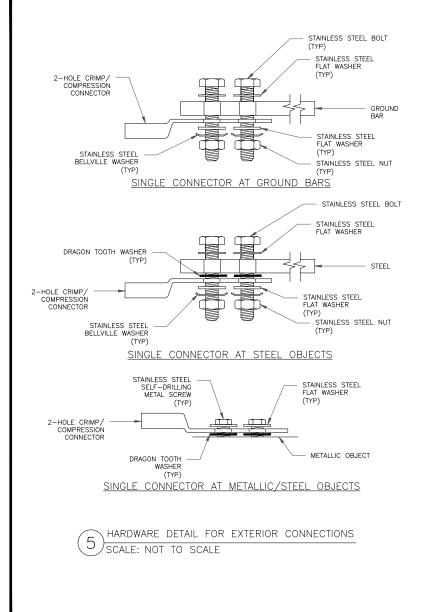

NOT USED
SCALE: NOT TO SCALE

Verizon

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EXISTING 168'-0" MONOPOLE


	ISSUED FOR:					
REV	DATE	DRWN	DESCRIPTION	DES./QA		
0	06/21/2021	RCD	FINAL CDs			
1	04/08/2021	PEG	FINAL CDs			
2	05/13/2022	RCD	FINAL CDs			



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SHEET NUMBER:


G-1

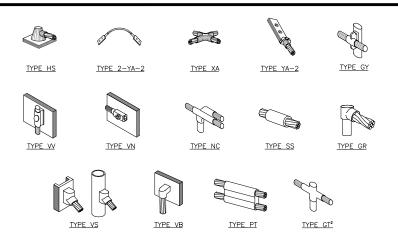

NOTE:


- ERICO EXOTHERMIC "MOLD TYPES" SHOWN HERE ARE EXAMPLES. CONSULT WITH CONSTRUCTION MANAGER FOR SPECIFIC MOLDS TO BE USED FOR THIS PROJECT.
 MOLD TYPE ONLY TO BE USED BELOW GRADE WHEN CONNECTING GROUND RING TO GROUND ROD.

CADWELD GROUNDING CONNECTIONS SCALE: NOT TO SCALE

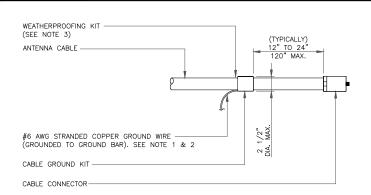

NOTES:


- DO NOT INSTALL CABLE GROUND KIT AT A BEND AND ALWAYS DIRECT GROUND WIRE DOWN TO GROUND BAR.
- GROUNDING KIT SHALL BE TYPE AND PART NUMBER AS SUPPLIED OR RECOMMENDED BY CABLE MANUFACTURER.
- WEATHER PROOFING SHALL BE TWO-PART TAPE KIT, COLD SHRINK SHALL NOT
- CABLE GROUND KIT CONNECTION SCALE: NOT TO SCALE

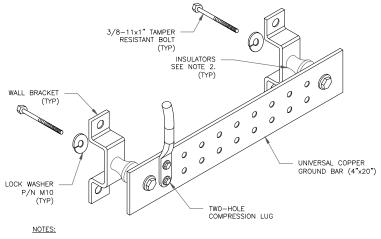

1. DOWN LEAD (HOME RUN) CONDUCTORS ARE NOT TO BE INSTALLED ON CROWN CASTLE USA INC. TOWER, PER THE GROUNDING DOWN CONDUCTOR POLICY QAS—STD—10091. NO MODIFICATION OR DRILLING TO TOWER STEEL IS ALLOWED IN ANY FORM OR FASHION, CAD—WELDING ON THE TOWER AND/OR IN THE AIR ARE NOT PERMITTED.

2. OMIT INSULATOR WHEN MOUNTING TO TOWER STEEL OR PLATFORM STEEL USE INSULATORS WHEN ATTACHING TO BUILDING OR SHELTERS.


GROUND BAR DETAIL (6) SCALE: NOT TO SCALE

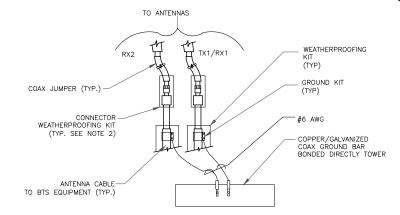



NOTES:

- 1. DO NOT INSTALL CABLE GROUND KIT AT A BEND AND ALWAYS DIRECT GROUND
- 2. WEATHER PROOFING SHALL BE TWO-PART TAPE KIT. COLD SHRINK SHALL NOT BE USED.

GROUND CABLE CONNECTION SCALE: NOT TO SCALE

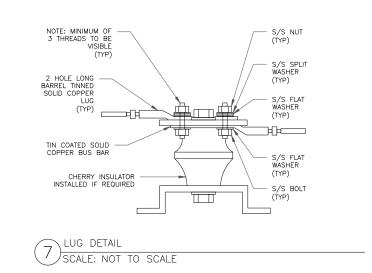

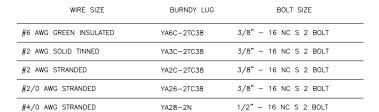


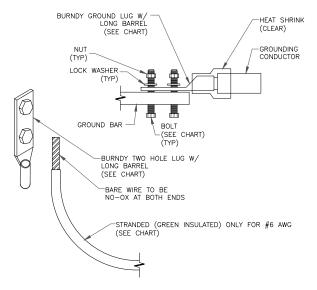

NOTES:

ALL GROUNDING LUGS ARE TO BE INSTALLED PER MANUFACTURER'S SPECIFICATIONS. ALL HARDWARE BOLTS, NUTS, LOCK WASHERS SHALL BE STAINLESS STEEL ALL HARDWARE ARE TO BE AS FOLLOWS: BOLT, FLAT WASHER, GROUND BAR, GROUND LUG, FLAT WASHER AND NUT.

MECHANICAL LUG CONNECTION SCALE: NOT TO SCALE

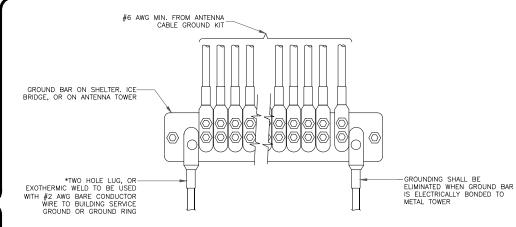

GROUNDWIRE INSTALLATION SCALE: NOT TO SCALE





CLIFTON PARK, NY 12065

500 West Office Center Dr. Suite 150 | Fort Washington, PA 19034 www.infinigy.com

VERIZON SITE NUMBER: 468137

BU #: **876392 NEW HARTFORD N CT**

115 INDUSTRIAL PARK RD NEW HARTFORD, CT 06057

EXISTING 168'-0" MONOPOLE

[ISSUED FOR:						
REV	DATE	DRWN	DESCRIPTION	DES./QA			
0	06/21/2021	RCD	FINAL CDs				
1	04/08/2021	PEG	FINAL CDs				
2	05/13/2022	RCD	FINAL CDs				
l							



IT IS A VIOLATION OF LAW FOR ANY PERSON, UNLESS THEY ARE ACTING UNDER THE DIRECTION OF A LICENSED PROFESSIONAL ENGINEER, TO ALTER THIS DOCUMENT

(8) SCALE: NOT TO SCALE



MOUNT MODIFICATION DRAWINGS EXISTING 14.67' PLATFORM

TOWER OWNER: CROWN CASTLE **TOWER OWNER SITE NUMBER: 876392**

CARRIER SITE NAME: NEW HARTFORD N CT **CARRIER SITE NUMBER: 468137** FUZE ID: 16271985

115 GREENWOODS INDUSTRIAL PARK NEW HARTFORD, CT 06057 LITCHFIELD COUNTY

> LATITUDE: 41.88625° N LONGITUDE: 72.966139° W

DESIGN CRITERIA WIND LOADS

BASIC WIND SPEED (3 SECOND GUST), V = 115 MPH EXPOSURE CATEGORY C TOPOGRAPHIC CATEGORY I

MEAN BASE ELEVATION (AMSL) = 566.99'

ICE LOADS

ICE WIND SPEED (3 SECOND GUST), V = 50 MPH

ICE THICKNESS = 1.50 IN

SEISMIC LOADS

SEISMIC DESIGN CATEGORY B SHORT TERM MCER GROUND MOTION, $S_S = .172$ LONG TERM MCER GROUND MOTION, S₁ = .054

CLIENT REPRESENTATIVE VERIZON WIRELESS PROJECT MANAGER **COLLIERS ENGINEERING & DESIGN** PETER ALBANO 856.797.0412 CONTACT: F-MAII ·

PMI REQUIREMENTS EMBEDDED WITHIN MOUNT MODIFICATION REPORT

VERIZON WIRELESS

APPLICANT/LESSEE

COMPANY:

PROJECT INFORMATION

E MAN DETER AL	DANIO COLLIERCENICINIEEDINIC COM			
E-MAIL: PETER.AL	LBANO@COLLIERSENGINEERING.COM			
		二L		
CONTRACTO	OR PMI REQUIREMENTS			
PMI LOCATION: SMART TOOL PROJECT #:	HTTPS://PMI.VZWSMART.COM			
VZW LOCATION CODE (PSLC):	468137			
ANALYSIS DATE:	4/25/2022			

SHEET DESCRIPTION

ST-I TITLE SHEET

SBOM-I BILL OF MATERIALS

SCF-I CLIMBING FACILITY DETAIL


SPECIFICATION SHEETS

SS-I MODIFICATION DETAILS

SGN-I GENERAL NOTES

SS-2 MOUNT PHOTOS

SHEET INDEX

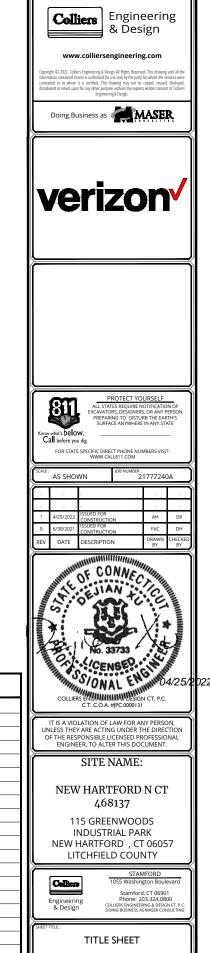

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BILL OF MATERIALS

			SE	CTION I - VZWSMART KITS		
QUANTITY	MANUFACTURER	PART NUMBER	DESCRIPTION	NOTES	UNIT WEIGHT (LBS.)	WEIGHT (LBS.)
24		VZWSMART-MSK I	CROSSOVER PLATE		14	336
ı		VZWSMART-PLK5	KICKER KIT	CONTRACTOR TO VERIFY THE LENGTH REQUIRED AND TRIM AS NECESSARY IN ACCORDANCE WITH THE 'STRUCTURAL STEEL' NOTES ON SHEET SGN-I.	291	291
I		VZWSMART-PLK7	MONOPOLE COLLAR MOUNT ASSEMBLY		150	150
3		VZWSMART-PLK3	SUPPORT RAIL CORNER BRACKET		30	90
	VZWSMART					
			SECTION	ON 2 - OTHER REQUIRED PARTS		
QUANTITY	MANUFACTURER	PART NUMBER	DESCRIPTION	NOTES	UNIT WEIGHT (LBS.)	WEIGHT (LBS.)
3	-	-	170" LONG, P2 1/2 STD PIPE	GALVANIZED.	83	249
3	-	-	72" LONG, P2 1/2 STD PIPE	GALVANIZED.	35	105
3	-	-	36" LONG, L3x3x1/4 ANGLE	GALVANIZED. CONTRACTOR TO VERIFY THE LENGTH REQUIRED AND TRIM AS NECESSARY IN ACCORDANCE WITH THE 'STRUCTURAL STEEL' NOTES ON SHEET SGN-I.	15	45
					TOTAL	12//
					TOTAL:	1266

NOTES	:

- I. THE MANUFACTURERS LISTED ARE THE APPROVED VENDORS FOR THE VZW MOUNT KITS. EACH MANUFACTURER WILL BE AWARE OF WHICH KITS HAVE BEEN THROUGH THE VZW APPROVAL PROCESS AND THEY ARE IN TURN APPROVED TO SELL. PLEASE NOTE THAT THE MATERIAL UTILIZED ON THE MOUNT MODIFICATIONS WILL BE REVIEWED AS A PART OF THE DESKTOP PMI COMPLETED BY THE SMART TOOL VENDOR. IT WILL BE REQUIRED THAT THE VZW KITS SPECIFIED ARE UTILIZED IN THE MODIFICATIONS.
- 2. ALL MATERIALS REQUIRED FOR THE DESIGNED MODIFICATIONS BUT NOT LISTED IN THIS SHEET ARE ASSUMED TO BE PROVIDED BY THE CONTRACTOR.

V D VV OIVIL I.	RT KITS - APPROVED VENDORS
	COMMSCOPE
CONTACT	SALVADOR ANGUIANO
PHONE	(817) 304-7492
EMAIL	SALVADOR.ANGUIANO@COMMSCOPE.COM
WEBSITE	WWW.COMMSCOPE.COM
N	IETROSITE FABRICATORS, LLC
CONTACT	KENT RAMEY
PHONE	(706) 335-7045 (O), (706) 982-9788 (M)
EMAIL	KENT@METROSITELLC.COM
WEBSITE	METROSITEFABRICATORS.COM
	PERFECTVISION
CONTACT	WIRELESS SALES
PHONE	(844) 887-6723
EMAIL	WWW.PERFECT-VISION.COM
WEBSITE	WIRELESSSALES@PERFECT-VISION.COM
	SABRE INDUSTRIES, INC.
CONTACT	ANGIE WELCH
PHONE	(866) 428-6937
EMAIL	AKWELCH@SABREINDUSTRIES.COM
WEBSITE	WWW.SABRESITESOLUTIONS.COM
	SITE PRO 1
CONTACT	PAULA BOSWELL
PHONE	(972) 236-9843
EMAIL	PAULA.BOSWELL@VALMONT.COM
WEBSITE	WWW.SITEPROI.COM

VZWSMART KITS - APPROVED VENDORS **NEWAVE** NEWAVE SALES TEAM CONTACT (971) 239-4762 PHONE SALES@NEWAVETC.COM EMAIL WEBSITE WWW.NEWAVETC.COM BETTER METAL, LLC CONTACT DAVID STANSBERRY (615) 535-0990 (O), (615) 631-2520 (M) PHONE DLS@BETTERMETAL.COM EMAIL WEBSITE WWW.BETTERMETAL.COM



SBOM-I

PROJECT NOTES

- I. SEE MODIFICATION NOTES
- THE CONTRACTOR SHALL COMPLY WITH ALL APPLICABLE CODES ORDINANCES, LAWS AND REGULATIONS OF ALL MUNICIPALITIES, UTILITY COMPANIES OR OTHER PUBLIC/GOVERNING AUTHORITIES.
- 3 THE CONTRACTOR SHALL BE RESPONSIBLE FOR OBTAINING ALL PERMITS AND INSPECTIONS THAT MAY BE REQUIRED BY ANY FEDERAL, STATE, COUNTY OR MUNICIPAL AUTHORITIES.
- THE CONTRACTOR SHALL NOTIFY THE CONSTRUCTION MANAGER, IN WRITING, OF ANY CONFLICTS, ERRORS OR OMISSIONS PRIOR TO THE SUBMISSION OF BIDS OR PERFORMANCE OF WORK
- THE CONTRACTOR SHALL BE RESPONSIBLE FOR PROTECTING ALL EXISTING SITE IMPROVEMENTS PRIOR TO COMMENCING CONSTRUCTION. THE CONTRACTOR SHALL REPAIR ANY DAMAGE AS A RESULT OF CONSTRUCTION OF THIS FACILITY AT THE CONTRACTOR'S EXPENSE TO THE SATISFACTION OF THE OWNER.
- THE SCOPE OF WORK FOR THIS PROJECT SHALL INCLUDE PROVIDING ALL MATERIALS, EQUIPMENT AND LABOR REQUIRED TO COMPLETE THIS PROJECT. ALL EQUIPMENT SHALL BE INSTALLED IN ACCORDANCE WITH MANUFACTURER'S RECOMMENDATIONS.
- THE CONTRACTOR SHALL VISIT THE PROJECT SITE PRIOR TO SUBMITTING THE BID TO VERIEY THAT THE PROJECT CAN BE CONSTRUCTED IN ACCORDANCE WITH THE CONTRACT DOCUMENTS AND CONSTRUCTION
- THE CONTRACTOR SHALL VERIFY ALL EXISTING DIMENSIONS AND CONDITIONS PRIOR TO COMMENCING ANY WORK. ALL DIMENSIONS OF EXISTING CONSTRUCTION SHOWN ON THESE DRAWINGS MUST BE VERIFIED. THE CONTRACTOR SHALL NOTIFY THE CONSTRUCTION MANAGER OF ANY DISCREPANCIES PRIOR TO ORDERING MATERIAL OR PROCEEDING WITH CONSTRUCTION.
- SINCE THE CELL SITE MAY BE ACTIVE, ALL SAFETY PRECAUTIONS MUST BE TAKEN WHEN WORKING AROUND HIGH LEVELS OF ELECTROMAGNETIC RADIATION. EQUIPMENT SHOULD BE SHUTDOWN PRIOR TO PERFORMING ANY WORK THAT COULD EXPOSE THE WORKERS TO DANGER. PERSONAL RF EXPOSURE MONITORS ARE REQUIRED TO BE WORN TO ALERT OF ANY POTENTIALLY DANGEROUS EXPOSURE LEVELS.
- 10. NO NOISE, SMOKE, DUST OR ODOR WILL RESULT FROM THIS FACILITY AS TO CAUSE A NUISANCE.
- II. THE FACILITY IS UNMANNED AND NOT FOR HUMAN HABITATION (NO HANDICAP ACCESS IS REQUIRED).

GENERAL NOTES

- THESE MODIFICATIONS HAVE BEEN DESIGNED IN ACCORDANCE WITH THE GOVERNING PROVISIONS OF THE TELECOMMUNICATIONS INDUSTRY STANDARD TIA-222-H. MATERIALS AND SERVICES PROVIDED BY THE CONTRACTOR SHALL CONFORM TO THE ABOVE MENTIONED CODES
- CONTRACTOR SHALL TAKE ALL PRECAUTIONS NECESSARY TO PREVENT DAMAGE TO EXISTING STRUCTURES. ANY DAMAGE TO EXISTING STRUCTURES AS A RESULT OF THE CONTRACTOR'S WORK OR FROM DAMAGE DUE TO OTHER CAUSES SHALL BE REPAIRED AT THE CONTRACTOR'S EXPENSE TO THE SATISFACTION OF THE OWNER.
- CONTRACTOR SHALL VERIEY ALL DIMENSIONS AND EXISTING CONDITIONS BEFORE BEGINNING WORK, ORDERING MATERIAL, AND PREPARING OF SHOP DRAWINGS. ANY DISCREPANCIES BETWEEN FIELD CONDITIONS AND THE CONTRACT DOCUMENTS SHALL BE BROUGHT TO THE IMMEDIATE ATTENTION OF THE ENGINEER. IF THE CONTRACTOR DISCOVERS ANY EXISTING CONDITIONS THAT ARE NOT REPRESENTED ON THESE DRAWINGS, OR ANY CONDITIONS THAT WOULD INTERFERE WITH THE INSTALLATION OF THE MODIFICATIONS, NOTIFY THE ENGINEER IMMEDIATELY.
- IT IS ASSUMED THAT ANY STRUCTURAL MODIFICATION WORK SPECIFIED ON THESE PLANS WILL BE ACCOMPLISHED BY KNOWLEDGEABLE WORKMEN WITH TOWER CONSTRUCTION EXPERIENCE
- THE CONTRACTOR SHALL SUPERVISE AND DIRECT THE WORK AND SHALL BE SOLELY RESPONSIBLE FOR ALL CONSTRUCTION METHODS, MEANS, TECHNIQUES, SEQUENCES, AND PROCEDURES,
- ALL CONSTRUCTION MEANS AND METHODS: INCLUDING BUT NOT LIMITED TO, ERECTION PLANS, RIGGING PLANS, CLIMBING PLANS, AND RESCUE PLANS SHALL BE THE RESPONSIBILITY OF THE GENERAL CONTRACTOR RESPONSIBLE FOR THE EXECUTION OF THE WORK CONTAINED HEREIN AND SHALL MEET ANSI/TIA-322 (LATEST EDITION), OSHA, AND GENERAL INDUSTRY STANDARDS. ALL RIGGING PLANS SHALL ADHERE TO ANSI/TIA-322 (LATEST EDITION) INCLUDING THE REQUIRED INVOLVEMENT OF A QUALIFIED ENGINEER FOR CLASS IV CONSTRUCTION.
- THE CONTRACTOR IS SOLELY RESPONSIBLE FOR INITIATING, MAINTAINING, AND SUPERVISING ALL SAFETY PROGRAMS IN ACCORDANCE WITH APPLICABLE SAFETY CODES.
- WORK SHALL ONLY BE PERFORMED DURING CALM DRY DAYS (WINDS LESS THAN 30-MPH). THE STRUCTURE SHOWN ON THE DRAWINGS IS STRUCTURALLY SOUND ONLY IN THE COMPLETED FORM, THE

- CONTRACTOR SHALL BE RESPONSIBLE FOR THE STRENGTH AND STABILITY OF THE STRUCTURE DURING ERECTION. CONTRACTOR SHALL PROVIDE TEMPORARY SUPPORT, SHORING, BRACING AND ANY OTHER STRUCTURAL SYSTEMS AS REQUIRED TO RESIST ALL FORCES THAT MAY OCCUR DURING HANDLING AND ERECTION UNTIL THE STRUCTURE IS FULLY COMPLETED. TEMPORARY SUPPORTS BRACING AND OTHER STRUCTURAL SYSTEMS REQUIRED DURING CONSTRUCTION SHALL REMAIN THE CONTRACTOR'S PROPERTY AFTER THEIR USE.
- 9. ALL INSTALLATIONS PERFORMED ON THIS STRUCTURE SHALL BE COMPLETED IN ACCORDANCE WITH THE GOVERNING PROVISIONS OF THE STANDARD FOR INSTALLATION, ALTERATION AND MAINTENANCE OF ANTENNA SUPPORTING STRUCTURES AND ANTENNAS, ANSI/TIA-322.
- 10. CONTRACTOR SHALL SECURE SITE BACK TO EXISTING CONDITION UNDER SUPERVISION OF OWNER. ALL FENCE, STONE, GEOFABRIC, GROUNDING, AND SURROUNDING GRADE SHALL BE REPLACED AND REPAIRED AS REQUIRED TO ACHIEVE OWNER APPROVAL. POSITIVE DRAINAGE AWAY FROM TOWER SITE SHALL BE MAINTAINED.
- II. CONNECTIONS BETWEEN ITEMS SUPPORTED BY THE STRUCTURE AND THE STRUCTURE NOT SPECIFICALLY DETAILED IN THE CONTRACT DOCUMENTS ARE THE RESPONSIBILITY OF THE CONTRACTOR, SUCH CONNECTIONS SHALL BE DESIGNED, COORDINATED AND INSPECTED BY A PROFESSIONAL STRUCTURAL ENGINEER LICENSED IN THE STATE OF THE PROJECT, SUBMIT SIGNED AND SEALED CALCULATIONS DURING SHOP DRAWING REVIEW.
- DO NOT SCALE DRAWINGS.
- 13. DO NOT USE THESE DRAWINGS FOR ANY OTHER SITE.
- 14. ALL MATERIAL UTILIZED FOR THIS PROJECT MUST BE NEW AND FREE OF ANY DEFECTS. ANY MATERIAL SUBSTITUTIONS, INCLUDING BUT NOT LIMITED TO ALTERED SIZE AND/OR STRENGTHS, MUST BE APPROVED BY THE OWNER AND ENGINEER IN WRITING
- 15. THE MOUNT UNDER NO CIRCUMSTANCES SHOULD BE USED AS A TIE OFF POINT.

STRUCTURAL STEEL

- DESIGN, DETAILING, FABRICATION AND ERECTION OF STRUCTURAL STEEL SHALL CONFORM TO THE FOLLOWING PUBLICATIONS EXCEPT AS SPECIFICALLY INDICATED IN THE CONTRACT DOCUMENTS.
 - a. AMERICAN INSTITUTE OF STEEL CONSTRUCTION (AISC) MANUAL OF STEEL CONSTRUCTION (15TH EDITION)
 - b. SPECIFICATION FOR STRUCTURAL JOINTS USING ASTM A325 OR A490 BOLTS
 - c. AISC CODE OF STANDARD PRACTICE
- STRUCTURAL STEEL SHALL CONFORM TO THE FOLLOWING UNLESS OTHERWISE SHOWN:

CHANNELS, ANGLES, PLATES, ETC. ASTM A36 (GR 36) STEEL PIPE ASTM A53 (GR 35) ASTM A325 **BOLTS** NUTS ASTM A563

LOCK WASHERS LOCKING STRUCTURAL GRADE

- 3. ALL SUBSTITUTIONS PROPOSED BY THE CONTRACTOR SHALL BE APPROVED IN WRITING BY THE ENGINEER. CONTRACTOR SHALL PROVIDE DOCUMENTATION TO ENGINEER FOR VERIFYING THE SUBSTITUTE IS SUITABLE FOR USE AND MEETS ORIGINAL DESIGN CRITERIA. DIFFERENCES FROM THE ORIGINAL DESIGN, INCLUDING MAINTENANCE, REPAIR AND REPLACEMENT, SHALL BE NOTED. ESTIMATES OF COSTS/CREDITS ASSOCIATED WITH THE SUBSTITUTION (INCLUDING RE-DESIGN COSTS AND COSTS TO SUB-CONTRACTORS) SHALL BE PROVIDED TO THE ENGINEER. CONTRACTOR SHALL PROVIDE ADDITIONAL DOCUMENTATION AND/OR SPECIFICATIONS TO THE ENGINEER AS REQUESTED.
- 4. PROVIDE STRUCTURAL STEEL SHOP DRAWINGS TO ENGINEER FOR APPROVAL PRIOR TO FABRICATION.
 - a. SUBMIT SHOP DRAWINGS TO

PETER.ALBANO@COLLIERSENGINEERING.COM

- b. PROVIDE MASER CONSULTING PROJECT # AND MASER CONSULTING PROJECT ENGINEER CONTACT IN THE BODY OF THE EMAIL
- 5. DRILL NO HOLES IN ANY NEW OR EXISTING STRUCTURAL STEEL MEMBERS OTHER THAN THOSE SHOWN ON STRUCTURAL DRAWINGS WITHOUT THE APPROVAL OF THE ENGINEER OF RECORD.
- GALVANIZED ASTM A325 BOLTS SHALL NOT BE REUSED.
- 7. ALL NEW STEEL SHALL BE HOT BE DIPPED GALVANIZED FOR FULL WEATHER PROTECTION. IN ADDITION ALL NEW STEEL SHALL BE PAINTED TO MATCH EXISTING STEEL. CONTRACTOR SHALL OBTAIN WRITTEN PERMISSION TO PROTECT STEEL BY ANY OTHER MEANS.
- CONTRACTOR SHALL PROTECT CUT ENDS OF ALL FIELD-CUT STEEL WITH TWO (2) COATS OF COLD GALVANIZATION (ZINGA OR ZINC COTE).
- ALL BOLT ASSEMBLIES FOR STRUCTURAL MEMBERS REPRESENTED IN THIS DRAWING REQUIRE LOCKING DEVICES TO BE INSTALLED IN ACCORDANCE WITH TIA-222-H SECTION 4.9.2 REQUIREMENTS.
- 10. WHERE CONNECTIONS ARE NOT FULLY DETAILED ON THESE DRAWINGS, FABRICATOR SHALL DESIGN CONNECTIONS TO RESIST LOADS AND FORCES WHERE SHOWN ON DRAWINGS AND AS OUTLINED IN SPECIFICATIONS.
- II. FOR MEMBERS BEING REPLACED, PROVIDE NEW BOLTS AND MATCH EXISTING SIZE AND GRADE, MAINTAIN AISC REQUIREMENTS FOR MINIMUM BOLT DISTANCE AND SPACING.


- 12. ALL PROPOSED AND/OR REPLACED BOLTS SHALL BE OF SUFFICIENT LENGTH SUCH THAT THE END OF THE BOLT IS AT LEAST FLUSH WITH THE FACE OF THE NUT. IT IS NOT PERMITTED FOR THE BOLT END TO BE BELOW THE FACE OF THE NUT AFTER TIGHTENING IS COMPLETED.
- 13. GALVANIZED ASTM A325 BOLTS SHALL NOT BE REUSED.
- 14. ALL EXISTING PAINTED/GALVANIZED SURFACES DAMAGED DURING REHAB INCLUDING AREAS UNDER STIFFENER PLATES SHALL BE WIRE BRUSHED CLEAN, REPAIRED BY COLD GALVANIZING (ZINGA OR ZINC COTE), AND REPAINTED TO MATCH THE EXISTING FINISH (IF APPLICABLE).
- 15. ALL HOLES IN STEEL MEMBERS SHALL BE SIZED 1/16" LARGER THAN THE BOLT DIAMETER. STANDARD HOLES SHALL BE USED UNLESS NOTED OTHERWISE.

WELDING NOTES

- ALL WELDING SHALL BE DONE IN ACCORDANCE WITH AWS DI.0 (LATEST EDITION). THIS SHALL INCLUDE A CERTIFIED WELD INSPECTION (CWI) FOR ACCEPTANCE OR REJECTION OF ALL WELDING OPERATIONS, PRE. DURING AND POST INSTALLATION, USING THE ACCEPTANCE CRITERIA OF AWS D.I.
- CONTRACTOR IS RESPONSIBLE FOR COMMISSIONING A THIRD PARTY CERTIFIED WELD INSPECTOR (CWI) THROUGHOUT THE ENTIRETY OF THE PROJECT. A PASSING CWI REPORT SHALL BE PROVIDED TO THE ENGINEER UPON COMPLETION OF THE PROJECT.
- THE CERTIFIED WELD INSPECTOR SHALL INDICATE, IN A WRITTEN CWI REPORT, THAT ALL WELDING OPERATIONS PRE, DURING, AND POST INSTALLATION WERE CONDUCTED IN ACCORDANCE WITH AWS DI.I WITH PHOTOGRAPHS AND DOCUMENTATION SUPPORTING THE ACCEPTANCE OR REJECTION OF ALL WELDING. ALL CWI WELD INSPECTION DOCUMENTATION AND PHOTOS SHALL BE SUBMITTED DURING THE PMI.
- IN CASES WHERE A WELD IS SPECIFIED BETWEEN TWO MEMBERS IN WHICH THERE IS A GAP IN BETWEEN, THE WELD IS TO BE BUILT-UP SUCH THAT THE SIZE OF WELD ON THE MEMBER IS EQUAL TO THAT SHOWN IN THE
- 5. OXY FUEL GAS WELDING OR BRAZING IS STRICTLY PROHIBITED. SPECIFICALLY, NO TORCH CUTTING IS PERMITTED ON SITE. ALL HOLES SHALL BE CUT WITH A GRINDER.
- 6. CONTRACTOR SHALL EXERCISE CAUTION WHEN WELDING A GALVANIZED
- 7. CONTRACTOR SHALL HAVE A FIRE PROTECTION PLAN IN PLACE THAT CONFORMS WITH ALL OSHA, ANSI/ASSP A10.48, ANSI Z49.1, AND LOCAL JURISDICTIONAL REQUIREMENTS.


BOLT SCHEDULE (IN.)					
BOLT DIAMETER	STANDARD HOLE	SHORT SLOT	MIN. EDGE DISTANCE	SPACING	
1/2	9/16	9/16 x 11/16	7/8	I I/2	
5/8	11/16	11/16 x 7/8	1 1/8	I 7/8	
3/4	13/16	13/16 x 1	1 1/4	2 1/4	
7/8	15/16	15/16 x 1 1/8	1 1/2	2 5/8	
I	1 1/16	1 1/16 x 1 5/16	1 3/4	3	

WORKABLE GAGES (IN.)			
LEG	GAGE		
4	2 1/2		
3 1/2	2		
3	I 3/4		
2 1/2	I 3/8		
2	I I/8		

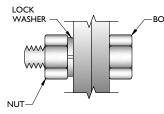

- ALL DIMENSIONS REPRESENTED IN THE ABOVE TABLES ARE AISC MINIMUM REQUIREMENTS. CONTRACTOR SHALL VERIFY EXISTING CONDITIONS IN FIELD AND NOTIFY ENGINEER IF DISTANCES ARE LESS THAN THOSE PROVIDED.
- 2. THE DIMENSIONS PROVIDED ARE MINIMUM REQUIREMENTS. ACTUAL **DIMENSIONS OF PROPOSED MEMBERS** WITHIN THESE DRAWINGS MAY VARY FROM THE AISC MINIMUM REQUIREMENTS.
- SHORT SLOT HOLES SHALL ONLY BE USED WHEN DEPICTED IN THE DRAWINGS
- MATCH EXISTING GAGES WHEN
 APPLICABLE, UNLESS MINIMUM EDGE DISTANCES ARE COMPROMISED.

GAGE

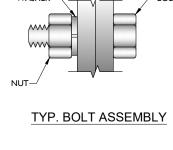

ALLOWABLE COPING

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EDGE





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T IS A VIOLATION OF LAW FOR ANY PERSON LESS THEY ARE ACTING UNDER THE DIRECTI

OF THE RESPONSIBLE LICENSED PROFESSIONA ENGINEER, TO ALTER THIS DOCUMENT.

SITE NAME:

NEW HARTFORD N CT

468137

115 GREENWOODS

INDUSTRIAL PARK

NEW HARTFORD . CT 06057

LITCHFIELD COUNTY


4/25/2022

MAIL

Colliers

GENERAL NOTES

NOTE: DO NOT SCALE DRAWINGS FOR CONSTRUCTIO

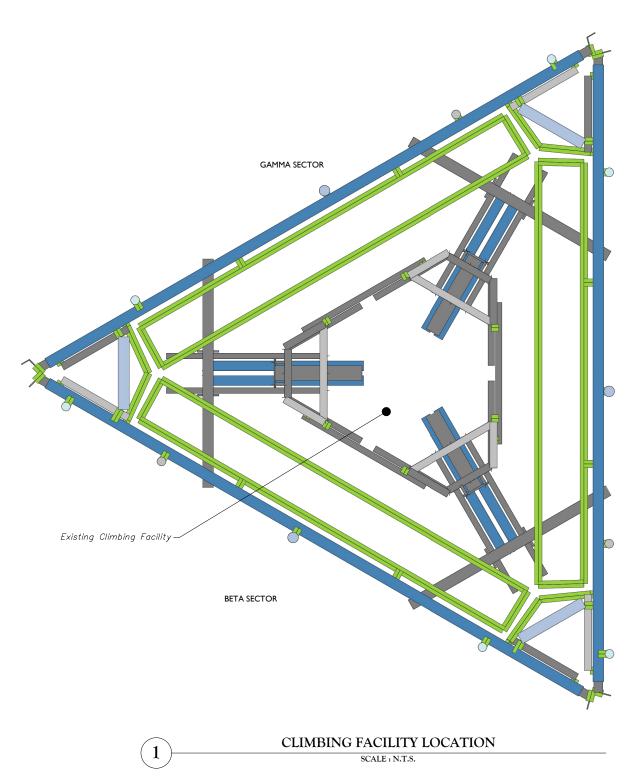



CLIMBING FACILITY PHOTO

STRUCTURAL NOTES:

- I. PER THE MOUNT MAPPING COMPLETED BY ROAMING NETWORKS INC. ON 3/25/2021, THE SAFETY CLIMB AND CLIMBING FACILITIES UP TO THE VERIZON MOUNT ELEVATION (145'-0") ARE IN GOOD CONDITION. COLLIERS ENGINEERING & DESIGN DOES NOT WARRANT THIS INFORMATION.
- INSTALL SHALL NOT CAUSE HARM TO THE STRUCTURE, CLIMBING FACILITY, SAFETY CLIMB, OR ANY SYSTEM INSTALLED ON THE STRUCTURE. TIMELY NOTICE AND DOCUMENTATION SHALL BE PROVIDED BY CONTRACTORS TO THE EOR (OF STRUCTURAL DESIGN) IF AN OBSTRUCTION WAS REQUIRED TO MEET THE RF SYSTEM DESIGN REQUIREMENTS AND PERFORMANCES.






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FOR STATE SPECIFIC DIRECT PHONE NUM

WWW.CALL811.COM

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1	0	6/30/2021	ISSUED FOR CONSTRUCTION	N	FAC	DH		
١	REV	DATE	DESCRIPTION	7	DRAWN BY	CHECKED BY		



IT IS A VIOLATION OF LAW FOR ANY PERSON, UNLESS THEY ARE ACTING UNDER THE DIRECTION OF THE RESPONSIBLE LICENSED PROFESSIONAL ENGINEER, TO ALTER THIS DOCUMENT.

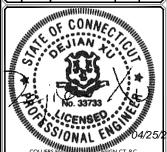SITE NAME:

NEW HARTFORD N CT 468137

115 GREENWOODS INDUSTRIAL PARK NEW HARTFORD, CT 06057 LITCHFIELD COUNTY



STAMFORD 1055 Washington Boulev Stamford, CT 06901 Phone: 203.324.0800

CLIMBING FACILITY DETAIL

SHEET NUMBER

SCF-I


LEGEND:		
	PROPOSED	
	RELOCATED	
	EXISTING	

	MOUNT MODIFICATION SCHEDULE						
NO.	ELEVATION	QUANTITY	DESCRIPTION	NOTES			
ı		1	PROPOSED KICKER KIT (PART #: VZWSMART-PLK5))	CONTRACTOR TO VERIFY THE LENGTH REQUIRED AND TRIM AS NECESSARY IN ACCORDANCE WITH THE 'STRUCTURAL STEEL' NOTES ON SHEET SGN-I. CONNECT OTHER END OF KICKER KIT TO MONOPOLE COLLAR MOUNT ASSEMBLY (PART #: VZWSMART-PLK7).			
2		3		CONTRACTOR SHALL CONNECT PROPOSED L3X3X1/4 ANGLES TO CORNER BRACKETS USING THE PROVIDED (8) 5/8" DIA. BOLTS, (4) BOLTS PER CONNECTION. CONTRACTOR TO VERIFY THE LENGTH REQUIRED AND TRIM AS NECESSARY IN ACCORDANCE WITH THE 'STRUCTURAL STEEL' NOTES ON SHEET SGN-1.			
3	145'-0"	3	170" LONG P2 1/2 STD PIPE	RADIO AND/OR TME POSITIONS SHALL BE ADJUSTED VERTICALLY AS NEEDED IN ORDER TO ACHIEVE INSTALLATION OF HORIZONTAL AS SHOWN. EOR SHALL BE NOTIFIED IF EQUIPMENT NEEDS TO BE RELOCATED TO ANOTHER MOUNT PIPE. CONNECT NEW HORIZONTAL TO ALL VERTICAL MOUNT PIPES WITH CROSSOVER PLATES (PART #: VZWSMART-MSKI).			
4	4	3	72" LONG, P2 1/2 STD PIPE	CONTRACTOR SHALL REMOVE EXISTING MOUNT PIPE IN POSTION 2 ON ALL SECTORS. CONNECT NEW MOUNT PIPE TO EXISTING HORIZONTAL WITH CROSSOVER PLATES (PART #: VZWSMART-MSKI).			
5		9	RELOCATE EXISTING MOUNT PIPES	CONTRACTOR SHALL RELOCATE EXISTING MOUNT PIPES IN POSITIONS 1, 3, AND 4 ON ALL SECTORS. CONNECT MOUNT PIPES TO EXISTING HORIZONTAL WITH CROSSOVER PLATES (PART #: VZWSMART-MSK1).			


NOTES.

INT MEMBERS NOT SHOWN FOR CLARITY U.N.O.

THREADED ROD FROM PROPOSED KITS SHALL BE TRIMMED TO EXTEND NO MORE THAN 3" BEYOND THE LOCK NUT. TREAT ALL CUT ENDS WITH (2) COATS OF COLD GALVANIZATION (ZINGA OR ZINC KOTE).

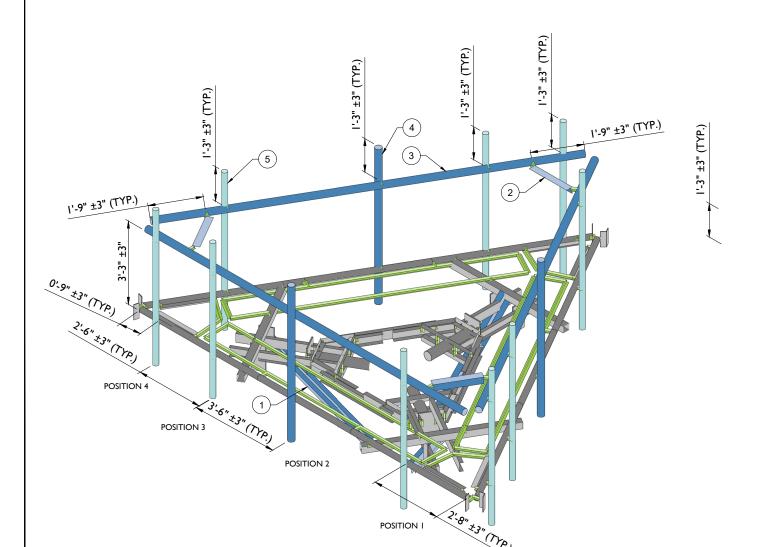


PROPOSED ISOMETRIC VIEW SCALE : N.T.S.

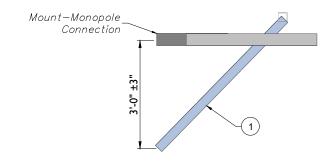

PROPOSED SIDE ELEVATION VIEW (TYP. ALL SECTORS)

SCALE: N.T.S.

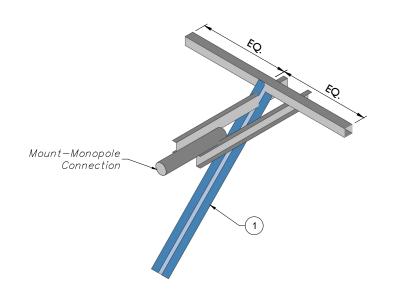

PROPOSED KICKER ISOMETRIC VIEW (TYP. ALL SECTORS)

ALE: N.T.S.



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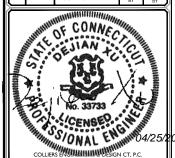


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0	6/30/2021	ISSUED FOR CONSTRUCTION	N	FAC	DH
REV	DATE	DESCRIPTION	N	DRAWN	CHECKED



IT IS A VIOLATION OF LAW FOR ANY PERSON,
UNLESS THEY ARE ACTING UNDER THE DIRECTION
OF THE RESPONSIBLE LICENSED PROFESSIONAL
ENGINEER, TO ALTER THIS DOCUMENT.

SITE NAME:

NEW HARTFORD N CT 468137

115 GREENWOODS INDUSTRIAL PARK NEW HARTFORD , CT 06057 LITCHFIELD COUNTY



1055 Washington Boulev
Stamford, CT 06901
Phone: 203.324,0800
COLLIERS ENGINEERING & DESIGN

MODIFICATION DETAILS

T NUMBER :

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MOUNT PHOTO 1




MOUNT PHOTO 3




MOUNT PHOTO 2



MOUNT PHOTO 4

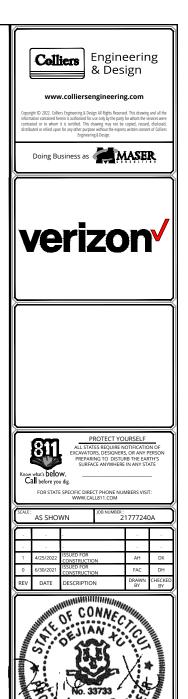

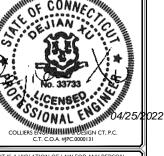


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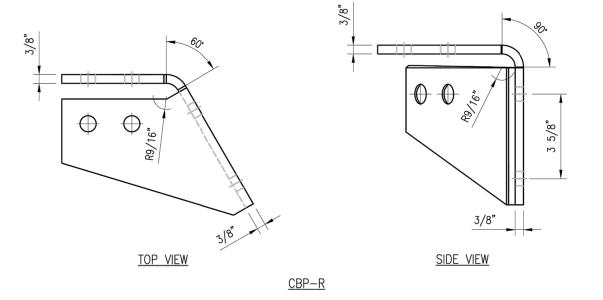
NEW HARTFORD N CT 468137

115 GREENWOODS INDUSTRIAL PARK NEW HARTFORD , CT 06057 LITCHFIELD COUNTY

MOUNT PHOTOS

SS-2



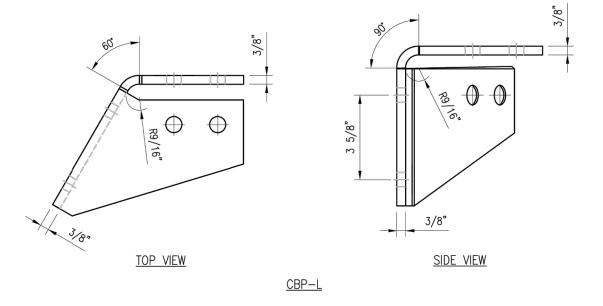

NOTES: 1. HOT-DIPPED GALVANIZED PER ASTM A123.

	VZWSMART-PLK3 (SUPPORT RAIL CORNER BRACKET)						
ITEM NO.			SHEET #	WT			
1	1	CBP-L	CORNER BENT PLATE BRACKET	PLK3-F1	9		
2	1	CBP-R	CORNER BENT PLATE BRACKET	PLK3-F1	9		
3	4	MS02-625-300-500	RU-BOLT 5/8" X 3" I.W. X 5" I.L. A36 (OR EQUIV.)	RBC-1	5		
4	8		BOLT 5/8" X 2" A325		3		
5	16	FW-625	5/8" HDG USS FLAT WASHER		1		
6	16	LW-625	5/8" HDG LOCK WASHER		0		
7	16	NUT-625	5/8" HDG HEX NUT		2		
			(GALVANIZED WT	30		


VzW SMART Tool[©] Vendor



DRAWN BY: H.R	CHECKED BY: HMA
REV. DESCRIPTION FIRST ISSUE	BY DATE H.R 05/08/20
SHEET TITLE:	

VZWSM		
SUPPORT	RAIL	CORNER
BR.	ACKE	Τ

SHEET NUMBER:	REV #:
VZWSMART-PLK3	0

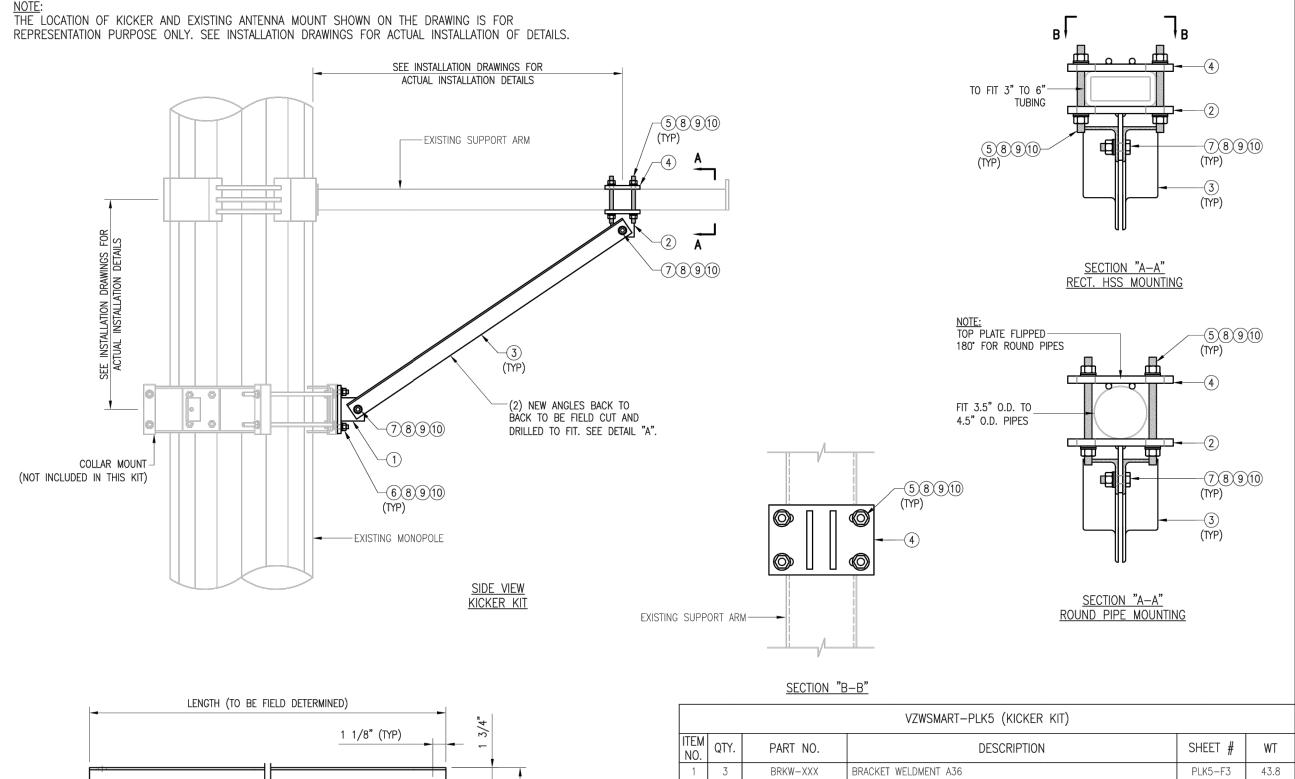

DETAIL "A" —FIELD DRILL 11/16"ø HOLE

NOTES:

- 1. ALL HOLES ARE 11/16" DIA. U.N.O
- 2. HOT-DIPPED GALVANIZED PER ASTM A123.
- 3. FIT UP TO 6" SQ. TUBING OR 4 1/2" O.D. PIPE

	VZWSMART-PLK5 (KICKER KIT)					
ITEM NO. DESCRIPTION SHEET # W				WT		
1	3	BRKW-XXX	BRACKET WELDMENT A36	PLK5-F3	43.8	
2	3	BRKW-XXXX	BRACKET WELDMENT A36	PLK5-F2	35.7	
3	6	L331875-8	L 3" X 3" X 3/16" X 8'-0" A36	PLK5-F4	182.9	
4	3	PL-KI	PL 5/8" X 6" X 9" A36	PLK5-F1	29.0	
5	12		THREADED ROD 5/8" DIA. X 1'-0" F1554-36 HDG			
6	6		BOLT 5/8" X 2" A325			
7	12		BOLT 5/8" X 2 1/2" A325			
8	42	FW-625	5/8" HDG USS FLAT WASHER		3	
9	42	LW-625	5/8" HDG LOCK WASHER		1	
10	42	NUT-625	5/8" HDG HEX NUT		5	
GALVANIZED WT					291	

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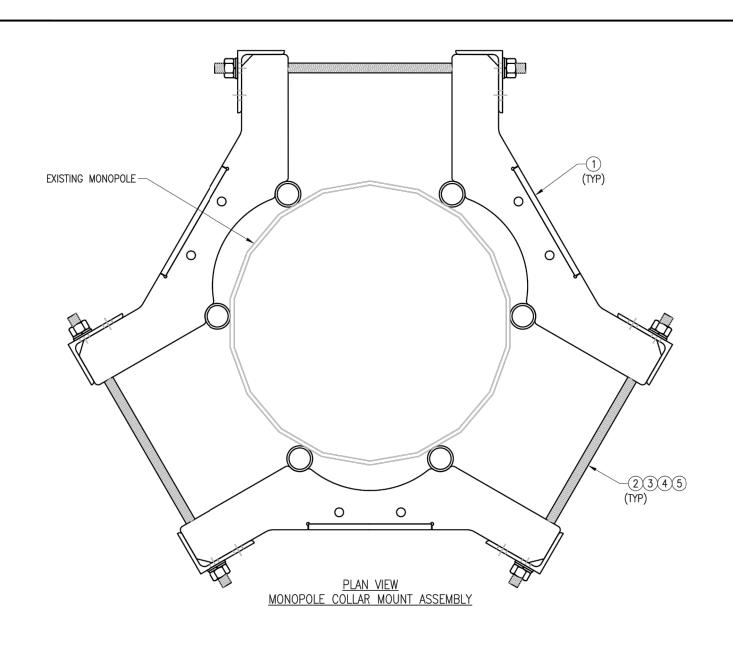



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SHEET TITLE:

VZWSMART-PLK5 KICKER KIT

	SHEET NUMBER:	REV #:
	VZWSMART-PLK5	0



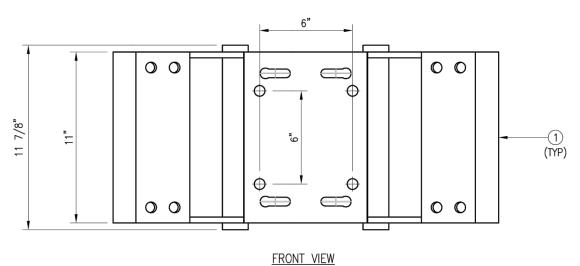

VZWSMART-PLK7	(MONOPOLE	COLLAR	MOUNT	ASSEMBLY	١
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ITEM NO.	QTY.	PART NO.	DESCRIPTION	SHEET #	WT
1	3	CM-1245	COLLAR MOUNT ASSEMBLY	PLK7-F1	147
2	6		THREADED ROD 5/8" X 4'-0" A193-B7		
3	12	FW-625	5/8" HDG USS FLAT WASHER		1
4	12	LW-625	5/8" HDG LOCK WASHER		0
5	12	NUT-625	5/8" HDG HEX NUT		1
			GAL\	/ANIZED WT	150

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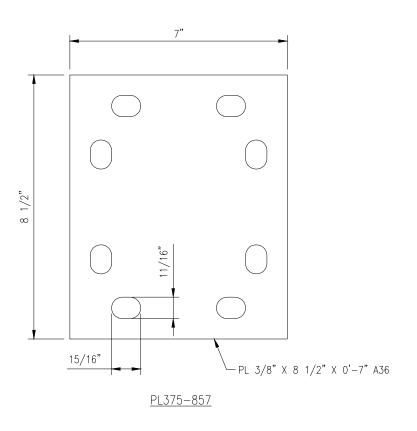
VZWSMART-PLK7 MONOPOLE COLLAR MOUNT ASSEMBLY

SHEET NUMBER: REV #: VZWSMART-PLK7

NOTES:
1. FIT 12" TO 45" DIA MONOPOLE.

2. HOT-DIPPED GALVANIZED PER ASTM A123.

FITS 2.375" O.D. AND 2.875" O.D. VERTICAL PIPE. (NOT INCLUDED IN THIS KIT) FITS 2.375" O.D. AND 2.875" O.D. HORIZONTAL PIPE. (NOT INCLUDED IN THIS KIT)



VZWSMART-MSK1 (CROSSOVER PLATE)						
ITEM NO.	QTY.	PART NO.	DESCRIPTION	SHEET #	WT	
1	1	PL375-857	PL 3/8" X 8 1/2" X 0'-7" A36	MSK1-F1	6	
2	4	MS02-625-300-500	RU-BOLT 5/8" X 3" I.W. X 5" I.L. A36 (OR EQUIV.)	RBC-1	5	
3	8	FW-625	5/8" HDG USS FLAT WASHER		1	
4	8	LW-625	5/8" HDG LOCK WASHER		0	
5	8	NUT-625	5/8" HDG HEX NUT		1	
GALVANIZED WT					14	

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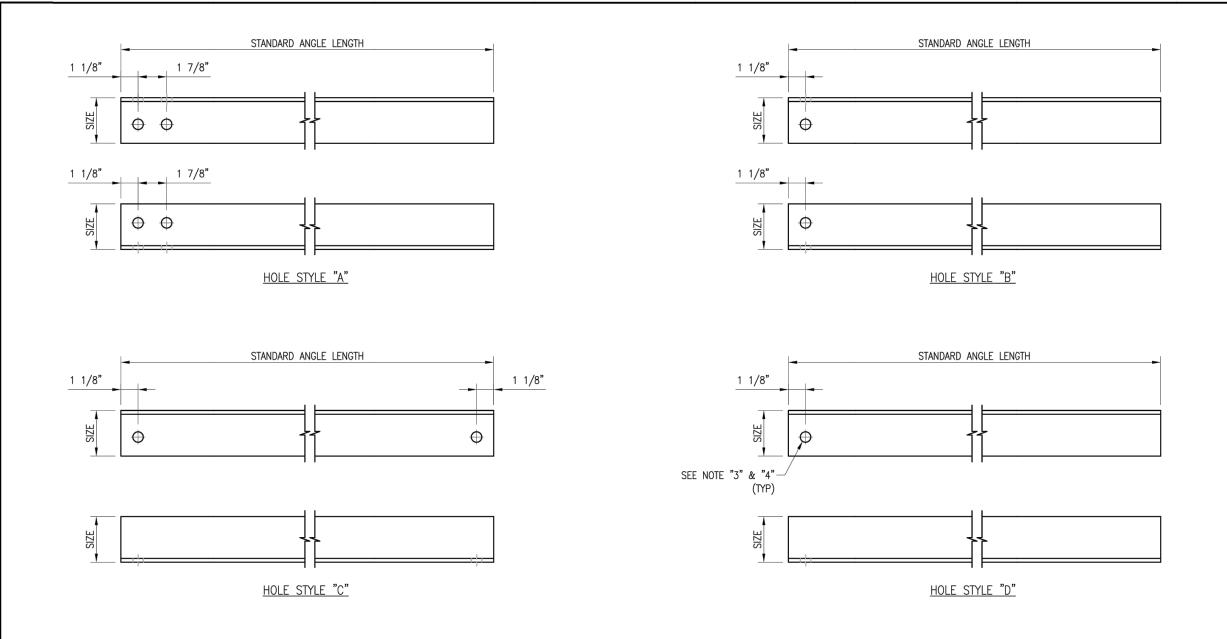
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SHEET TITLE:

VZWSMART-MSK1 CROSSOVER PLATE

SHEET NUMBER:	REV #:
VZWSMART-MSK1	0

NOTES: 1. HOT-DIPPED GALVANIZED PER ASTM A123.



NOTE: APPROVED SMART KIT VENDORS ARE ALLOWED TO SUBSTITUTE AT THEIR DISCRETION
ANGLES LISTED ON THIS PAGE FOR CUSTOM LENGTH COMPONENTS OF MATCHING SIZE. SUBSTITUTIONS SHALL MEET THE ORIGINAL STRUCTURAL INTENT.

- NOTES:

 1. ALL ANGLE GRADE A36 OR BETTER.
 2. HOT-DIPPED GALVANIZED PER ASTM A123.
 3. ALL HOLES ARE 11/16" DIA. U.N.O.

- 4. HOLES MAY OR MAY NOT BE PRESENT, DEPEND UPON MANUFACTURE DISCRETION.
 5. ALL FIELD CUT AND DRILLED SURFACES SHALL BE REPAIRED WITH A MINIMUM OF TWO COATS OF ZINGA OR ZINC COTE PER ASTM A780 AND MANUFACTURER'S RECOMMENDATIONS.

VZWSMART Standard Angle						
VZWSMART Number	Size	Length	Hole Style	Hole Gage	Also Used In:	
A-PLK2-01	L 3" X 3" X 1/4"	96"	A	1-3/4"	VZWSMART-PLK2	
A-PLK5-01	L 3"X 3" X 3/16"	96"	В	1-3/4"	VZWSMART-PLK5	
A-SFK3-01	L 2-1/2" X 2-1/2" X 1/4"	96"	С	1-3/8"	VZWSMART-SFK3,-SFK3-SL, -PLK6, & -PLK8	
A-L25X25X4X120	L 2-1/2" X 2-1/2" X 1/4"	120"	D	1-5/16"		
A-L25X25X4X240	L 2-1/2" X 2-1/2" X 1/4"	240"	D	1-5/16"		
A-L30X30X4X120	L 3" X 3" X 1/4"	120"	D	1-1/2"		
A-L30X30X4X240	L 3" X 3" X 1/4"	240"	D	1-1/2"		
A-L40X40X4X120	L 4" X 4" X 1/4"	120"	D	2"		
A-L40X40X4X240	L 4" X 4" X 1/4"	240"	D	2"		
A-L50X30X6X120	L 5" X 3" X 3/8"	120"	D	2-1/2"		
A-L50X50X6X120	L 5" X 5" X 3/8"	120"	D	2-1/2"		

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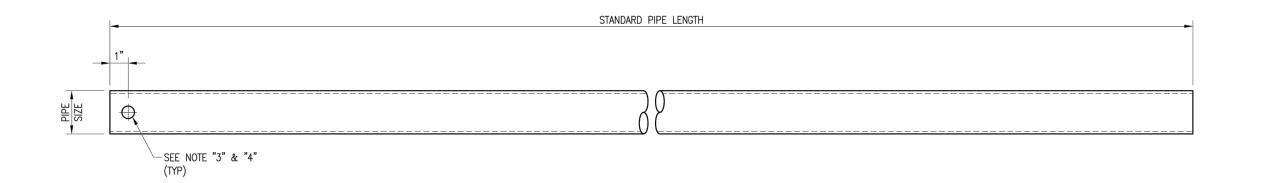
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SHEET TITLE:			

VZWSMART STANDARD ANGLE

VZWSMART-ANGLE

REV #:



VZWSMART Standard Pipe				
VZWSMART Number	Size	Length		
P40-238X048	PIPE 2 SCH40 (2.375" OD x 0.154" THK)	48"		
P40-238X072	PIPE 2 SCH40 (2.375" OD x 0.154" THK)	72"		
P40-238X096	PIPE 2 SCH40 (2.375" OD x 0.154" THK)	96"		
P40-238X120	PIPE 2 SCH40 (2.375" OD x 0.154" THK)	120"		
P40-238X126	PIPE 2 SCH40 (2.375" OD x 0.154" THK)	126"		
P40-238X150	PIPE 2 SCH40 (2.375" OD x 0.154" THK)	150"		
P40-238X174	PIPE 2 SCH40 (2.375" OD x 0.154" THK)	174"		
P40-278X048	PIPE 2.5 SCH40 (2.875" OD x 0.203" THK)	48"		
P40-278X072	PIPE 2.5 SCH40 (2.875" OD x 0.203" THK)	72"		
P40-278X096	PIPE 2.5 SCH40 (2.875" OD x 0.203" THK)	96"		
P40-278X120	PIPE 2.5 SCH40 (2.875" OD x 0.203" THK)	120"		
P40-278X126	PIPE 2.5 SCH40 (2.875" OD x 0.203" THK)	126"		
P40-278X150	PIPE 2.5 SCH40 (2.875" OD x 0.203" THK)	150"		
P40-278X174	PIPE 2.5 SCH40 (2.875" OD x 0.203" THK)	174"		
P40-312X048	PIPE 3 SCH40 (3.5" OD x 0.216" THK)	48"		
P40-312X072	PIPE 3 SCH40 (3.5" OD x 0.216" THK)	72"		
P40-312X126	PIPE 3 SCH40 (3.5" OD x 0.216" THK)	126"		
P40-312X150	PIPE 3 SCH40 (3.5" OD x 0.216" THK)	150"		
P40-312X174	PIPE 3 SCH40 (3.5" OD x 0.216" THK)	174"		

NOTE:
APPROVED SMART KIT VENDORS ARE ALLOWED TO SUBSTITUTE AT THEIR DISCRETION PIPES LISTED ON THIS PAGE FOR CUSTOM LENGTH COMPONENTS OF MATCHING SIZE. SUBSTITUTIONS SHALL MEET THE ORIGINAL STRUCTURAL INTENT.

- NOTES:
 1. ALL PIPE GRADE A53-B OR BETTER.
- 2. HOT-DIPPED GALVANIZED PER ASTM A123.
- 3. ALL HOLES ARE 11/16" DIA. U.N.O
- 4. HOLES MAY OR MAY NOT BE PRESENT, DEPEND UPON MANUFACTURE DISCRETION.
- 5. ALL FIELD CUT AND DRILLED SURFACES SHALL BE REPAIRED WITH A MINIMUM OF TWO COATS OF ZINGA OR ZINC COTE PER ASTM A780 AND MANUFACTURER'S RECOMMENDATIONS.

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RAWN BY: BT	CHECKED BY	: HMA/KW
REV. DESCRIPTION FIRST ISSUE	BY	DATE 08/04/21
SHEET TITLE:		

VZWSMART STANDARD PIPE

SHEET NUMBER: REV #: VZWSMART-PIPE