

STATE OF CONNECTICUT

CONNECTICUT SITING COUNCIL

Ten Franklin Square, New Britain, CT 06051
Phone: (860) 827-2935 Fax: (860) 827-2950
E-Mail: siting.council@ct.gov
www.ct.gov/csc

July 15, 2011

Mark Hulshart, Principal Hulshart & Associates, LLC 3009 Federal Hill Drive Falls Church, VA 22044

RE: **EM-SPRINT-086-110627** – Sprint Spectrum LP notice of intent to modify an existing telecommunications facility located at 71 Moxley Hill Road, Montville, Connecticut.

Dear Mr. Hulshart:

The Connecticut Siting Council (Council) hereby acknowledges your notice to modify this existing telecommunications facility, pursuant to Section 16-50j-73 of the Regulations of Connecticut State Agencies with the following conditions:

- Any deviation from the proposed modification as specified in this notice and supporting materials with Council shall render this acknowledgement invalid;
- Any material changes to this modification as proposed shall require the filing of a new notice with the Council;
- Not less than 45 days after completion of construction, the Council shall be notified in writing that construction has been completed;
- The validity of this action shall expire one year from the date of this letter; and
- The applicant may file a request for an extension of time beyond the one year deadline provided that such request is submitted to the Council not less than 60 days prior to the expiration;

The proposed modifications including the placement of all necessary equipment and shelters within the tower compound are to be implemented as specified here and in your notice dated June 22, 2011. The modifications are in compliance with the exception criteria in Section 16-50j-72 (b) of the Regulations of Connecticut State Agencies as changes to an existing facility site that would not increase tower height, extend the boundaries of the tower site, increase noise levels at the tower site boundary by six decibels, and increase the total radio frequencies electromagnetic radiation power density measured at the tower site boundary to or above the standard adopted by the State Department of Environmental Protection pursuant to General Statutes § 22a-162. This facility has also been carefully modeled to ensure that radio frequency emissions are conservatively below State and federal standards applicable to the frequencies now used on this tower.

This decision is under the exclusive jurisdiction of the Council. Please be advised that the validity of this action shall expire one year from the date of this letter. Any additional change to this facility will require explicit notice to this agency pursuant to Regulations of Connecticut State Agencies Section 16-50j-73. Such notice shall include all relevant information regarding the proposed change with cumulative worst-case modeling of radio frequency exposure at the closest point of uncontrolled access to the tower base, consistent with Federal Communications Commission, Office of Engineering and Technology, Bulletin 65. Thank you for your attention and cooperation.

Very truly yours,

Linda Roberts
Executive Director

LR/CDM/laf


c: The Honorable Joseph W. Jaskiewicz, Mayor, Town of Montville Marcia Vlaun, Town Planner, Town of Montville SBA Inc.

HULSHART & ASSOCIATES, LLC STRATEGIC CONSULTING TO THE COMMUN

EM-SPRINT-086-110627

3009 FEDERAL HILL DRIVE LS CHURCH, VIRGINIA 22044 phone 703.533.1006

June 22, 2011

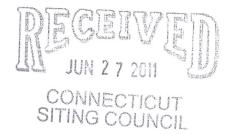

Chairman Robert Stein Connecticut Siting Council 10 Franklin Square New Britain, CT 06051

SUBJECT: Sprint Spectrum L.P.'s Notice of Intent to Make an Exempt Modification to an

Existing Facility at 71 Moxley Hill Road, Montville, CT 06353

(Site # CT23XC400)

Dear Chairman Stein:

Pursuant to R.C.S.A. Sections 16-50j-73 and 16-50j-72(b), Sprint Spectrum L.P. (Sprint) hereby gives notice to the Connecticut Siting Council (Council) and the Town of Montville of its intent to make an exempt modification to an existing telecommunications facility located at 71 Moxley Hill Road, Montville, Connecticut.

Sprint plans to install a hydrogen fuel cell at its 71 Moxley Hill Road facility to provide emergency backup power in the event of an electric outage. This planned installation does not constitute a modification subject to the Council's review as it falls within those activities provided for in R.C.S.A. Section 16-50j-72(b)(2). Specifically, this installation will not change the height of the existing tower, will not extend the boundaries of the existing compound, will not increase noise levels at the site by six decibels or more, and will not increase the total radio frequency electromagnetic radiation power density at the site to levels above applicable standards.

PROPOSED INSTALLATION

Sprint plans to install a 5 kW Altergy hydrogen fuel cell generator within the existing fenced equipment compound; the installation mounted to an existing concrete pad. The fuel cell will be inside a cabinet measuring 3'4" x 2'4" x 6'0". The hydrogen cylinder storage cabinet has overall dimensions of 4'8" x 4'8" x 6'0".

Please contact me at 703.533.1006 or <u>Hulshart@earthlink.net</u> should you have any questions about this planned modification.

Sincerely

Mark Hulshart

Principal

cc: Mayor Joseph W. Jaskiewicz, Town of Montville

Ernest Wainwright & Walter Wainwright Jr. (property owner)

Specifications



0,7	dom Power™ 5 kW System n FPS Power Cabinet	FPS-524-240	FPS-524-240-400	FPS-548-240	FPS-548-240-405
Physical	Dimensions (w x d x h)	26" x 42" x 72" [66 cm x 107 cm x 183 cm]			
	Weight	515 lb [234 kg]	706 lb [320 kg]	515 lb [234 kg]	706 lb [320 kg]
	Number of FPS Engines		1		
	Number of TPMs	0	1	0	1
Performance	Rated power	•	5 k'	W	
	Rated current	2	10 A	1	05 A
	Operating voltage (nominal)	24	VDC	48	VDC
	Operating voltage (range)	21 to 29 VDC		42 to	58 VDC
	Standing Input Current (nominal)	1.92 A @ 24 VDC		0.96 A	@ 48 VDC
Operation	Ambient temperature ²	- 4 °F to 104 °F [- 20 °C to +40 °C]			
	Relative humidity, noncondensing	5 to 100%			
	Location	Outdoor only			
	Auxiliary AC in ²	120 V, 60 Hz, 10 A. single phase			
Storage	Ambient temperature	+ 40 °F to +113 °F [+4 °C to +45 °C]			
	Relative humidity, noncondensing	5 to 100%			
Fuel	Gaseous hydrogen purity	Hydrogen (H ₂) 99.95% certified Industrial Grade			al Grade
	Supply pressure range	40 to 150 PSIG [2.8 to 10.5 kg/cm²]			
	Typical operating pressure	100 PSIG [7.03 kg/cm²]			
	Consumption	300 g/hour @ 5 kW			
Monitoring / Control	Standard		Ethernet, USB, Ser	ial, 4 Dry Conta	ncts
	Optional		Wireless	Telemetry	
	Rectifier Supply Voltage	n/a	27.0 ± 0.6 VDC	n/a	54.0 ± 0.6 VDC

¹Polarity is determined by customer requirements and ground connections.

MAN-0005 REV A - March 2010

²For operation below +10 °C, the FPS must be connected to the grid and supplied with AC power until a grid failure, at which time the heat generated by the FPS will be sufficient to maintain operation of the FPS at temperatures between -20 °C and +10 °C.



SITE NAME:

MONTVILLE S.

SITE NUMBER:

CT23XC400

SITE ADDRESS:

71 MOXLEY HILL ROAD

MONTVILLE, CT 06353

SITE TYPE:

EXISTING 190'-0" GUYED TOWER

T-1

C-1

C-2

S-1

S-2

E-1

F-2

E-3

E-4




6580 SPRINT PARKWAY OVERLAND PARK, KANSAS 66251



10950 GRANDVIEW DRIVE OVERLAND PARK, KANSAS 66210 (913) 458-2000

PROJECT NO:	168202
DRAWN BY:	AKJ
CHECKED BY:	ВЈН

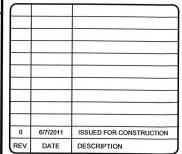



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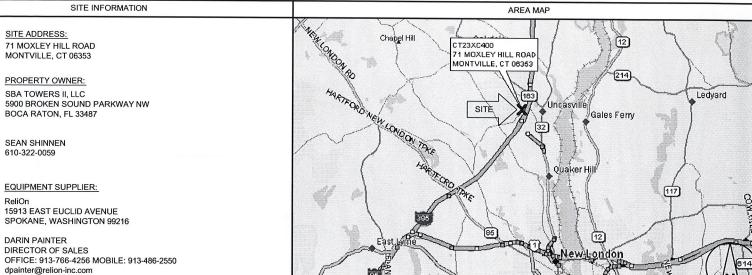
MONTVILLE S. CT23XC400 71 MOXLEY HILL ROAD **MONTVILLE, CT 06353 CO-LOCATION**

SHEET TITLE

TITLE SHEET & PROJECT DATA

SHEET NUMBER

T-1



LOCATION MAP CT23XC400 71 MOXLEY HILL ROAD MONTVILLE, CT 06353

IN THE EVENT OF CONFLICT, THE MOST RESTRICTIVE CODE SHALL

2005 NEC NATIONAL ELECTRICAL CODE

CONNECTICUT AMENDMENTS

CONNECTICUT AMENDMENTS

PROJECT DESCRIPTION

INSTALL POWER BACK UP EQUIPMENT TO EXISTING SITE WITHIN EXISTING COMPOUND. INSTALL (1) NEW FUEL CELL WITH (1) FUEL STORAGE CABINET ON CONCRETE PAD AND CONNECT TO THE SITE'S DC POWER PLANT BUS.

APPLICABLE CODES

ALL WORK SHALL COMPLY WITH THE FOLLOWING APPLICABLE

2003 INTERNATIONAL MECHANICAL CODE WITH 2005 STATE OF

2003 INTERNATIONAL PLUMBING CODE WITH 2005 STATE OF

2003 INTERNATIONAL BUILDING CODE WITH 2005 STATE OF

ENGINEER OF RECORD

DRAWING INDEX

TITLE SHEET & PROJECT DATA

EQUIPMENT CABINET DETAILS

HYDROGEN PIPING SCHEMATIC

ELECTRICAL ONE-LINE DIAGRAM

OVERALL CONDUIT DETAILS

FUEL CELL INSTALL DETAIL

ELECTRICAL WIRING DIAGRAM

GROUNDING PLAN AND DETAILS

CONCRETE PAD DETAILS

OVERALL SITE PLAN

SITE PLAN

CHRISTOPHER ALAN KRAFFT

BLACK & VEATCH CORPORATION

DRIVING DIRECTIONS FROM NEAREST AIRPORT

GROTON-NEW LONDON AIRPORT: HEAD WEST ON S ROAD/RUNWAY LANE/TOWER AVENUE TOWARDS RHODE ISLAND LANE, TURN RIGHT AT HIGH ROCK ROAD, TURN LEFT AT POQUONNOCK ROAD, TURN RIGHT AT MITCHELL STREET, CONTINUE ONTO NORTH STREET, TAKE THE RAMP ONTO I-95 S, TAKE THE EXIT TOWARDS CT-32 N, TAKE EXIT 84 E TO MERGE ONTO CT-32 N TOWARDS NORWICH, TURN LEFT AT MAPLE ROAD, CONTINUE ONTO JEROME ROAD, TURN LEFT AT MOXLEY ROAD, DESTINATION WILL BE ON THE RIGHT.

COUNTY: NEW LONDON LATITUDE (NAD83):

POWER COMPANY:

PHONE: 800-286-5000

TELCO COMPANY:

CONNECTICUT LIGHT & POWER

41° 26' 7.555" N

41.435432

LONGITUDE (NAD83):

72° 7' 26.043" W -72.123901

CONTACT ENGINEER:

BRYAN HANSEN WORK: 913-458-7343 E-MAIL: hansenbj@bv.com







10950 GRANDVIEW DRIVE OVERLAND PARK, KANSAS 66210 (913) 458-2000

168202
AKJ
МВ

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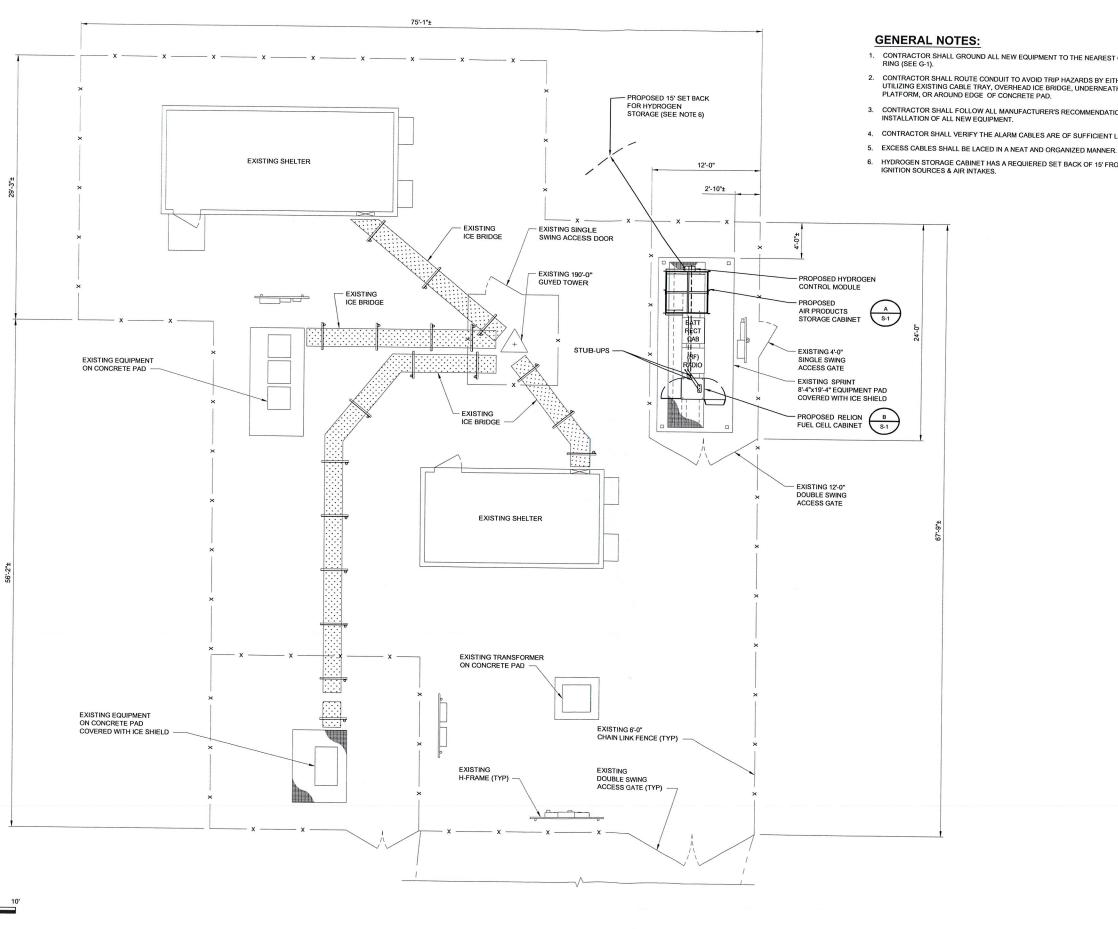
MONTVILLE S. CT23XC400 71 MOXLEY HILL ROAD MONTVILLE, CT 06353 CO-LOCATION

SHEET TITLE

OVERALL SITE PLAN

SHEET NUMBER

C-1



SITE PLAN

- CONTRACTOR SHALL GROUND ALL NEW EQUIPMENT TO THE NEAREST GROUND RING (SEE G-1).
- CONTRACTOR SHALL ROUTE CONDUIT TO AVOID TRIP HAZARDS BY EITHER UTILIZING EXISTING CABLE TRAY, OVERHEAD ICE BRIDGE, UNDERNEATH RAISED PLATFORM, OR AROUND EDGE OF CONCRETE PAD.
- CONTRACTOR SHALL FOLLOW ALL MANUFACTURER'S RECOMMENDATIONS FOR INSTALLATION OF ALL NEW EQUIPMENT.
- 4. CONTRACTOR SHALL VERIFY THE ALARM CABLES ARE OF SUFFICIENT LENGTH.
- HYDROGEN STORAGE CABINET HAS A REQUIERED SET BACK OF 15' FROM IGNITION SOURCES & AIR INTAKES.



6580 SPRINT PARKWAY OVERLAND PARK, KANSAS 66251



BLACK & VEATCH

10950 GRANDVIEW DRIVE OVERLAND PARK, KANSAS 66210 (913) 458-2000

PROJECT NO: 168202 DRAWN BY: AKJ CHECKED BY: МВ

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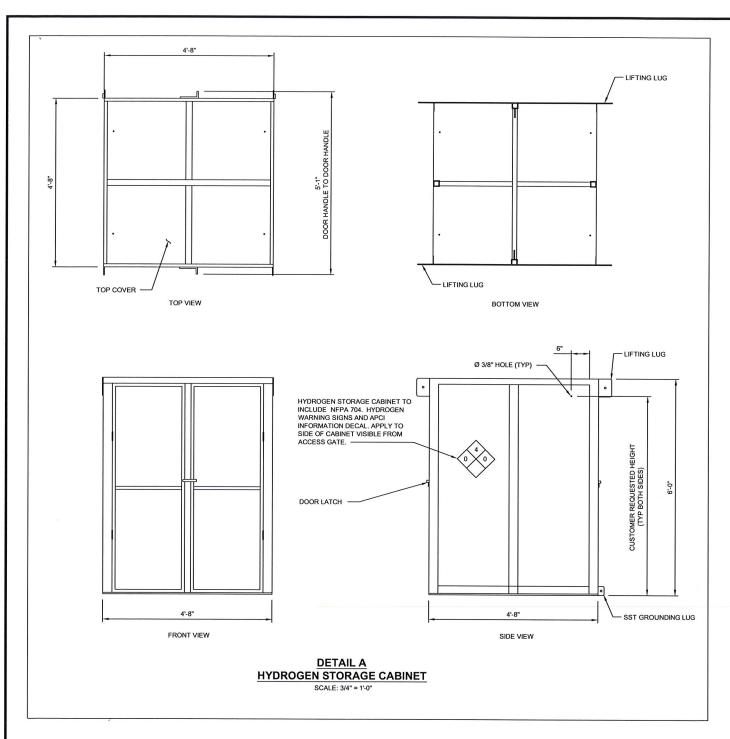
MONTVILLE S. CT23XC400 71 MOXLEY HILL ROAD **MONTVILLE, CT 06353 CO-LOCATION**


SHEET TITLE

SITE PLAN

SHEET NUMBER

C-2



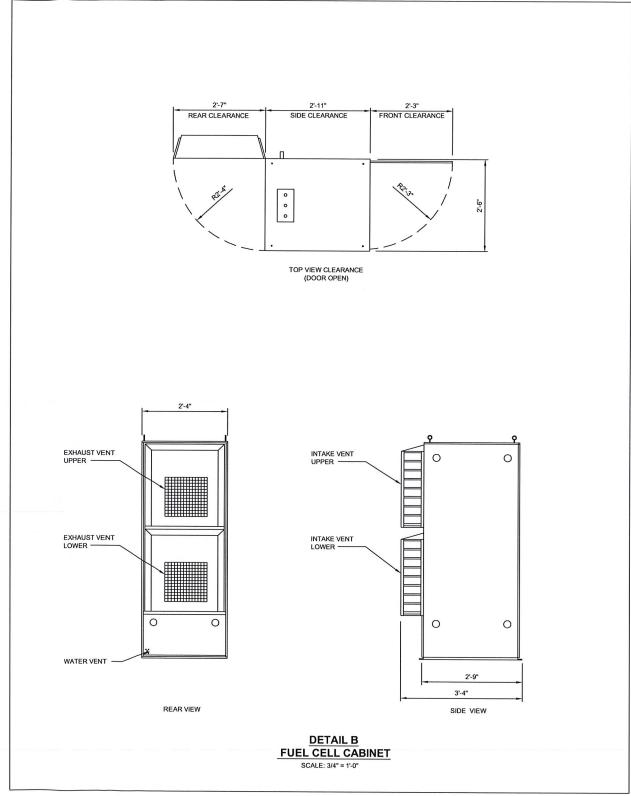






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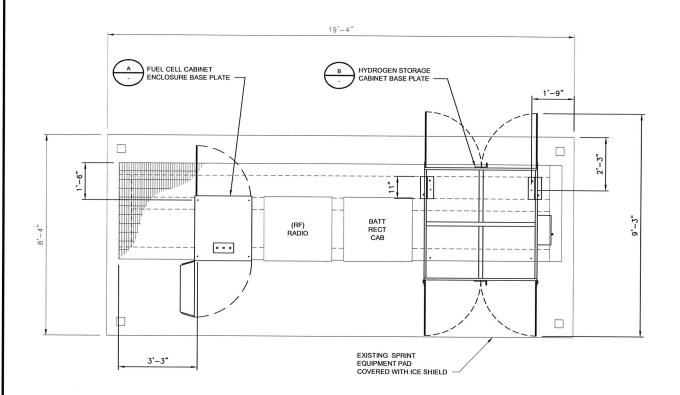
MONTVILLE S. CT23XC400 71 MOXLEY HILL ROAD MONTVILLE, CT 06353 CO-LOCATION

SHEET TITLE

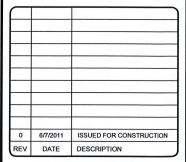EQUIPMENT CABINET DETAILS

SHEET NUMBER

S-1



PLAN VIEW CONCRETE PAD

SCALE: 3/4" = 1'-0"

EXISTING
STELL FRAME ON
CONCRETE PAD

SCALE: 34" = 1:0"

EXISTING
ICE SHIELD


FROPOSED HYDROGEN
CCNTROL MODULE

PROPOSED HYDROGEN
STAINLESS STEEL PIPING
PROPOSED CONTROL
WIRING CONDUIT

EXISTING
STEEL FRAME ON
CONCRETE PAD

EXISTING
SPINT
S-4-X19-4" EQUIPMENT PAD

S'-0" 4'-9" 4'-3" EXISTING W8x24 EXISTING W8x24

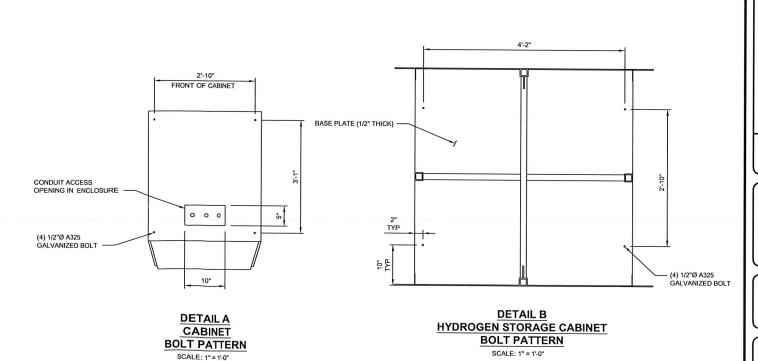



6580 SPRINT PARKWAY OVERLAND PARK, KANSAS 66251



10950 GRANDVIEW DRIVE OVERLAND PARK, KANSAS 66210 (913) 458-2000

168202

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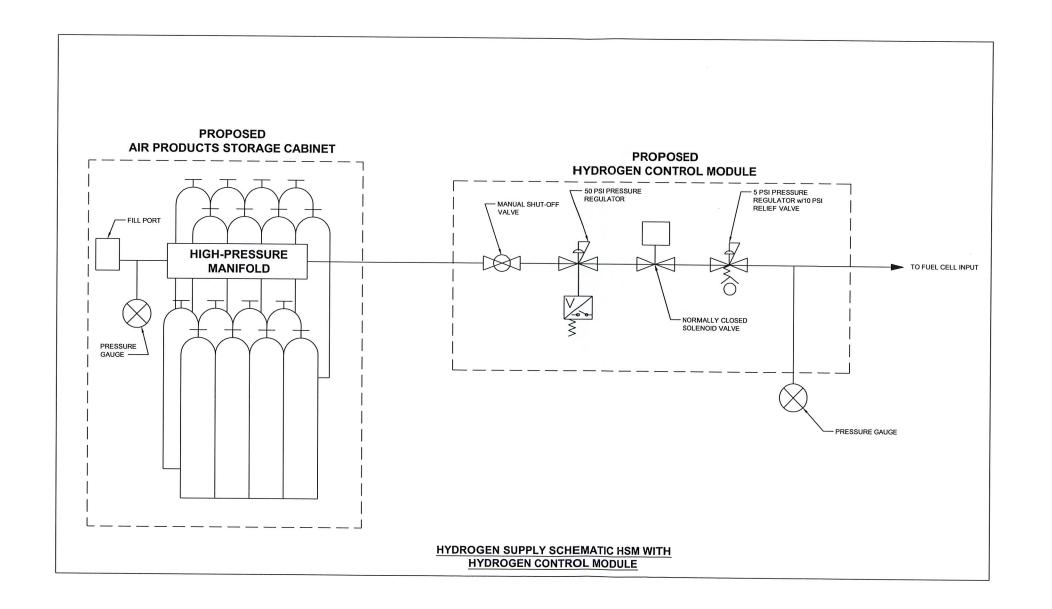
MONTVILLE S. CT23XC400 71 MOXLEY HILL ROAD MONTVILLE, CT 06353 CO-LOCATION

SHEET TITLE

CONCRETE PAD DETAILS

SHEET NUMBER

S-2








10950 GRANDVIEW DRIVE OVERLAND PARK, KANSAS 66210 (913) 458-2000

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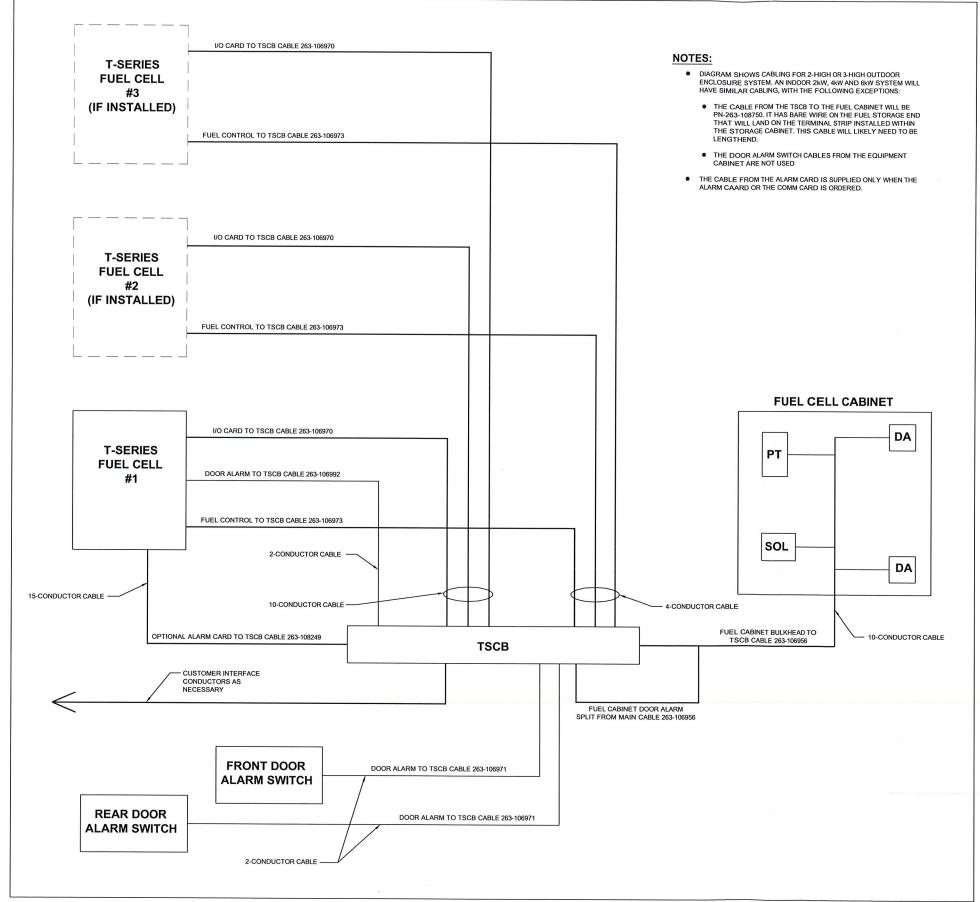
MONTVILLE S. CT23XC400 71 MOXLEY HILL ROAD MONTVILLE, CT 06353 CO-LOCATION

SHEET TITLE

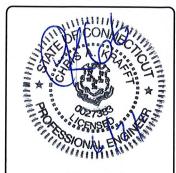HYDROGEN PIPING SCHEMATIC

SHEET NUMBER

M-1



T-SERIES SIGNAL INTERCONNECT DIAGRAM

GENERAL ELECTRICAL NOTES:

- ALL ELECTRICAL WORK SHALL CONFORM TO THE LATEST EDITION OF THE NATIONAL ELECTRICAL CODE (NEC), AND LOCAL CODES.
- ALL ELECTRICAL MATERIALS, EQUIPMENT AND INSTALLATION PROCEDURES SHALL CONFORM WITH SPRINT'S STANDARD CONSTRUCTION SPECIFICATIONS.
- 3. ALL MATERIALS SHALL BE MANUFACTURED IN ACCORDANCE WITH APPLICABLE STANDARDS ESTABLISHED BY ANSI, NEMA NFPA, AND "UL" LISTED.
- THE ELECTRICAL PLANS, DETAILS, AND DIAGRAMS SHOWN ON THESE DRAWINGS ARE DIAGRAMMATIC ONLY. ACTUAL FIELD CONDITIONS AND SITE REQUIREMENTS SHALL DICTATE THE AMOUNT AND LOCATION OF EQUIPMENT.
- 5. THE ENTIRE ELECTRICAL INSTALLATION SHALL BE GROUNDED AS REQUIRED BY THE NEC AND ALL APPLICABLE LOCAL CODES.
- 6. ALL CIRCUIT BREAKERS, FUSES AND ELECTRICAL EQUIPMENT SHALL HAVE A MINIMUM INTERRUPTING RATING OF 65,000 AIC (UNLESS NOTED OTHERWISE).
- REFER TO THE VENDOR DRAWINGS OF THE PPC CABINET, BATTERY, AND BTS CABINETS FOR COMPLETE INTERNAL WIRING AND ARRANGEMENT.
- 8. PATCH, REPAIR AND PAINT ANY AREA THAT HAS BEEN DAMAGED IN THE COURSE OF THE ELECTRICAL INSTALLATION.
- 9. LABEL ALL ELECTRICAL EQUIPMENT PER SPRINT'S SPECIFICATIONS.
- ALL SINGLE-PHASE SELF-CONTAINED METER CONNECTION DEVICES MUST INCLUDE HORN TYPE BYPASS PROVISIONS SO THAT SERVICE WILL NOT BE INTERRUPTED WHEN A METER IS REMOVED FROM THE SOCKET.
- 11. USE METER CONNECTION DEVICES LABELED BY THE MANUFACTURER WITH THE LETTERS
- ALL INTERIOR CONDUITS AND BUSHINGS SHALL BE EMT. ALL EXTERIOR SHALL BE PVC UNLESS NOTED OTHERWISE (SEE SPRINT'S STANDARD CONSTRUCTION SPECIFICATIONS).
- 13. PROVIDE 2 PULL STRINGS SECURELY FASTENED AT EACH END OF ALL CONDUITS. THE PULL STRINGS ARE TO BE 200 LB. TEST POLYETHYLENE CORD. PROVIDE CAP ON THE END OF EACH CONDUIT AND MARK AS SHOWN ON THIS SITE PLAN.
- 14. THE CONTRACTOR SHALL LOCATE AND MARK ALL EXISTING UNDERGROUND POWER, TELCO, GROUNDING CONDUITS, AND ALL OTHER UTILITIES EASEMENTS AND/OR WIRES PRIOR TO TRENCHING. ANY DAMAGE CAUSED TO THE EXISTING UNDERGROUND SERVICES OR SYSTEMS SHALL BE REPAIRED AT THE CONTRACTOR'S EXPENSE. VERIFY WITH UTILITY MER SERVICE HAS BEEN APPLIED FOR. THERE SHALL BE NO SPLICING OF GROUND CONDUCTORS BELOW GRADE.
- UTILITY RACK AND CONDUIT SIZES TO BE FIELD DETERMINED BY CONTRACTOR IN ACCORDANCE WITH THE LOCAL JURISDICTION.
- ALL WORK SHALL MEET OR EXCEED ALL APPLICABLE LOCAL AND NATIONAL ELECTRICAL CODE REQUIREMENTS.
- 17. ALL INSTALLATION AND EQUIPMENT SHALL MEET OR EXCEED SPRINT CONSTRUCTION SPECIFICATIONS.

ELECTRICAL NOTES:

- 1. LIGHT SHADED LINES INDICATE EXISTING CONSTRUCTION.
- CONTRACTOR TO VERIFY POWERWAVE MODEL AND ASSOCIATED POWER REQUIREMENTS.
 IF LARGER CIRCUIT BREAKERS ARE REQUIRED, CONTRACTOR SHALL PROVIDE CORRECT ELECTRICAL
 CONDUCTOR SIZES.



6580 SPRINT PARKWAY OVERLAND PARK, KANSAS 66251



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10950 GRANDVIEW DRIVE OVERLAND PARK, KANSAS 66210 (913) 458-2000

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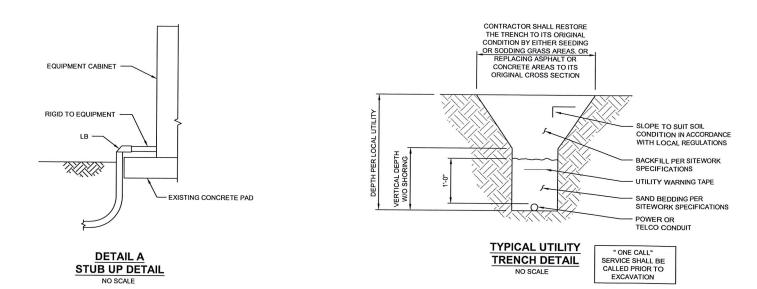
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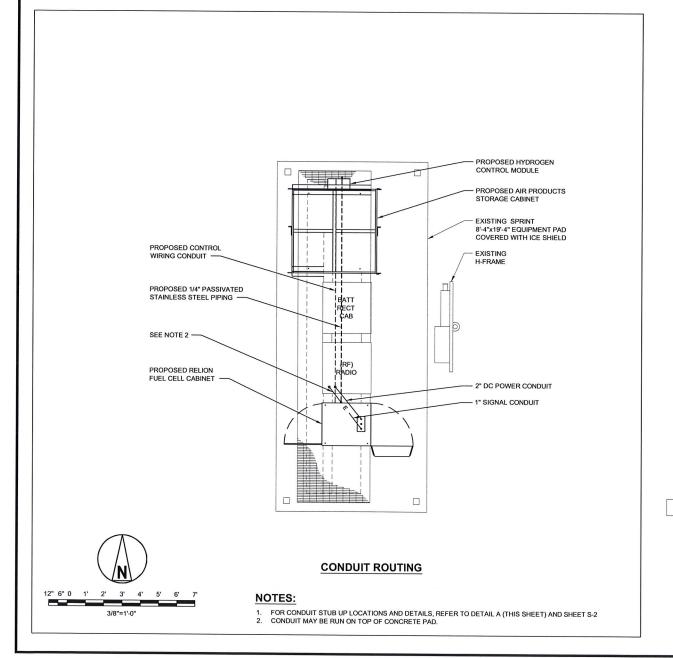
SHEET TITLE

ELECTRICAL ONE-LINE DIAGRAM

SHEET NUMBER

E-1





GENERAL NOTES:

- MATERIALS: ALL HANGERS, SUPPORTS, FASTENERS AND HARDWARE SHALL BE ZINC COATED OR OF EQUIVALENT CORROSION RESISTANCE BY TREATMENT OR INHERENT PROPERTY, AND SHALL BE MANUFACTURED PRODUCTS DESIGNED FOR THE APPLICATION. PRODUCTS FOR OUTDOOR USE SHALL BE HOT DIP GALVANIZED.
- CONDUIT SEALS: INSTALL CONDUIT SEAL FOR EACH CONDUIT PENETRATING AN EXTERIOR BUILDING WALL BELOW
 GRADE (UNLESS PENETRATION IS BELOW LOWEST BUILDING FLOOR SLAB), AND ELSEWHERE AS INDICATED, AND SO AS
 TO ACHIEVE A SEALED WATERTIGHT INSTALLATION. MATCH EXISTING CONDITIONS AND MEET OR EXCEED INTEGRITY OF
 WALLS.
- INSTALLATION: RIGIDLY SUPPORT AND SECURE ALL MATERIALS, RACEWAY AND EQUIPMENT TO BUILDING STRUCTURE USING HANGERS, SUPPORTS AND FASTENERS, SUITABLE FOR THE USE, MATERIALS AND LOADS ENCOUNTERED. PROVIDE ALL NECESSARY HARDWARE. PROVIDE CONDUIT SUPPORTS AT MAXIMUM 5 FT. O.C.
- . STRUCTURAL MEMBERS: DO NOT CUT, DRILL OR WELD ANY STRUCTURAL MEMBER EXCEPT AS SPECIFICALLY APPROVED BY THE ENGINEER.
- INDEPENDENT SUPPORT: DO NOT SUPPORT MATERIALS OR EQUIPMENT FROM OTHER EQUIPMENT, PIPING, DUCTWORK OR SUPPORTS FOR SAME.
- MISCELLANEOUS SUPPORTS: PROVIDE ANY ADDITIONAL STRUCTURAL SUPPORT STEEL BRACKETS ANGLES, FASTENERS AND HARDWARE AS REQUIRED TO ADEQUATELY SUPPORT ALL ELECTRICAL MATERIALS AND EQUIPMENT.
- 7. ONE HOLE STRAPS SHALL NOT BE USED FOR CONDUITS LARGER THAN 3/4"Ø.



6580 SPRINT PARKWAY OVERLAND PARK, KANSAS 66251



10950 GRANDVIEW DRIVE OVERLAND PARK, KANSAS 66210 (913) 458-2000

168202

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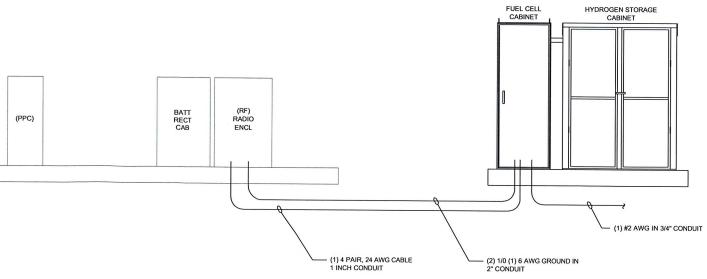
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SHEET TITLE


OVERALL CONDUIT DETAILS

SHEET NUMBER

E-2



ELECTRICAL & SIGNAL RISER DIAGRAM

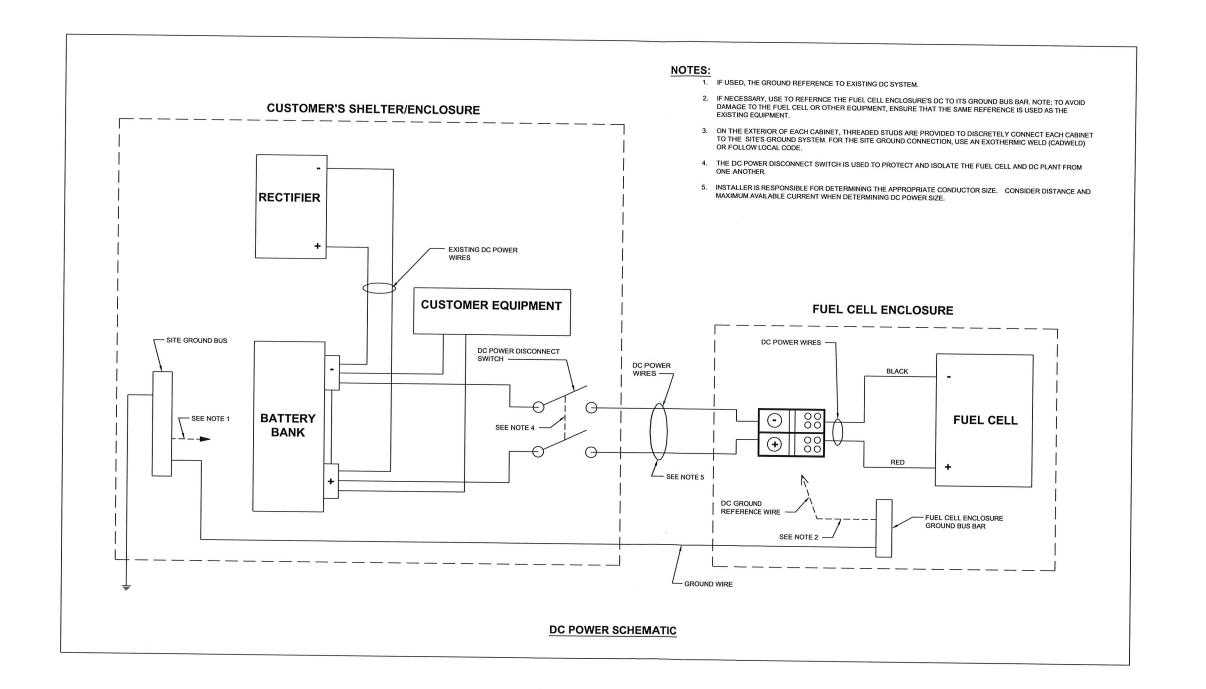





10950 GRANDVIEW DRIVE OVERLAND PARK, KANSAS 66210 (913) 458-2000

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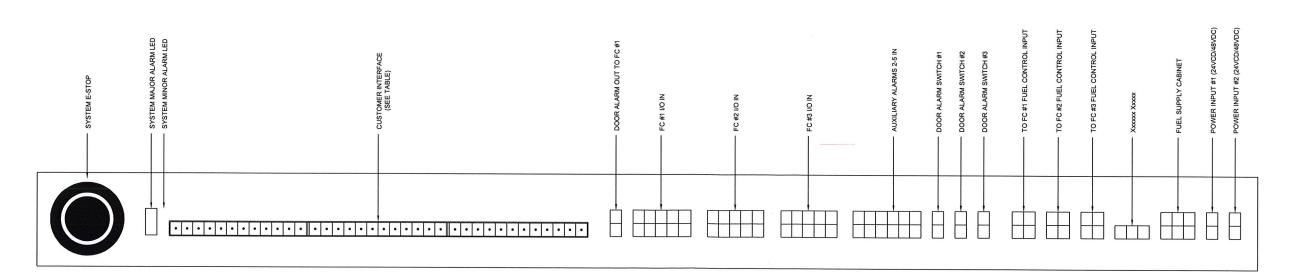
SHEET TITLE

ELECTRICAL WIRING DIAGRAM

SHEET NUMBER

E-3

CUSTOMER CONNECTIONS									
NOTES	<u> </u>	SIGNAL NAME	<u>PIN</u>	NOTES	SIGNAL NAME	PIN	NOTES	SIGNAL NAME	PIN
AUXILIARY RELAYS 2 THROUGH 5		AUX. 2 ALARM RELAY (N.O.)	25	THERE IS 1.1 k OHM SERIES	FC #1 AUX. ALARM RELAY (N.O.)	13	THERE IS 1.1 k OHM SERIES RESISTANCE BETWEEN PINS 1 & 2	DOOR SWITCH ALARM	1
ARE AVAILABLE WITH THE ADDITION OF AN OPTIONAL ALARM CARD OR	(COMMON)	AUX. 2 ALARM RELAY (COMMOI	26	RESISTANCE BETWEEN PINS 1 & 2	FC #1 AUX. ALARM RELAY (COMMON)	14	RESISTANCE BETWEEN FINS 1 & 2	DOOR SWITCH ALARM RETURN	2
COMM CARD INSTALLED ONTO ONE OF THE FUEL CELLS		AUX. 2 ALARM RELAY (N.C.)	27		FC #1 AUX. ALARM RELAY (N.C.)	15		NOT USED	3
	′ (N.O.)	AUX. 2 ALARM RELAY (N.O.)	28		FC #2 AUX. ALARM RELAY (N.O.)	16		NOT USED	4
	(COMMON)	AUX. 3 ALARM RELAY (COMMO	29		FC #2 AUX. ALARM RELAY (COMMON.)	17		SYSTEM MAJOR ALARM (N.O.)	5
	(N.C.)	AUX. 3 ALARM RELAY (N.C.)	30		FC #2 AUX. ALARM RELAY (N.C.)	18		SYSTEM MAJOR ALARM (COMMON)	6
	(N.O.)	AUX. 3 ALARM RELAY (N.O.)	31		FC #3 AUX. ALARM RELAY (N.O.)	19		SYSTEM MAJOR ALARM (N.C.)	7
	(COMMON)	AUX. 4 ALARM RELAY (COMMO	32		FC #3 AUX. ALARM RELAY (COMMON)	20		SYSTEM MINOR ALARM (N.O.)	8
	(N.C.)	AUX. 4 ALARM RELAY (N.C.)	33		FC #3 AUX. ALARM RELAY (N.C.)	21		SYSTEM MINOR ALARM (COMMON)	9
	(N.O.)	AUX. 5 ALARM RELAY (N.O.)	34		PRESSURE SW ALARM RELAY (N.O.)	22		SYSTEM MINOR ALARM (N.C.)	10
	(COMMON)	AUX. 5 ALARM RELAY (COMMON	35		PRESSURE SW ALARM RELAY (COMMON)	23	THESE ARE WETTED CONTACTS; USE A CLOSED SWITCH TO ACTIVATE.	CONTACT START	11
	(N.C.)	AUX. 5 ALARM RELAY (N.C.)	36		PRESSURE SW ALARM RELAY (N.C.)	24	A GLOSED SWITCH TO ACTIVATE.	CONTACT START RETURN	12
	(N.C.)	AUX. 5 ALARM RELAY (N.C.)	36		PRESSURE SW ALARM RELAT (N.C.)	24		CONTROL CHILL REPORT	



T-SERIES SIGNAL AND CONTROL CONNECTIONS




6580 SPRINT PARKWAY OVERLAND PARK, KANSAS 66251



10950 GRANDVIEW DRIVE OVERLAND PARK, KANSAS 66210 (913) 458-2000

	PROJECT NO:	168202
- 1	DRAWN BY:	AKJ
	CHECKED BY:	МВ

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	100		
	0	6/7/2011	ISSUED FOR CONSTRUCTION
	REV	DATE	DESCRIPTION

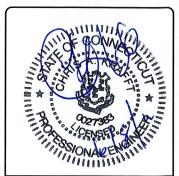

IT IS A VIOLATION OF LAW FOR ANY PERSON, UNLESS THEY ARE ACTING UNDER THE DIRECTION OF A LICENSED PROFESSIONAL ENGINEER, TO ALTER THIS DOCUMENT.

MONTVILLE S. CT23XC400 71 MOXLEY HILL ROAD MONTVILLE, CT 06353 CO-LOCATION


SHEET TITLE

FUEL CELL INSTALL DETAIL


SHEET NUMBER

E-4

THE DETAILS ON THIS SHEET APPLY ONLY AS CALLED OUT ON SITE PLANS OR SITE SPECIFIC DRAWINGS.

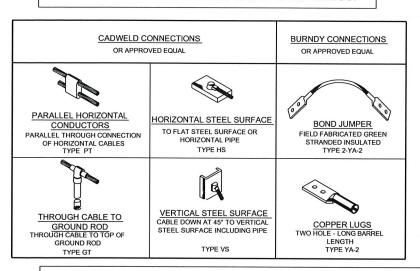

3/8"=1'-0"

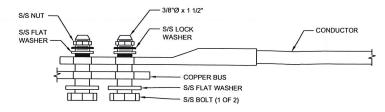


NO SCALE

NOTES:

- 1. ALL HARDWARE 18-8 STAINLESS STEEL COAT ALL SURFACES WITH KOPR-SHIELD BEFORE MATING
- 2. FOR GROUND BOND TO STEEL ONLY: INSERT A DRAGON TOOTH WASHER BETWEEN LUG AND STEEL. COAT ALL SURFACES WITH ANTI-OXIDATION COMPOUND (BURNDY PENETROX E, OR THOMAS & BETTS KOPR-SHIELD).

GROUNDING NOTES:

- THE SUBCONTRACTOR IS RESPONSIBLE FOR PROPERLY SEQUENCING INSTALLATION AS TO PREVENT ANY LOSS OF CONTINUITY IN THE GROUNDING SYSTEM OR DAMAGE TO THE CONDUIT.
- 2. ALL GROUND CONNECTIONS ABOVE GRADE (INTERIOR & EXTERIOR) SHALL BE FORMED USING HIGH PRESS CRIMPS.
- 3. ALL EXTERIOR GROUNDING CONNECTIONS SHALL BE COATED WITH A CORROSION RESISTANT MATERIAL.
- 4. ALL EXTERIOR GROUNDING CONDUCTORS SHALL BE 2 AWG SOLID TINNED COPPER UNLESS OTHERWISE INDICATED.
- CONNECTIONS TO THE GROUNDING BUS SHALL NOT BE DOUBLED UP OR STACKED. BACK TO BACK CONNECTIONS ON OPPOSITE SIDES OF THE GROUND BUS ARE PERMITTED.
- USE OF 90° BENDS IN THE PROTECTION GROUNDING CONDUCTORS SHALL BE AVOIDED WHEN 45° BENDS CAN BE ADEQUATED.
- . MAXIMUM RESISTANCE OF THE COMPLETED GROUND SYSTEM SHALL NOT EXCEED 5 OHMS. TESTING SHALL BE PERFORMED IN ACCORDANCE WITH PROJECT SPECIFICATIONS FOR FACILITY GROUNDING, USING FALL OF POTENTIAL METHOD.

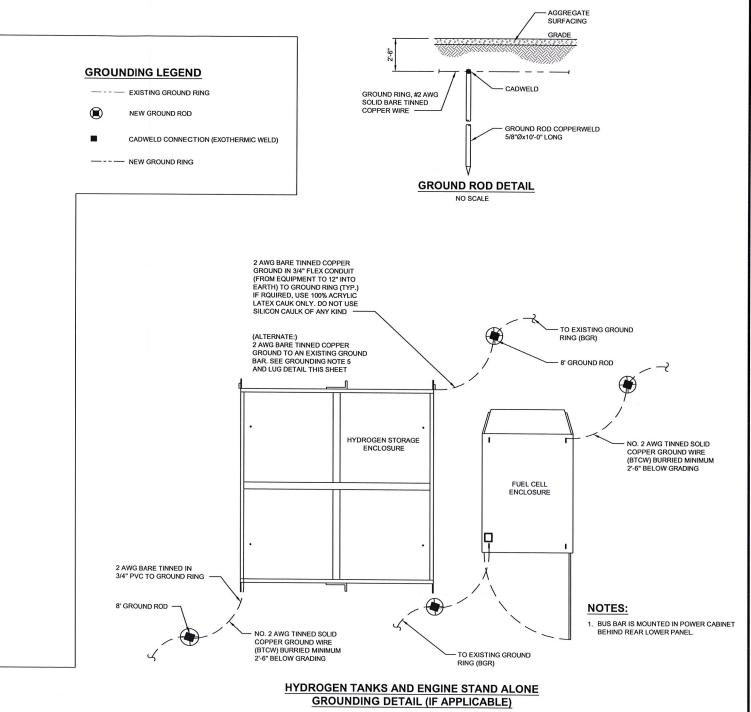



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10950 GRANDVIEW DRIVE OVERLAND PARK, KANSAS 66210 (913) 458-2000

168202

PROJECT NO:

REV

DRA	AWN BY:	AKJ
CHE	ECKED BY:	MB
0	6/7/2011	ISSUED FOR CONSTRUCTION



DATE DESCRIPTION

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MONTVILLE S. CT23XC400 71 MOXLEY HILL ROAD MONTVILLE, CT 06353 CO-LOCATION

SHEET TITLE

GROUNDING PLAN AND DETAILS

SHEET NUMBER

G-1

