

STATE OF CONNECTICUT

CONNECTICUT SITING COUNCIL

Ten Franklin Square, New Britain, CT 06051 Phone: (860) 827-2935 Fax: (860) 827-2950 E-Mail: siting.council@ct.gov www.ct.gov/csc

August 5, 2011

Mark Hulshart, Principal Hulshart & Associates, LLC 3009 Federal Hill Drive Falls Church, VA 22044

RE: **EM-SPRINT-086-110718** – Sprint Spectrum LP notice of intent to modify an existing telecommunications facility located at 57 Cook Drive, Montville, Connecticut.

Dear Mr. Hulshart:

The Connecticut Siting Council (Council) hereby acknowledges your notice to modify this existing telecommunications facility, pursuant to Section 16-50j-73 of the Regulations of Connecticut State Agencies with the following conditions:

- Any deviation from the proposed modification as specified in this notice and supporting materials with Council shall render this acknowledgement invalid;
- Any material changes to this modification as proposed shall require the filing of a new notice with the Council;
- Not less than 45 days after completion of construction, the Council shall be notified in writing that construction has been completed;
- The validity of this action shall expire one year from the date of this letter; and
- The applicant may file a request for an extension of time beyond the one year deadline provided that such request is submitted to the Council not less than 60 days prior to the expiration;

The proposed modifications including the placement of all necessary equipment and shelters within the tower compound are to be implemented as specified here and in your notice dated July 12, 2011. The modifications are in compliance with the exception criteria in Section 16-50j-72 (b) of the Regulations of Connecticut State Agencies as changes to an existing facility site that would not increase tower height, extend the boundaries of the tower site, increase noise levels at the tower site boundary by six decibels, and increase the total radio frequencies electromagnetic radiation power density measured at the tower site boundary to or above the standard adopted by the State Department of Environmental Protection pursuant to General Statutes § 22a-162. This facility has also been carefully modeled to ensure that radio frequency emissions are conservatively below State and federal standards applicable to the frequencies now used on this tower.

This decision is under the exclusive jurisdiction of the Council. Please be advised that the validity of this action shall expire one year from the date of this letter. Any additional change to this facility will require explicit notice to this agency pursuant to Regulations of Connecticut State Agencies Section 16-50j-73. Such notice shall include all relevant information regarding the proposed change with cumulative worst-case modeling of radio frequency exposure at the closest point of uncontrolled access to the tower base, consistent with Federal Communications Commission, Office of Engineering and Technology, Bulletin 65. Thank you for your attention and cooperation.

Very truly yours,

Linda Roberts
Executive Director

LR/CDM/laf

c: The Honorable Joseph W. Jaskiewicz, Mayor, Town of Montville Marcia Vlaun, Town Planner, Town of Montville Wireless Solutions

3009 FEDERAL HILL DRIVE FALLS CHURCH, VIRGINIA 22044

phone 703.533.1006

TUT-SPRINT-086-110718

TRANSMITTAL

TEO.

DATE:

July 12, 2011

TO:

Chairman Robert Stein, Connecticut Siting Council,

10 Franklin Square, New Britain, CT 06051

SUBJECT:

Transmittal of Sprint Spectrum L.P.'s Notice of Intent to Make an Exempt

Modification to an Existing Facility at 57 Cook Drive, Montville, CT 06382

(Site # CT23XC500)

Included with this transmittal are six packets (one original and five copies) of:

• Letter summarizing the installation.

• 8.5" x 14" PE-stamped drawings that illustrate the site plan, equipment cabinets and electrical diagrams.

• Altergy's fuel cell specifications for model FPS-524-240.


Attached to this transmittal form is:

• One application fee check in the amount of \$625.

\$009 FEDERAL HILL DRIVE FALLS CHURCH, VIRGINIA 22044 phone 703.533.1006

July 12, 2011

Chairman Robert Stein Connecticut Siting Council 10 Franklin Square New Britain, CT 06051

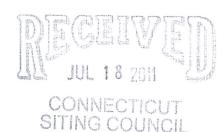

SUBJECT:

Sprint Spectrum L.P.'s Notice of Intent to Make an Exempt Modification to an

Existing Facility at 57 Cook Drive, Montville, CT 06382

(Site # CT23XC500)

Dear Chairman Stein:

Pursuant to R.C.S.A. Sections 16-50j-73 and 16-50j-72(b), Sprint Spectrum L.P. (Sprint) hereby gives notice to the Connecticut Siting Council (Council) and the Town of Montville of its intent to make an exempt modification to an existing telecommunications facility located at 57 Cook Drive, Montville, Connecticut.

Sprint plans to install a hydrogen fuel cell at its 57 Cook Drive facility to provide emergency backup power in the event of an electric outage. This planned installation does not constitute a modification subject to the Council's review as it falls within those activities provided for in R.C.S.A. Section 16-50j-72(b)(2). Specifically, this installation will not change the height of the existing tower, will not extend the boundaries of the existing compound, will not increase noise levels at the site by six decibels or more, and will not increase the total radio frequency electromagnetic radiation power density at the site to levels above applicable standards.

PROPOSED INSTALLATION

Sprint plans to install a 5 kW Altergy hydrogen fuel cell generator within the existing fenced equipment compound; the installation mounted to a new concrete pad. The fuel cell will be inside a cabinet measuring 3'6" x 2'2" x 6'0". The hydrogen cylinder storage cabinet has overall dimensions of 4'8" x 4'8" x 6'0".

Please contact me at 703.533.1006 or <u>Hulshart@earthlink.net</u> should you have any questions about this planned modification.

Sincerely.

Mark Hulshart Principal

cc: Mayor Joseph W. Jaskiewicz, Town of Montville

Robert Kingsborough (property owner)

Specifications



	lom Power™ 5 kW System n FPS Power Cabinet	FPS-524-240	FPS-524-240-400	FPS-548-240	FPS-548-240-40		
Physical	Dimensions (w x d x h)	26" x 42" x 72" [66 cm x 107 cm x 183 cm]					
	Weight	515 lb 706 lb [234 kg] [320 kg]		515 lb [234 kg]	706 lb [320 kg]		
	Number of FPS Engines		1				
	Number of TPMs	0	1	0	1		
Performance	Rated power	5 kW					
	Rated current	21	0 A	11	05 A		
	Operating voltage (nominal)	24	VDC	48	VDC		
	Operating voltage (range)	21 to 2	9 VDC	42 to	58 VDC		
	Standing Input Current (nominal)	1.92 A @) 24 VDC	0.96 A @ 48 VDC			
Operation	Ambient temperature ²						
	Relative humidity, noncondensing		00%				
	Location	•	Outdoo	ronly			
	Auxiliary AC in ²		120 V, 60 Hz, 10	A. single phase	e		
Storage	Ambient temperature		+ 40 °F to [+4 °C to	+113 °F +45 °C]			
	Relative humidity, noncondensing		5 to 1	00%			
Fuel	Gaseous hydrogen purity	Hydrogen (H ₂) 99.95% certified Industrial Grade					
	Supply pressure range	40 to 150 PSIG [2.8 to 10.5 kg/cm²]					
	Typical operating pressure	100 PSIG [7.03 kg/cm²]					
	Consumption	300 g/hour @ 5 kW					
Monitoring /	Standard	·	thernet, USB, Ser	ial, 4 Dry Conta	icts		
Control	Optional		Wireless T	elemetry			
	Rectifier Supply Voltage	n/a	27.0 ± 0.6 VDC	n/a	54.0 ± 0.6 VD		

¹Polarity is determined by customer requirements and ground connections.

²For operation below +10 °C, the FPS must be connected to the grid and supplied with AC power until a grid failure, at which time the heat generated by the FPS will be sufficient to maintain operation of the FPS at temperatures between -20 °C and +10 °C.



SITE NAME:

MOHEGAN HILL

SITE NUMBER:

CT23XC500

SITE ADDRESS: 57 COOK DRIVE

MONTVILLE, CT 06382

SITE TYPE:

EXISTING 180' LATTICE SELF

SUPPORT TOWER





BLACK & VEATCH

10950 GRANDVIEW DRIVE OVERLAND PARK, KANSAS 66210 (913) 458-2000

168202
MBG
ВН

06/07/2011 CHANGE LEASE AREA DIM 05/25/2011 ISSUED FOR CONSTRUCTION DATE DESCRIPTION



IT IS A VIOLATION OF LAW FOR ANY PERSON. UNLESS THEY ARE ACTING UNDER THE DIRECTION OF A LICENSED PROFESSIONAL ENGINEER, TO ALTER THIS DOCUMENT.


MOHEGAN HILL CT23XC500 **57 COOK DRIVE MONTVILLE, CT 06382 CO-LOCATION**

SHEET TITLE


TITLE SHEET & **PROJECT DATA**

SHEET NUMBER

T-1

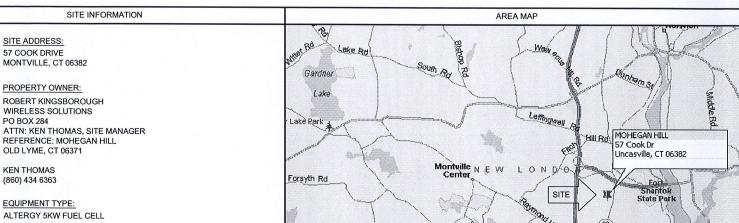

Derry Hill Bg LOCATION MAP

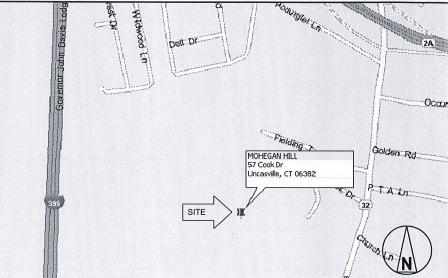

ALL WORK SHALL COMPLY WITH THE FOLLOWING APPLICABLE

APPLICABLE CODES

2003 INTERNATIONAL BUILDING CODE WITH 2005 STATE OF CONNECTICUT AMENDMENTS

2003 INTERNATIONAL MECHANICAL CODE WITH 2005 STATE OF

2003 INTERNATIONAL PLUMBING CODE WITH 2005 STATE OF CONNECTICUT AMENDMENTS

2005 NEC NATIONAL ELECTRICAL CODE

IN THE EVENT OF CONFLICT, THE MOST RESTRICTIVE CODE SHALL

PROJECT DESCRIPTION

INSTALL POWER BACK UP EQUIPMENT TO EXISTING SITE WITHIN EXISTING COMPOUND. INSTALL (1) NEW FUEL CELL WITH (1) FUEL STORAGE CABINET ON CONCRETE PAD AND CONNECT TO THE SITE'S

ENGINEER OF RECORD

DRAWING INDEX

TITLE SHEET & PROJECT DATA

EQUIPMENT CABINET DETAILS

HYDROGEN PIPING SCHEMATIC

OVERALL CONDUIT DETAILS

ELECTRICAL WIRING DIAGRAM

GROUNDING PLAN AND DETAILS

ELECTRICAL ONE-LINE DIAGRAMS

FUEL CELL INTERNAL WIRING DIAGRAM

CONCRETE PAD DETAILS

OVERALL SITE PLAN

SITE PLAN

C-1

C-2

F-2

E-3

E-4

CHRISTOPHER ALAN KRAFFT PE # 080438

BLACK & VEATCH CORPORATION

DRIVING DIRECTIONS FROM NEAREST AIRPORT

WESTERLY STATE AIRPORT: HEAD NORTH ON AIRPORT RD, ROAD NAME CHANGES TO SR-78 / WESTERLY BYPASS FOR 4.4 MILES, ENTER INTO CONNETICUT, TURN RIGHT (NORTH) ONTO LIBERTY ST, ROAD NAME CHANGES TO SR-2 / LIBERTY ST FOR 1.4 MILES, TAKE RAMP (LEFT) ONTO I-95 FOR 14.1 MILES TOWARDS I-95 / NEW LONDON, TAKE EXIT 84S-N-E (RIGHT) TOWARDS CT-32 / DOWNTOWN NEW LONDON / NORWICH, KEEP RIGHT TO STAY ON RAMP TOWARDS CT-32 / NORWICH / STATE PIER/ HODGES SQ, TAKE RAMP (LEFT) ONTO SR-32 FOR 3.2 MILES TOWARDS CT-32 / NORWICH, TAKE MONTVILLE CONNECTOR (RIGHT) ONTO I-395 / GOVERNOR JOHN DAVIS LODGE TPKE FOR 5.3 MILES TOWARDS I-395 / NORWICH, TAKE EXIT 79A (RIGHT) ONTO SR-2A TOWARDS CT-2A / PRESTON / LEDYARD, TAKE EXIT 1 (RIGHT) TOWARDS CT-32 / NORICH / UNCASVILLE, TURN RIGHT (SOUTH) ONTO SR-32 / NORWICH NEW LONDON TPKE FOR 0.4 MILES, TURN RIGHT (WEST) ONTO COOK DR, FOLLOW COOK DRIVE TO DESTINATION,

COUNTY:

EQUIPMENT SUPPLIER:

140 BLUE RAVINE ROAD

jerry.meyers@altergy.com

CONNECTICUT LIGHT AND POWER

(800) 286-2000 OR (860) 947-2000

FOLSOM, CA 95630 JERRY MEYERS

POWER COMPANY:

TELCO COMPANY:

ALTERGY

913-461-3674

NEW LONDON


LATITUDE (NAD83): 41° 28' 29.719" N

41.47492200 LONGITUDE (NAD83):

-72° 6' 19.493" N -72.10541500

CONTACT ENGINEER:

BRYAN HANSEN WORK: 913-458-7343 E-MAIL: hansenbj@bv.com

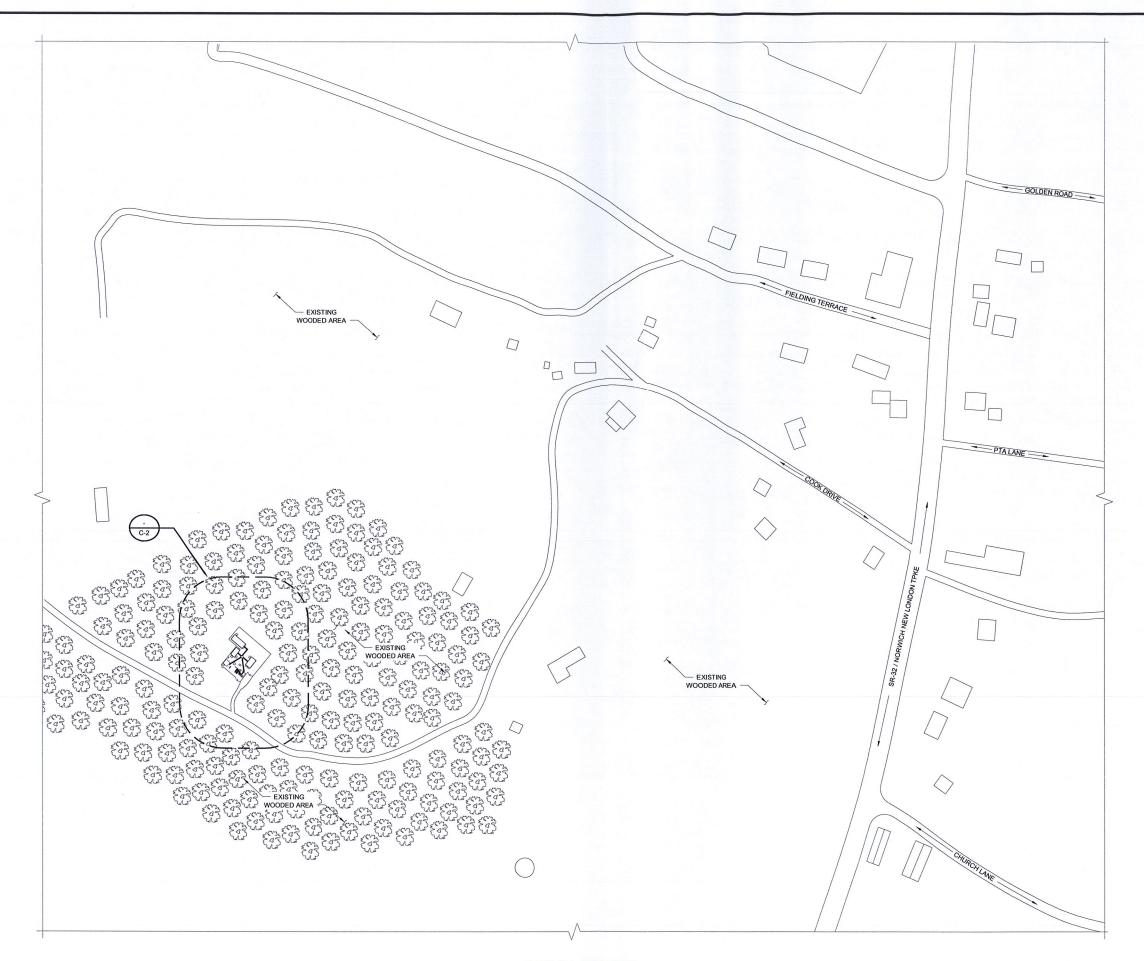



6580 SPRINT PARKWAY OVERLAND PARK, KANSAS 66251



BLACK & VEATCH

10950 GRANDVIEW DRIVE OVERLAND PARK, KANSAS 66210 (913) 458-2000

168202

PROJECT NO:

DR/	AWN BY:	MBG
CHE	CKED BY:	BH
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1	06/07/2011	CHANGE LEASE AREA DIM
0	05/25/2011	ISSUED FOR CONSTRUCTION
DEV	DATE	DESCRIPTION



IT IS A VIOLATION OF LAW FOR ANY PERSON, UNLESS THEY ARE ACTING UNDER THE DIRECTION OF A LICENSED PROFESSIONAL ENGINEER, TO ALTER THIS DOCUMENT.

> MOHEGAN HILL CT23XC500 57 COOK DRIVE MONTVILLE, CT 06382 CO-LOCATION

> > SHEET TITLE

OVERALL SITE PLAN


SHEET NUMBER

C-1



OVERALL SITE PLAN

NO SCALE

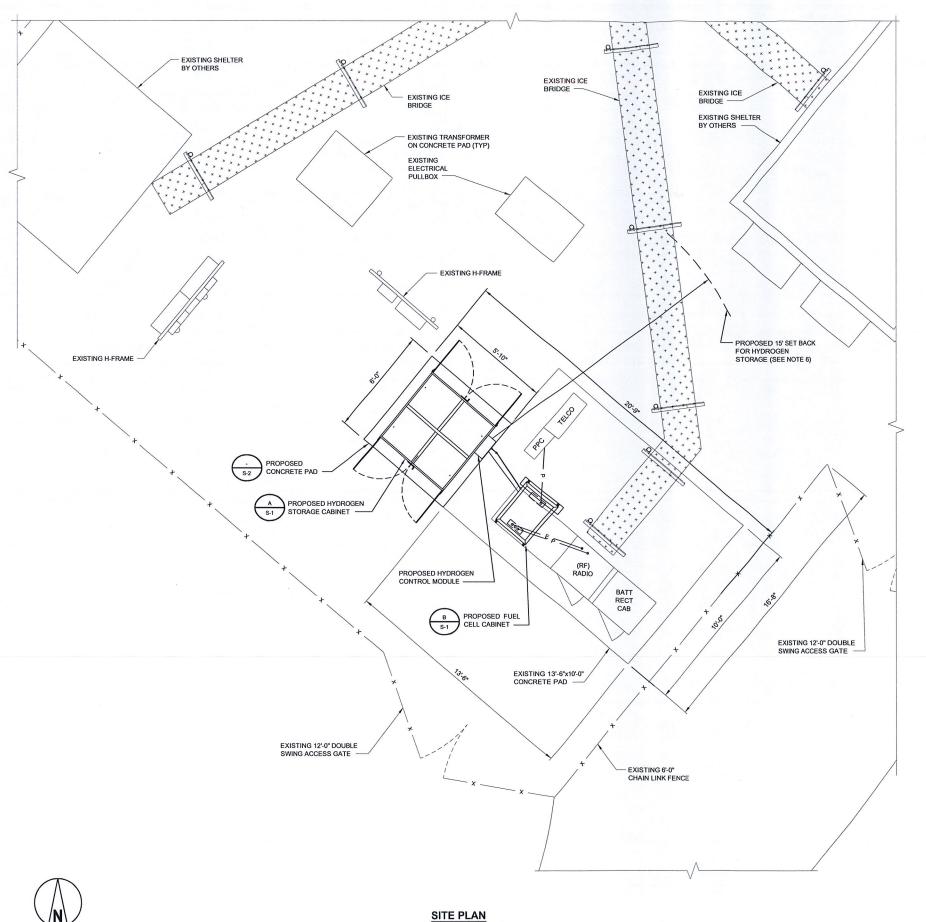

GENERAL NOTES:

- CONTRACTOR SHALL GROUND ALL NEW EQUIPMENT TO THE NEAREST GROUND RING (SEE G-1).
- CONTRACTOR SHALL ROUTE CONDUIT TO AVOID TRIP HAZARDS BY EITHER
 UTILIZING EXISTING CABLE TRAY, OVERHEAD ICE BRIDGE, UNDERNEATH RAISED
 PLATFORM, OR AROUND EDGE OF CONCRETE PAD.
- 3. CONTRACTOR SHALL FOLLOW ALL MANUFACTURER'S RECOMMENDATIONS FOR INSTALLATION OF ALL NEW EQUIPMENT.
- 4. CONTRACTOR SHALL VERIFY THE ALARM CABLES ARE OF SUFFICIENT LENGTH.
- 5. EXCESS CABLES SHALL BE LACED IN A NEAT AND ORGANIZED MANNER.
- HYDROGEN STORAGE CABINET HAS A REQUIRED SET BACK OF 15' FROM IGNITION SOURCES & AIR INTAKES.



6580 SPRINT PARKWAY OVERLAND PARK, KANSAS 66251



PROJECT NO:

BLACK & VEATCH

10950 GRANDVIEW DRIVE OVERLAND PARK, KANSAS 66210 (913) 458-2000

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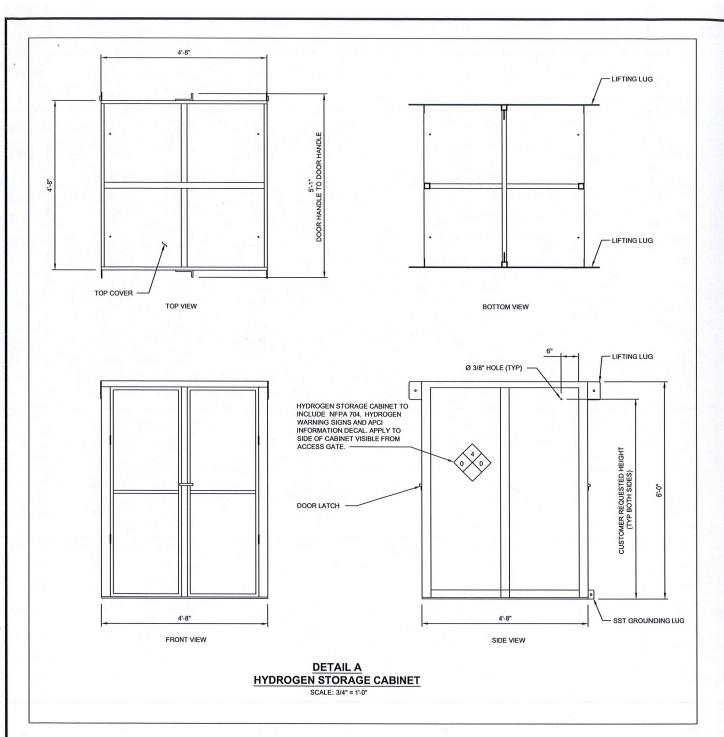
MOHEGAN HILL CT23XC500 57 COOK DRIVE MONTVILLE, CT 06382 CO-LOCATION


SHEET TITLE

SITE PLAN

SHEET NUMBER

C-2



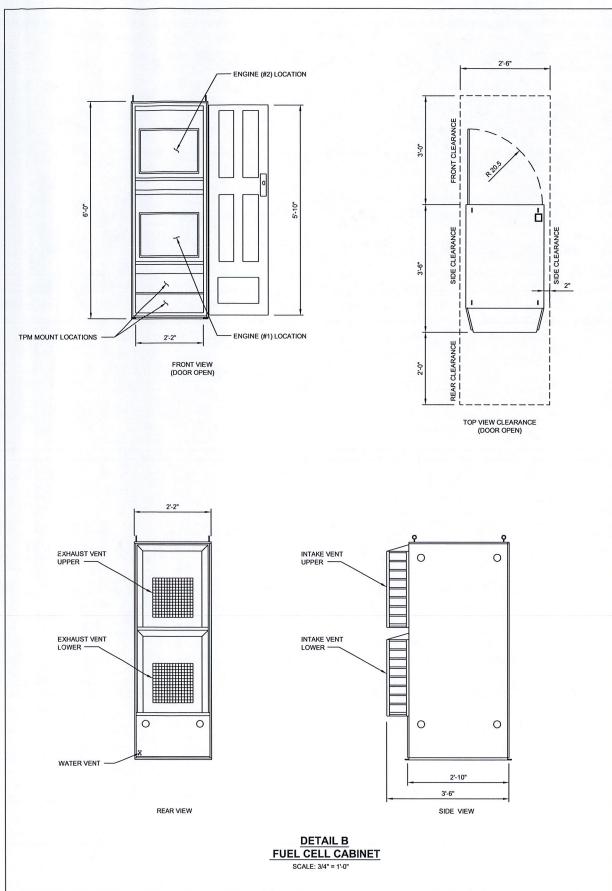



6580 SPRINT PARKWAY OVERLAND PARK, KANSAS 66251



BLACK & VEATCH

10950 GRANDVIEW DRIVE OVERLAND PARK, KANSAS 66210 (913) 458-2000

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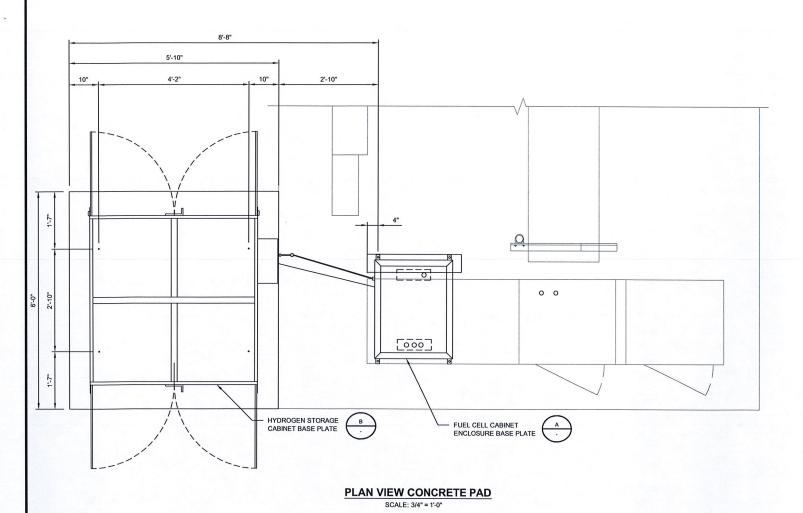
> MOHEGAN HILL CT23XC500 57 COOK DRIVE MONTVILLE, CT 06382 CO-LOCATION

> > SHEET TITLE

EQUIPMENT CABINET DETAILS

SHEET NUMBER

S-1



PROPOSED 3/8" PASSIVATED STAINLESS STEEL PIPING PROPOSED CONTROL HYDROGEN CONTROL MODULE — WIRING CONDUIT HYDROGEN STORAGE CABINET EXPANSION ANCHOR, TYP #4 BARS @ 12" OC BOTH DIRECTIONS PROPOSED CONCRETE PAD 1'-0" #4 BARS @ 12" OC BOTH DIRECTIONS EXISTING SPRINT 12'-0"x9'-0" CONCRETE PAD WITH EQUIPMENT 6" AGGREGATE BASE NEW #4 BARS EXTENDED 1'-0"
 INTO EXISTING SPRINT PAD
 (ANCHOR WITH HILTI HY-500
 EPOXY SYSTEM OR EQUAL) 6" CONCRETE SLAB (3000 PSI @ 28 DAYS) -UNDISTURBED NATURAL SUBGRADE

ELEVATION VIEW CONCRETE PAD SCALE: 3/4" = 1'-0"


DC POWER CONDUIT
STUB UP LOCATION

ELECTRICAL SIGNAL
AND AUX A/C POWER
STUB UP LOCATION


FRONT OF CABINET

DETAIL A
CABINET
BOLT PATTERN

SCALE: 1" = 1'-0"

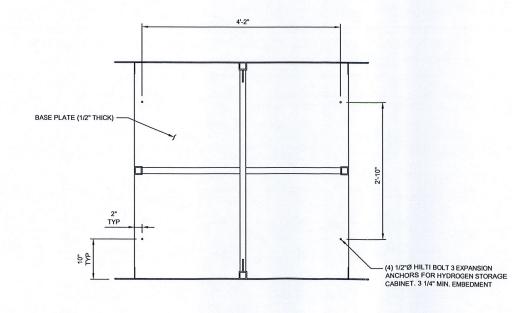

DETAIL B
HYDROGEN STORAGE CABINET
BOLT PATTERN
SCALE: 1" = 1":0"

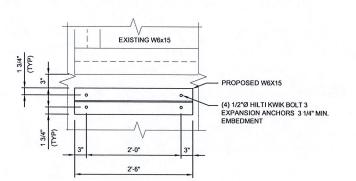

PLAN VIEW STEEL FRAMING FOR FUEL CELL CABINET

SCALE: 1" = 1'-0"



EXISTING SPRINT ICE SHIELD

6580 SPRINT PARKWAY OVERLAND PARK, KANSAS 66251



10950 GRANDVIEW DRIVE OVERLAND PARK, KANSAS 66210 (913) 458-2000

PRO	DJECT NO:	168202
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> > SHEET TITLE

CONCRETE PAD DETAILS

SHEET NUMBER

S-2

CUSTOMER LOAD AND EQUIPMENT

COMMUNICATIONS

DC POWER MAIN

AUX AC POWER

FUEL CELL

FUEL CELL

FUEL TUBING

HYDROGEN STORAGE

TYPICAL CONNECTION DIAGRAM

FUEL CELL ENGINE

FUEL CELL CABINET

EXHAUST VENT

HYDROGEN PIPING LEGEND



HYDROGEN PIPING SCHEMATIC

FUEL TANK

FUEL CABINET

OPTIONAL VALVE LOCATION SEE VENDOR DWG

HYDROGEN CONNECTION NOTES:

STEP 1. ROUTE HYDROGEN GAS LINE AND CONNECT TO THE FPS POWER CARINET

- IDENTIFY THE KNOCKOUT LOCATION TO BE USED FOR THE SENSOR /
 SIGNAL HARNESS AND FUEL TUBING ROUTING. OPEN KNOCKOUT
 LOCATION IN THE FPS POWER CABINET.
- INSTALL CONDUIT AND ROUTE TUBING FROM THE HYDROGEN STORAGE MODULE TO THE FPS POWER CABINET.
- CONNECT THE HYDROGEN LINE TO THE 3/8" TO 1/4" REDUCER COMPRESSION (PROVIDED) FITTING IN THE FPS POWER CABINET. TIGHTEN FITTING 1 1/4 TURNS PAST HAND TIGHT. THE LINE IS LOCATED IN THE LOWER REAR SECTION OF FPS POWER CABINET.

STEP 2. ROUTE THE SENSOR / SIGNAL HARNESS FROM THE FPS POWER CABINET TO THE HYDROGEN STORAGE MODULE.

- ROUTE THE SENSOR / SIGNAL HARNESS THROUGH THE CONDUIT USED FOR THE HYDROGEN TUBING.
- CONNECT THE PRESSURE TRANSDUCER, HYDROGEN SOLENOID VALVE, AND DOOR ALARM (IF EQUIPPED) TO THE SENSOR / SIGNAL HARNESS.

Sprint

6580 SPRINT PARKWAY OVERLAND PARK, KANSAS 66251



10950 GRANDVIEW DRIVE OVERLAND PARK, KANSAS 66210 (913) 458-2000

PROJECT NO:	168202
DRAWN BY:	МВО
CHECKED BY:	BH

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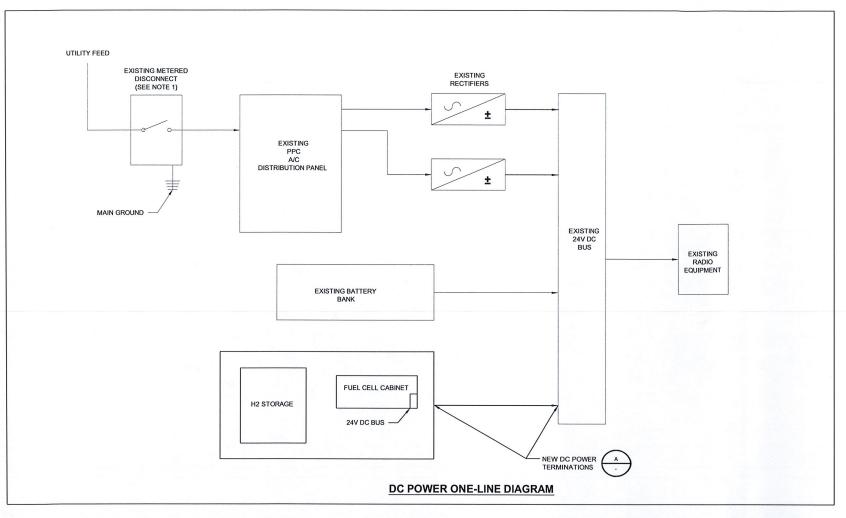
MOHEGAN HILL CT23XC500 57 COOK DRIVE MONTVILLE, CT 06382 CO-LOCATION


SHEET TITLE

HYDROGEN PIPING SCHEMATIC

SHEET NUMBER

M-1



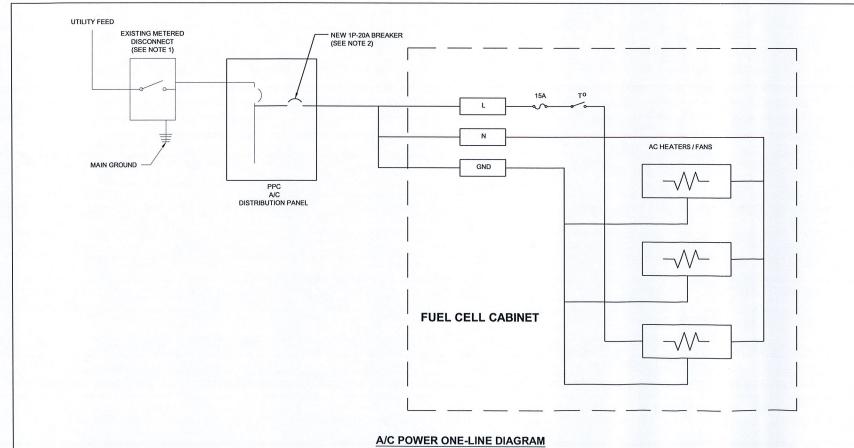

GENERAL ELECTRICAL NOTES:

- ALL ELECTRICAL WORK SHALL CONFORM TO THE LATEST EDITION OF THE NATIONAL ELECTRICAL CODE (NEC), AND LOCAL CODES.
- 2. ALL ELECTRICAL MATERIALS, EQUIPMENT AND INSTALLATION PROCEDURES SHALL CONFORM WITH SPRINT'S STANDARD CONSTRUCTION SPECIFICATIONS.
- ALL MATERIALS SHALL BE MANUFACTURED IN ACCORDANCE WITH APPLICABLE STANDARDS ESTABLISHED BY ANSI, NEMA NFPA, AND "UL" LISTED.
- 4. THE ELECTRICAL PLANS, DETAILS, AND DIAGRAMS SHOWN ON THESE DRAWINGS ARE DIAGRAMMATIC ONLY. ACTUAL FIELD CONDITIONS AND SITE REQUIREMENTS SHALL DICTATE THE AMOUNT AND LOCATION OF EQUIPMENT.
- 5. THE ENTIRE ELECTRICAL INSTALLATION SHALL BE GROUNDED AS REQUIRED BY THE NEC AND ALL APPLICABLE LOCAL CODES.
- 6. ALL CIRCUIT BREAKERS, FUSES AND ELECTRICAL EQUIPMENT SHALL HAVE A MINIMUM INTERRUPTING RATING OF 65,000 AIC (UNLESS NOTED OTHERWISE)
- 7. REFER TO THE VENDOR DRAWINGS OF THE PPC CABINET, BATTERY, AND BTS CABINETS FOR COMPLETE INTERNAL WIRING AND ARRANGEMENT.
- 8. PATCH, REPAIR AND PAINT ANY AREA THAT HAS BEEN DAMAGED IN THE COURSE OF THE ELECTRICAL INSTALLATION.
- 9. LABEL ALL ELECTRICAL EQUIPMENT PER SPRINT'S SPECIFICATIONS.
- 10. ALL SINGLE-PHASE SELF-CONTAINED METER CONNECTION DEVICES MUST INCLUDE HORN TYPE BYPASS PROVISIONS SO THAT SERVICE WILL NOT BE INTERRUPTED WHEN A METER IS REMOVED FROM THE SOCKET.
- 11. USE METER CONNECTION DEVICES LABELED BY THE MANUFACTURER WITH THE LETTERS
- ALL INTERIOR CONDUITS AND BUSHINGS SHALL BE EMT. ALL EXTERIOR SHALL BE PVC UNLESS NOTED OTHERWISE (SEE SPRINT'S STANDARD CONSTRUCTION SPECIFICATIONS).
- 13. PROVIDE 2 PULL STRINGS SECURELY FASTENED AT EACH END OF ALL CONDUITS. THE PULL STRINGS ARE TO BE 200 LB. TEST POLYETHYLENE CORD. PROVIDE CAP ON THE END OF EACH CONDUIT AND MARK AS SHOWN ON THIS SITE PLAN.
- 14. THE CONTRACTOR SHALL LOCATE AND MARK ALL EXISTING UNDERGROUND POWER, TELCO, GROUNDING CONDUITS, AND ALL OTHER UTILITIES EASEMENTS AND/OR WIRES PRIOR TO TRENCHING. ANY DAMAGE CAUSED TO THE EXISTING UNDERGROUND SERVICES OR SYSTEMS SHALL BE REPAIRED AT THE CONTRACTOR'S EXPENSE. VERIFY WITH UTILITY NEW SERVICE HAS BEEN APPLIED FOR. THERE SHALL BE NO SPLICING OF GROUND CONDUCTORS BELOW GRADE.
- UTILITY RACK AND CONDUIT SIZES TO BE FIELD DETERMINED BY CONTRACTOR IN ACCORDANCE WITH THE LOCAL JURISDICTION.
- ALL WORK SHALL MEET OR EXCEED ALL APPLICABLE LOCAL AND NATIONAL ELECTRICAL CODE REQUIREMENTS.
- 17. ALL INSTALLATION AND EQUIPMENT SHALL MEET OR EXCEED SPRINT CONSTRUCTION SPECIFICATIONS.

ELECTRICAL NOTES:

- 1. LIGHT SHADED LINES INDICATE EXISTING CONSTRUCTION.
- CONTRACTOR TO VERIFY POWERWAVE MODEL AND ASSOCIATED POWER REQUIREMENTS.
 IF LARGER CIRCUIT BREAKERS ARE REQUIRED, CONTRACTOR SHALL PROVIDE CORRECT ELECTRICAL CONDUCTOR SIZES.

		POS	ITIVE					N	EGA	TIVE	
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_	 -	-									_

DETAIL A BUS BARS MOUNTED IN FUEL CELL & BTS CABINETS

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0

DESCRIPTION:	BUS BAR. BB19, ENERSYS
COPPER BUS BAR MATERIAL PER ASTM B-49, B-152, B-171, B187, B-188, B-283	C11000 99.9% COPPER - ELECTROLYTIC TOUGH PITCH (ETP)
COPPER BUS BAR LENGTH	7.25" (184mm)
COPPER BUS BAR WIDTH	2.0" (50.8mm)
COPPER BUS BAR THICKNESS	0.25" (6.35mm)
MAXIMUM CURRENT RATING	975A @50C RISE
VOLTAGE LIMIT (INSULATOR BREAKDOWN)	3000V



6580 SPRINT PARKWAY OVERLAND PARK, KANSAS 66251



10950 GRANDVIEW DRIVE OVERLAND PARK, KANSAS 66210 (913) 458-2000

168202

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DR	AWN BY:	MBG		
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DATE DESCRIPTION


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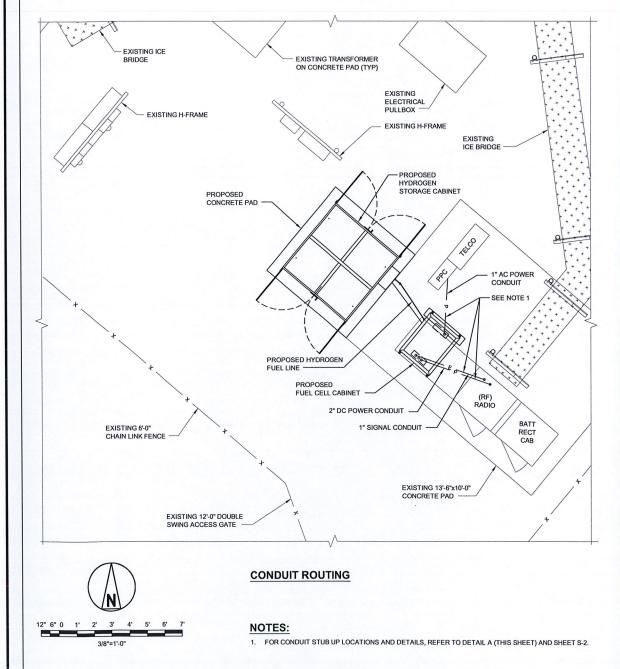
MOHEGAN HILL CT23XC500 **57 COOK DRIVE MONTVILLE, CT 06382 CO-LOCATION**

SHEET TITLE

ELECTRICAL ONE-LINE DIAGRAMS


SHEET NUMBER



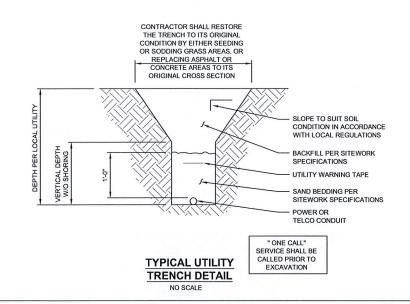

GENERAL NOTES:

- MATERIALS: ALL HANGERS, SUPPORTS, FASTENERS AND HARDWARE SHALL BE ZINC COATED OR OF EQUIVALENT CORROSION RESISTANCE BY TREATMENT OR INHERENT PROPERTY, AND SHALL BE MANUFACTURED PRODUCTS DESIGNED FOR THE APPLICATION. PRODUCTS FOR OUTDOOR USE SHALL BE HOT DIP GALVANIZED.
- CONDUIT SEALS: INSTALL CONDUIT SEAL FOR EACH CONDUIT PENETRATING AN EXTERIOR BUILDING WALL BELOW
 GRADE (UNLESS PENETRATION IS BELOW LOWEST BUILDING FLOOR SLAB), AND ELSEWHERE AS INDICATED, AND SO AS
 TO ACHIEVE A SEALED WATERTIGHT INSTALLATION. MATCH EXISTING CONDITIONS AND MEET OR EXCEED INTEGRITY OF
 WALLS.
- INSTALLATION: RIGIDLY SUPPORT AND SECURE ALL MATERIALS, RACEWAY AND EQUIPMENT TO BUILDING STRUCTURE USING HANGERS, SUPPORTS AND FASTENERS, SUITABLE FOR THE USE, MATERIALS AND LOADS ENCOUNTERED. PROVIDE ALL NECESSARY HARDWARE. PROVIDE CONDUIT SUPPORTS AT MAXIMUM 5 FT. O.C.
- 4. STRUCTURAL MEMBERS: DO NOT CUT, DRILL OR WELD ANY STRUCTURAL MEMBER EXCEPT AS SPECIFICALLY APPROVED BY THE ENGINEER.
- INDEPENDENT SUPPORT: DO NOT SUPPORT MATERIALS OR EQUIPMENT FROM OTHER EQUIPMENT, PIPING, DUCTWORK OR SUPPORTS FOR SAME.
- MISCELLANEOUS SUPPORTS: PROVIDE ANY ADDITIONAL STRUCTURAL SUPPORT STEEL BRACKETS ANGLES, FASTENERS
 AND HARDWARE AS REQUIRED TO ADEQUATELY SUPPORT ALL ELECTRICAL MATERIALS AND EQUIPMENT.
- 7. ONE HOLE STRAPS SHALL NOT BE USED FOR CONDUITS LARGER THAN 3/4"Ø.

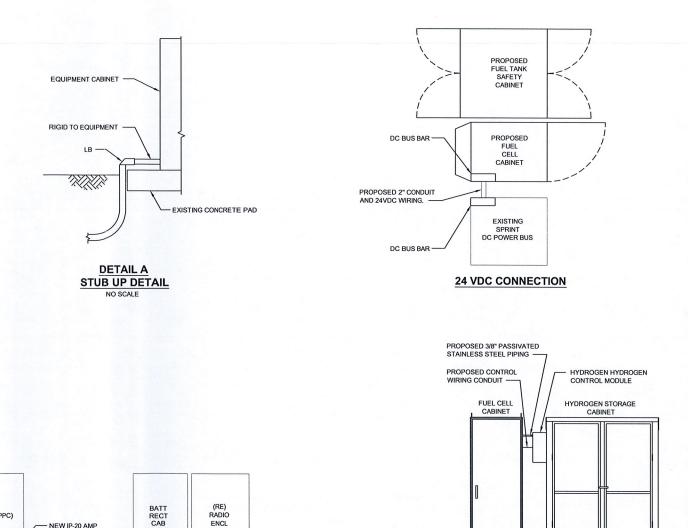

- (1) 4 PAIR, 24 AWG CABLE

1 INCH CONDUIT

ELECTRICAL & SIGNAL RISER DIAGRAM

- (2) 12 AWG & (1) 14 AWG GROUND IN 1" CONDUIT



6580 SPRINT PARKWAY OVERLAND PARK, KANSAS 66251



10950 GRANDVIEW DRIVE OVERLAND PARK, KANSAS 66210 (913) 458-2000

168202

PROJECT NO

DR	AWN BY:	MBG
СН	ECKED BY:	ВН
1	06/07/2011	CHANGE LEASE AREA DIM

 0
 05/25/2011
 ISSUED FOR CONSTRUCTION

 REV
 DATE
 DESCRIPTION



IT IS A VIOLATION OF LAW FOR ANY PERSON, UNLESS THEY ARE ACTING UNDER THE DIRECTION OF A LICENSED PROFESSIONAL ENGINEER, TO ALTER THIS DOCUMENT.

MOHEGAN HILL CT23XC500 57 COOK DRIVE MONTVILLE, CT 06382 CO-LOCATION

SHEET TITLE

#2 AWG BARED TINNED IN 3/4" PVC TO GROUND RING

(2) 1/0 (1) 6 AWG GROUND IN

2" CONDUIT

OVERALL CONDUIT DETAILS

SHEET NUMBER

E-2


DC WIRE SIZE GUIDE					
3	48V ALTERGY	48V ALTERGY			
BATTERY DISTANCE FROM FUEL CELL	@ 5KW (105A)	@ 10KW (105A)			
10'	#1 AWG	3/0 AWG			
20'	#1 AWG	4/0 AWG			
30'	1/0 AWG	4/0 AWG			
40'	1/0 AWG	4/0 AWG			
50'	2/0 AWG	250 MCM			
>50'	INSTALLER WILL NEED TO DETERMINE WIRE SIZE IN SITUATIONS WHERE THE DISTANCE FROM THE FUEL CELL TO THE BATTERY BANK IS GREATER THAN 50'				

THIS GUIDE IS FOR REFERENCE ONLY. THE INSTALLER IS RESPONSIBLE FOR SELECTING THE PROPER WIRE FOR EACH INSTALLATION IN ACCORDANCE WITH THE NATIONAL ELECTRICAL CODE (NEC)

WIRE SCHEDULE TABLE

NOTES:

- BTS BUS BAR LUGS-TWO HOLE, 1/4" HOLE, 5/8" SPACING. ALTERGY FUEL CELL BUS LUGS TWO HOLE, 1/4" HOLE, 5/8" SPACING. RECOMMENDED CABLE POWERFLEX 1000, SIZED PER APPLICATION.

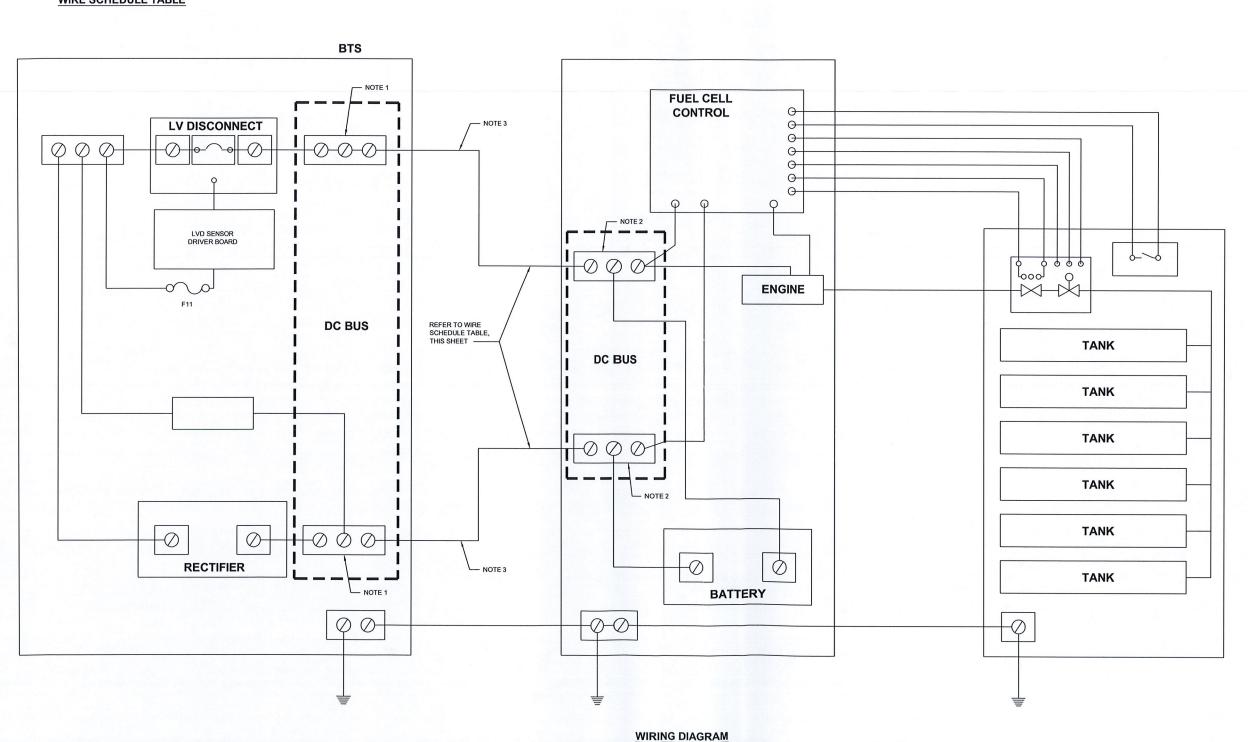



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10950 GRANDVIEW DRIVE OVERLAND PARK, KANSAS 66210 (913) 458-2000

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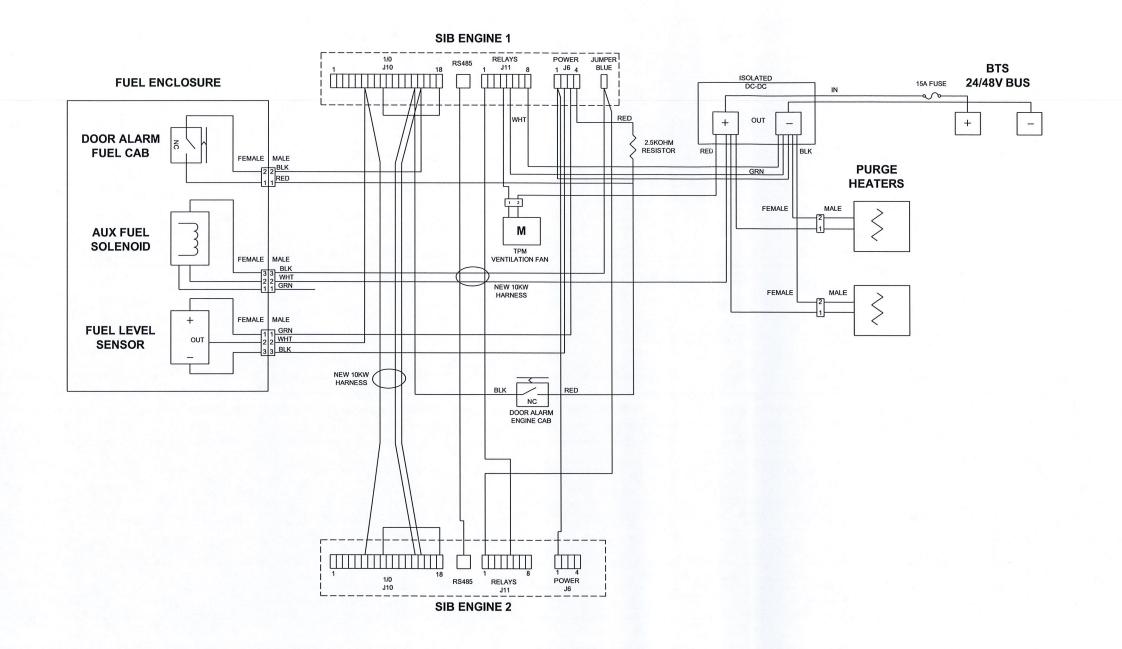
MOHEGAN HILL CT23XC500 **57 COOK DRIVE MONTVILLE, CT 06382** CO-LOCATION

SHEET TITLE

ELECTRICAL **WIRING DIAGRAM**

SHEET NUMBER

E-3





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SHEET TITLE


FUEL CELL INTERNAL WIRING DIAGRAM


SHEET NUMBER

E-4

WIRING SCHEMATIC

THE DETAILS ON THIS SHEET APPLY ONLY AS CALLED OUT ON SITE PLANS OR SITE SPECIFIC DRAWINGS.

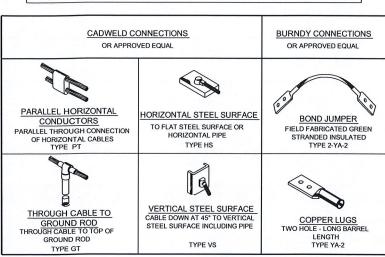

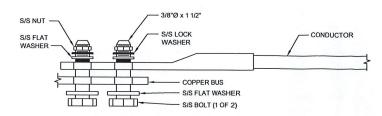

LUG DETAIL

NOTES:

- ALL HARDWARE 18-8 STAINLESS STEEL COAT ALL SURFACES WITH KOPR-SHIELD BEFORE MATING.
- 2. FOR GROUND BOND TO STEEL ONLY: INSERT A DRAGON TOOTH WASHER BETWEEN LUG AND STEEL. COAT ALL SURFACES WITH ANTI-OXIDATION COMPOUND (BURNDY PENETROX E, OR THOMAS & BETTS KOPR-SHIF ID.

GROUNDING NOTES:

- THE SUBCONTRACTOR IS RESPONSIBLE FOR PROPERLY SEQUENCING INSTALLATION AS TO PREVENT ANY LOSS OF CONTINUITY IN THE GROUNDING SYSTEM OR DAMAGE TO THE CONDUIT.
- 2. ALL GROUND CONNECTIONS ABOVE GRADE (INTERIOR & EXTERIOR) SHALL BE FORMED USING HIGH PRESS CRIMPS.
- 3. ALL EXTERIOR GROUNDING CONNECTIONS SHALL BE COATED WITH A CORROSION RESISTANT MATERIAL.
- ALL EXTERIOR GROUNDING CONDUCTORS SHALL BE 2 AWG SOLID TINNED COPPER UNLESS OTHERWISE INDICATED.
- CONNECTIONS TO THE GROUNDING BUS SHALL NOT BE DOUBLED UP OR STACKED. BACK TO BACK CONNECTIONS ON OPPOSITE SIDES OF THE GROUND BUS ARE PERMITTED.
- 6. USE OF 90° BENDS IN THE PROTECTION GROUNDING CONDUCTORS SHALL BE AVOIDED WHEN 45° BENDS CAN BE ADEQUATELY SUPPORTED.

HYDROGEN TANKS AND ENGINE STAND ALONE GROUNDING DETAIL (IF APPLICABLE)

MAXIMUM RESISTANCE OF THE COMPLETED GROUND SYSTEM SHALL NOT EXCEED 5 OHMS. TESTING SHALL BE PERFORMED IN ACCORDANCE WITH PROJECT SPECIFICATIONS FOR FACILITY GROUNDING, USING FALL OF POTENTIAL METHOD.

SURFACING



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GROUNDING PLAN AND DETAILS

SHEET NUMBER

G-1

