

Northeast Site Solutions Victoria Masse 420 Main St Unit 1 Box 2 Sturbridge, MA 01566 victoria@northeastsitesolutions.com

May 17, 2023

Members of the Siting Council Connecticut Siting Council Ten Franklin Square New Britain, CT 06051

RE: Notice of Exempt Modification

111 School House Road, Milford, CT 06460

Latitude: 41.21285100 Longitude: -73.08490700

T-Mobile Site#: CT11229A_NHP

Dear Ms. Bachman:

T-Mobile currently has nine (9) antennas at the 116-foot level of the existing 140-foot tower. The property is owned by Milford Enterprises LLC and the Tower is owned by Crown Castle. T-Mobile now intends to add a 48Kw generator to a new 4'x9' concrete pad within an existing fenced compound. Two (2) double wide gates will be installed to allow access to the new generator, the compound size will not change.

Planned Modifications:

Groundwork only-Install New:

- (1) GENERAC RD 48KW AC DIESEL GENERATOR 233-gallon double walled self-contained tank with fuel sensor. Requires two
- (2) 12-minute run cycles bi-weekly.
- (1) 4'x9' concrete pad

This facility was approved by the City of Milford on May 15, 1997. This approval was given without conditions. Please see attached.

Please accept this letter as notification pursuant to Regulations of Connecticut State Agencies § 16-50j-73, for construction that constitutes an exempt modification pursuant to R.C.S.A. § 16-50j-72(b)(2). In accordance with R.S.C.A. § 16-50j-73, a copy of this letter is being sent to Benjamin G. Blake, Mayor of the City of Milford, as well as Stephen Harris, Zoning Enforcement Officer for the City of Milford. A copy of this application will also be sent to the tower and property owner.

The planned modifications to the facility fall squarely within those activities explicitly provided for in R.C.S;A. § 16-50j-72(b)(2).

- 1. The proposed modifications will not result in an increase in the height of the existing structure.
- 2. The proposed modifications will not require the extension of the site boundary.
- 3. The proposed modifications will not increase noise levels at the facility by six decibels or more, or to levels that exceed state and local criteria.
- 4. The operation of the replacement antennas will not increase radio frequency emissions at the facility to a level at or above the Federal Communications Commission safety standard.
- 5. The proposed modifications will not cause a change or alteration in the physical or environmental characteristics of the site.
- 6. The existing structure and its foundation can support the proposed loading.

For the foregoing reasons, T-Mobile respectfully submits that the proposed modifications to the above referenced telecommunications facility constitute an exempt modification under R.C.S.A. § 16-50j-72(b)(2).

Sincerely,

Victoria Masse

Mobile: 860-306-2326 Fax: 413-521-0558

Victoria Masse

Office: 420 Main Street, Unit 2, Sturbridge MA 01566

Email: victoria@northeastsitesolutions.com

Attachments cc: Benjamin Blake – Mayor City of Milford 110 River St Milford, CT 06460 203-783-3201

Attn: Stephen H. Harris – Zoning Enforcement Officer City of Milford 70 West River St Milford, CT 06460 203-783-3245

Attn: Vipul Mehta Milford Enterprises LLC 1207 E Main Street Stamford, CT 06702

Crown Castle - tower owner

Exhibit A



DATE FILED	5/15/97		
RECEIPT #	10.391		
FFF ANGLUDES CZCI	\$ \$ 2200		

City of Milford, Connecticut application for zoning permit

	on making the street streets of on the second	achie and the location or all build	lings in relation to the street i	lot plan must be submitted nes, side lot lines and rear	lot lines.
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MIDTH OF STREET RIC	SHT OF WAY LESS THA	N 50 FT.? YES N	O CORNE	R LOT? YES NO	1
	HE LOT BELOW REGUL		ATION? YESNO	CAM YES	NO 👱
CITY WATER V PRIVA	TE WELL* SEWER*	* SEPTIC*** I	ENGINEERING OFF STREE	T PERMIT #	
OWNER TElach	Prop. L.P.	, , ,	PHONE (1877- 800	0
ADDRESS OF OWNER		House Id:	11.16.2	CT	
PRESENT USE OF PRO	PERTY	Mrte/	CITY	STATE 2	DP CODE
PROPOSED CONSTRU	CTION NEW	X ADDITION	ALTERATION_	REPAIR _	
(Kellands Kelmit	ED CONSTRUCTION_	140' Telecci		manepole	_
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ClibPDF - www.fastio.com

ZONPERT/98

P&Z OFFICE - WHITE



MILFORD PLANNING & ZONING BOARD PETITION FOR SPECIAL PERMIT

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NAME Harris Brach	WILCOX, ILP		 -
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HAS ANY PREVIOUS PET	TION FOR A SPECIAL	PERMIT BEEN FILED FOR	IMIS PROPERTY
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PROCEDURE FOLLOWING APPROVAL BY PLANNING & ZONING BOARD

SITE PLAN REVIEW

Following approval by the Planning & Zoning Board, it is necessary to obtain a zoning permit at the Planning & Zoning Office. Plans for this permit will be the Board approved plans on file in our office unless the Board has stipulated revisions to be made. Please call the reviewing officer for this application at 783-3245 to make arrangements for the issuance of a zoning permit. The fee for a zoning permit following Board approval is \$22.00. The zoning permit, associated plans and other exhibits must then be taken to the Building Inspector for the issuance of a building permit.

SPECIAL PERMIT/SPECIAL EXCEPTION

Following approval by the Planning & Zoning Board, it is necessary to obtain a zoning permit at the Planning & Zoning Office. Plans for this permit will be the Board approved plans on file in our office unless the Board has stipulated revisions to be made. Please call the reviewing officer for this application at 783-3245 to make arrangements for the issuance of a zoning permit. The fee for a zoning permit following Board approval is \$22.00. The zoning permit, associated plans and other exhibits must then be taken to the Building Inspector for the issuance of a building permit.

Prior to the issuance of a zoning permit, a certificate, which is being held at the office must be filed on the land records in the City Clerk's Office for which a fee of \$10.00 is required. You must present your receipt from the City Clerk's Office at the Planning & Zoning Office to be recorded in your file.

Exhibit B

111 SCHOOLHOUSE RD #CELL

111 SCHOOLHOUSE RD #CELL **Mblu** 33/ 335/ 5/A / Location

023043 MILFORD ENTERPRISES LLC Acct# Owner

Assessment \$245,000 **Appraisal** \$350,000

> **Building Count** 1 PID 100242

Current Value

Appraisal Appraisal					
Valuation Year Improvements Land Total					
2016	\$350,000	\$0	\$350,000		
	Assessment				
Valuation Year	Improvements	Land	Total		
2016	\$245,000	\$0	\$245,000		

Owner of Record

Owner MILFORD ENTERPRISES LLC Sale Price \$3,675,000

Other C/O VIPUL MEHTA Certificate

Address 1207 E MAIN STREET Book & Page 03622/0230 STAMFORD, CT 06702 Sale Date 03/27/2015

Instrument 18

Ownership History

Ownership History					
Owner	Sale Price	Certificate	Book & Page	Instrument	Sale Date
MILFORD ENTERPRISES LLC	\$3,675,000		03622/0230	18	03/27/2015
CSMC 2007 C5 FFI HOTEL PORTFOLIO LLC	\$6,930,207		03602/0294	22	10/06/2014
MILFORD FFI LLC	\$4,800,000		03168/0407	00	05/10/2007
OLY REALTY ONE LLC	\$3,800,000		02396/0375		02/28/2000
TELAHC PROPERTIES L P	\$0		02040/0184		03/11/1994

Building Information

Building 1: Section 1

Year Built:

Living Area:

0

Building Photo

Replacement Cost: \$0

Building Percent Good: Replacement Cost

Build	ding Attributes		
Field Description			
Sty l e	Outbuildings		
Model			
Grade:			
Stories:			
Occupancy			
Exterior Wall 1			
Exterior Wall 2			
Roof Structure:			
Roof Cover			
Interior Wall 1			
Interior Wall 2			
Interior FIr 1			
Interior FIr 2			
Heat Fuel			
Heat Type:			
AC Type:			
Total Bedrooms:			
Total Bthrms:			
Total Half Baths:			
Total Xtra Fixtrs:			
Total Rooms:			
Bath Description:			
Kitchen Descrip:			
Num Kitchens			
Cndtn			
Usrfld 103			
Int Condition:			
Solar Panels			
House Generator			
Usrfid 107			
Num Park			
Fireplaces			
Usrfld 108			
Usrfld 101			
Usrfld 102			
Usrf i d 100			



(http://images.vgsi.com/photos/MilfordCTPhotos//default.jpg)

Building Layout

Building Layout

(http://images.vgsi.com/photos/MilfordCTPhotos//Sketches/100242_10024

Building Sub-Areas (sq ft)	Legend
No Data for Building Sub-Areas	

Usrfld 300	
Usrfld 301	

Extra Features

Ex	xtra Features	Legend
No I	Data for Extra Features	

Land

Land Use		Land Line Valuation	
Use Code	434V	Size (Acres)	0
Description	CELL TOWER MDL-00	Frontage	
Zone		Depth	
Neighborhood	С	Assessed Value	\$0
Alt Land Appr	No	Appraised Value	\$0
Category			

Outbuildings

	Outbuildings <u>Leger</u>					<u>Legend</u>
Code	Description	Sub Code	Sub Description	Size	Value	Bldg#
CEL1	CEL TWR SITE			1.00 UNITS	\$350,000	1

Valuation History

Appraisal Appraisal					
Valuation Year	Improvements	Land	Total		
2018	\$350,000	\$0	\$350,000		
2017	\$350,000	\$0	\$350,000		
2016	\$350,000	\$0	\$350,000		

Assessment					
Valuation Year	Improvements	Land	Total		
2018	\$245,000	\$0	\$245,000		
2017	\$245,000	\$0	\$245,000		
2016	\$245,000	\$0	\$245,000		

Google Maps

111 Schoolhouse Rd

Crown Castle - tower location



Imagery ©2020 Maxar Technologies, New York GIS, USDA Farm Service Agency, Map data ©2020



111 Schoolhouse Rd

Milford, CT 06460











Directions Save

Nearby

Send to your phone

Share

At this location

Fairfield Inn Milford 4.3 ***** (20) 2-star hotel



Exhibit C

T--Mobile

T-MOBILE NORTHEAST LLC

UPGRADE:

GENERATOR ADD

LOCATION MAP Search Google Maps Q 0 Groceries ♥ Restaurants 🔒 Takeout CT11229A

APPLICABLE CODES/REFERENCE DOCUMENTS

ALL WORK SHALL BE PERFORMED AND MATERIALS INSTALLED IN ACCORDANCE WITH THE CURRENT EDITIONS OF THE FOLLOWING CODES AS ADOPTED BY THE LOCAL GOVERNING AUTHORITIES. NOTHING IN THESE PLANS IS TO BE CONSTRUED TO PERMIT WORK NOT CONFORMING TO THESE CODES:

MECHANICAL 2021 IMC ELECTRICAL. 2020 NEC



GENERAL NOTES

OCCUPANCY CLASSIFICATION:

TYPE OF CONSTRUCTION:

A.D.A. COMPLIANCE: FACILITY IS UNMANNED AND NOT FOR HUMAN HABITATION

PLUMBING REQUIREMENTS: FACILITY HAS NO SANITARY OR POTABLE WATER.

SITE NAME:

STRATFORD/RT 1/RT 162

SITE NUMBER:

CT11229A

SITE ADDRESS:

111 SCHOOL HOUSE ROAD MILFORD, CT 06460

SCOPE OF WORK

SCOPE OF WORK:

- INSTALL (1) NEW ATS
- INSTALL (2) NEW 8' DOUBLE GATES

- INSTALL (1) NEW 8'-0" x 4'-0" CONCRETE PAD
- INSTALL (1) NEW 48KW GENERATOR
- INSTALL (1) NEW H-FRAME

APPROVALS

T-MOBILE CONSTRUCTION MANAGER

T-MOBILE RF ENGINEER

LAND USE PLANNER

NETWORK OPERATION

PROPERTY OWNER

CONTRACTOR

PROJECT INFORMATION

111 SCHOOL HOUSE ROAD MILFORD, CT 06460 SITE ADDRESS:

COUNTY NEW HAVEN

JURISDICTION: N/A

LATITUDE: 41° 12' 46.06" N

-73° 05' 07.10" W LONGITUDE:

PARCEL/APN # N/A

ZONING N/A

GROUND ELEVATION: 70.01 FT

TOWER TYPE: MONOPOLE

140'-0" TOWER HEIGHT

PROPERTY OWNER: N/A N/A

APPLICANT: T-MOBILE

35 GRIFFIN ROAD BLOOMFIELD, CT 06002

ENGINEER: TRYLON TSF

1825 W. WALNUT HILL LANE, SUITE 302

N/A

IRVING, TX 75038 CONTACT: MIKE MOORE

MIKE.MOORE@TRYLON.COM

NORTHEAST SITE SOLUTIONS 420 MAIN STREET, BLDG 4 STURBRIDGE, MA 01566 PROJECT MANAGER:

ERIC PROULX CONTACT:

EPROULX@NORTHEASTSITESOLUTIONS.COM

SHEET INDEX

SHEET #	DESCRIPTION	REVISION #
T-1	TITLE SHEET	2
T-2	GENERAL NOTES	2
C-1.1	OVERALL SITE PLAN	2
C-1.2	EXISTING PLAN	2
C-1.3	PROPOSED PLAN	2
C-2	DETAIL	2
C-3	GENERATOR SPECS	2
S-1	FOUNDATION DETAIL	2
E-1	AC PANEL SCHEDULES & ONE LINE DIAGRAM	2
G-1	GROUNDING DETAILS	2
,		



35 GRIFFIN ROAD BLOOMFIELD, CT 06002





T-MOBILE SITE NUMBER: CT11229A

111 SCHOOL HOUSE ROAD MILFORD, CT 06460

EXISTING 140'-0" MONOPOLE

Γ	ISSUED FOR:					
REV	DATE	DRWN	DESCRIPTION	DES./Q.		
Α	06/22/2022	RC	PRELIMINARY			
0	07/15/2022	RC	ISSUE FOR CONSTRUCTION			
1	08/26/2022	RC	ISSUE FOR CONSTRUCTION ISSUE FOR			
2	04/26/2023	RC	ISSUE FOR CONSTRUCTION			



IT IS A VIOLATION OF LAW FOR ANY PERSON, UNLESS THEY ARE ACTING UNDER THE DIRECTION OF A LICENSED PROFESSIONAL ENGINEER, TO ALTER THIS DOCUMENT.

SHEET NUMBER:

SHOWN IN BOTH, THE MORE STRINGENT REQUIREMENTS SHALL APPLY.

2. THE INTENTION OF THE DOCUMENT IS TO INCLUDE ALL LABOR

AND COMPLETION OF THE WORK AS STIPULATED IN THE CONTRACT.

OR DOING ANY WORK, NO EXTRA CHARGE OR COMPENSATION WILL BE ALLOWED DUE TO DIFFERENCES BETWEEN ACTUAL DIMENSIONS OR

WILL BE ACCEPTED AS AN EXCUSE FOR ANY FAILURE OR OMISSION ON THE PART OF THE CONTRACTOR TO FULFILL EVERY DETAIL OF ALL THE

CAUSED BY EMPLOYEES AT THE COMPLETION OF THE WORK, REMOVE ALL WASTE AND NON-CONSTRUCTION MATERIAL INCLUDING ALL CONTRACT

A CODES

AUTHORITIES WITH JURISDICTION OVER THE SALTIER. THIS RESPONSIBILITY IS IN EFFECT REGARDLESS OF WEATHER THE LAW, ORDINANCE,

A LICENSING

FOLLOW ALL APPLICABLE RULES AND REGULATIONS OF THE WITH TOWER CONSTRUCTION AND SAFETY, EXCAVATION AND TRENCHING, AND WORK IN CONFINED SPACES. ENSURE THAT EMPLOYEES AND SUBCONTRACTORS WEAR HARD HATS AT ALL TIMES DURING CONSTRUCTION.

A. BUILDING PERMITS

1. CONTRACTOR WILL SUBMIT CONSTRUCTION DOCUMENTS TO THE JURISDICTIONAL AUTHORITY FOR PLAN CHECK AND REVIEW. CONTRACTOR WILL SUBMIT LICENSING AND WORKMAN'S COMPENSATION INFORMATION TO THE JURISDICTION AS REQUIRED TO OBTAIN THE BUILDING PERMIT, CONTRACTOR SHALL COORDINATE AND SCHEDULE REQUIRED INSPECTIONS AND POST REQUIRED PERMITS AT THE JOB SITE COMPLY WITH SPECIFIC PROJECT RELATED REQUESTS AND SUGGESTIONS MADE BY BUILDING INSPECTOR, AND INFORM CONSTRUCTION MANAGER OF ANY SUCH WORK THAT MAY BE BEYOND THE SCOPE OF THE CONTRACT OR DEVIATE FROM THE CONSTRUCTION DOCUMENT. T-MOBILE WILL REIMBURSE THE

A. ZONING REGULATIONS AND CONDITIONAL USE PERMITS 1. CONTRACTOR WILL SUBMIT ALL ZONING AND CONDITIONAL USE HOURS OF WORK, ACCESS LIMITATIONS, ETC. THE CONSTRUCTION MANAGER WILL INFORM THE CONTRACTOR OF THESE REQUIREMENTS AT THE

A. FAA PERMIT AND TOWER LIGHTING 1. REFER TO CONSTRUCTION DOCUMENTS AND CONSTRUCTION

A TOWER SECURITY

1. IF REQUIRED, TOWER MUST BE FENCED, TEMPORARILY OR PERMANENTLY WITHIN 24 HOURS OF ERECTION. DO NOT ALLOW THE GATE ACCESSING THE TOWER AREA TO REMAIN OPEN OR UNATTENDED ANY TIME

2. THE CONTRACTOR IS TO MAINTAIN ADEQUATE DRAINAGE AT ALL TIMES, DO NOT ALLOW WATER TO STAND OR POND, ANY DAMAGE TO STRUCTURES OR WORK ON THE SITE CAUSED BY INADEQUATE MAINTENANCE OF DRAINAGE PROVISIONS WILL BE THE RESPONSIBILITY OF THE CONTRACTOR AND ANY COST ASSOCIATED WITH REPAIRS FOR SUCH DAMAGE WILL BE AT THE CONTRACTOR'S EXPENSE.

OR AS DIRECTED BY CONSTRUCTION MANAGER AND IN ACCORDANCE WITH

1. PROTECT AND SECURE LIVESTOCK. MAINTAIN AND SECURE EXISTING

A. SCOPE OF WORK INCLUDES

MATERIALS WHICH MIGHT BE DAMAGED BY CONSTRUCTION ACTIVITIES

RE-INSTALLATION OF EXISTING FENCE AND OTHER SITE IMPROVEMENTS SCHEDULED FOR RE-USE.

MANAGER OR AS NOTED IN CONSTRUCTION DOCUMENTS)

MATERIALS USED FOR TREE PROTECTION, EROSION CONTROL.

A. SCOPE OF WORK INCLUDES

1. EXCAVATION, TRENCHING, FILLING, COMPACTION, AND GRADING FOR STRUCTURES, SITE IMPROVEMENTS AND UTILITIES.

SLABS, PAVEMENT AND IMPROVEMENTS.

. SUPPLY OF ADDITIONAL MATERIALS FOR OFFSITE AS REQUIRED. 5. REMOVAL AND LEGDK DISPOSAL OF EXCAVATED MATERIAL AS

WALKWAYS WILL OBTAIN A 95% COMPACTION AT A MINIMUM DRY DENSITY AS DETERMINED BY ASTM 0-1557 OR WITH PLUS OR MINUS 3% OF THE

LAWNS, UNPAVED AREAS AND WALKS PLUS OR MINUS 1

B. UNDER PAVEMENTS PLUS OR MINUS ½ INCH.
3. GRADING TOLERANCES FOR FILL UNDER CONCRETE APPLICATIONS A. PLUS OR MINUS $\frac{1}{2}$ INCH MEASURED WITH 10 FOOT STRAIGHT

MANAGER OR AS NOTED IN CONSTRUCTION DOCUMENTS) SUB-BASE MATERIAL: GRADED MIXTURE OF NATURAL OR CRUSHED

2. WASHED MATERIAL, EVENLY GRADED MIXTURE OF CRUSHED STONE DR GRAVEL WITH 95% PASSING A 1-1/2 INCH SIEVE

3. GRADING MATERIAL WILL CONSIST OF SATISFACTORY NATIVE OR IMPORTED SOIL MATERIALS FREE OF CLAY, ROCK OR GRAVEL NOT LARGER THAN 2 INCHES IN ANY DIMENSION, DEBRIS, WASTE, FROZEN MATERIALS AND OTHER UNSUITABLE MATERIALS WILL NOT BE ALLOWED FOR US

4. GRAVEL MATERIAL: EVENLY GRADED MIXTURE OF CRUSHED STONE OR GRAVEL WITH 95% PASSING A 1-1/2 INCH SIEVE

. REMOVE ALL VEGETATION AND MATERIALS AS REQUIRED. REMOVE

THAT WILL UNDERLAY GRAVEL, PAVEMENT, NEW STRUCTURES OR EMBANKMENTS. STOCKPILE STRIPPING ON—SITE FOR RE—USE AND FINAL

CONSTRUCT EMBANKMENT FROM ON-SITE EXCAVATION MATERIAL WHEN

DEPTH. THE FULL WIDTH OF THE CROSS SECTION SHALL BE BROUGHT

IN THE APPROPRIATE BID ITEM. SHOULD THE MATERIAL BE TOO WET TO PERMIT PROPER COMPACTION, IT IS THE CONTRACTOR'S RESPONSIBILITY TO UTILIZE MATERIAL WITH AN ACCEPTABLE MOISTURE CONTENT

EMBANKMENTS AND THE REPLACEMENT OF ANY PORTION WHICH HAS

ROUTE EQUIPMENT BOTH LOADED AND EMPTY, OVER THE FULL WIDTH OF THE EMBANKMENT TO ENSURE UNIFORMITY OF MATERIAL PLACEMENT.

9. COMPACT EMBANKMENT UNDERLYING NEW GRAVEL PAVING, FLOOR

DENSITY AS DETERMINED BY ASTM 0-1557 OR WITHIN PLUS OR MINUS 3% OF OPTIMUM MOISTURE CONTENT. COMPACT NON-STRUCTURAL AREA

COMPACT AREAS OF UNDERLYING NEW GRAVEL, PAVING, FLOOR SLABS

CONSTRUCT FINISH SURFACE OF SITE GRADING AREAS WITHIN 1 INCH

1. SHAPE TOP OF SUBGRADE TO THE LINES AND GRADES SHOWN ON

AT A MAXIMUM DRY DENSITY AS DETERMINED BY ASTM 0-1557 OR WITHIN PLUS OR MINUS 3% OF THE OPTIMUM MOISTURE CONTENT.

5. CONSTRUCT TOP OF SUBGRADE WITHIN 1 INCH OF ESTABLISHED

ALL JOINTS TO A MINIMUM OF 36 INCHES.

CONSTRUCT GRAVEL SURFACING AREAS USING CRUSHED AGGREGATE

RECEIVE A $\frac{3}{4}$ INCH BY $\frac{3}{4}$ INCH 45 DEGREE CHAMFER. OTHER EXPOSED EDGES SHALL RECEIVE A TOOLED RADIUS FINISH.

4 REFER TO STRUCTURAL DRAWINGS FOR ADDITIONAL REQUIREMENTS

4. GENERAL NOTES

SHEETS AND SPECIFICATIONS AND COORDINATE HIS WORK WITH THE WORK OF ALL OTHER CONTRACTORS TO ENSURE THAT WORK

REMOVE AND DISPOSE OFF SITE ALL RUBBISH, WASTE MATERIAL LITTER AND ALL FOREIGN SUBSTANCES. REMOVE PETROCHEMICA

THE PLANS SHOW SOME KNOWN SUBSURFACE STRUCTURE ABOVE GROUND STRUCTURES AND/OR UTILITIES BELIEVED TO EXIST IN THE WORKING AREA, EXACT LOCATION OF WHICH MAY VARY FROM WARNED THAT THE EXACT OR EVEN APPROXIMATE LOCATION OF SHALL BE HIS RESPONSIBILITY TO PROCEED WITH GREAT 48 HOURS BEFORE YOU DIG, DRILL OR BLAST CALL LOCAL

WRITING OF ANY CONDITIONS THAT VARY FROM THOSE SHOWN OF THE PLANS WITHOUT THE EXPRESSED APPROVAL OF THE OWNER

OR THE OWNER'S REPRESENTATIVE.
THE CONTRACTOR IS INSTRUCTED TO COOPERATE WITH ANY AND ALL OTHER CONTRACTORS PERFORMING WORK ON THE SITE

THE CONTRACTOR SHALL RESTORE ALL DAMAGED, PUBLIC OR PRIVATE PROPERTY TO AT LEAST AS GOOD OF CONDITION AS

THE CONTRACTOR SHALL COMPLY WITH ALL REQUIRED PERMITS.

11. ALL UTILITY WORK INVOLVING CONNECTIONS TO EXISTING SYSTEMS SHALL BE COORDINATED WITH THE OWNER OR OWNER'S

12. MAINTAIN FLOW FOR ALL EXISTING UTILITIES
13. ALL SITE FILL SHALL MEET SELECTED FILL STANDARDS AS

14. CONTRACTOR TO GRADE ALL AREAS OF THE SITE TO PROVIDE

17. WATER AND SEWER SERVICES ARE NOT REQUIRED FOR THE

18. THE CONTRACTOR SHALL FURNISH AND INSTALL ALL MATERIAL

SITE LEGENDS

----- CENTERLINE ----- GROUND CONDUCTOR ----- A----- COAXIAL CABLE ----X---- CHAIN LINK FENCING OVERHEAD POWER LINE _____ E _____ POWER RUN ——F/P—— FIBER/POWER RUN ----- TELCO RUN T/E POWER/TELCO RUN GROUNDING CONDUCTOR ----- SPARK ZONE AND WORKING CLEARANCE

SYMBOLS & MATERIAL



DETAIL REFERENCE



FLEVATION REFERENCE



T · · Mobile · · · T-MOBILE NORTHEAST LLC

35 GRIFFIN ROAD BLOOMFIELD, CT 06002





IRVING, TEXAS 75038

T-MOBILE SITE NUMBER: CT11229A

111 SCHOOL HOUSE ROAD MILFORD, CT 06460


EXISTING 140'-0" MONOPOLE

_						
	ISSUED FOR:					
REV	DATE	DRWN	DESCRIPTION	DES./QA		
Α	06/22/2022	RC	PRELIMINARY			
0	07/15/2022	RC	ISSUE FOR CONSTRUCTION ISSUE FOR			
1	08/26/2022	RC	ISSUE FOR CONSTRUCTION ISSUE FOR			
2	04/26/2023	RC	ISSUE FOR CONSTRUCTION			



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> SHEET NUMBER: T-2

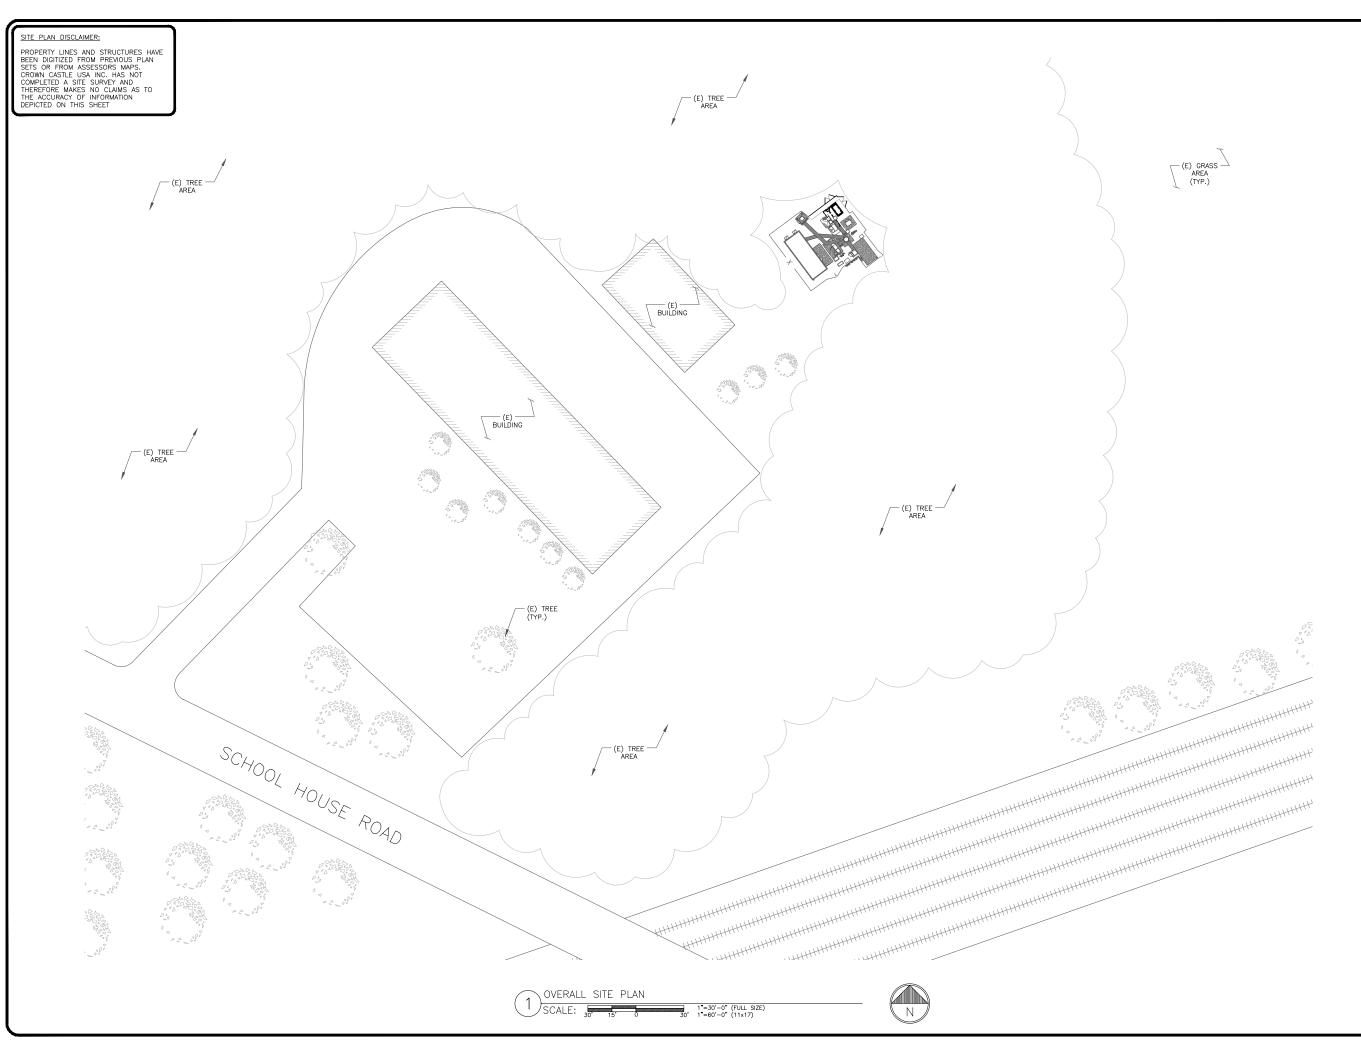

T--Mobile---T-MOBILE NORTHEAST LLC

35 GRIFFIN ROAD BLOOMFIELD, CT 06002



420 MAIN STREET, BLDG 4 STURBRIDGE, MA 01566 203-275-6669




T-MOBILE SITE NUMBER: **CT11229A**

111 SCHOOL HOUSE ROAD MILFORD, CT 06460

EXISTING 140'-0" MONOPOLE


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SHEET NUMBER:

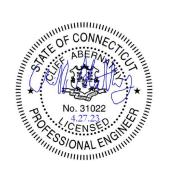C-1.1





35 GRIFFIN ROAD BLOOMFIELD, CT 06002

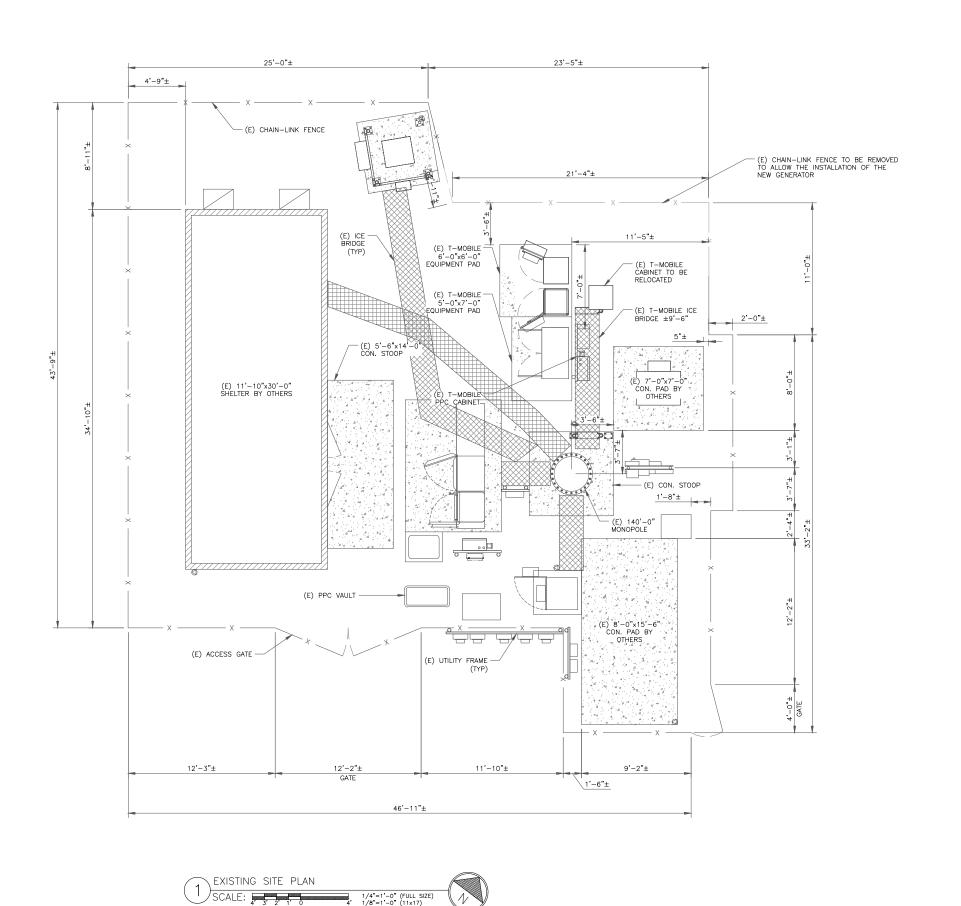



1825 W. WALNUT HILL LANE, SUITE 120 IRVING, TEXAS 75038

T-MOBILE SITE NUMBER: **CT11229A**

111 SCHOOL HOUSE ROAD MILFORD, CT 06460

EXISTING 140'-0" MONOPOLE


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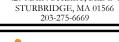
C-1.2



T - Mobile - - T-MOBILE NORTHEAST LLC

35 GRIFFIN ROAD BLOOMFIELD, CT 06002



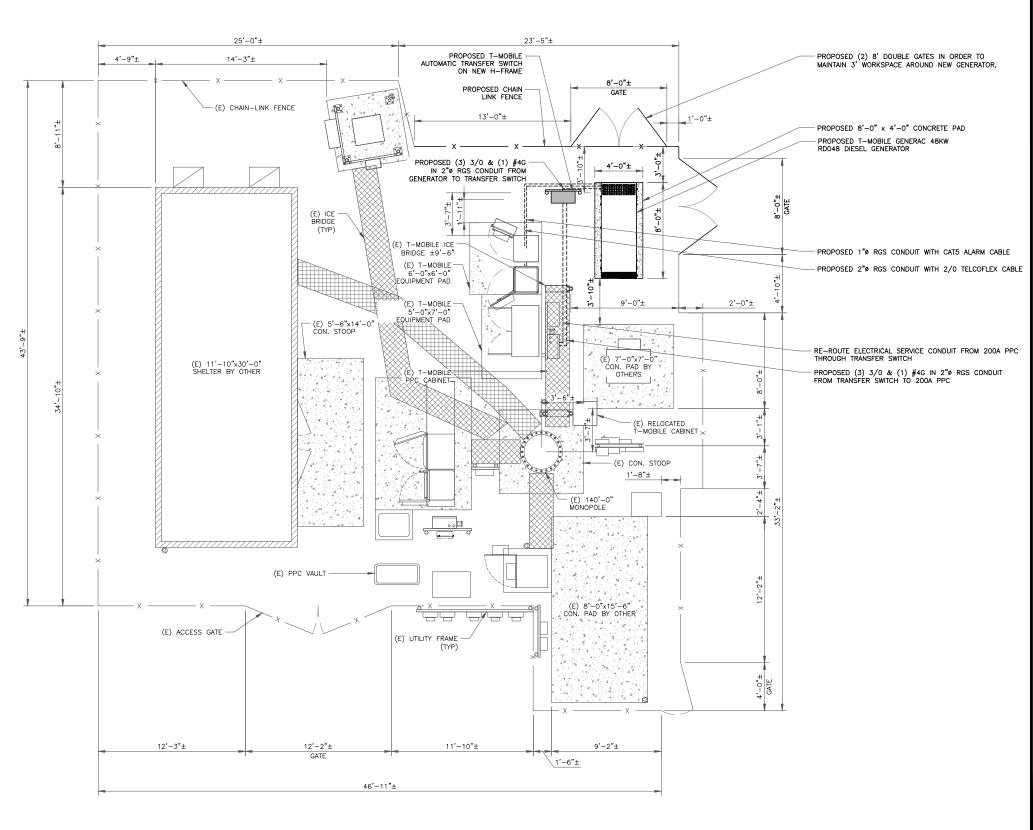



T-MOBILE SITE NUMBER: **CT11229A**

111 SCHOOL HOUSE ROAD MILFORD, CT 06460

EXISTING 140'-0" MONOPOLE


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SHEET NUMBER:

C-1.3





BLOOMFIELD, CT 06002

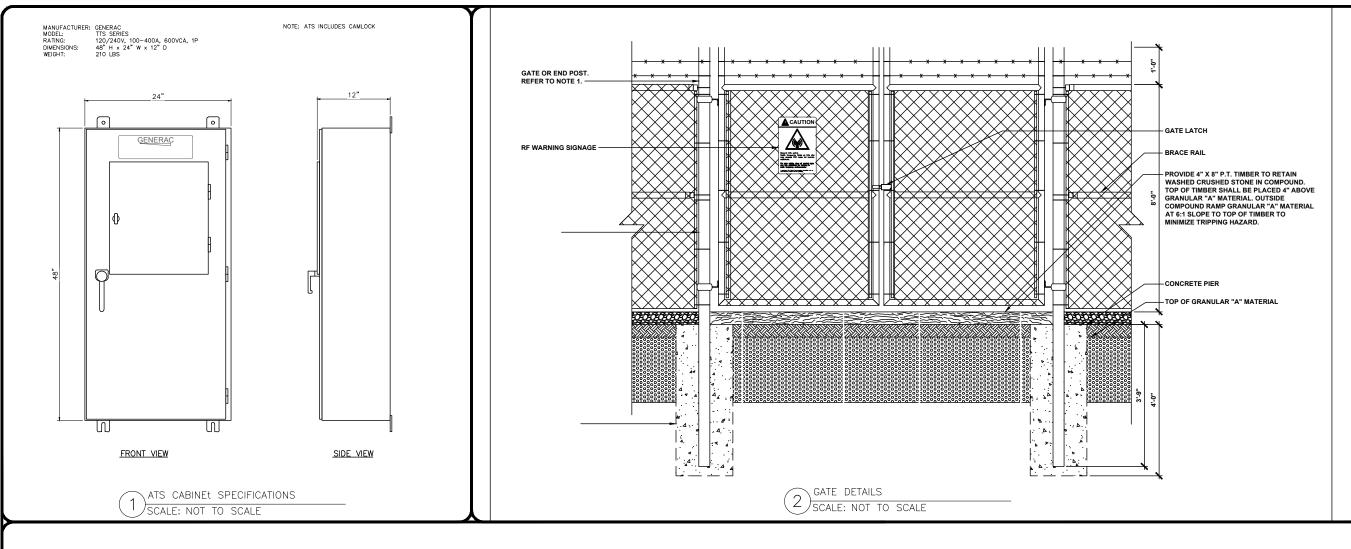

STURBRIDGE, MA 01566 203-275-6669




IRVING, TEXAS 75038

T-MOBILE SITE NUMBER: **CT11229A**

111 SCHOOL HOUSE ROAD MILFORD, CT 06460

EXISTING 140'-0" MONOPOLE


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SHEET NUMBER:

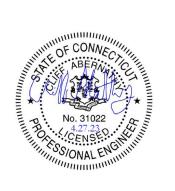C-2



GENERAC' NOUSTRIAL

INDUSTRIAL DIESEL GENERATOR SET EPA Certified Stationary Emergency

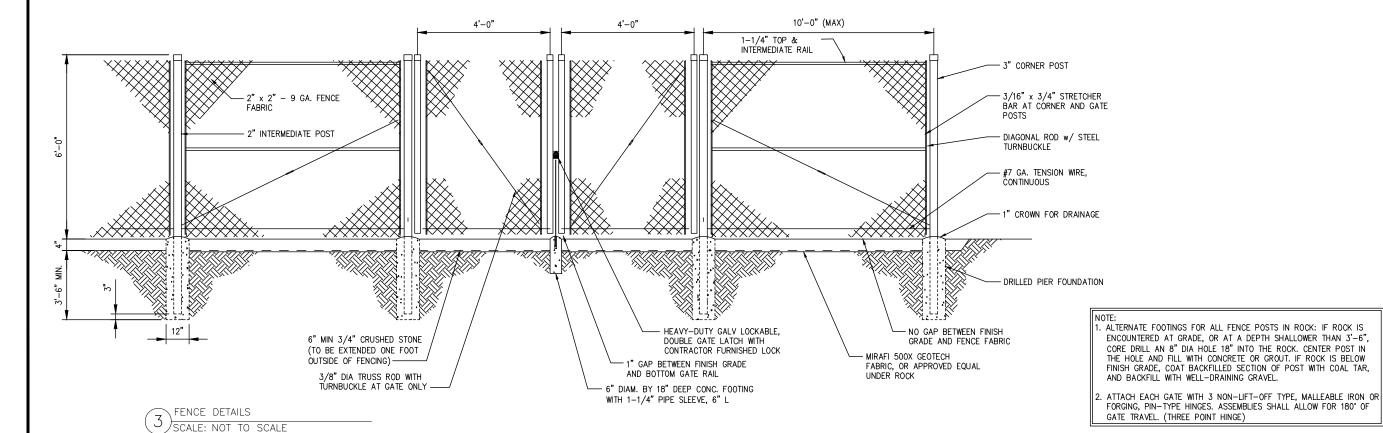Standby Power Rating 48 kW, 60 kVA, 60 Hz







Codes and Standards

Not all codes and standards apply to all configurations. Contact factory for details.



UL2200, UL508, UL489, UL142



CSA 22.2



BS5514 and DIN 6271



SHE SISH



NFPA 37, 70, 99



ISO 3046, 8528, 9001



NEMA ICS1, ICS10, MG1, 250, ICS6, AB1



ANSI/IEEE C62.41

Powering Ahead


For over 50 years, Generac has led the industry with innovative design and superior manufacturing.

Generac ensures superior quality by designing and manufacturing most of its generator components, including alternators, enclosures and base tanks, control systems and communications software.

Generac's gensets utilize a wide variety of options, configurations and arrangements, allowing us to meet the standby power needs of practically every application.

Generac searched globally to ensure the most reliable engines power our generators. We choose only engines that have already been proven in heavy-duty industrial application under adverse conditions.

Generac is committed to ensuring our customers' service support continues after their generator purchase.

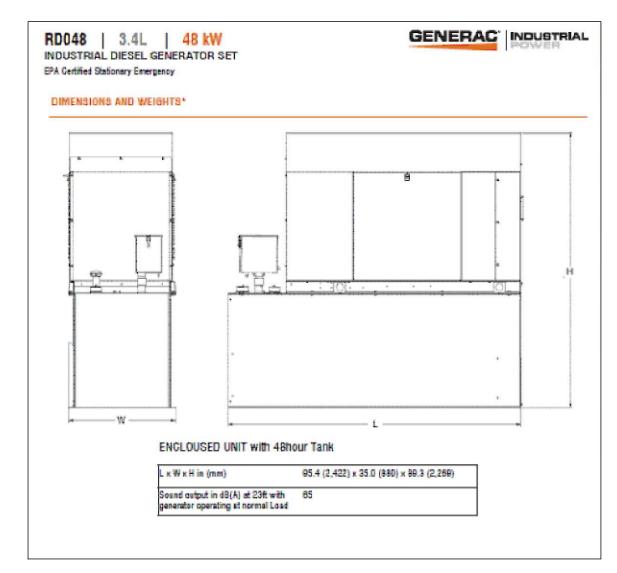



35 GRIFFIN ROAD BLOOMFIELD, CT 06002





T-MOBILE SITE NUMBER: **CT11229A**

111 SCHOOL HOUSE ROAD MILFORD, CT 06460

EXISTING 140'-0" MONOPOLE

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SHEET NUMBER:

C-3

2

REVISION:


GENERATOR SPECIFICATIONS
SCALE: NOT TO SCALE


NOTES:

- 1. ALL CONCRETE CONSTRUCTION SHALL MEET THE REQUIREMENTS OF THE AMERICAN CONCRETE INSTITUTE (ACI 318—14) BUILDING CODE REQUIREMENTS FOR REINFORCED CONCRETE AND (ACI 301) STANDARD SPECIFICATION FOR STRUCTURAL CONCRETE. ALL CONCRETE WORK SHALL BE IN ACCORDANCE WITH THE ACIW301, ACIW318, ASTM A184
- MINIMUM ALLOWABLE CONCRETE COMPRESSIVE STRENGTH SHALL BE 2500 PSI AT 28 DAYS WHEN TESTED IN ACCORDANCE WITH THE
- AMERICAN SOCIETY FOR TESTING AND MATERIALS METHODS STANDARDS
 ASTM C172, ASTM C31 AND ASTM C39 UNLESS OTHERWISE NOTED.
 REINFORCING STEEL SHALL CONFORM TO ASTM A615, GRADE 60,

 6. CHAMFER ALL EXPOSED EDGES OF CONCRETE 3/4" IN ACCORDANCE WITH ACI 301 SECTION 4.2.2. UNLESS OTHERWISE NOTED.


 6. REINFORCING STEEL SHALL BE ACCURATELY PLACED AND ADEQUATELY
- DEFORMED UNLESS NOTED OTHERWISE. WELDING WIRE FABRIC SHALL CONFORM TO ASTM A185 WELDED STEEL WIRE FABRIC UNLESS NOTED OTHERWISE. SPLICES SHALL BE CLASS "8" AND ALL HOOKS SHALL BE STANDARD, UNLESS NOTED OTHERWISE.
 DETAILING SHALL BE IN ACCORDANCE WITH MANUAL OF STANDARD
- PRACTICE OF DETAILING REINFORCED CONCRETE STRUCTURES (ACI STD-315-92).
- REINFORCING STEEL SHALL BE ACCURATELY PLACED AND ADEQUATELY SECURED IN POSITION. LOCATION OF REINFORCEMENT SHALL BE INDICATED ON THE DRAWINGS. CONCRETE COVER SHALL DEPEND ON WHETHER CONCRETE IS PRE-CAST OR CAST IN PLACE.
- TOP OF FOUNDATION TO HAVE A "BRUSH FINISH".
- EXPOSED FINISHED SURFACE IS NOT TO HOLD WATER.
- ALL SURFACES ARE TO BE CLEANED OF ANY RESIDUAL CONCRETE FROM SPLASHING OR SPILLS.

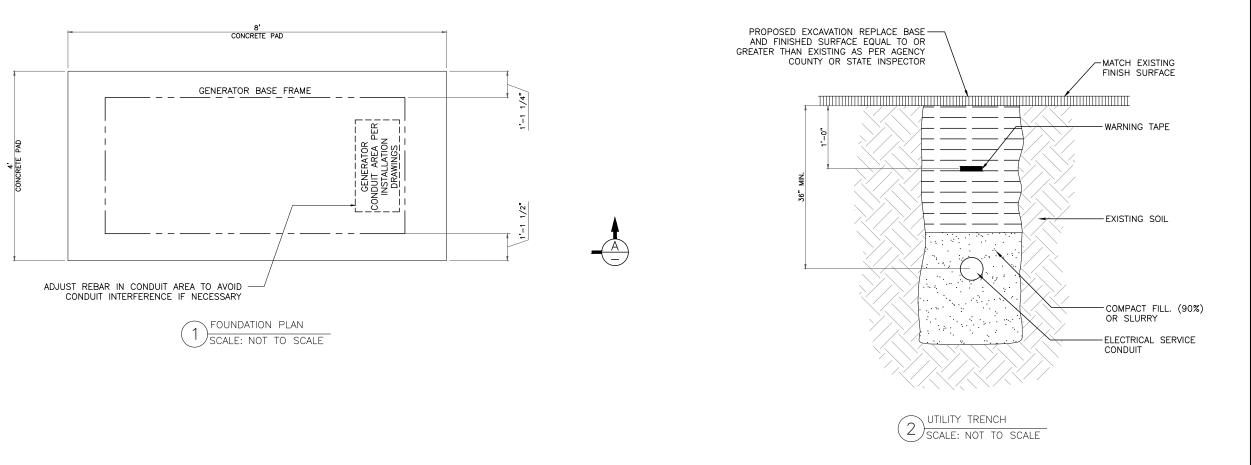

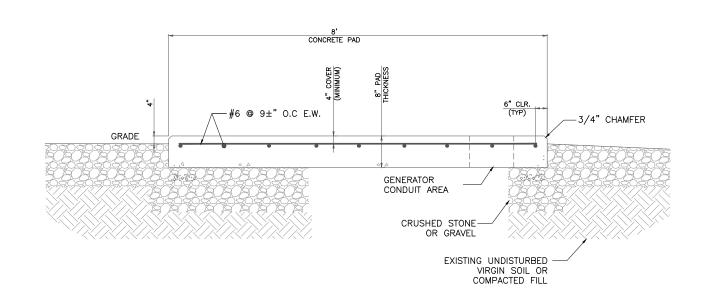

SECTION A-A

SCALE: NOT TO SCALE

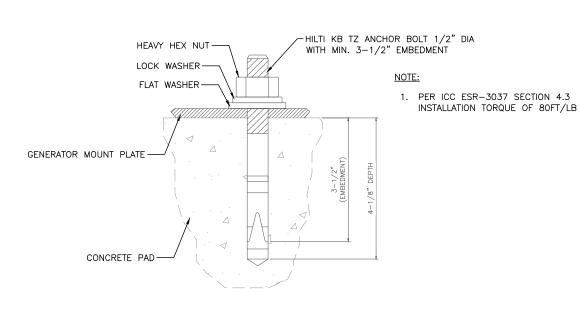

ANCHOR BOLT DETAIL 5) SCALE: NOT TO SCALE

T··Mobile··· T-MOBILE NORTHEAST LLC 35 GRIFFIN ROAD



BLOOMFIELD, CT 06002



T-MOBILE SITE NUMBER: CT11229A

111 SCHOOL HOUSE ROAD MILFORD, CT 06460

EXISTING 140'-0" MONOPOLE

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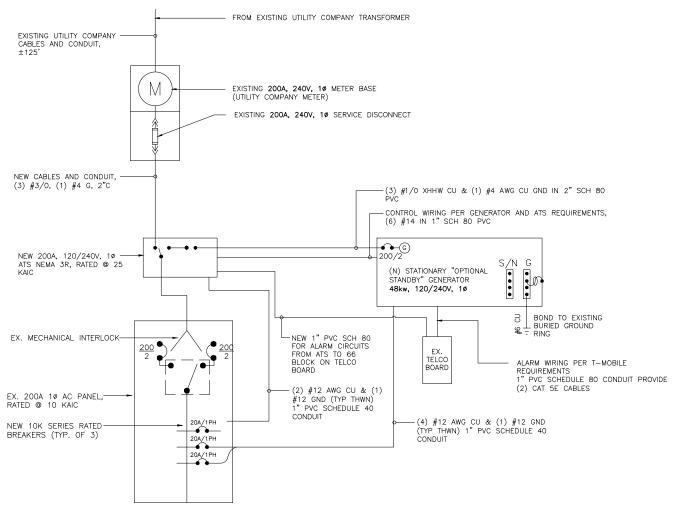


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SHEET NUMBER:

S-1

PENDING





35 GRIFFIN ROAD BLOOMFIELD, CT 06002



STURBRIDGE, MA 01566 203-275-6669




T-MOBILE SITE NUMBER: **CT11229A**

111 SCHOOL HOUSE ROAD MILFORD, CT 06460

EXISTING 140'-0" MONOPOLE

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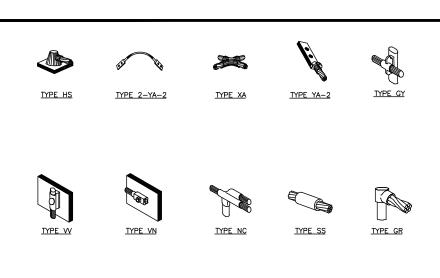
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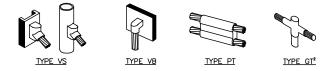
SHEET NUMBER:
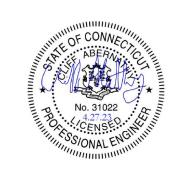
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REVISION:

ONE LINE DIAGRAM
SCALE: NOT TO SCALE





NOTES:

1. HAND DIG ONLY WITHIN COMPOUND.

• BELOW GRADE CONDUITS: SCH. 40 PVC CONDUIT

POSSIBLE AT ALL 90" TURNS. 3. CONDUIT TYPES SHALL BE AS FOLLOWS:

GROUNDING LEGEND

MECHANICAL CONNECTION

EXOTHERMIC CONNECTION

GROUND ROD

GROUND WIRE


• INTERIOR CONDUITS: IMC

- 1. ERICO EXOTHERMIC "MOLD TYPES" SHOWN HERE ARE EXAMPLES. CONSULT WITH CONSTRUCTION MANAGER FOR SPECIFIC
- MOLDS TO BE USED FOR THIS PROJECT.

 2. MOLD TYPE ONLY TO BE USED BELOW GRADE WHEN CONNECTING GROUND RING TO GROUND ROD.

CADWELD GROUNDING CONNECTIONS SCALE: NOT TO SCALE

	CONDUIT SCHEDULE
KEY	DESCRIPTION
1	1" CONDUIT W/PULLSTRINGS FOR ALARM CABLES (FROM GENERATOR TO BTS)
2	2" CONDUIT W/PULLSTRING (FROM GENERATOR TO PPC FOR BLOCK HEATER/BATTERY CHARGER))
3	2" CONDUIT W/ PULLSTRING (FROM ATS TO PPC, FOR POWER FEEDERS)
4	2" CONDUIT W/ PULLSTRING (FROM GENERATOR TO ATS FOR EMERGENCY POWER FEEDERS)
5	1" CONDUIT W/ PULLSTRING (FROM GENERATOR TO ATS, FOR CONTROL CABLE)
	/ -
	ş'

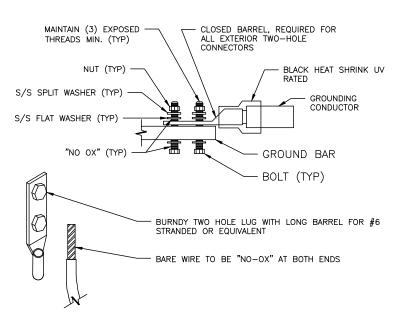

ALL HARDWARE SHALL BE 18-8 STAINLESS STEEL. COAT ALL SURFACES WITH
ANTIOXIDANT COMPOUND BEFORE ALL EXPOSED EASILY SHALL BE TAGGED "DO NOT DISCONNECT".
4. COAT ALL BARRELS WITH ANTIOXIDANT BEFORE CRIMPING.

> EXTERIOR GROUND BAR LUG SCALE: NOT TO SCALE

> > SCALE: NOT TO SCALE

NOTES:

- 1. BOND PPC AND EQUIPMENT ENCLOSURES TO BURIED GROUNDING CONDUCTOR. USE A NEMA DRILLING, TWO—HOLE CONNECTOR FOR BONDS TO EQUIPMENT ENCLOSURES; USE AN APPROVED CONDUIT CLAMP FOR CONNECTIONS TO SERVICE CONDUITS. EXOTHERMICALLY WELD CONNECTIONS TO GROUNDING
- 2. BOND ALL EXTERIOR CONDUITS, PIPES, AND CYLINDRICAL METALLIC OBJECTS WITH A PENN-UNION GT SERIES CLAMP, BLACKBURN GUV SERIES CLAMP, OR A BURNDY GAR 3900BU SERIES CLAMP ONLY. NO SUBSTITUTES ACCEPTED.
- 3. AFTER INSTALLATION IS COMPLETED IN CONFORMANCE WITH THESE DRAWINGS AND THE STANDARD SPECIFICATIONS, THE CONTRACTOR SHALL CONFIRM THE IMPEDANCE (GROUND RESISTANCE) TO EARTH AND BETWEEN GROUNDING CIRCUITS. THE GROUNDING SYSTEM IS EXPECTED TO PROVIDE FOR A MAXIMUM EARTH RESISTANCE OF 6 OHMS. THE CONTRACTOR SHALL NOTIFY T-MOBILE PRIOR TO ALL TESTING AND SHALL FURTHER NOTIFY T-MOBILE IN THE EVENT THE EARTH RESISTANCE IS GREATER THAN 5 OHMS.
- 4. ALL GROUNDING INSTALLATION IS TO BE IN ACCORDANCE WITH THE T-MOBILE WIRELESS STANDARDS AND SUPPLEMENTS PROVIDED BY THE PROJECT
- 5. ALL BENDS ON THE GROUND CONDUCTOR TO BE MADE WITH A MINIMUM 24"
- 6. ALL GROUND LEADS MUST TERMINATE AT MGB, NOT HALO.
- 7. MUST USE INSPECTION HOLE LUGS FOR GROUNDING
- 8. NO OVERLAPPING GROUND HARDWARE.
- 9. WHERE MECHANICAL CONNECTIONS ARE USED (TWO HOLE OR CRIMP), APPLY A LIBERAL PROTECTIVE COATING OF A CONDUCTIVE ANTI-OXIDE COMPOUND ON ALL CONNECTORS SUCH AS NO-OX OR APPROVED EQUAL.

GENERAL GROUNDING NOTES SCALE: NOT TO SCALE



BLOOMFIELD, CT 06002



203-275-6669




T-MOBILE SITE NUMBER: CT11229A

111 SCHOOL HOUSE ROAD MILFORD, CT 06460

EXISTING 140'-0" MONOPOLE

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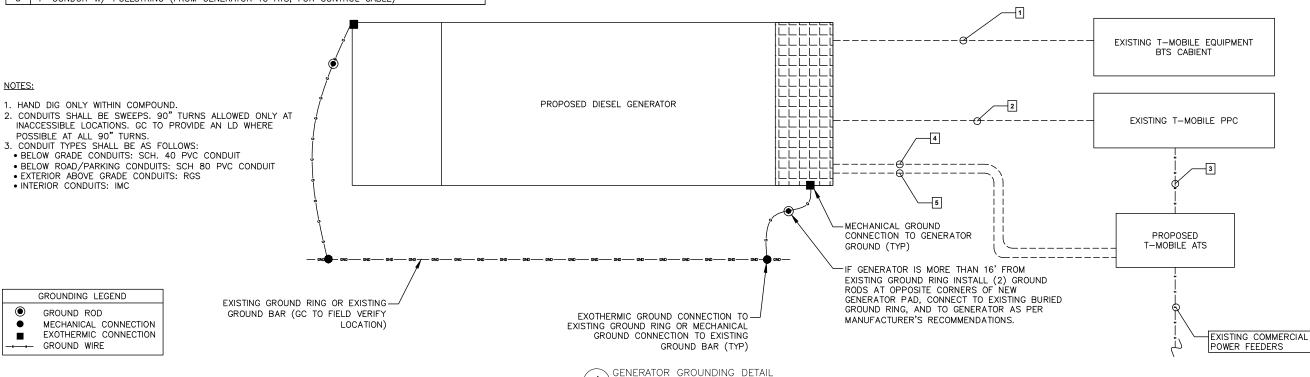


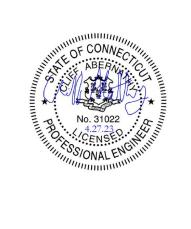Exhibit D

EPA Certified Stationary Emergency



Standby Power Rating 48 kW, 60 kVA, 60 Hz







Image used for illustration purposes only

Codes and Standards

Not all codes and standards apply to all configurations. Contact factory for details.



UL2200, UL508, UL489, UL142



CSA 22.2





BS5514 and DIN 6271



SAE J1349



NFPA 37, 70, 99



ISO 3046, 8528, 9001



NEMA ICS1, ICS10, MG1, 250, ICS6, AB1



an National Standards Institute ANSI/IEEE C62.41

Powering Ahead

For over 50 years, Generac has led the industry with innovative design and superior manufacturing.

Generac ensures superior quality by designing and manufacturing most of its generator components, including alternators, enclosures and base tanks, control systems and communications software.

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INDUSTRIAL DIESEL GENERATOR SET

EPA Certified Stationary Emergency

Standard Features

ENGINE SYSTEM

- · Cold Weather Kit
- · Oil Drain Extension
- · Fan Guard
- Stainless Steel Flexible Exhaust Connection
- · Factory Filled Oil & Coolant

Fuel System

· Primary Fuel Filter

Cooling System

- · Closed Coolant Recovery System
- · Factory-Installed Radiator
- 50/50 Ethylene Glycol Antifreeze
- Radiator Drain Extension
- Can Operate at up to 122°F (50°C) Ambient Temperature

Electrical System

- . Battery Charging Alternator
- Battery Cables
- Battery Tray
- **Rubber-Booted Engine Electrical Connections**
- Solenoid Activated Starter Motor
- Smart Battery Charger

ALTERNATOR SYSTEM

- · Class H Insulation Material
- 2/3 Pitch
- Skewed Stator
- Sealed Bearings
- Low Temperature Rise (<120°C)
- Low THD (<5%)

GENERATOR SET

GENERAC

Sound Attenuated Aluminum Enclosure

INDUSTRIAL

- · Internal Genset Vibration Isolation
- · Separation of Circuits High/Low Voltage
- Wrapped Exhaust Piping
- · Standard Factory Testing
- · 5 Year Limited Warranty
- Ready to Accept Full Load in <10 Seconds
- E-Stop

TANKS

- 48 Hour Run Time Tank
- UL 142 Listed Tank

CONTROL SYSTEM



Evolution ™ Controller

- Two-Line Plain Text LCD Display
- Programmable Start Delay Between 10-30
- . 10 second Engine Start Sequence
- 5 second Engine Warm Up
- 1 minute Engine Cool-Down
- Starter Lock-Out
- Smart Battery Charger
- Automatic Voltage Regulation with Over and Under Protection
- Automatic Low Oil Pressure Shutdown
- Overspeed Shutdown
- High Temperature Shutdown

- Overcrank Protection
- · Safety Fused
- · Failure to Transfer Protection
- · Low Battery Protection
- 50 Even Run Log
- . Future Set Capable Exerciser
- Incorrect Wiring Protection
- Internal Fault Protection
- · Common External Fault Capability
- · Governor Failure Protection

Optional Shipped Loose and Field Install Kits

GENERATOR SET

- O Paint Kit
- O Scheduled Maintance Kit

CONTROL SYSTEM

○ Mobile Link TM and Adapter Kit

TANKS

- O Spill Box
- O 90% Fuel Alarm
- Tank Risers
- O Spill Box Drainback Kit
- O Vent Extension Support Kit
- O 5 Day Run Time Tank
- Overfill Prevention Valve
- O Fuel Fill Drop Tube
- O Lockable Fuel Cap

INDUSTRIAL DIESEL GENERATOR SET

EPA Certified Stationary Emergency



APPLICATION AND ENGINEERING DATA

ENGINE SPECIFICATIONS

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Make	Generac
Cylinder #	4
Туре	In-Line
Displacement - in ³ (L)	3.4 (207.48)
Bore - in (mm)	3.86 (98)
Stroke - in (mm)	4.45 (113)
Compression Ratio	18.5:1
Intake Air Method	Turbocharged/Aftercooled
Cylinder Head	Cast Iron OHV
Piston Type	Aluminum

Engine Governing

Governor	Electronic
Frequency Regulation (Steady State	e) ±0.25%

Lubrication System

Oil Pump Type	Gear
Oil Filter Type	Full Flow Spin-On Canister
Crankcase Capacity with Filters- qt (L	7.4 (7.0)

Cooling System

Cooling System Type	Closed Recovery
Fan Type	Pusher
Fan Speed- rpm	2,029
Fan Diameter - in (mm)	22 (559)

Fuel System

Fuel Type	Ultra Low Sulfur Diesel Fuel
Fuel Specification	ASTM
Fuel Pump Type	Mechanical Engine Driven Gear
Injector Type	Mechanical
Fuel Supply Lin (mm/in)	7.94/0.31 (ID)
Fuel Return Line (mm/in)	7.94/0.31 (ID)
Fuel Filtering (microns)	25

Engine Electrical System

System Voltage	12 VDC
Battery Charger Alternator	Standard
Battery Size	Group 27F
Battery Voltage	12 VDC
Ground Polarity	Negative

ALTERNATOR SPECIFICATIONS

Standard Model	Generac
Poles	4
Field Type	Rotating
Insulation Class - Rotor	Н
Insulation Class - Stator	Н
Total Harmonic Distortion	<5%
Telephone Interference Factor (TIF)	<50

Standard Excitation	Direct
Bearings	Single Sealed
Coupling	Flexible Disc
Prototype Short Circuit Test	Yes
Voltage Regulator Type	Full Digital
Number of Sensed Phases	2
Regulation Accuracy (Steady State)	±1.0%

INDUSTRIAL DIESEL GENERATOR SET

EPA Certified Stationary Emergency



OPERATING DATA

POWER RATINGS

Standby

Single-Phase 120/480 VAC @0.1pf

48 kW

Amps: 200

MOTOR STARTING CAPABILITIES (SKVA)

sKVA vs. Voltage Dip at 30%

120/240 V, Single-Phase at 0.4pf	189
----------------------------------	-----

FUEL CONSUMPTION RATES*

Percent Load	Diesel gal/hr (L/hr)
25%	1.35 (5.11)
50%	2.15 (8.14)
75%	3.06 (11.58)
100%	3.98 (15.07)

^{*} Fuel supply installation must accommodate fuel consumption rates at 100% load.

COOLING

		Standby
Air Flow (Radiator and Alternator)	ft³/min (m³/min)	2824 (80)
Coolant System Capacity	gal (L)	2.8 (10.6)
Heat Rejection to Coolant	BTU/hr (MJ/hr)	135,900 (143.4)
Temperature Deration	3% for every 5°C above 25°C or 1	.7% for every 5°F over 77°F
Altitude Deration	1% for every 100 m above 915 or 3% fo	r every 1000 ft over 3000 ft
Maximum Radiator Backpressure	in H ₂ O (kPa)	0.50 (0.12)

COMBUSTION AIR REQUIREMENTS

	Standby
Flow at Rated Power ft ³ /min (m ³ /min)	190 (5.38)

ENGINE			EXHAUST		
		Standby			Standby
Rated Engine Speed	rpm	1,800	Exhaust Flow (Rated Output)	ft ³ /min (m ³ /min)	448 (12.7)
Horsepower at rated kW	HP	85	Exhaust Temp (Rated Output - Post Silencer)	°F (°C)	1120 (604.4)


Deration – Operational characteristics consider maximum ambient conditions. Derate factors may apply under atypical site conditions.

Please consult a Generac Power Systems Industrial Dealer for additional details. All performance ratings in accordance with ISO3046, BS5514, ISO8528 and DIN6271 standards. Standby - See Bulletin 0187500SSB

EPA Certified Stationary Emergency



DIMENSIONS AND WEIGHTS*

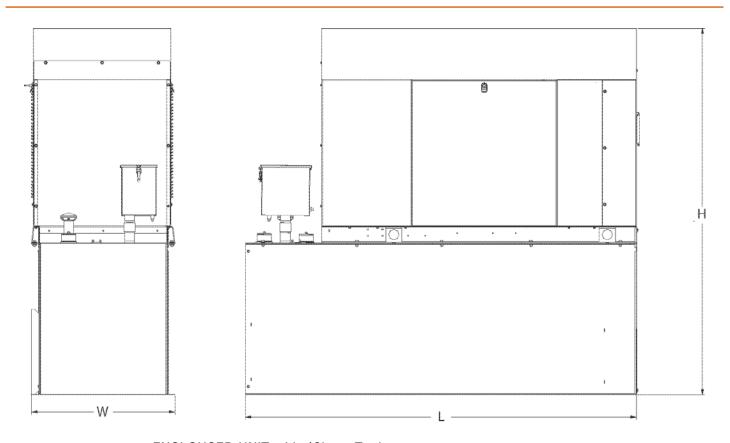

ENCLOUSED UNIT with 48hour Tank

L x W x H in (mm)	95.4 (2,422) x 35.0 (880) x 89.3 (2,269)
Sound output in dB(A) at 23ft with generator operating at normal Load	65

* All measurements are approximate and for estimation purposes only.

YOUR FACTORY RECOGNIZED GENERAC INDUSTRIAL DEALER		

Specification characteristics may change without notice. Dimensions and weights are for preliminary purposes only. Please consult a Generac Power Systems Industrial Dealer for detailed installation drawings.

1 of 12

Protector™ Series



Diesel Generator Set

INCLUDES:

- Two Line LCD Multilingual Digital Evolution™ Controller (English/Spanish/French/ Portuguese) with external viewing window for easy indication of generator status and breaker position.
- Isochronous Electronic Governor
- Sound Attenuated Aluminum Enclosure
- · Smart Battery Charger
- UV/Ozone Resistant Hoses
- ±1% Voltage Regulation
- Integrated Base Tank Provides Up to 40 Hours of Run Time
- 5 Year Limited Warranty*
- UL 2200 / UL142 / ULC S601 Listed
- Meets code requirements for External Vent and Fill

Standby Power Rating

Model RD015 - 15 kW 60 Hz Model RD020 - 20 kW 60 Hz Model RD030 - 30 kW 60 Hz

Model RD048 - 48 kW 60 Hz (single phase only) Model RD050 - 50 kW 60 Hz (three phase only)





Meets EPA Emission Regulations CA/MA Emissions Compliant

* 5 year warranty applicable to U.S. and Territories/Canada. International warranty is 3 year limited.

FEATURES

- **INNOVATIVE DESIGN & PROTOTYPE TESTING** are key components of GENERAC'S success in "IMPROVING POWER BY DESIGN." But it doesn't stop there. Total commitment to component testing, reliability testing, environmental testing, destruction and life testing, plus testing to applicable CSA, NEMA, EGSA, and other standards, allows you to choose GENERAC POWER SYSTEMS with the confidence that these systems will provide superior performance.
- O TEST CRITERIA:
 - √ PROTOTYPE TESTED
 - √ SYSTEM TORSIONAL TESTED
- √ NEMA MG1-22 EVALUATION √ MOTOR STARTING ABILITY
- SOLID-STATE, FREQUENCY COMPENSATED VOLTAGE REGULATION. This state-of-the-art power maximizing regulation system is standard on all Generac models. It provides optimized FAST RESPONSE to changing load conditions and MAXIMUM MOTOR STARTING CAPABILITY by electronically torque-matching the surge loads to the engine. Digital voltage regulation at ±1%.
- SINGLE SOURCE SERVICE RESPONSE from Generac's extensive dealer network provides parts and service know-how for the entire unit, from the engine to the smallest electronic component.
- GENERAC TRANSFER SWITCHES. Long life and reliability are synonymous with GENERAC POWER SYSTEMS. One reason for this confidence is that the GENERAC product line includes its own transfer systems and controls for total system compatibility.





application & engineering data

GENERATOR SPECIFICATIONS

Туре	Synchronous
Rotor Insulation Class	H (15 & 20 kW) or F (30, 48 & 50 kW)
Stator Insulation Class	H
Telephone Interference Factor (TIF)	<50
Alternator Output Leads 1-Phase	3 wire
Alternator Output Leads 3-Phase	6 wire
Bearings	Single Sealed Cartridge
Coupling	Direct, Flexible Disc
Excitation System	Direct

VOLTAGE REGULATION

Туре	Electronic
Sensing	Single Phase
Regulation	± 1%
Features	Adjustable Voltage & Gain

GOVERNOR SPECIFICATIONS

Туре	Electronic Isochronous
Steady State Regulation	± 0.25%

ELECTRICAL SYSTEM

Battery Charge Alternator	50 Amp (15 & 20 kW) or 70 Amp (30, 48 & 50 kW)
Smart Battery Charger	2 Amp
Recommended Battery (battery not included)	Group 27F, 700 CCA
System Voltage	12 Volts

GENERATOR FEATURES

Revolving field heavy duty generator Directly connected to the engine

Operating temperature rise 120°C above a 40°C ambient

Class H insulation is NEMA rated

Class F insulation is NEMA rated

All models fully prototype tested

ENCLOSURE FEATURES

Aluminum weather protective enclosure	Ensures protection against mother nature. Electrostatically applied textured epoxy paint for added durability.
Enclosed critical grade muffler	Quiet, critical grade muffler is mounted inside the unit to prevent injuries and maximize sound dampening.
Small, compact, attractive	Makes for an easy, eye appealing installation.
SAE	Sound attenuated enclosure ensures quiet operation.



application & engineering data

ENGINE SPECIFICATIONS: 15 & 20 kW

Make	Generac
Model	In-line
Cylinders	4
Displacement (Liters)	2.28
Bore (in./mm)	3.46/88
Stroke (in./mm)	3.70/94
Compression Ratio	21.3:1
Intake Air System	Naturally Aspirated
Cylinder Head Type	Cast Iron OHV
Piston Type	Aluminum
EPA Emissions Compliance	Emergency Stationary

ENGINE SPECIFICATIONS: 30 kW

Make	Generac
Model	In-line
Cylinders	4
Displacement (Liters)	2.4
Bore (in/mm)	3.54/90
Stroke (in/mm)	3.70/94
Compression Ratio	21.3:1
Intake Air System	Turbocharged
Cylinder Head Type	Cast Iron OHV
Piston Type	Aluminum
EPA Emissions Compliance	Emergency Stationary

ENGINE SPECIFICATIONS: 48/50 kW

Make	Generac		
Model	In-Line		
Cylinders	4		
Displacement (Liters)	3.4		
Bore in/mm	3.86/98		
Stroke in/mm	4.45/113		
Compression Ratio	18.5:1		
Intake Air System	Turbocharged/Aftercooled		
Cylinder Head Type	Cast Iron OHV		
Piston Type	Aluminum		
EPA Emissions Compliance	Emergency Stationary		

ENGINE LUBRICATION SYSTEM

Oil Pump Type	Gear
Oil Filter Type	Full flow spin-on canister
Crankcase Capacity (quarts/liters)	6.87/6.5 - 15 & 20 kW 6.8/6.4 - 30 kW
	7.4/7 - 48 & 50 kW

ENGINE COOLING SYSTEM

Туре	Pressurized radiator – 15 & 20 kW Closed recovery – 30, 48 & 50 kW
Water Pump	Pre-lubed, self-seating
Fan Speed (rpm)	1800 - 15 & 20 kW 2061 - 30 kW 2029 - 48 & 50 kW
Fan Diameter (in/mm)	18.11/460 (15 & 20 kW) 22/559 (30, 48 & 50 kW)
Fan Mode	Pusher

FUEL SYSTEM

Fuel Type	Ultra Low Sulfur Diesel Fuel
Fuel Pump Type	Mechanical Engine Driven Gear
Injector Type	Mechanical
Fuel Supply Line (mm/in)	7.94/0.31 (ID)
Fuel Return Line (mm/in)	7.94/0.31(ID)
Fuel Specification	ASTM
Fuel Filtering (microns)	5 - 15, 20 & 30 kW 10 - 48 & 50 kW

TANK SPECIFICATIONS

Total Size (gallons/liters)	34/128.7 - 15 & 20 kW 62/234.7 - 30, 48 & 50 kW
Usable Size (gallons/liters)	32/121.1 - 15 & 20 kW 57/215.8 - 30, 48 & 50 kW
Run Time @ 1/2 Load (hrs)	41 - 15 kW 31 - 20 kW 38 - 30 kW 25 - 48 & 50 kW
Listings	UL142 ULC-S601

WEIGHTS AND DIMENSIONS

	15 kW	20 kW	30 kW	48 kW	50 kW
Weight (lb/kg)	1380)/626	1927/874	2197	7/997
Dimensions (LxWxH) (in/cm)	81 x 31 x 50/2	205 x 78 x 128	95 x 35 x 57/242 x 89 x 145		

operating data

GENERATOR OUTPUT VOLTAGE/kW - 60 Hz

		kW (Standby)	Amp (Standby)	CB Size
	120/240 V, 1Ø, 1.0 pf	15	62	70
RD015	120/208 V, 3Ø, 0.8 pf	15	52	60
	120/240 V, 3Ø, 0.8 pf	15	45	50
	120/240 V, 1Ø, 1.0 pf	20	83	100
RD020	120/208 V, 3Ø, 0.8 pf	20	69	80
	120/240 V, 3Ø, 0.8 pf	20	60	70
	120/240 V, 1Ø, 1.0 pf	30	125	150
RD030	120/208 V, 3Ø, 0.8 pf	30	104	125
NDOOU	120/240 V, 3Ø, 0.8 pf	30	90	100
	277/480 V, 3Ø, 0.8 pf	30	45	50
	120/240 V, 1Ø, 1.0 pf	48	200	200
RD048/	120/208 V, 3Ø, 0.8 pf	50	173	200
RD050	120/240 V, 3Ø, 0.8 pf	50	150	175
	277/480 V, 3Ø, 0.8 pf	50	75	90

SURGE CAPACITY IN AMPS

		Voltage Dip	@ < .41
		15%	30%
	120/240 V, 1Ø	53	129
RD015	120/208 V, 3Ø	37	90
	120/240 V, 3Ø	32	78
	120/240 V, 1Ø	87	211
RD020	120/208 V, 3Ø	59	143
	120/240 V, 3Ø	51	124
	120/240 V, 1Ø	66	168
RD030	120/208 V, 3Ø	59	144
UUUSU	120/240 V, 3Ø	51	125
	277/480 V, 3Ø	26	64
	120/240 V, 1Ø	69	189
RD048/	120/208 V, 3Ø	90	218
RD050	120/240 V, 3Ø	78	189
	277/480 V, 3Ø	36	87

ENGINE FUEL CONSUMPTION

		gal/hr	L/hr
	25% of rated load	0.51	1.93
RD015	50% of rated load	0.79	2.99
HDUTS	75% of rated load	1.14	4.31
	100% of rated load	1.48	5.58
	25% of rated load	0.67	2.6
RD020	50% of rated load	1.05	3.97
NUUZU	75% of rated load	1.52	5.32
	100% of rated load	1.98	7.48
	25% of rated load	0.92	3.5
RD030	50% of rated load	1.45	5.5
טפטעח	75% of rated load	1.96	7.4
	100% of rated load	2.74	10.4
	25% of rated load	1.35	5.11
RD048/	50% of rated load	2.15	8.14
RD050	75% of rated load	3.06	11.58
	100% of rated load	3.98	15.07



operating data

ENGINE COOLING

	15 kW	20 kW	30 kW	48/50 kW
Air flow (inlet air including alternator and combustion air in cfm/cmm)	2824/80	2824/80	3038/86	2824/80
System coolant capacity (gal/liters)	2.8/10.6	2.8/10.6	2.8/10.6	2.8/10.6
Heat rejection to coolant (BTU per hr/MJ per hr)	63,535/67	63,535/67	111,000/117.1	135,900/143.4
Maximum operation air temperature on radiator (°C/°F)		50	/122	
Maximum ambient temperature (°C/°F)	50/122			

COMBUSTION REQUIREMENTS

Flow at rated power (cfm/cmm)	84.76/2.4	84.76/2.4	90/2.55	190/5.38
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SOUND EMISSIONS

Sound output in dB(A) at 23 ft (7 m) with generator in exercise mode*	65	
Sound output in dB(A) at 23 ft (7 m) with generator operating at normal load*	70	

^{*}Sound levels are taken from the front of the generator. Sound levels taken from other sides of the generator may be higher depending on installation parameters.

EXHAUST

Exhaust flow at rated output (cfm/cmm)	98.88/2.8	98.88/2.8	230/6.51	448/12.7
Exhaust temperature at rated output (°C/°F)	604.4/1120	604.4/1120	454.4/850	604.4/1120

ENGINE PARAMETERS

Rated Synchronous RPM	1800				
HP at rated kW	26.4	33.5	49	85	

POWER ADJUSTMENT FOR AMBIENT CONDITIONS


Temperature Deration	
Altitude Deration (15, 30, 48 & 50 kW)	.1% for every 100 m above 915 m or 3% for every 1000 ft above 3000 ft
Altitude Deration (20 kW)	1% for every 100 m above 305 m or 3% for every 1000 ft above 1000 ft

CONTROLLER FEATURES

2-Line Plain Text Multilingual LCD Display	
Mode Buttons: Auto	Automatic Start on Utility failure, Programmable 7 day exerciser
Manual	Start with starter control unit stays on If utility fails transfer to load takes place
Ready to Run/Maintenance Messages	Standard
Engine Run Hours Indication	Stops unit. Power is removed. Control and charger still operate. Standard Standard Standard (programmable by dealer only) From 140-171 V/190-216 V Standard
Programmable start delay between 2-1500 seconds	Standard (programmable by dealer only)
Utility Voltage Loss/Return to Utility Adjustable	From 140–171 V/190–216 V
Future Set Capable Exerciser/Exercise Set Error Warning	Standard
Run/Alarm/Maintenance Logs	
Engine Start Sequence	
Starter Lock-out	Starter cannot re-engage until 5 sec after engine has stopped.
Smart Battery Charger	Starter cannot re-engage until 5 sec after engine has stopped. Standard Standard
Charger Fault/Missing AC Warning	Standard
Low Battery/Battery Problem Protection and Battery Condition Indication	Standard Standard Standard Standard Standard Standard Standard
Automatic Voltage Regulation with Over and Under Voltage Protection	Standard
Under-Frequency/Overload/Stepper Overcurrent Protection	Standard
Safety Fused/Fuse Problem Protection	Standard
Automatic Low Oil Pressure/High Oil Temperature Shutdown	Standard
Overcrank/Overspeed (@ 72 Hz)/RPM Sense Loss Shutdown	Standard
High Engine Temperature Shutdown	
Internal Fault/Incorrect Wiring Protection	Standard
Common External Fault Capability	
Field Upgradable Firmware	Standard Standard


6 of 12

Drawing #0K7025-C (1 of 2)

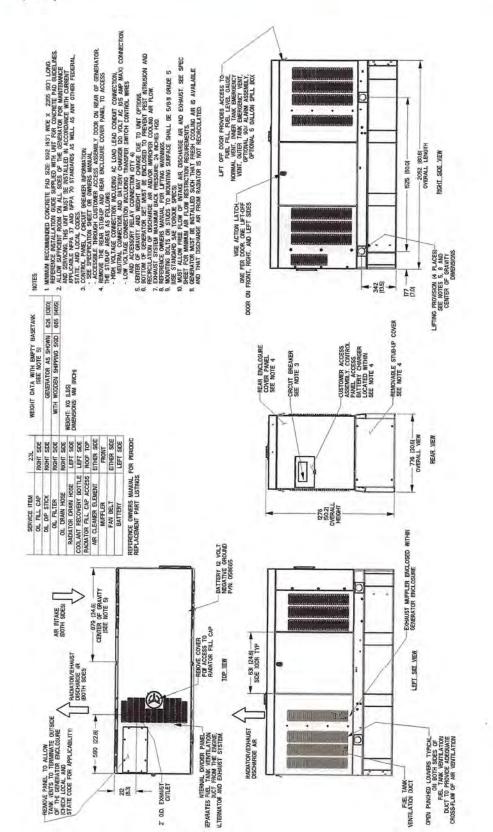

installation layout


Drawing #0K7025-C (2 of 2)

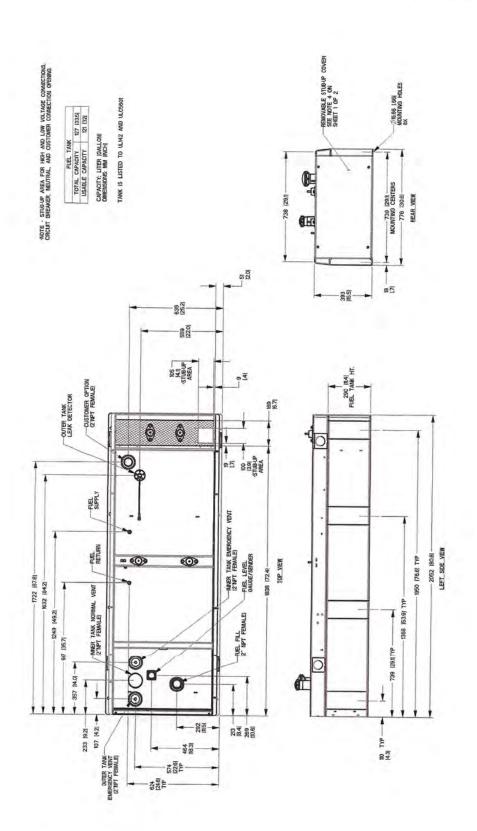

7 of 12


8 of 12

Drawing #0K7002-C (1 of 2)

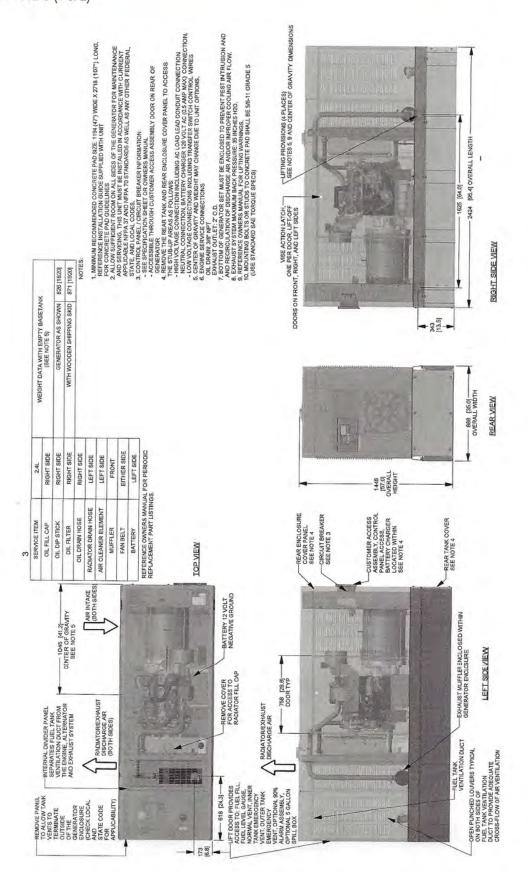

installation layout


Drawing #0K7002-B (2 of 2)

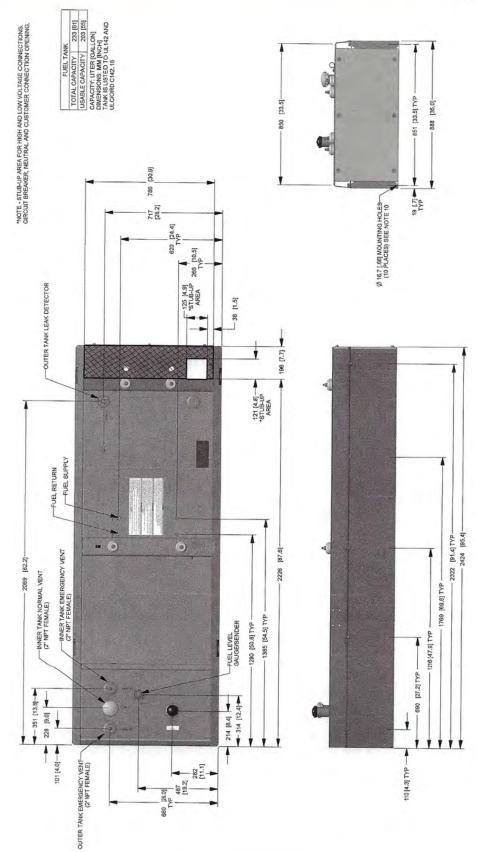

9 of 12


10 of 12

Drawing #0K6968-C (1 of 2)

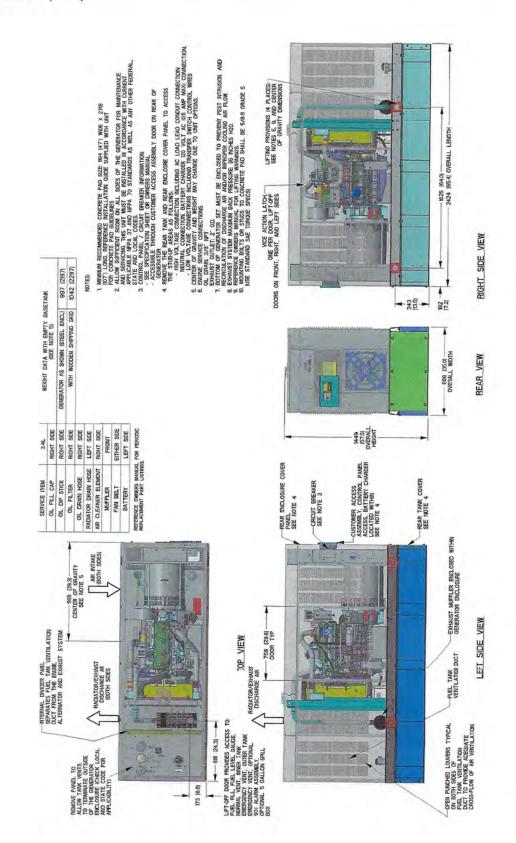

installation layout

Drawing #0K6968-A (2 of 2)

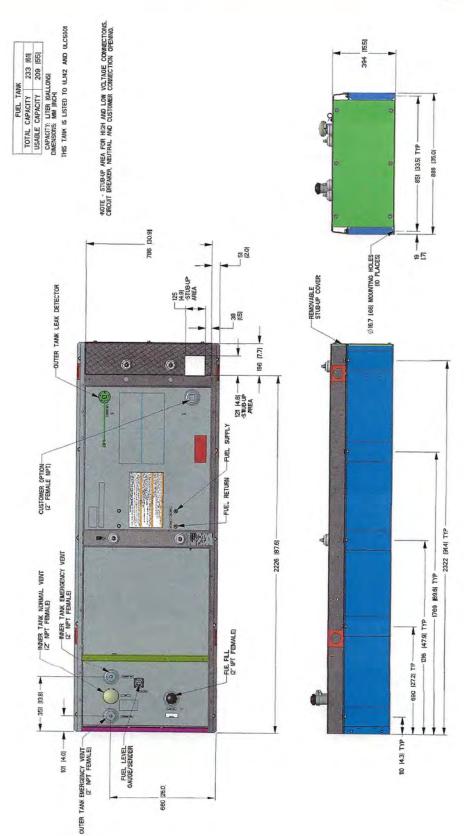

11 of 12

12 of 12

GENERAC


available accessories

15 · 20 · 30 · 48 · 50 kW

Model #	Product	Description	
G006463-4	Mobile Línk™	Generac's Mobile Link allows you to check the status of your generator from anywhere that you have access to an Internet connection from a PC or with any smart device. You will even be notified when a change in the generator's status occurs via e-mail or text message. Note: Harness Adapter Kit required. Available in the U.S. only.	
G006478-0	Harness Adapter Kit	The Harness Adapter Kit is required to make liquid-cooled units compatible with Mobile Link™.	
G006502-0	Spill Box	The 5-gallon spill box screws into the existing fuel fill port of the base tank. It captures and contains fuel if over fueling or spilling occurs during the fill process.	
G006504-0	90% Fuel Level Alarm	The 90% fuel level alarm alerts the fuel fill operator when the tank reaches a 90% fill level by sounding an audible alarm and triggering an LED warning light.	
G006505-0 - 15 & 20 kW G006506-0 - 30, 48 & 50 kW	Tank Risers	Tank risers are required in some municipalities to help avoid potential base tank corrosion caused by mounting on rough surfaces.	
G006507-0	Fuel Fill Drop Tube	A powder coat painted, steel fuel fill drop tube is required in some municipalities to prosparking due to static electricity buildup, which can be caused by the fuel dropping into tank from the fill area. Using a drop tube also results in submerged filling, which increase the fuel delivery flow rate and reduces vapors, foam and potential tank evaporation.	
G006513-0 - 15 & 20 kW G006517-0 - 30 kW G006516-0 - 48 & 50 kW	Stainless Steel Fuel Lines	Some municipalities require the use of stainless steel fuel lines instead of the standard hoses provided with the diesel generator products. These stainless steel lines are fire resistant for additional safety.	
G006510-0	E-Stop	E-stop allows for immediate fuel shutoff and generator shutdown in the event of an emergency.	
006511-0	Spill Box Drainback Kit	The spill box drainback kit allows fuel that was captured in the 5-gallon spill box to be drained directly back into the fuel tank to avoid vapors.	
G006588-1	Vent Extension Support Kit	The vent extension support kit consists of two aluminum plates with the appropriate pipe cutouts to secure the vent extension pipes coming through the top of the generat enclosure. It helps to minimize stress on the NPT fittings integrated on the tank and all helps protect against pests.	
G006512-0	Lockable Fuel Cap	The cast iron, lockable fuel cap provides the ability to lock the fuel system to prevent unwanted fuel tampering or fuel siphoning.	
G006572-0 - 15 & 20 kW G006571-0 - 30 kW G006570-0 - 48 & 50 kW	Maintenance Kits	The Protector Maintenance Kits offer all the hardware necessary to perform complete maintenance on Generac Protector generators.	
G006560-0 - 15 & 20 kW G006559-0 - 30 kW G006558-0 - 48 & 50 kW	Cold Weather Kits	Recommended for generators installed in regions where the temperature regularly falls below 32 °F (0 °C). The Cold Weather Kits consist of a block heater with all necessary mounting hardware and a battery warmer with a thermostat built into the battery wrap.	
G005704-0	Paint Kit	If the generator enclosure is scratched or damaged, it is important to touch-up the paint to protect from future corrosion. The paint kit includes the necessary paint to properly maintain or touch-up a generator enclosure.	
G006664-0	Local Wireless Remote	Completely wireless and battery powered, Generac's wireless remote monitor provides you with instant status information without ever leaving the house.	
G006665-0	Wireless Remote Extension Harness	Recommended for use with the Wireless Remote on units up to 60 kW, required for use on units 70 kW or greater.	
G006873-0	Smart Management Module (50 Amps)	Manage large loads by utilizing up to 8 individual Smart Management modules. These devices are installed directly in line with existing appliance wiring for easy installation.	



Exhibit E

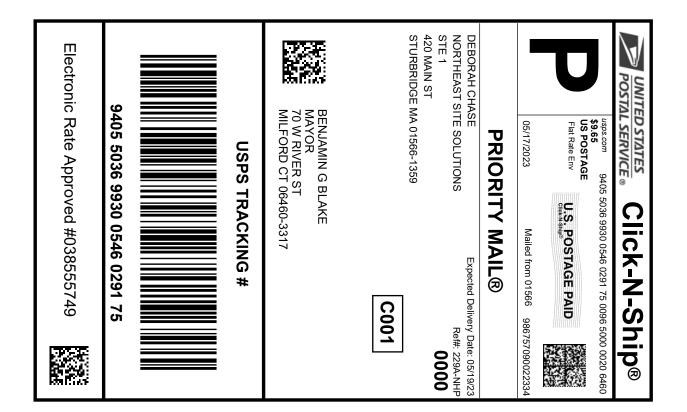



Instructions

- 1. Each Click-N-Ship® label is unique. Labels are to be used as printed and used only once. DO NOT PHOTO **COPY OR ALTER LABEL.**
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- 3. Adhere your label to the package. A self-adhesive label is recommended. If tape or glue is used, DO NOT TAPE OVER BARCODE. Be sure all edges are secure.
- 4. To mail your package with PC Postage®, you may schedule a Package Pickup online, hand to your letter carrier, take to a Post Office™, or drop in a USPS collection box.
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Click-N-Ship® Label Record

USPS TRACKING #: 9405 5036 9930 0546 0291 75

Trans. #: 588534603 Print Date: 05/17/2023 05/17/2023 05/19/2023 Delivery Date:

Priority Mail® Postage: Total:

\$9.65 \$9.65

Ref#: 229A-NHP

From: **DEBORAH CHASE**

NORTHEAST SITE SOLUTIONS

STE 1

420 MAIN ST


STURBRIDGE MA 01566-1359

BENJAMIN G BLAKE

MAYOR

70 W RIVER ST

MILFORD CT 06460-3317

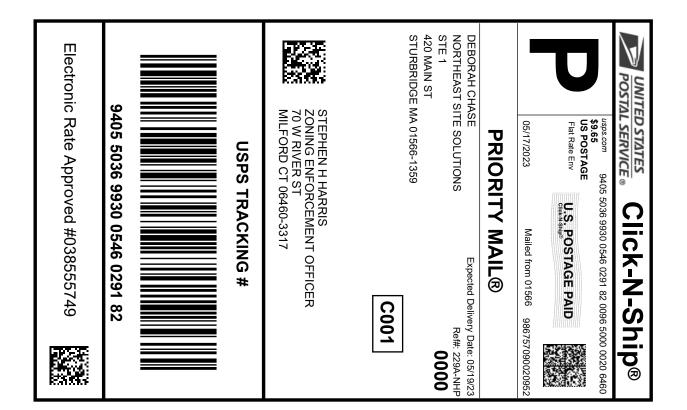



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Click-N-Ship® Label Record

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Trans. #: 588534603 Print Date: 05/17/2023 05/17/2023 05/19/2023 Delivery Date:

From:

Priority Mail® Postage: \$9.65 Total: \$9.65

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NORTHEAST SITE SOLUTIONS

STE 1

420 MAIN ST

DEBORAH CHASE


STURBRIDGE MA 01566-1359

STEPHEN H HARRIS

ZONING ENFORCEMENT OFFICER

70 W RIVER ST

MILFORD CT 06460-3317

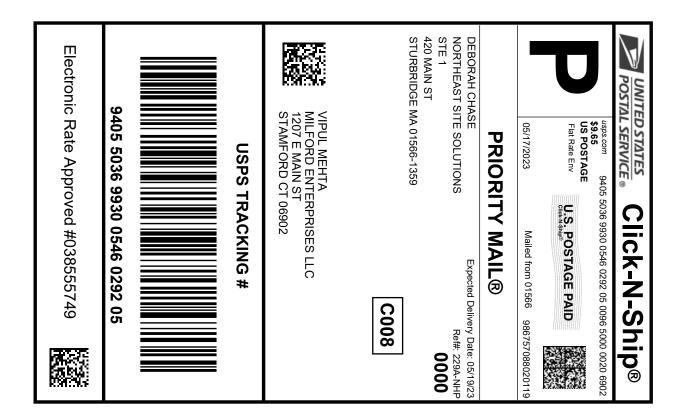



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Click-N-Ship® Label Record

USPS TRACKING #: 9405 5036 9930 0546 0292 05

Trans. #: 588534603 Print Date: 05/17/2023 05/17/2023 05/19/2023 Delivery Date:

Priority Mail® Postage: \$9.65 Total: \$9.65

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From: **DEBORAH CHASE**

NORTHEAST SITE SOLUTIONS

STE 1


420 MAIN ST

STURBRIDGE MA 01566-1359

VIPUL MEHTA

MILFORD ENTERPRISES LLC

1207 E MAIN ST STAMFORD CT 06902

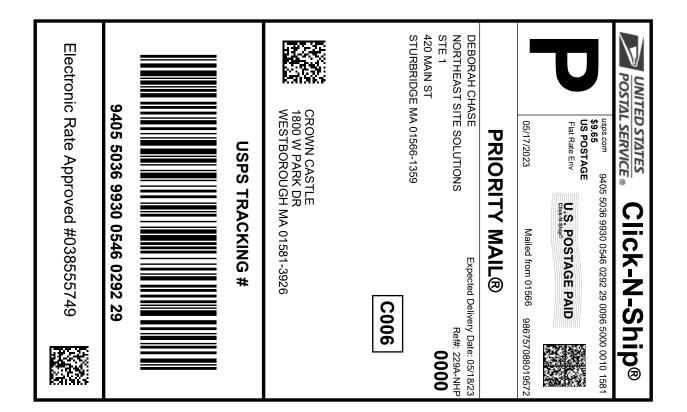



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Click-N-Ship® Label Record

USPS TRACKING #: 9405 5036 9930 0546 0292 29

Trans. #: 588534603 Print Date: 05/17/2023 05/17/2023 Delivery Date: 05/18/2023 Priority Mail® Postage: Total:

\$9.65 \$9.65

Ref#: 229A-NHP

From: **DEBORAH CHASE**

NORTHEAST SITE SOLUTIONS

STE 1

420 MAIN ST

STURBRIDGE MA 01566-1359

CROWN CASTLE

1800 W PARK DR

WESTBOROUGH MA 01581-3926



FISKDALE 458 MAIN ST FISKDALE, MA 01518-9998 (800)275-8777 05/17/2023

12:46 PM

Qty Product Unit Price Price Prepaid Mail \$0.00 Westborough, MA 01581 Weight: 0 1b 2.00 oz Acceptance Date: Wed 05/17/2023 Tracking #: 9405 5036 9930 0546 0292 29

Prepaid Mail \$0.00 Stamford, CT 06902 Weight: 0 1b 8.40 oz Acceptance Date: Wed 05/17/2023 Tracking #: 9405 5036 9930 0546 0292 05

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Grand Total: \$0.00

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