



ATC SITE NAME: MADISON CT ATC SITE NUMBER: 283421

VERIZON SITE NAME: MADISON 5 CT

VERIZON SITE NUMBER:467699

SITE ADDRESS: 15 ORCHARD PARK ROAD

MADISON, CT 06443-2268



LOCATION MAP

VERIZON UPGRADE-RRH ANTENNA AMENDMENT DRAWINGS

COMPLIANCE CODE	PROJECT S	UMMARY	PROJECT DESCRIPTION	SHEET INDEX					
ALL WORK SHALL BE PERFORMED AND MATERIALS INSTALLED IN ACCORDANCE WITH THE CURRENT EDITIONS OF THE FOLLOWING CODES AS ADOPTED BY THE LOCAL	SITE ADD		THE PROPOSED PROJECT INCLUDES MODIFYING GROUND BASED AND TOWER MOUNTED EQUIPMENT AS INDICATED PER BELOW:	SHEET NO:	DESCRIPTION:	REV:	DATE:	BY:	
GOVERNMENT AUTHORITIES. NOTHING IN THESE PLANS IS TO BE CONSTRUED TO PERMIT WORK NOT CONFORMING TO	15 ORCHARD F	7.1.1.1.107.12	TOWER WORK:	G-001	TITLE SHEET	1	01/09/24	VL	
THESE CODES.	MADISON, CT		REMOVE (12) ANTENNA(s), (9) RRU(s) AND (2) OVP(s)	G-002	GENERAL NOTES	1	01/09/24	VL	
2022 CONNECTICUT STATE BUILDING CODE-AMENDMENTS	COUNTY: NE		INSTALL MOUNT MODIFICATION(s), (3) SBS MOUNT(s), (12)	C-101	DETAILED SITE PLAN	1	01/09/24	VL	1
TO IBC 2021 2. INTERNATIONAL BUILDING CODE 2015. INTERNATIONAL	GEOGRAPHIC CO	OORDINATES:	ANTENNA(s), (6) RRU(s), (1) OVP(s) AND (2) FIBER CABLE(s)	C-201	TOWER ELEVATION	1	01/09/24	VL	٠,
CODE COUNCIL	LATITUDE: 41					'			7
3. TIA-222-G-4, STRUCTURAL STANDARD FOR ANTENNA	LONGITUDE: -			C-401	ANTENNA INFORMATION & SCHEDULE	1	01/09/24	VL	-
SUPPORTING STRUCTURES AND ANTENNAS 4. ASCE 7-10 MINIMUM DESIGN LOADS FOR BUILDINGS AND	GROUND ELEVAT	ION: 20' AMSL		C-501	CONSTRUCTION DETAILS	1	01/09/24	VL	
OTHER STRUCTURES, AMERICAN SOCIETY OF CIVIL				E-501	GROUNDING DETAILS	1	01/09/24	VL	
ENGINEERS 5. STEEL CONSTRUCTION MANUAL 14TH EDITION, AMERICAN				R-601	SUPPLEMENTAL				1
INSTITUTE OF STEEL CONSTRUCTION			PROJECT NOTES	R-602	SUPPLEMENTAL				1
6. CITY/COUNTY ORDINANCES	PROJEC1	TTEAM	THE FACILITY IS UNMANNED. A TECHNICIAN WILL VISIT THE SITE APPROXIMATELY ONCE A	R-603	SUPPLEMENTAL				1
	TOWER OWNER:	APPLICANT:	MONTH FOR ROUTINE INSPECTION AND MAINTENANCE. 3. THE PROJECT WILL NOT RESULT IN ANY SIGNIFICANT LAND		MOUNT MOD DRAWINGS (11 PAGES)				1
	AMERICAN TOWER 10 PRESIDENTIAL WAY	VERIZON WIRELESS 51 ALDER STREET	DISTURBANCE OR EFFECT OF STORM WATER DRAINAGE. 4. NO SANITARY SEWER, POTABLE WATER OR TRASH DISPOSAL IS REQUIRED.						
UTILITY COMPANIES	WOBURN, MA 01801 ENGINEER:	MEDWAY, MA 02053	HANDICAP ACCESS IS NOT REQUIRED. THE PROJECT DEPICTED IN THESE PLANS QUALIFIES AS AN ELIGIBLE FACILITIES REQUEST ENTITLED TO EXPEDITED.						1
POWER COMPANY: EVERSOURCE PHONE: (877) 659-6326	DEWBERRY ENGINEERS, INC.		REVIEW UNDER 47 U.S.C. § 1455(A) AS A MODIFICATION OF AN EXISTING WIRELESS TOWER THAT INVOLVES THE COLLOCATION. REMOVAL. AND/OR REPLACEMENT OF						1
TELEPHONE COMPANY: FRONTIER COMMUNICATIONS PHONE: (877) 641-3250	SUITE 700 BOSTON, MA 02110		TRANSMISSION EQUIPMENT THAT IS NOT A SUBSTANTIAL CHANGE UNDER CFR § 1.61000 (B)(7).						+
Know what's below. Call before you dig.	PROPERTY OWNER: 15 ORCHARD PARK ROAD LLC 15 ORCHARD PARK ROAD - MADISON - CT - 06443		PROJECT LOCATION DIRECTIONS FROM DOWNTOWN NEW HAVEN CT START OUT GOING NORTHEAST ON CHURCH ST TOWARD WALL ST. CHURCH ST BECOMES WHITNEY AVE. TURN RIGHT ONTO TRUMBULL ST. TURN SLIGHT LEFT TO TAKE THE I-91 S/I-91 N RAMP. MERGE ONTO I-91 S TOWARD I-95/NEW LONDON/N.Y.CITY. MERGE ONTO I-95 N/GOVERNOR JOHN DAVIS LODGE TPKE N VIA THE EXIT ON THE LEFT TOWARD NEW LONDON. TAKE THE GOOSE LANE EXIT, EXIT 59. TURN RIGHT ONTO GOOSE LN. TAKE THE 1ST LEFT ONTO BOSTON POST RD/US-1 N. TURN LEFT ONTO MUNGERTOWN RD. TAKE THE 2ND RIGHT ONTO ORCHARD						



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Dewberry Engineers Inc. 99 SUMMER STREET SUITE 700 BOSTON, MA 02110 PHONE: 617.531.0801 FAX: 617.695.3310

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verizon /

DATE DRAWN:	06/17/21
ATC JOB NO:	13684191
CUSTOMER ID:	MADISON 5 CT
CUSTOMER #:	467699

TITLE SHEET

REVISION: G-001

GENERAL CONSTRUCTION NOTES:

- OWNER FURNISHED MATERIALS, VERIZON "THE COMPANY" WILL PROVIDE AND THE CONTRACTOR WILL INSTALL
- BTS EQUIPMENT FRAME (PLATFORM) AND ICEBRIDGE SHELTER (GROUND
- BUILD/CO-LOCATE ONLY) AC/TELCO INTERFACE BOX (PPC)
- C. ICE BRIDGE (CABLE TRAY WITH COVER) (GROUND BUILD/CO-LOCATE ONLY, GC TO FURNISH AND INSTALL FOR ROOFTOP INSTALLATION)
- D. TOWERS, MONOPOLES
- TOWER LIGHTING
- GENERATORS & LIQUID PROPANE TANK
- ANTENNA STANDARD BRACKETS, FRAMES AND PIPES FOR MOUNTING
- ANTENNAS (INSTALLED BY OTHERS)
- TRANSMISSION LINE
- TRANSMISSION LINE JUMPERS
- TRANSMISSION LINE CONNECTORS WITH WEATHERPROOFING KITS
- TRANSMISSION LINE GROUND KITS
- HANGERS
- HOISTING GRIPS
- O. BTS EQUIPMENT
- THE CONTRACTOR IS RESPONSIBLE TO PROVIDE ALL OTHER MATERIALS FOR THE COMPLETE INSTALLATION OF THE SITE INCLUDING, BUT NOT LIMITED TO, SUCH MATERIALS AS FENCING, STRUCTURAL STEEL SUPPORTING SUB-FRAME FOR PLATFORM, ROOFING LABOR AND MATERIALS GROUNDING RINGS GROUNDING WIRES COPPER-CLAD OR XIT CHEMICAL GROUND ROD(S), BUSS BARS, TRANSFORMERS AND DISCONNECT SWITCHES WHERE APPLICABLE, TEMPORARY ELECTRICAL POWER, CONDUIT LANDSCAPING COMPOUND STONE, CRANES, CORE DRILLING, SLEEPERS AND RUBBER MATTING, REBAR, CONCRETE CAISSONS, PADS AND/OR AUGER MOUNTS, MISCELLANEOUS FASTENERS, CABLE TRAYS, NON-STANDARD ANTENNA FRAMES AND ALL OTHER MATERIAL AND LABOR REQUIRED TO COMPLETE THE JOB ACCORDING TO THE DRAWINGS AND SPECIFICATIONS. IT IS THE POSITION OF VERIZON TO APPLY FOR PERMITTING AND CONTRACTOR RESPONSIBLE FOR PICKUP AND PAYMENT OF REQUIRED
- ALL WORK SHALL CONFORM TO ALL CURRENT APPLICABLE FEDERAL, STATE, AND LOCAL CODES, INCLUDING ANSI/EIA/TIA-222, AND COMPLY WITH ATC CONSTRUCTION
- CONTRACTOR SHALL CONTACT LOCAL 811 FOR IDENTIFICATION OF UNDERGROUND UTILITIES PRIOR TO START OF CONSTRUCTION.
- CONTRACTOR SHALL BE RESPONSIBLE FOR COORDINATING ALL REQUIRED
- ALL DIMENSIONS TO, OF, AND ON EXISTING BUILDINGS, DRAINAGE STRUCTURES, AND SITE IMPROVEMENTS SHALL BE VERIFIED IN FIELD BY CONTRACTOR WITH ALL DISCREPANCIES REPORTED TO THE ENGINEER.
- DO NOT CHANGE SIZE OR SPACING OF STRUCTURAL ELEMENTS
- DETAILS SHOWN ARE TYPICAL: SIMILAR DETAILS APPLY TO SIMILAR CONDITIONS UNLESS
- THESE DRAWINGS DO NOT INCLUDE NECESSARY COMPONENTS FOR CONSTRUCTION SAFETY WHICH SHALL BE THE SOLE RESPONSIBILITY OF THE CONTRACTOR
- CONTRACTOR SHALL BRACE STRUCTURES UNTIL ALL STRUCTURAL ELEMENTS NEEDED FOR STABILITY ARE INSTALLED. THESE ELEMENTS ARE AS FOLLOWS: LATERAL BRACING,
- CONTRACTOR SHALL DETERMINE EXACT LOCATION OF EXISTING UTILITIES. GROUNDS DRAINS, DRAIN PIPES, VENTS, ETC, BEFORE COMMENCING WORK
- INCORRECTLY FABRICATED, DAMAGED, OR OTHERWISE MISFITTING OR NONCONFORMING MATERIALS OR CONDITIONS SHALL BE REPORTED TO THE VERIZON REP PRIOR TO REMEDIAL OR CORRECTIVE ACTION, ANY SUCH REMEDIAL ACTION SHALL REQUIRE WRITTEN APPROVAL BY THE VERIZON REP PRIOR TO PROCEEDING.
- EACH CONTRACTOR SHALL COOPERATE WITH THE VERIZON REP, AND COORDINATE HIS WORK WITH THE WORK OF OTHERS.
- CONTRACTOR SHALL REPAIR ANY DAMAGE CAUSED BY CONSTRUCTION OF THIS PROJECT TO MATCH EXISTING PRE-CONSTRUCTION CONDITIONS TO THE SATISFACTION
- ALL CABLE/CONDUIT ENTRY/EXIT PORTS SHALL BE WEATHERPROOFED DURING INSTALLATION LISING A SILICONE SEALANT
- WHERE EXISTING CONDITIONS DO NOT MATCH THOSE SHOWN IN THIS PLAN SET. CONTRACTOR SHALL NOTIFY THE VERIZON REP AND ENGINEER OF RECORD
- CONTRACTOR SHALL ENSURE ALL SUBCONTRACTORS ARE PROVIDED WITH A COMPLETE AND CURRENT SET OF DRAWINGS AND SPECIFICATIONS FOR THIS PROJECT.
- CONTRACTOR SHALL REMOVE ALL RUBBISH AND DEBRIS FROM THE SITE AT THE END OF
- CONTRACTOR SHALL COORDINATE WORK SCHEDULE WITH AMERICAN TOWER CORPORATION (ATC) AND TAKE PRECAUTIONS TO MINIMIZE IMPACT AND DISRUPTION OF OTHER OCCUPANTS OF THE FACILITY.
- CONTRACTOR SHALL FURNISH VERIZON AND AMERICAN TOWER CORPORATION (ATC) /ITH A PDF MARKED UP AS-BUILT SET OF DRAWINGS UPON COMPLETION OF WORK
- PRIOR TO SUBMISSION OF BID, CONTRACTOR SHALL COORDINATE WITH VERIZON REP TO DETERMINE WHAT, IF ANY, ITEMS WILL BE PROVIDED. ALL ITEMS NOT PROVIDED SHALL BE PROVIDED AND INSTALLED BY THE CONTRACTOR. CONTRACTOR WILL INSTALL

- 22. PRIOR TO SUBMISSION OF BID. CONTRACTOR SHALL COORDINATE WITH VERIZON REP TO DETERMINE IF ANY PERMITS WILL BE OBTAINED BY CONTRACTOR. ALL REQUIRED PERMITS NOT OBTAINED BY VERIZON MUST BE OBTAINED, AND PAID FOR, BY THE
- 23. CONTRACTOR SHALL INSTALL ALL SITE SIGNAGE IN ACCORDANCE WITH VERIZON SPECIFICATIONS AND REQUIREMENTS.
- 24. CONTRACTOR SHALL SUBMIT ALL SHOP DRAWINGS TO VERIZON FOR REVIEW AND
- ALL EQUIPMENT SHALL BE INSTALLED ACCORDING TO MANUFACTURER'S SPECIFICATIONS AND LOCATED ACCORDING TO VERIZON SPECIFICATIONS, AND AS SHOWN IN THESE PLANS
- 26. THE CONTRACTOR SHALL SUPERVISE AND DIRECT THE PROJECT DESCRIBED HEREIN THE CONTRACTOR SHALL BE SOLELY RESPONSIBLE FOR ALL THE CONSTRUCTION MEANS, METHODS, TECHNIQUES, SEQUENCES AND PROCEDURES AND FOR COORDINATING ALL PORTIONS OF THE WORK UNDER THE CONTRACT.
- CONTRACTOR SHALL NOTIFY VERIZON REP A MINIMUM OF 48 HOURS IN ADVANCE OF POURING CONCRETE OR BACKFILLING ANY UNDERGROUND UTILITIES, FOUNDATIONS OR SEALING ANY WALL, FLOOR OR ROOF PENETRATIONS FOR ENGINEERING REVIEW AND
- CONTRACTOR SHALL BE RESPONSIBLE FOR SITE SAFETY INCLUDING COMPLIANCE WITH ALL APPLICABLE OSHA STANDARDS AND RECOMMENDATIONS AND SHALL PROVIDE ALL NECESSARY SAFETY DEVICES INCLUDING PPE AND PPM AND CONSTRUCTION DEVICES SUCH AS WELDING AND FIRE PREVENTION, TEMPORARY SHORING, SCAFFOLDING, TRENCH BOXES/SLOPING, BARRIERS, ETC.
- THE CONTRACTOR SHALL PROTECT AT HIS OWN EXPENSE, ALL EXISTING FACILITIES AND SPECIAL CONSTRUCTION SUCH OF HIS NEW WORK LIABLE TO INJURY DURING THE CONSTRUCTION PERIOD. ANY DAMAGE CAUSED BY NEGLECT ON THE PART OF THIS CONTRACTOR OR HIS REPRESENTATIVES, OR BY THE ELEMENTS DUE TO NEGLECT ON THE PART OF THIS CONTRACTOR OR HIS REPRESENTATIVES, EITHER TO THE EXISTING WORK, OR TO HIS WORK OF ANY OTHER CONTRACTOR, SHALL BE REPAIRED AT HIS EXPENSE TO THE OWNER'S SATISFACTION.
- ALL WORK SHALL BE INSTALLED IN A FIRST CLASS, NEAT AND WORKMANLIKE MANNER BY MECHANICS SKILLED IN THE TRADE INVOLVED. THE QUALITY OF WORKMANSHIP SHALL BE SUBJECT TO THE APPROVAL OF THE VERIZON REP. ANY WORK FOUND BY THE VERIZON REP TO BE OF INFERIOR QUALITY AND/OR WORKMANSHIP SHALL BE REPLACED AND/OR REWORKED AT CONTRACTOR EXPENSE UNTIL APPROVAL IS
- 31. IN ORDER TO ESTABLISH STANDARDS OF QUALITY AND PERFORMANCE, ALL TYPES OF MATERIALS LISTED HEREINAFTER BY MANUFACTURER'S NAMES AND/OR
 MANUFACTURER'S CATALOG NUMBER SHALL BE PROVIDED BY THESE MANUFACTURERS AS SPECIFIED.
- VERIZON FURNISHED EQUIPMENT SHALL BE PICKED-UP AT THE VERIZON WAREHOUSE AND INSTALLED BY THE CONTRACTOR WITH ALL APPURTENANCES REQUIRED TO PLACE THE EQUIPMENT IN OPERATION, READY FOR USE. THE CONTRACTOR SHALL BE RESPONSIBLE FOR THE EQUIPMENT AFTER PICKING IT UP.
- VERIZON OR HIS ARCHITECT/ENGINEER RESERVES THE RIGHT TO REJECT ANY FOLIPMENT OR MATERIALS WHICH IN HIS OWN OPINION ARE NOT IN COMPLIANCE WITH THE CONTRACT DOCUMENTS, EITHER BEFORE OR AFTER INSTALLATION AND THE EQUIPMENT SHALL BE REPLACED WITH EQUIPMENT CONFORMING TO THE REQUIREMENTS OF THE CONTRACT DOCUMENTS BY THE CONTRACTOR AT NO COST TO VERIZON OR THEIR ARCHITECT/ENGINEER

STRUCTURAL STEEL NOTES:

- STRUCTURAL STEEL SHALL CONFORM TO THE LATEST EDITION OF THE AISC "SPECIFICATION FOR THE DESIGN, FABRICATION AND ERECTION OF STRUCTURAL STEEL
- STRUCTURAL STEEL ROLLED SHAPES, PLATES AND BARS SHALL CONFORM TO THE FOLLOWING ASTM DESIGNATIONS:
 - A. ASTM A-572, GRADE 50 ALL W SHAPES, UNLESS NOTED OR A992 OTHERWISE
 - B. ASTM A-36 ALL OTHER ROLLED SHAPES, PLATES AND BARS UNLESS NOTED
 - C. ASTM A-500, GRADE B HSS SECTION (SQUARE, RECTANGULAR, AND ROUND)
 - D. ASTM A-325, TYPE SC OR N ALL BOLTS FOR CONNECTING STRUCTURAL
 - E. ASTM F-1554 07 ALL ANCHOR BOLTS, UNLESS NOTED OTHERWISE
- ALL EXPOSED STRUCTURAL STEEL MEMBERS SHALL BE HOT-DIPPED GALVANIZED AFTER FABRICATION PER ASTM A123. EXPOSED STEEL HARDWARE AND ANCHOR BOLTS SHALL BE GALVANIZED PER ASTM A153 OR B695
- ALL FIELD CUT SURFACES, FIELD DRILLED HOLES AND GROUND SURFACES WHERE EXISTING PAINT OR GALVANIZATION REMOVAL WAS REQUIRED SHALL BE REPAIRED WITH (2) BRUSHED COATS OF ZRC GALVILITE COLD GALVANIZING COMPOUND PER ASTM A780 AND MANUFACTURER'S RECOMMENDATIONS
- DO NOT DRILL HOLES THROUGH STRUCTURAL STEEL MEMBERS EXCEPT AS SHOWN AND DETAILED ON STRUCTURAL DRAWINGS.
- CONNECTIONS:
 - A. ALL WELDING TO BE PERFORMED BY AWS CERTIFIED WELDERS AND CONDUCTED IN ACCORDANCE WITH THE LATEST EDITION OF THE AWS WELDING CODE D1.1.

- ALL WELDS SHALL BE INSPECTED VISUALLY. 25% OF WELDS SHALL BE INSPECTED WITH DYE PENETRANT OR MAGNETIC PARTICLE TO MEET THE ACCEPTANCE CRITERIA OF AWS D1 1 REPAIR ALL WELDS AS NECESSARY
- C. INSPECTION SHALL BE PERFORMED BY AN AWS CERTIFIED WELD INSPECTOR.
- D. IT IS THE CONTRACTORS RESPONSIBILITY TO PROVIDE BURNING/WELDING PERMITS AS REQUIRED BY LOCAL GOVERNING AUTHORITY AND IF REQUIRED SHALL HAVE FIRE DEPARTMENT DETAIL FOR ANY WELDING ACTIVITY
- E. ALL ELECTRODES TO BE LOW HYDROGEN, MATCHING FILLER METAL, PER AWS
- F. MINIMUM WELD SIZE TO BE 0.1875 INCH FILLET WELDS, UNLESS NOTED
- G PRIOR TO FIELD WELDING GALVANIZING MATERIAL CONTRACTOR SHALL GRIND OFF GALVANIZING ½" BEYOND ALL FIELD WELD SURFACES. AFTER WELD AND WELD INSPECTION IS COMPLETE, REPAIR ALL GROUND AND WELDED SURFACES WITH ZRC GALVILITE COLD GALVANIZING COMPOUND PER ASTM A780 AND MANUFACTURERS RECOMMENDATIONS.
- THE CONTRACTOR SHALL PROVIDE ADEQUATE SHORING AND/OR BRACING WHERE REQUIRED DURING CONSTRUCTION UNTIL ALL CONNECTIONS ARE
- ANY FIELD CHANGES OR SUBSTITUTIONS SHALL HAVE PRIOR APPROVAL FROM THE ENGINEER, AND T- MOBILE PROJECT MANAGER IN WRITING

ANTENNA INSTALLATION NOTES:

- WORK INCLUDED:
 - ANTENNA AND COAXIAL CABLES ARE FURNISHED BY VERIZON UNDER A SEPARATE CONTRACT. THE CONTRACTOR SHALL ASSIST ANTENNA INSTALLATION CONTRACTOR IN TERMS OD COORDINATION AND SITE ACCESS. ERECTION SUBCONTRACTOR SHALL BE RESPONSIBLE FOR THE PROTECTION OF
 - B. INSTALL ANTENNA AS INDICATE ON DRAWINGS AND VERIZON SPECIFICATIONS.
 - C. INSTALL GALVANIZED STEEL ANTENNA MOUNTS AS INDICATED ON DRAWINGS
 - D. INSTALL FURNISHED GALVANIZED STEEL OR ALUMINUM WAVEGUIDE AND PROVIDE PRINTOUT OF THAT TEST
 - F CONTRACTOR SHALL PROVIDE FOLIR (4) SETS OF SWEEP TESTS LISING ANRITZU-PACKARD 8713B RF SCALAR NETWORK ANALYZER. SUBMIT FREQUENCY DOMAIN REFLECTOMETER(FDR) TESTS RESULTS TO THE PROJECT MANAGER. SWEEP TESTS SHALL BE AS PER ATTACHED RES "MINIMUM FIELD TESTING RECOMMENDED FOR ANTENNA AND HELIAX COAXIAL CABLE SYSTEMS" DATED 10/5/93, TESTING SHALL BE PERFORMED BY AN INDEPENDENT TESTING SERVICE AND BE BOUND AND SUBMITTED WITHIN ONE WEEK OF WORK COMPLETION.
 - INSTALL COAXIAL CABLES AND TERMINATING BETWEEN ANTENNAS AND EQUIPMENT PER MANUFACTURER'S RECOMMENDATIONS. WEATHERPROOF ALL CONNECTIONS BETWEEN THE ANTENNA AND EQUIPMENT PER MANUFACTURER'S REQUIREMENTS. TERMINATE ALL COAXIAL CABLE THREE (3) FEET IN EXCESS OF ENTRY PORT LOCATION UNLESS OTHERWISE STATED.
 - G. ANTENNA AND COAXIAL CABLE GROUNDING:
- ALL EXTERIOR #6 GREED GROUND WIRE "DAISY CHAIN" CONNECTIONS ARE TO BE WEATHER SEALED WITH RFS CONNECTORS/SPLICE WEATHERPROOFING KIT #221213 OR
- ALL COAXIAL CABLE GROUNDING KITS ARE TO BE INSTALLED ON STRAIGHT RUNS OF COAXIAL CABLE (NOT WITHIN BENDS)

ALL DISCREPANCIES FROM WHAT IS SHOWN ON THESE CONSTRUCTION DRAWINGS SHALL BE COMMUNICATED TO ATC ENGINEERING IMMEDIATELY FOR CORRECTION OR RE-DESIGN. FAILURE TO COMMUNICATE DIRECTLY WITH ATC ENGINEERING OR ANY CHANGES FROM THE DESIGN CONDUCTED WITHOUT PRIOR APPROVAL FROM ATC ENGINEERING SHALL BE THE SOLE RESPONSIBILITY OF THE GENERAL CONTRACTOR.





Dewberry Engineers Inc. 99 SUMMER STREET SUITE 700 BOSTON, MA 02110 PHONE: 617.531.0801 FAX: 617.695.3310

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<u>^</u>	FINAL	SL	03/14/23
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ATC SITE NUMBER: 283421

ATC SITE NAME: MADISON CT

VERIZON SITE NAME:

MADISON 5 CT

SITE ADDRESS: 15 ORCHARD PARK ROAD MADISON, CT 06443-2268

DATE DRAWN: 06/17/21 ATC JOB NO: 13684191 CUSTOMER ID: MADISON 5 CT CUSTOMER #: 467699

GENERAL NOTES

SHEET NUMBER:

G-002

REVISION


SITE PLAN NOTES:

- THIS SITE PLAN REPRESENTS THE BEST PRESENT KNOWLEDGE AVAILABLE TO THE ENGINEER AT THE TIME OF THIS DESIGN. THE CONTRACTOR SHALL VISIT THE SITE
 PRIOR TO CONSTRUCTION AND VERIFY ALL EXISTING CONDITIONS RELATED TO THE SCOPE OF WORK FOR THIS PROJECT.
- ICE BRIDGE, CABLE LADDER, COAX PORT, AND COAX CABLE ARE SHOWN FOR REFERENCE ONLY. CONTRACTOR SHALL CONFIRM THE EXACT LOCATION OF ALL PROPOSED AND EXISTING EQUIPMENT AND STRUCTURES DEPICTED ON THIS PLAN. BEFORE UTILIZING EXISTING CABLE SUPPORTS, COAX PORTS, INSTALLING NEW PORTS OR ANY OTHER EQUIPMENT, CONTRACTOR SHALL VERIFY ALL ASPECTS OF THE COMPONENTS MEET THE ATC SPECIFICATIONS.
- 3. THIS PROJECT INCLUDES NO INSTALL OR MODIFICATION AT GRADE.

BANDING. ADEQUATELY SECURE CABLES USING EITHER APPROPRIATELY SIZED STAINLESS STEEL

AS SPECIFIED BY CABLE MANUFACTURER.

SNAP-INS OR MOUNTING HARDWARE AND BRACKETS

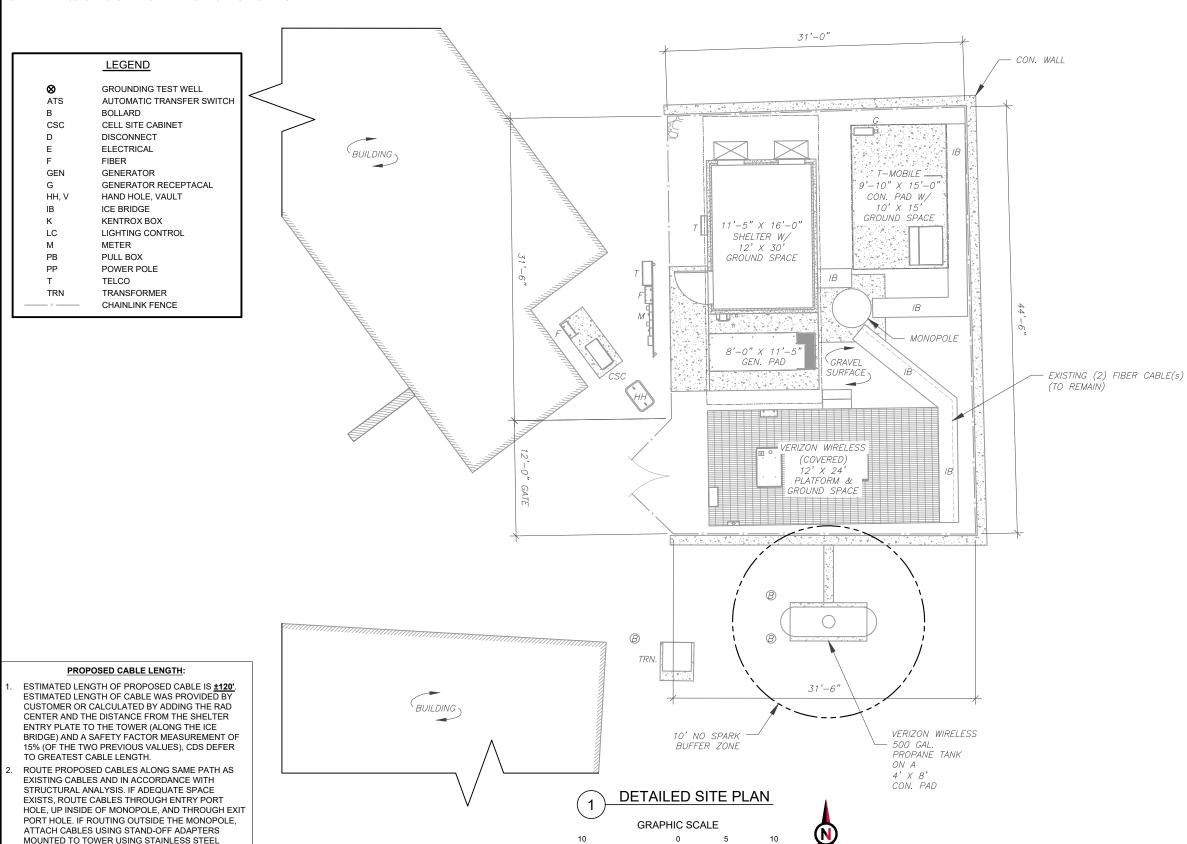

1 UNIT = 10 FEET





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28971




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DETAILED SITE PLAN

SHEET NUMBER:

C-101

REVISION:

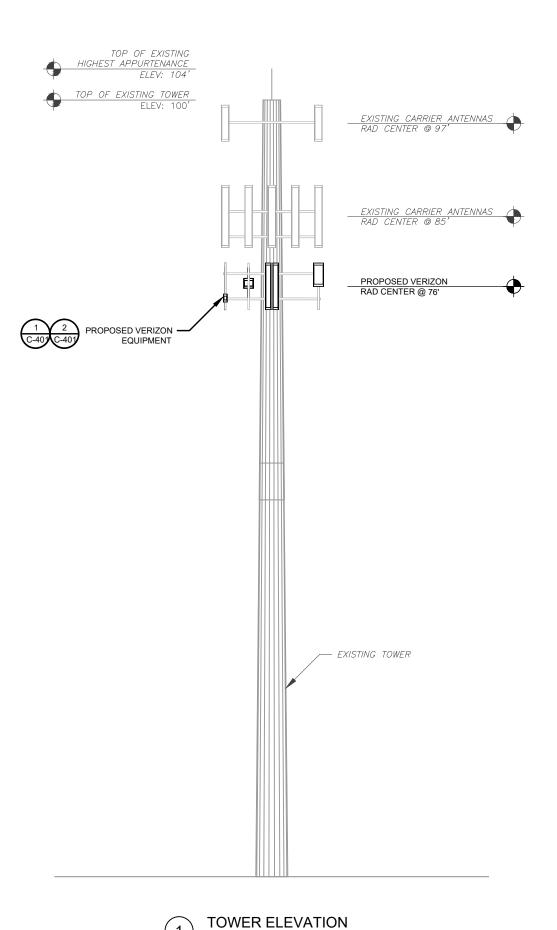

SCALE: N.T.S.

PER MOUNT ANALYSIS COMPLETED BY COLLIERS ENGINEERING & DESIGN. DATED 10/10/23. THE EXISTING MOUNT MUST BE MODIFIED TO ADEQUATELY SUPPORT THE PROPOSED LOADING. THE MOUNT MODIFICATION DETAILED AT THE END OF THIS PLAN SET, MUST BE INSTALLED PRIOR TO THE INSTALLATION OF THE PROPOSED ANTENNAS AND OTHER EQUIPMENT.

- TOWER NOTE:

 1. IT IS THE CONTRACTOR'S RESPONSIBILITY TO CONFIRM WITH THE PROJECT MANAGER THAT THEY HAVE THE MOST RECENT VERSION OF THE STRUCTURAL ANALYSIS BEFORE COMMENCING WORK. EXISTING AND PROPOSED TOWER APPURTENANCES, MOUNTS, AND ANTENNAS ARE SHOWN BASED ON THE STRUCTURAL ANALYSIS.
- 2. WHERE APPLICABLE, ALL NEW ANTENNAS, EQUIPMENT, MOUNTS, CABLING, ETC. SHALL BE PAINTED/SOCKED TO MATCH EXISTING EQUIPMENT IN ACCORDANCE WITH FAA, JURISDICTION, AND/OR OTHER LOCAL REQUIREMENTS.
- 3. ROUTE PROPOSED CABLES ALONG SAME PATH AS EXISTING CABLES AND IN ACCORDANCE WITH STRUCTURAL ANALYSIS. IF ADEQUATE SPACE EXISTS, ROUTE CABLES THROUGH ENTRY PORT HOLE, UP INSIDE OF MONOPOLE, AND THROUGH EXIT PORT HOLE. IF ROUTING OUTSIDE THE MONOPOLE, ATTACH CABLES USING STAND-OFF ADAPTERS MOUNTED TO TOWER USING STAINLESS STEEL BANDING. ADEQUATELY SECURE CABLES USING EITHER APPROPRIATELY SIZED STAINLESS STEEL SNAP-INS OR MOUNTING HARDWARE AND BRACKETS AS SPECIFIED BY CABLE MANUFACTURER.
- 4. TOWER ELEVATIONS ARE MEASURED FROM TOP OF BASE PLATE TO MATCH STRUCTURAL ANALYSIS. ELEVATIONS DO NOT REFLECT TRUE ABOVE GROUND LEVEL (A.G.L.)

AMERICAN TOWER®



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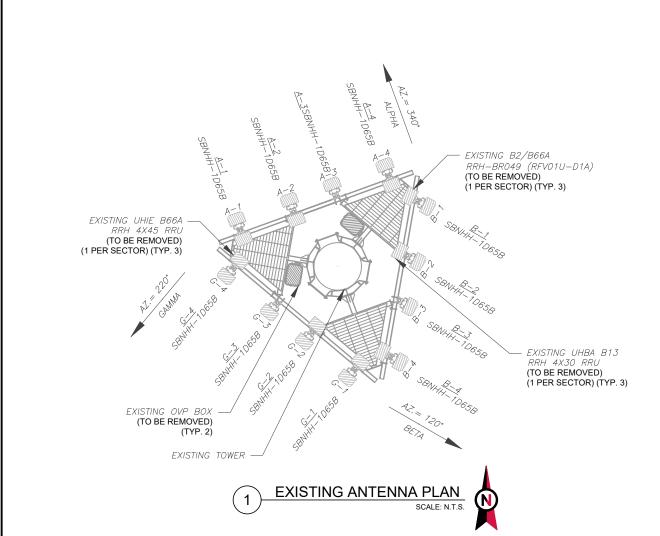
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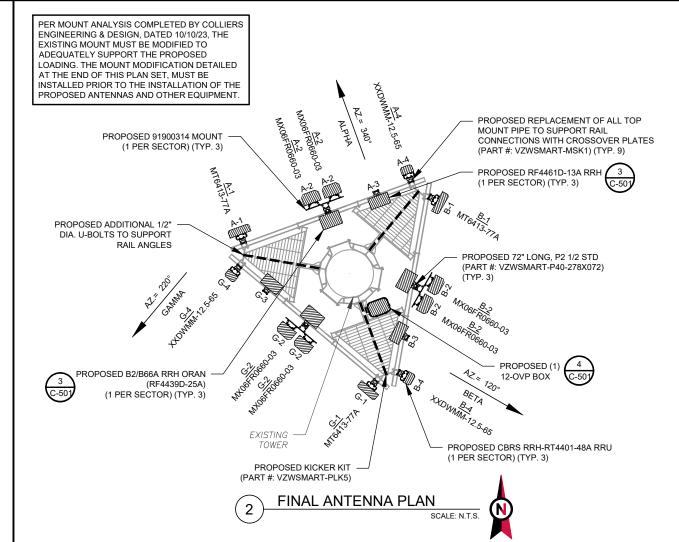
TOWER ELEVATION

SHEET NUMBER:

REVISION:

C-201





	EXISTING ANTENNA SCHEDULE								Π	
LOC	CATION			ANT	ENNA SUMMARY			NON ANTENNA SUMMARY		
SECTOR	RAD	AZ	POS	ANTENNA	BAND	MECH/ELEC D-TILT	STATUS	ADDITIONAL TOWER MOUNTED EQUIPMENT	STATUS	
			A 1	SBNHH-1D65B	LTE 700, LTE AWS	0/4,2	RMV	B2/B66A RRH—BR049 (RFV01U—D1A)	RMV	
ALPHA	76'	340°	A2	SBNHH-1D65B	LTE 700, LTE AWS	0/4,2	RMV	UHBA B13 RRH 4X30	RMV	
			A3	SBNHH-1D65B	LTE 700, LTE AWS	0/4,2	RMV	_	_	1
			A4	SBNHH-1D65B	LTE 700, LTE AWS	0/4,2	RMV	UHIE B66A RRH 4X45	RMV	
			B1	SBNHH-1D65B	LTE 700, LTE AWS	0/4,2	RMV	B2/B66A RRH-BR049 (RFV01U-D1A)	RMV	l
BETA	76'	120°	B2	SBNHH-1D65B	LTE 700, LTE AWS	0/4,2	RMV	UHBA B13 RRH 4X30	RMV	
			<i>B3</i>	SBNHH-1D65B	LTE 700, LTE AWS	0/4,2	RMV	-	-	
			B4	SBNHH-1D65B	LTE 700, LTE AWS	0/4,2	RMV	UHIE B66A RRH 4X45	RMV	
			G1	SBNHH-1D65B	LTE 700, LTE AWS	0/4,2	RMV	B2/B66A RRH-BR049 (RFV01U-D1A)	RMV	İL
GAMMA	76'	220°	G2	SBNHH-1D65B	LTE 700, LTE AWS	0/4,2	RMV	UHBA B13 RRH 4X30	RMV	l
			G3	SBNHH-1D65B	LTE 700, LTE AWS	0/4,2	RMV	-	_	
			G4	SBNHH-1D65B	LTE 700, LTE AWS	0/4,2	RMV	UHIE B66A RRH 4X45	RMV	

	NOTES						FINAL ANTENNA SCHE	DULE				
	CONFIRM WITH VERIZON REP	LO	CATION			,	ANTENNA SUMMARY			NON ANTENNA SUMMARY		1
;	FOR APPLICABLE UPDATES/REVISIONS AND MOST RECENT RFDS FOR NSN	SECTOR	RAD	AZ	POS	ANTENNA	BAND	MECH/ELEC D-TILT	STATUS	ADDITIONAL TOWER MOUNTED EQUIPMENT	STATUS	
	CONFIGURATION (CONFIG). GC		77.5'		A1	MT6413-77A	5G L-SUB6	0/6	ADD	-	- 3	-1
-	TO CAP ALL UNUSED PORTS. 2. CONFIRM SPACING OF PROPOSED EQUIP DOES NOT		76'		A2	MX06FR0660-03	LTE 700, 5G 850, LTE 850, LTE 1900, LTE AWS	0/6,4,2	ADD	B2/B66A RRH ORAN	ADD	(
	CAUSE TOWER CONFLICTS NOR IMPEDE TOWER CLIMBING	ALPHA	76'	340°	A2	MX06FR0660-03	LTE 700, 5G 850, LTE 850, LTE 1900, LTE AWS	0/6,4,2	ADD	(RF4439D-25A)	ADD	
	PEGS.		-		А3	-	-	-	-	RF4461D-13A	ADD	1
			74'		A4	XXDWMM-12.5-65	LTE CBRS	0/8	ADD	CBRS RRH-RT4401-48A	ADD	1
	STATUS ABBREVIATIONS		77.5'		B1	MT6413-77A	5G L-SUB6	0/6	ADD	-	-	1
	RMV: TO BE REMOVED		76'		B2	MX06FR0660-03	LTE 700, 5G 850, LTE 850, LTE 1900, LTE AWS	0/6,4,2	ADD	B2/B66A RRH ORAN	ADD	1
	REL: TO BE RELOCATED ADD: TO BE ADDED	BETA	76'	120°	B2	MX06FR0660-03	LTE 700, 5G 850, LTE 850, LTE 1900, LTE AWS	0/6,4,2	ADD	(RF4439D-25A)	ADD	
			-		В3	-	-	-	-	RF4461D-13A	ADD	
4			74'		B4	XXDWMM-12.5-65	LTE CBRS	0/8	ADD	CBRS RRH-RT4401-48A	ADD	1
4	CABLE LENGTHS FOR JUMPERS		77.5'		C1	MT6413-77A	5G L-SUB6	0/6	ADD	-	-	1
-	JUNCTION BOX TO RRU: 15' RRU TO ANTENNA: 10'		76'		C2	MX06FR0660-03	LTE 700, 5G 850, LTE 850, LTE 1900, LTE AWS	0/6,4,2	ADD	B2/B66A RRH ORAN	ADD	1
		GAMMA	76'	220°	C2	MX06FR0660-03	LTE 700, 5G 850, LTE 850, LTE 1900, LTE AWS	0/6,4,2	ADD	(RF4439D-25A)	ADD	
			-		C3	-	-	-	-	RF4461D-13A	ADD	1
			74'		C4	XXDWMM-12.5-65	LTE CBRS	0/8	ADD	CBRS RRH-RT4401-48A	ADD	
												1

EXISTING FIBER DISTRIBUTION/O	/P BOX	EXISTI	NG CABLING SUMMARY	
MODEL NUMBER	STATUS	COAX	HYBRID	STATUS
(2) OVP(s)	RMV	_	_	_
(2) FIBER CABLE(s)	RMN	-	-	-

\bigcirc	EQUIPMENT SCHEDULES
(3)	

FINAL FIBER DISTRIBUTION / OVP BOX		FINAL	CABLING SUMMARY	
MODEL NUMBER	STATUS	COAX	HYBRID	STATUS
(1) 12-OVP BOX	ADD	-	-	-
(2) FIBER CABLE(s)	RMN	-	-	-





Dewberry Engineers Inc.
99 SUMMER STREET
SUITE 700
BOSTON, MA 02110
PHONE: 617.531.0801
FAX: 617.695.3310

REV.	DESCRIPTION	BY	DATE
<u> </u>	PRELIM	ZP_	06/17/21
<u></u>	FINAL	SL_	03/14/23
<u>1</u>	FINAL	VL	01/09/24
\triangle			
\wedge			

ATC SITE NUMBER: 283421

ATC SITE NAME: MADISON CT

VERIZON SITE NAME: MADISON 5 CT

SITE ADDRESS: 15 ORCHARD PARK ROAD




verizon[/]

DATE DRAWN:	06/17/21
ATC JOB NO:	13684191
CUSTOMER ID:	MADISON 5 CT
CUSTOMER #:	467699


ANTENNA INFORMATION & SCHEDULE

SHEET NUMBER:	
C-401	


REVISION:

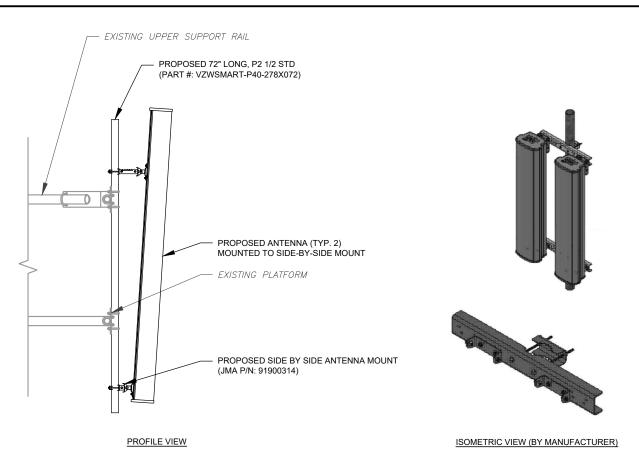


PROPOSED SIDE-BY-SIDE MOUNT SCALE: NOT TO SCALE

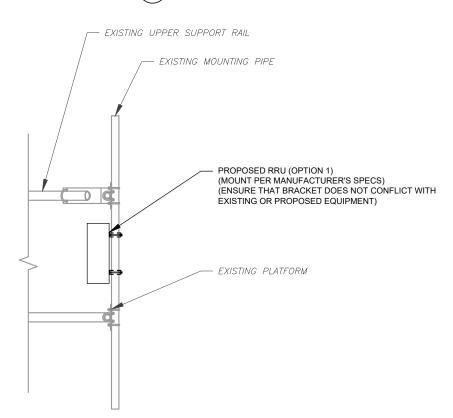

PROPOSED RRU MOUNTING DETAIL - TYPICAL

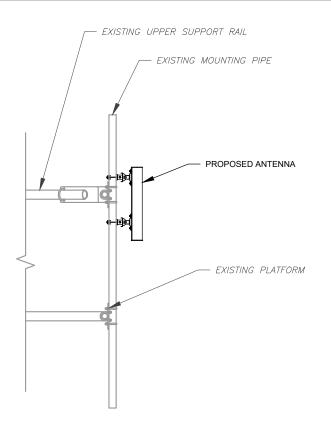

PROPOSED 5G ANTENNA MOUNTING DETAIL - TYPICAL

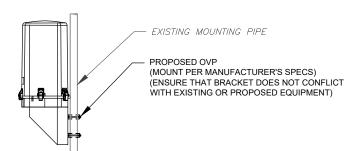

PROPOSED OVP MOUNTING
SCALE: N.T.S.





Dewberry Engineers Inc.
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SUITE 700
BOSTON, MA 02110
PHONE: 617.531.0801
FAX: 617.695.3310

REV.	DESCRIPTION	BY	DATE
<u> </u>	PRELIM	ZP	06/17/21
<u>^</u>	FINAL	SL	03/14/23
1\	FINAL	VL	01/09/24
$\overline{\wedge}$			
$\overline{\wedge}$			

ATC SITE NUMBER: 283421

ATC SITE NAME: MADISON CT

VERIZON SITE NAME:

MADISON 5 CT

SITE ADDRESS: 15 ORCHARD PARK ROAD MADISON, CT 06443-2268





	DATE DRAWN:	06/17/21
	ATC JOB NO:	13684191
	CUSTOMER ID:	MADISON 5 CT
	CUSTOMER #:	467699
ı		


CONSTRUCTION DETAILS

SHEET NUMBER:

C-501


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REVISION:

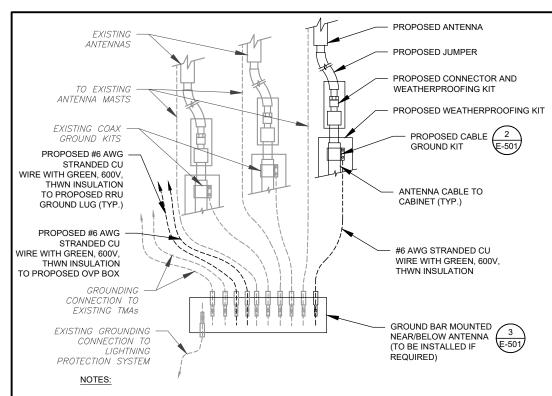


- 1. THIS DETAIL IS INTENDED TO SHOW THE GENERAL GROUNDING REQUIREMENTS. SLIGHT ADJUSTMENTS MAY BE REQUIRED BASED ON EXISTING SITE CONDITIONS. THE CONTRACTOR SHALL MAKE FIELD ADJUSTMENTS AS NEEDED AND INFORM THE CONSTRUCTION MANAGER OF ANY CONFLICTS.
- 2. SITE GROUNDING SHALL COMPLY WITH VERIZON GROUNDING STANDARDS, LATEST EDITION, AND COMPLY WITH VERIZON GROUNDING CHECKLIST, LATEST VERSION. WHEN NATIONAL AND LOCAL GROUNDING CODES ARE MORE STRINGENT THEY SHALL GOVERN.



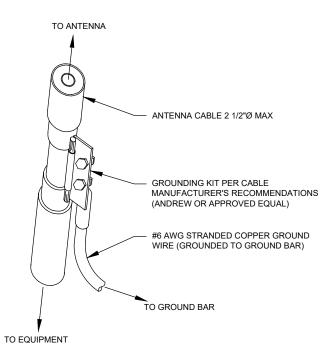

- GROUND KIT NOTES:

 1. DO NOT INSTALL CABLE GROUND KIT AT A BEND AND ALWAYS DIRECT GROUND WIRE DOWN TO GROUND BAR.
- 2. CONTRACTOR SHALL PROVIDE WEATHERPROOFING KIT (ANDREW PART NUMBER 221213) AND INSTALL/TAPE PER MANUFACTURER'S SPECIFICATIONS.

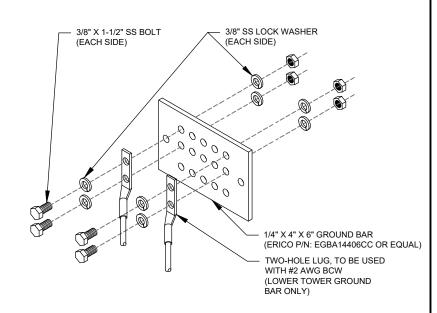

GROUND BAR NOTES:

- GROUND BAR KITS COME WITH ALL HARDWARE, NUTS, BOLTS, WASHERS, ETC. EXCEPT THE STRUCTURAL MOUNTING MEMBER(S).
- 2. GROUND BAR TO BE BONDED DIRECTLY TO TOWER.







Dewberry Engineers Inc. 99 SUMMER STREET SUITE 700 BOSTON, MA 02110 PHONE: 617.531.0801 FAX: 617.695.3310

REV.	DESCRIPTION	BY	DATE
<u> </u>	PRELIM	<u>JW</u>	05/25/21
<u> </u>	FINAL	SL	03/14/23
<u>^1</u>	FINAL	VL	01/09/24
\triangle			
$\overline{\wedge}$			

ATC SITE NUMBER: 283421

ATC SITE NAME: MADISON CT

VERIZON SITE NAME:

MADISON 5 CT

SITE ADDRESS: 15 ORCHARD PARK ROAD MADISON, CT 06443-2268



DATE DRAWN:	06/17/21
ATC JOB NO:	13684191
CUSTOMER ID:	MADISON 5 CT
CUSTOMER #:	467699


GROUNDING DETAILS


SHEET NUMBER:

E-501

REVISION:

CABLE GROUND KIT CONNECTION DETAIL

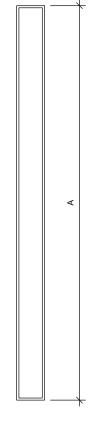


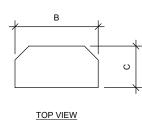

FRONT VIEW

ANTENNA SPECIFICATIONS FOR ILLUSTRATIVE PURPOSES ONLY - NOT TO SCALE

ANTENNA SPECIFICATIONS					
ANTENNA MODEL A B C WEIGHT (LBS)					
MT6413-77A	29.5"	15.8"	5.5"	55.1	
MX06FR0660-03	71.3"	15.4"	10.7"	60.0	
XXDWMM-12.5-65	12.3"	8.66"	1.35"	2.86	

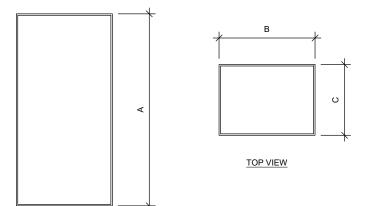



2 RRU SPECIFICATIONS


FOR ILLUSTRATIVE PURPOSES ONLY - NOT TO SCALE

FRONT VIEW

RRU SPECIFICATIONS				
RRU MODEL	А	В	С	WEIGHT (LBS)
B2/B66A RRH ORAN (RF4439D-25A)	15.0"	15.0"	10.0"	74.7
RF4461D-13A	15.0"	15.0"	10.2"	79.1

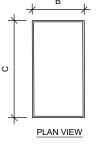

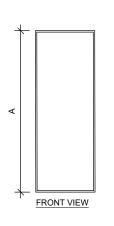

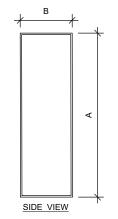



RVZDC-6627-PF-48

OVP SPECIFICATIONS FOR ILLUSTRATIVE PURPOSES ONLY - NOT TO SCALE

29.5"

OVP SPECIFICATIONS

OVP MODEL A B C WEIGHT (LBS)

16.5"

12.6"

32.0





Dewberry Engineers Inc.

99 SUMMER STREET
SUITE 700
BOSTON, MA 02110
PHONE: 617.531.0801
FAX: 617.695.3310

ATC SITE NUMBER: 283421

ATC SITE NAME: MADISON CT

VERIZON SITE NAME: MADISON 5 CT

SITE ADDRESS: 15 ORCHARD PARK ROAD MADISON, CT 06443-2268

DATE DRAWN: 06/17/21

ATC JOB NO: 13684191

CUSTOMER ID: MADISON 5 CT

CUSTOMER #: 467699

SUPPLEMENTAL

SHEET NUMBER:

R-601

NOTE: THIS SHEET WAS CREATED BY OTHERS AND PROVIDED AT THE REQUEST OF THE CUSTOMER WITHOUT EDIT. PLEASE REFERENCE THE MOUNT ANALYSIS REPORT FOR COMPLETE MOUNT ANALYSIS CALCULATIONS AND DETAILS. SUPPLEMENTAL PAGES INCLUDED IN THE CONSTRUCTION DRAWINGS ARE FOR REFERENCE ONLY. GENERAL CONTRACTOR IS TO VERIFY THEY HAVE THE MOST RECENT MOUNT ANALYSIS PRIOR TO CONSTRUCTION.





Colliers Engineering & Design, Architecture, Landscape Architecture, Surveying, CT P.C.
1055 Washington Boulevard
Stamford, CT 06901
203.324.0800
peter.albano@collierseng.com

Post-Modification Antenna Mount Analysis Report and PMI Requirements

Mount Fix

SMART Tool Project #: 10210298 Colliers Engineering & Design Project #: 21777875 (Rev. 1)

October 10, 2023

Site Information Site ID: 5000392629-VZW / MADISON 5 CT - FTP

Orchard Park

Site Name: MADISON 5 CT - FTP Orchard Park

Carrier Name: Verizon Wireless Address: 15 Orchard Park Rd

Madison, Connecticut 06443

New Haven County

Latitude: 41.28308333° Longitude: -72.62308333°

<u>Structure Information</u> Tower Type: 120-Ft Monopole

Mount Type: 12.58-Ft Platform

FUZE ID # 16067465

Analysis Results

Platform: 60.8% Pass w/ Modifications*

*Antennas and equipment to be installed in compliance with PMI Requirements of this mount analysis.

***Contractor PMI Requirements:

Included at the end of this MA report
Available & Submitted via portal at https://pmi.vzwsmart.com
For additional questions and support, please reach out to:
pmisupport@colliersengineering.com

Report Prepared By: Grant Walters



Mount Post-Modification Analysis Report (1) 12.50-Ft Platform October 10, 2023 Site ID: 5000392629-VZW / MADISON 5 CT Page | 5

Requirements:

The existing mount will be **SUFFICIENT** for the final loading configuration (attachment 2) after the modifications detailed in attachment 3 are successfully completed.

ANSI/ASSP rigging plan review services compliant with the requirements of ANSI/TIA 322 are available for a Construction Class IV site or other, if required. Separate review fees will apply.

Attachments:

- 1. Contractor Required PMI Report Deliverables
- 2. Antenna Placement Diagrams
- 3. Mount Modification Drawings
- 4. Mount Photos
- 5. Mount Mapping Report (for reference only)
- Analysis Calculations





Dewberry Engineers Inc.
99 SUMMER STREET
SUITE 700
BOSTON, MA 02110
PHONE: 617.531.0801
FAX: 617.695.3310

ATC SITE NUMBER: 283421

ATC SITE NAME: MADISON CT

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MADISON 5 CT

SITE ADDRESS: 15 ORCHARD PARK ROAD MADISON, CT 06443-2268


DATE DRAWN: 06/17/21
ATC JOB NO: 13684191
CUSTOMER ID: MADISON 5 CT
CUSTOMER #: 467699

SUPPLEMENTAL

SHEET NUMBER:

R-602

NOTE: THIS SHEET WAS CREATED BY OTHERS AND PROVIDED AT THE REQUEST OF THE CUSTOMER WITHOUT EDIT. PLEASE REFERENCE THE MOUNT ANALYSIS REPORT FOR COMPLETE MOUNT ANALYSIS CALCULATIONS AND DETAILS. SUPPLEMENTAL PAGES INCLUDED IN THE CONSTRUCTION DRAWINGS ARE FOR REFERENCE ONLY. GENERAL CONTRACTOR IS TO VERIFY THEY HAVE THE MOST RECENT MOUNT ANALYSIS PRIOR TO CONSTRUCTION.

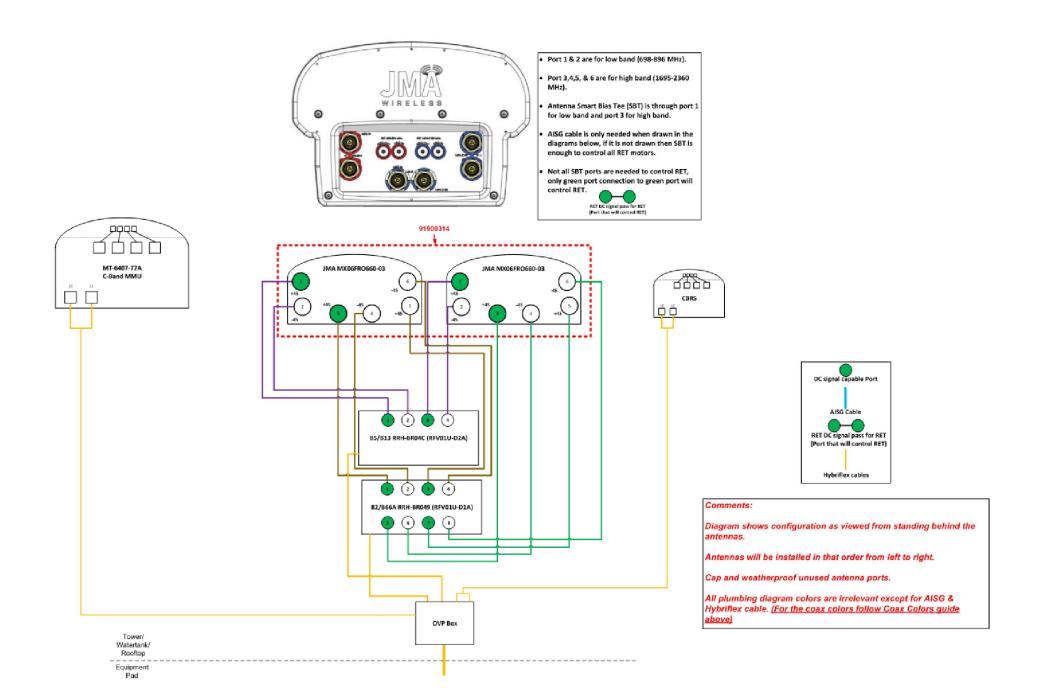

Proprietary and Confidential. Not for disclosure outside of Verizon.

AMERICAN TOWER®



Dewberry Engineers Inc.
99 SUMMER STREET
SUITE 700
BOSTON, MA 02110
PHONE: 617.531.0801
FAX: 617.695.3310

ATC SITE NUMBER: 283421

ATC SITE NAME: MADISON CT

VERIZON SITE NAME: MADISON 5 CT

SITE ADDRESS: 15 ORCHARD PARK ROAD MADISON, CT 06443-2268

DATE DRAWN: 06/17/21

ATC JOB NO: 13684191

CUSTOMER ID: MADISON 5 CT

CUSTOMER #: 467699

SUPPLEMENTAL

SHEET NUMBER:

R-603



MOUNT MODIFICATION DRAWINGS EXISTING 12.58' PLATFORM

TOWER OWNER: AMERICAN TOWER CO. TOWER OWNER SITE NUMBER: 283421

CARRIER SITE NAME: MADISON 5 CT-FTP ORCHARD PARK CARRIER SITE NUMBER: 5000392629 FUZE ID: 16067465

> 15 ORCHARD PARK RD MADISON, CT 06443 NEW HAVEN COUNTY

LATITUDE: 41.28308333° N LONGITUDE: 72.62308333° W

DESIGN CRITERIA

WIND LOADS

BASIC WIND SPEED (3 SECOND GUST), V = 125 MPH EXPOSURE CATEGORY B

TOPOGRAPHIC CATEGORY I MEAN BASE ELEVATION (AMSL) = 18.26'

ICE LOADS

ICE WIND SPEED (3 SECOND GUST), V = 50 MPH

ICE THICKNESS = 1.00 IN

SEISMIC LOADS

SEISMIC DESIGN CATEGORY B SHORT TERM MCER GROUND MOTION, $S_{\rm S}=.206$ Long Term McEr ground motion, $S_{\rm I}=.054$

APPLICANT/LESSEE COMPANY: VERIZON WIRELESS CLIENT REPRESENTATIVE COMPANY: VERIZON WIRELESS PROJECT MANAGER COMPANY: COLLIERS ENGINEERING & DESIGN CONTACT: PETER ALBANO PHONE: 856.797.0412 E-MAIL: PETER.ALBANO@COLLIERSENGINEERING.COM

PROJECT INFORMATION

CONTRACTOR F	PMI REQUIREMENTS	

PMI LOCATION: SMART TOOL PROJECT #: VZW LOCATION CODE (MDG): ANALYSIS DATE:

10210298 5000392629 10/10/2023

W LOCATION CODE (MDG): 5000392629

IALYSIS DATE: 10/10/2023

PMI REQUIREMENTS EMBEDDED WITHIN MOUNT MODIFICATION REPORT

HTTPS://PMI.VZWSMART.COM

Colliers Engineering verizon v EV DATE DESCRIPTION

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OF THE RESPONSIBLE LICENSED PROFESSIONAL ENGINEER, TO ALTER THIS DOCUMENT.

SITE NAME:

MADISON 5 CT-FTP Orchard

Park

5000392629

15 ORCHARD PARK RD

MADISON, CT 06443

NEW HAVEN COUNTY

TITLE SHEET

SHEET INDEX

SHEET DESCRIPTION
ST-I TITLE SHEET

SBOM-I BILL OF MATERIALS

SCF-I CLIMBING FACILITY DETAIL

SPECIFICATION SHEETS

SS-I MODIFICATION DETAILS

SGN-I GENERAL NOTES

SS-2 MOUNT PHOTOS

BILL OF MATERIALS

			SEC ⁻	TION I - VZWSMART KITS		
QUANTITY	MANUFACTURER	PART NUMBER	DESCRIPTION	NOTES	UNIT WEIGHT (LBS.)	WEIGHT (LBS.)
12		VZWSMART-MSK1	CROSSOVER PLATE		14	168
I		VZWSMART-PLK5	KICKER KIT	CONTRACTOR TO VERIFY THE LENGTH REQUIRED AND TRIM AS NECESSARY IN ACCORDANCE WITH THE 'STRUCTURAL STEEL' NOTES ON SHEET SGN-I.	291	291
1		VZWSMART-PLK7	MONOPOLE COLLAR MOUNT ASSEMBLY		150	150
3		VZWSMART-P40-278X072	72" LONG, PIPE 2 1/2 STD (2.875"OD X 0.203" THK)		35	105
	VZWSMART					
			SECTION	N 2 - OTHER REQUIRED PARTS		
QUANTITY	MANUFACTURER	PART NUMBER	DESCRIPTION	NOTES	UNIT WEIGHT (LBS.)	WEIGHT (LBS.)
3	SITE PRO I	SP219-H	CROSSOVER PLATE	OR EOR APPROVED EQUAL, CONTACT MASER CONSULTING FOR APPROVAL OF SUBSTITUTION.	13	39
-	-	-	I/2" DIA. U-BOLTS	GALVANIZED.		
					TOTAL:	753


NOTES:	

- I. THE MANUFACTURERS LISTED ARE THE APPROVED VENDORS FOR THE VZW MOUNT KITS. EACH MANUFACTURER WILL BE AWARE OF WHICH KITS HAVE BEEN THROUGH THE VZW APPROVAL PROCESS AND THEY ARE IN TURN APPROVED TO SELL. PLEASE NOTE THAT THE MATERIAL UTILIZED ON THE MOUNT MODIFICATIONS WILL BE REVIEWED AS A PART OF THE DESKTOP PMI COMPLETED BY THE SMART TOOL VENDOR. IT WILL BE REQUIRED THAT THE VZW KITS SPECIFIED ARE UTILIZED IN THE MODIFICATIONS.
- 2. ALL MATERIALS REQUIRED FOR THE DESIGNED MODIFICATIONS BUT NOT LISTED IN THIS SHEET ARE ASSUMED TO BE PROVIDED BY THE CONTRACTOR.

	COMMSCOPE
CONTACT	SALVADOR ANGUIANO
PHONE	(817) 304-7492
EMAIL	SALVADOR.ANGUIANO@COMMSCOPE.COM
WEBSITE	WWW.COMMSCOPE.COM
Ν	IETROSITE FABRICATORS, LLC
CONTACT	KENT RAMEY
PHONE	(706) 335-7045 (O), (706) 982-9788 (M)
EMAIL	KENT@METROSITELLC.COM
WEBSITE	METROSITEFABRICATORS.COM
	PERFECTVISION
CONTACT	WIRELESS SALES
PHONE	(844) 887-6723
EMAIL	WWW.PERFECT-VISION.COM
WEBSITE	WIRELESSSALES@PERFECT-VISION.COM
	SABRE INDUSTRIES, INC.
CONTACT	ANGIE WELCH
PHONE	(866) 428-6937
EMAIL	AKWELCH@SABREINDUSTRIES.COM
WEBSITE	WWW.SABRESITESOLUTIONS.COM
	SITE PRO 1
CONTACT	PAULA BOSWELL
PHONE	(972) 236-9843
EMAIL	PAULA.BOSWELL@VALMONT.COM
WEBSITE	WWW.SITEPRO I.COM

VZWSMART KITS - APPROVED VENDORS			
NEWAVE			
CONTACT	NEWAVE SALES TEAM		
PHONE	(971) 239-4762		
EMAIL	SALES@NEWAVETC.COM		
WEBSITE	WWW.NEWAVETC.COM		
	BETTER METAL, LLC		
CONTACT	DAVID STANSBERRY		
PHONE	(615) 535-0990 (O), (615) 631-2520 (M)		
EMAIL	DLS@BETTERMETAL.COM		
WEBSITE	WWW.BETTERMETAL.COM		



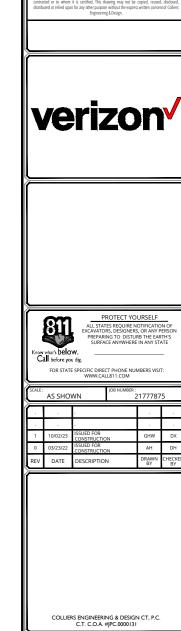

IT IS A VIOLATION OF LAW FOR ANY PERSON, UNLESS THEY ARE ACTING UNDER THE DIRECTION OF THE RESPONSIBLE LICENSED PROFESSIONAL ENGINEER, TO ALTER THIS DOCUMENT.

SITE NAME: MADISON 5 CT-FTP Orchard Park 5000392629

> 15 ORCHARD PARK RD MADISON, CT 06443 NEW HAVEN COUNTY



BILL OF MATERIALS

SBOM-I

PROJECT NOTES

- I. SEE MODIFICATION NOTES
- 2. THE CONTRACTOR SHALL COMPLY WITH ALL APPLICABLE CODES, ORDINANCES, LAWS AND REGULATIONS OF ALL MUNICIPALITIES, UTILITY COMPANIES OR OTHER PUBLIC/GOVERNING AUTHORITIES.
- 3. THE CONTRACTOR SHALL BE RESPONSIBLE FOR OBTAINING ALL PERMITS AND INSPECTIONS THAT MAY BE REQUIRED BY ANY FEDERAL, STATE, COUNTY OR MUNICIPAL AUTHORITIES.
- THE CONTRACTOR SHALL NOTIFY THE CONSTRUCTION MANAGER, IN WRITING, OF ANY CONFLICTS, ERRORS OR OMISSIONS PRIOR TO THE SUBMISSION OF BIDS OR PERFORMANCE OF WORK.
- THE CONTRACTOR SHALL BE RESPONSIBLE FOR PROTECTING ALL EXISTING SITE IMPROVEMENTS PRIOR TO COMMENCING CONSTRUCTION. THE CONTRACTOR SHALL REPAIR ANY DAMAGE AS A RESULT OF CONSTRUCTION OF THIS FACILITY AT THE CONTRACTOR'S EXPENSE TO THE SATISFACTION OF THE OWNER
- 6. THE SCOPE OF WORK FOR THIS PROJECT SHALL INCLUDE PROVIDING ALL MATERIALS, EQUIPMENT AND LABOR REQUIRED TO COMPLETE THIS PROJECT. ALL EQUIPMENT SHALL BE INSTALLED IN ACCORDANCE WITH MANUFACTURER'S RECOMMENDATIONS.
- THE CONTRACTOR SHALL VISIT THE PROJECT SITE PRIOR TO SUBMITTING THE BID TO VERIFY THAT THE PROJECT CAN BE CONSTRUCTED IN ACCORDANCE WITH THE CONTRACT DOCUMENTS AND CONSTRUCTION
- THE CONTRACTOR SHALL VERIFY ALL EXISTING DIMENSIONS AND CONDITIONS PRIOR TO COMMENCING ANY WORK. ALL DIMENSIONS OF EXISTING CONSTRUCTION SHOWN ON THESE DRAWINGS MUST BE VERIFIED. THE CONTRACTOR SHALL NOTIFY THE CONSTRUCTION MANAGER OF ANY DISCREPANCIES PRIOR TO ORDERING MATERIAL OR PROCEEDING WITH CONSTRUCTION.
- SINCE THE CELL SITE MAY BE ACTIVE, ALL SAFETY PRECAUTIONS MUST BE TAKEN WHEN WORKING AROUND HIGH LEVELS OF ELECTROMAGNETIC RADIATION. EOUIPMENT SHOULD BE SHUTDOWN PRIOR TO PERFORMING ANY WORK THAT COULD EXPOSE THE WORKERS TO DANGER. PERSONAL RF EXPOSURE MONITORS ARE REQUIRED TO BE WORN TO ALERT OF ANY POTENTIALLY DANGEROUS EXPOSURE LEVELS.
- 10. NO NOISE, SMOKE, DUST OR ODOR WILL RESULT FROM THIS FACILITY AS TO CAUSE A NUISANCE.
- II. THE FACILITY IS UNMANNED AND NOT FOR HUMAN HABITATION (NO HANDICAP ACCESS IS REQUIRED).

GENERAL NOTES

- THESE MODIFICATIONS HAVE BEEN DESIGNED IN ACCORDANCE WITH THE GOVERNING PROVISIONS OF THE TELECOMMUNICATIONS INDUSTRY STANDARD TIA-222-H MATERIALS AND SERVICES PROVIDED BY THE CONTRACTOR SHALL CONFORM TO THE ABOVE MENTIONED CODES
- 2 CONTRACTOR SHALL TAKE ALL PRECAUTIONS NECESSARY TO PREVENT DAMAGE TO EXISTING STRUCTURES. ANY DAMAGE TO EXISTING STRUCTURES AS A RESULT OF THE CONTRACTOR'S WORK OR FROM DAMAGE DUE TO OTHER CAUSES SHALL BE REPAIRED AT THE CONTRACTOR'S EXPENSE TO THE SATISFACTION OF THE OWNER.
- CONTRACTOR SHALL VERIFY ALL DIMENSIONS AND EXISTING CONDITIONS BEFORE BEGINNING WORK, ORDERING MATERIAL, AND PREPARING OF SHOP DRAWINGS. ANY DISCREPANCIES BETWEEN FIELD CONDITIONS AND THE CONTRACT DOCUMENTS SHALL BE BROUGHT TO THE IMMEDIATE ATTENTION OF THE ENGINEER. IF THE CONTRACTOR DISCOVERS ANY EXISTING CONDITIONS THAT ARE NOT REPRESENTED ON THESE DRAWINGS, OR ANY CONDITIONS THAT WOULD INTERFERE WITH THE INSTALLATION OF THE MODIFICATIONS, NOTIFY THE ENGINEER IMMEDIATELY.
- IT IS ASSUMED THAT ANY STRUCTURAL MODIFICATION WORK SPECIFIED ON THESE PLANS WILL BE ACCOMPLISHED BY KNOWLEDGEABLE WORKMEN WITH TOWER CONSTRUCTION EXPERIENCE.
- THE CONTRACTOR SHALL SUPERVISE AND DIRECT THE WORK AND SHALL BE SOLELY RESPONSIBLE FOR ALL CONSTRUCTION METHODS, MEANS, TECHNIQUES, SEQUENCES, AND PROCEDURES.
- ALL CONSTRUCTION MEANS AND METHODS: INCLUDING BUT NOT LIMITED TO, ERECTION PLANS, RIGGING PLANS, CLIMBING PLANS, AND RESCUE PLANS SHALL BE THE RESPONSIBILITY OF THE GENERAL CONTRACTOR RESPONSIBLE FOR THE EXECUTION OF THE WORK CONTAINED HEREIN AND SHALL MEET ANSI/TIA-322 (LATEST EDITION), OSHA, AND GENERAL INDUSTRY STANDARDS. ALL RIGGING PLANS SHALL ADHERE TO ANSI/TIA-322 (LATEST EDITION) INCLUDING THE REQUIRED INVOLVEMENT OF A QUALIFIED ENGINEER FOR CLASS IV CONSTRUCTION.
- THE CONTRACTOR IS SOLELY RESPONSIBLE FOR INITIATING, MAINTAINING, AND SUPERVISING ALL SAFETY PROGRAMS IN ACCORDANCE WITH APPLICABLE SAFETY CODES.
- WORK SHALL ONLY BE PERFORMED DURING CALM DRY DAYS (WINDS LESS THAN 30-MPH). THE STRUCTURE SHOWN ON THE DRAWINGS IS STRUCTURALLY SOUND ONLY IN THE COMPLETED FORM. THE

- CONTRACTOR SHALL BE RESPONSIBLE FOR THE STRENGTH AND STABILITY OF THE STRUCTURE DURING ERECTION. CONTRACTOR SHALL PROVIDE TEMPORARY SUPPORT. SHORING, BRACING AND ANY OTHER STRUCTURAL SYSTEMS AS REQUIRED TO RESIST ALL FORCES THAT MAY OCCUR DURING HANDLING AND ERECTION UNTIL THE STRUCTURE IS FULLY COMPLETED. TEMPORARY SUPPORTS, BRACING AND OTHER STRUCTURAL SYSTEMS REQUIRED DURING CONSTRUCTION SHALL REMAIN THE CONTRACTOR'S PROPERTY AFTER THEIR USE.
- 9. ALL INSTALLATIONS PERFORMED ON THIS STRUCTURE SHALL BE COMPLETED IN ACCORDANCE WITH THE GOVERNING PROVISIONS OF THE STANDARD FOR INSTALLATION, ALTERATION AND MAINTENANCE OF ANTENNA SUPPORTING STRUCTURES AND ANTENNAS, ANSI/TIA-322.
- 10. CONTRACTOR SHALL SECURE SITE BACK TO EXISTING CONDITION UNDER SUPERVISION OF OWNER. ALL FENCE, STONE, GEOFABRIC, GROUNDING, AND SURROUNDING GRADE SHALL BE REPLACED AND REPAIRED AS REQUIRED TO ACHIEVE OWNER APPROVAL. POSITIVE DRAINAGE AWAY FROM TOWER SITE SHALL BE MAINTAINED.
- II. CONNECTIONS BETWEEN ITEMS SUPPORTED BY THE STRUCTURE AND THE STRUCTURE NOT SPECIFICALLY DETAILED IN THE CONTRACT DOCUMENTS ARE THE RESPONSIBILITY OF THE CONTRACTOR. SUCH CONNECTIONS SHALL BE DESIGNED, COORDINATED AND INSPECTED BY A PROFESSIONAL STRUCTURAL ENGINEER LICENSED IN THE STATE OF THE PROJECT. SUBMIT SIGNED AND SEALED CALCULATIONS DURING SHOP DRAWING REVIEW.
- 12 DO NOT SCALE DRAWINGS
- 13. DO NOT USE THESE DRAWINGS FOR ANY OTHER SITE.
- 14. ALL MATERIAL UTILIZED FOR THIS PROJECT MUST BE NEW AND FREE OF ANY DEFECTS. ANY MATERIAL SUBSTITUTIONS, INCLUDING BUT NOT LIMITED TO ALTERED SIZE AND/OR STRENGTHS, MUST BE APPROVED BY THE OWNER AND ENGINEER IN WRITING
- 15. THE MOUNT UNDER NO CIRCUMSTANCES SHOULD BE USED AS A TIE OFF

STRUCTURAL STEEL

- DESIGN, DETAILING, FABRICATION AND ERECTION OF STRUCTURAL STEEL SHALL CONFORM TO THE FOLLOWING PUBLICATIONS EXCEPT AS SPECIFICALLY INDICATED IN THE CONTRACT DOCUMENTS.
 - a. AMERICAN INSTITUTE OF STEEL CONSTRUCTION (AISC) MANUAL OF STEEL CONSTRUCTION (15TH EDITION)
 - b. SPECIFICATION FOR STRUCTURAL JOINTS USING ASTM A325 OR A490 BOLTS
 - c. AISC CODE OF STANDARD PRACTICE
- STRUCTURAL STEEL SHALL CONFORM TO THE FOLLOWING UNLESS OTHERWISE SHOWN:

CHANNELS, ANGLES, PLATES, ETC. ASTM A36 (GR 36) STEEL PIPE ASTM A53 (GR 35) ASTM A325 **BOLTS** NUTS ASTM A563

LOCK WASHERS LOCKING STRUCTURAL GRADE

- 3. ALL SUBSTITUTIONS PROPOSED BY THE CONTRACTOR SHALL BE APPROVED IN WRITING BY THE ENGINEER. CONTRACTOR SHALL PROVIDE DOCLIMENTATION TO ENGINEER FOR VERIFYING THE SUBSTITUTE IS SUITABLE FOR USE AND MEETS ORIGINAL DESIGN CRITERIA. DIFFERENCES FROM THE ORIGINAL DESIGN, INCLUDING MAINTENANCE, REPAIR AND REPLACEMENT, SHALL BE NOTED, ESTIMATES OF COSTS/CREDITS ASSOCIATED WITH THE SUBSTITUTION (INCLUDING RE-DESIGN COSTS AND COSTS TO SUB-CONTRACTORS) SHALL BE PROVIDED TO THE ENGINEER. CONTRACTOR SHALL PROVIDE ADDITIONAL DOCUMENTATION AND/OR SPECIFICATIONS TO THE ENGINEER AS REQUESTED.
- 4. PROVIDE STRUCTURAL STEEL SHOP DRAWINGS TO ENGINEER FOR APPROVAL PRIOR TO FABRICATION.
 - a. SUBMIT SHOP DRAWINGS TO

PETER.ALBANO@COLLIERSENGINEERING.COM

- b. PROVIDE MASER CONSULTING PROJECT # AND MASER CONSULTING PROJECT ENGINEER CONTACT IN THE BODY OF THE EMAIL.
- 5. DRILL NO HOLES IN ANY NEW OR EXISTING STRUCTURAL STEEL MEMBERS OTHER THAN THOSE SHOWN ON STRUCTURAL DRAWINGS WITHOUT THE APPROVAL OF THE ENGINEER OF RECORD.
- 6. GALVANIZED ASTM A325 BOLTS SHALL NOT BE REUSED.
- 7. ALL NEW STEEL SHALL BE HOT BE DIPPED GALVANIZED FOR FULL WEATHER PROTECTION. IN ADDITION ALL NEW STEEL SHALL BE PAINTED TO MATCH EXISTING STEEL, CONTRACTOR SHALL OBTAIN WRITTEN PERMISSION TO PROTECT STEEL BY ANY OTHER MEANS
- CONTRACTOR SHALL PROTECT CUT ENDS OF ALL FIELD-CUT STEEL WITH TWO (2) COATS OF COLD GALVANIZATION (ZINGA OR ZINC COTE).
- ALL BOLT ASSEMBLIES FOR STRUCTURAL MEMBERS REPRESENTED IN THIS DRAWING REQUIRE LOCKING DEVICES TO BE INSTALLED IN ACCORDANCE WITH TIA-222-H SECTION 4.9.2 REQUIREMENTS.
- 10. WHERE CONNECTIONS ARE NOT FULLY DETAILED ON THESE DRAWINGS, FARRICATOR SHALL DESIGN CONNECTIONS TO RESIST LOADS AND FORCES WHERE SHOWN ON DRAWINGS AND AS OUTLINED IN SPECIFICATIONS.
- II. FOR MEMBERS BEING REPLACED, PROVIDE NEW BOLTS AND MATCH EXISTING SIZE AND GRADE, MAINTAIN AISC REQUIREMENTS FOR MINIMUM BOLT DISTANCE AND SPACING.


- 12. ALL PROPOSED AND/OR REPLACED BOLTS SHALL BE OF SUFFICIENT LENGTH SUCH THAT THE END OF THE BOLT IS AT LEAST FLUSH WITH THE FACE OF THE NUT. IT IS NOT PERMITTED FOR THE BOLT END TO BE BELOW THE FACE OF THE NUT AFTER TIGHTENING IS COMPLETED.
- 13. GALVANIZED ASTM A325 BOLTS SHALL NOT BE REUSED.
- 14. ALL EXISTING PAINTED/GALVANIZED SURFACES DAMAGED DURING REHAB INCLUDING AREAS UNDER STIFFENER PLATES SHALL BE WIRE BRUSHED CLEAN, REPAIRED BY COLD GALVANIZING (ZINGA OR ZINC COTE), AND REPAINTED TO MATCH THE EXISTING FINISH (IF APPLICABLE).
- 15. ALL HOLES IN STEEL MEMBERS SHALL BE SIZED 1/16" LARGER THAN THE BOLT DIAMETER, STANDARD HOLES SHALL BE USED UNLESS NOTED OTHERWISE.

WELDING NOTES

- ALL WELDING SHALL BE DONE IN ACCORDANCE WITH AWS DI.0 (LATEST EDITION). THIS SHALL INCLUDE A CERTIFIED WELD INSPECTION (CWI) FOR ACCEPTANCE OR REJECTION OF ALL WEIDING OPERATIONS PRE DURING AND POST INSTALLATION. USING THE ACCEPTANCE CRITERIA OF AWS DI.I.
- CONTRACTOR IS RESPONSIBLE FOR COMMISSIONING A THIRD PARTY CERTIFIED WELD INSPECTOR (CWI) THROUGHOUT THE ENTIRETY OF THE PROJECT. A PASSING CWI REPORT SHALL BE PROVIDED TO THE ENGINEER UPON COMPLETION OF THE PROJECT.
- THE CERTIFIED WELD INSPECTOR SHALL INDICATE, IN A WRITTEN CWI REPORT THAT ALL WELDING OPERATIONS PRE DURING AND POST INSTALLATION WERE CONDUCTED IN ACCORDANCE WITH AWS DI.I WITH PHOTOGRAPHS AND DOCUMENTATION SUPPORTING THE ACCEPTANCE OR REJECTION OF ALL WELDING. ALL CWI WELD INSPECTION DOCUMENTATION AND PHOTOS SHALL BE SUBMITTED DURING THE PMI
- IN CASES WHERE A WELD IS SPECIFIED BETWEEN TWO MEMBERS IN WHICH THERE IS A GAP IN BETWEEN, THE WELD IS TO BE BUILT-UP SUCH THAT THE SIZE OF WELD ON THE MEMBER IS EQUAL TO THAT SHOWN IN THE
- 5. OXY FUEL GAS WELDING OR BRAZING IS STRICTLY PROHIBITED. SPECIFICALLY, NO TORCH CUTTING IS PERMITTED ON SITE. ALL HOLES SHALL BE CUT WITH A GRINDER.
- 6. CONTRACTOR SHALL EXERCISE CAUTION WHEN WELDING A GALVANIZED
- CONTRACTOR SHALL HAVE A FIRE PROTECTION PLAN IN PLACE THAT CONFORMS WITH ALL OSHA, ANSI/ASSP A10.48, ANSI Z49.1, AND LOCAL JURISDICTIONAL REQUIREMENTS.


	BOLT SCHEDULE (IN.)				
BOLT DIAMETER	STANDARD HOLE	SHORT SLOT	MIN. EDGE DISTANCE	SPACING	
1/2	9/16	9/16 x 11/16	7/8	I I/2	
5/8	11/16	11/16 x 7/8	1 1/8	I 7/8	
3/4	13/16	13/16 x 1	1 1/4	2 1/4	
7/8	15/16	15/16 x 1 1/8	1 1/2	2 5/8	
I	1 1/16	1 1/16 x 1 5/16	I 3/4	3	

WORKABLE GAGES (IN.)		
LEG GAGE		
4	2 1/2	
3 1/2	2	
3	I 3/4	
2 1/2	I 3/8	
2	I I/8	

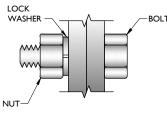


TYP. BOLT ASSEMBLY

- ALL DIMENSIONS REPRESENTED IN THE ABOVE TABLES ARE AISC MINIMUM REQUIREMENTS. CONTRACTOR SHALL VERIFY EXISTING CONDITIONS IN FIELD AND NOTIFY ENGINEER IF DISTANCES ARE LESS THAN THOSE PROVIDED.
- 2. THE DIMENSIONS PROVIDED ARE MINIMUM REQUIREMENTS. ACTUAL **DIMENSIONS OF PROPOSED MEMBERS** WITHIN THESE DRAWINGS MAY VARY FROM THE AISC MINIMUM REQUIREMENTS.
- 3. SHORT SLOT HOLES SHALL ONLY BE USED WHEN DEPICTED IN THE
- MATCH EXISTING GAGES WHEN
 APPLICABLE, UNLESS MINIMUM EDGE DISTANCES ARE COMPROMISED.

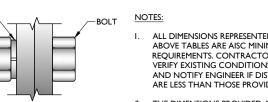

DRAWINGS

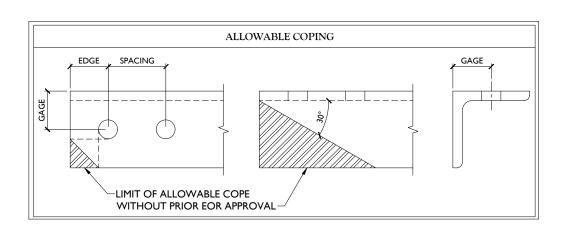

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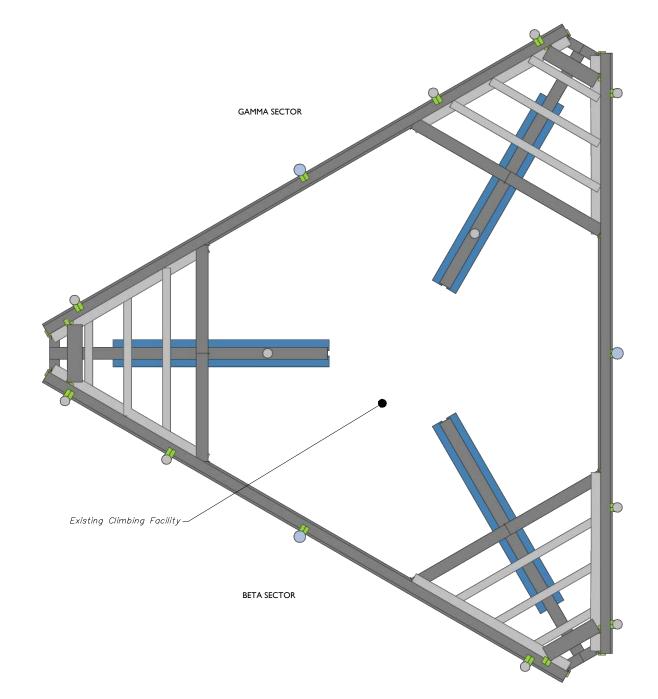
OF THE RESPONSIBLE LICENSED PROFESSIONAL ENGINEER, TO ALTER THIS DOCUMENT.


SITE NAME: MADISON 5 CT-FTP Orchard Park 5000392629

> 15 ORCHARD PARK RD MADISON, CT 06443 **NEW HAVEN COUNTY**

MODIFICATION NOTES

NOTE: DO NOT SCALE DRAWINGS FOR CONSTRUCTION



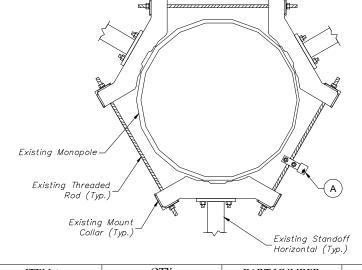

ITEM #	QTY	PART NUMBER	DESCRIPTIONS
A	I	PV-SCRB-RM-U	WIRE ROPE GUIDE (PERFECT VISION OR EQUIV)

ALPHA SECTOR

PROPOSED WIRE ROPE GUIDE ATTACHMENT - PLAN VIEW

SCALE : N.T.S.

NOTE: CONTRACTOR SHALL ENSURE THAT WIRE ROPE GUIDE DOES NOT PUSH THE WIRE ROPE OUTSIDE OF THE VERTICAL PLANE OF THE SAFETY CLIMB. CONTRACT EOR WITH PHOTOS OF SAFETY CLIMB AND COLLAR FOR FURTHER DIRECTION IF NEEDED.



CLIMBING FACILITY PHOTO



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1	10/02/23	ISSUED FOR CONSTRUCTION	GHW	DX
0	03/23/22	ISSUED FOR CONSTRUCTION	AH	DH
REV	DATE	DESCRIPTION	DRAWN BY	CHECKED BY

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> 15 ORCHARD PARK RD MADISON, CT 06443 NEW HAVEN COUNTY

Cullier

1055 Washington Bo Stamford, CT 06 Phone: 203.324.

CLIMBING FACILITY DETAIL

SHEET NUM

SCF-I

1 CLIMBING FACILITY LOCATION SCALE: N.T.S.


STRUCTURAL NOTES:


- I. PER THE MOUNT MAPPING COMPLETED BY HUDSON DESIGN GROUP, LLC ON 10/6/2021, THE SAFETY CLIMB AND CLIMBING FACILITIES UP TO THE VERIZON MOUNT ELEVATION (73'-9") ARE IN GOOD CONDITION. COLLIERS ENGINEERING & DESIGN DOES NOT WARRANT THIS INFORMATION.
- INSTALL SHALL NOT CAUSE HARM TO THE STRUCTURE, CLIMBING FACILITY, SAFETY CLIMB, OR ANY SYSTEM INSTALLED ON THE STRUCTURE. TIMELY NOTICE AND DOCUMENTATION SHALL BE PROVIDED BY CONTRACTORS TO THE EOR (OF STRUCTURAL DESIGN) IF AN OBSTRUCTION WAS REQUIRED TO MEET THE RF SYSTEM DESIGN REQUIREMENTS AND PERFORMANCES.

LEGEND:	
	PROPOSED
	RELOCATED
	EXISTING

MOUNT MODIFICATION SCHEDULE							
ELEVATION QUANTITY DESCRIPTION		DESCRIPTION	NOTES				
1 PROPOSED KICKER KIT (PART #: VZWSMART-PLK5)) 3 PROPOSED 72" LONG, P2 I/2 STD (PART #: VZWSMART-P40-278X072) 9 CROSSOVER PLATE		PROPOSED KICKER KIT (PART #: VZWSMART-PLK5))	CONTRACTOR TO VERIFY THE LENGTH REQUIRED AND TRIM AS NECESSARY IN ACCORDANCE WITH THE 'STRUCTURAL STEEL' NOTES ON SHEET SGN-1. CONNECT OTHER END OF KICKER KIT TO MONOPOLE COLLAR MOUNT ASSEMBLY (PART #: VZWSMART-PLK7).				
		72' 9"	3	PROPOSED 72" LONG, P2 1/2 STD (PART #: VZWSMART-P40-278X072)	CONNECT NEW MOUNT PIPE TO EXISTING TOP HORIZONTAL WITH CROSSOVER PLATES (PART #: VZWSMART-MSKI). CONNECT TO EXISTING BOTTOM HORIZONTAL WITH CROSSOVER PLATES (SITE PRO I - SP219-H).	Ci in cc d'	
		CROSSOVER PLATE	CONTRACTOR SHALL REPLACE ALL EXISTING TOP MOUNT PIPE TO SUPPORT RAIL CONNECTIONS WITH NEW CROSSOVER PLATES (VZWSMART-MSK I). CONTRACTOR SHALL ADJUST SUPPORT RAIL AND CORNER ANGLES AS NEEDED TO BE AGAINST MOUNT PIPES AND MAINTAIN VERTICAL ANTENNA PIPE ORIENTATION.				
	6	I/2" DIA. U-BOLTS	CONTRACTOR SHALL INSTALL ADDITIONAL U-BOLTS TO THE SUPPORT RAIL CORNER ANGLES SUCH THAT THERE ARE 2 U-BOLTS PER CONNECTION (4 PER CORNER ANGLE).				
		1 3	ELEVATION QUANTITY DESCRIPTION I PROPOSED KICKER KIT (PART #: VZWSMART-PLK5)) 3 PROPOSED 72" LONG, P2 I/2 STD (PART #: VZWSMART-P40-278X072) 73'-9" 9 CROSSOVER PLATE	ELEVATION QUANTITY DESCRIPTION CONTRACTOR TO VERIFY THE LENGTH REQUIRED AND TRIM AS NECESSARY IN ACCORDANCE WITH THE 'STRUCTURAL STEEL' NOTES ON SHEET SGN-1. CONNECT OTHER END OF KICKER KIT TO MONOPOLE COLLAR MOUNT ASSEMBLY (PART #: VZWSMART-PLK7). 3 PROPOSED 72" LONG, P2 1/2 STD (PART #: VZWSMART-P40-278X072) 9 CROSSOVER PLATE CONTRACTOR TO VERIFY THE LENGTH REQUIRED AND TRIM AS NECESSARY IN ACCORDANCE WITH THE 'STRUCTURAL STEEL' NOTES ON SHEET SGN-1. CONNECT OTHER END OF KICKER KIT TO MONOPOLE COLLAR MOUNT ASSEMBLY (PART #: VZWSMART-PLK7). CONNECT NEW MOUNT PIPE TO EXISTING TOP HORIZONTAL WITH CROSSOVER PLATES (SITE PRO 1 - SP219-H). CONTRACTOR SHALL REPLACE ALL EXISTING TOP MOUNT PIPE TO SUPPORT RAIL CONNECTIONS WITH NEW CROSSOVER PLATES (VZWSMART-MSK1). CONTRACTOR SHALL ADJUST SUPPORT RAIL AND CORNER ANGLES AS NEEDED TO BE AGAINST MOUNT PIPES AND MAINTAIN VERTICAL ANTENNA PIPE ORIENTATION. CONTRACTOR SHALL INSTALL ADDITIONAL U-BOLTS TO THE SUPPORT RAIL CORNER ANGLES			

MOUNT MEMBERS NOT SHOW FOR CLARITY U.N.O.
CONTRACTOR SHALL INSTALL THE PROPOSED OVP ON THE EXISTING OVP PIPE ON THE BETA/GAMMA SECTOR STANDOFF. INSTALL THE OVP 12" DOWN FROM THE TOP OF THE PIPE.
THREADED ROD FROM PROPOSED KITS SHALL BE TRIMMED TO EXTEND NO MORE THAN 3" BEYOND THE LOCK NUT. TREAT ALL CUT ENDS WITH (2) COATS OF COLD GALVANIZATION (ZINC KOTE, OR EOR

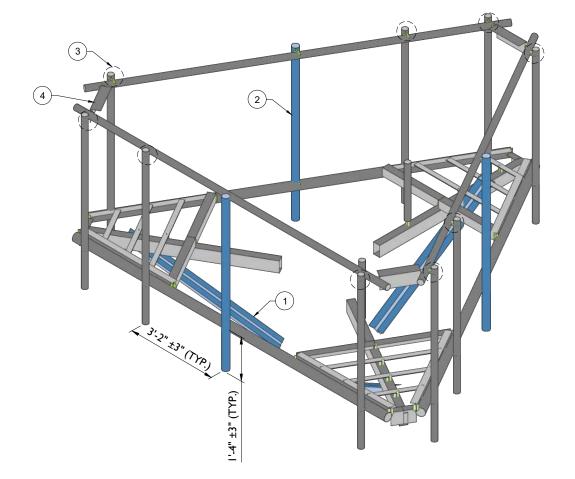

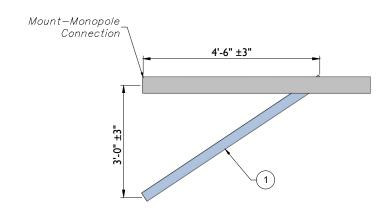

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1	10/02/23	ISSUED FOR CONSTRUCTION	GHW	DX
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MODIFICATION DETAILS

SS-I

PROPOSED ISOMETRIC VIEW



MOUNT PHOTO 1



MOUNT PHOTO 3



MOUNT PHOTO 2



MOUNT PHOTO 4



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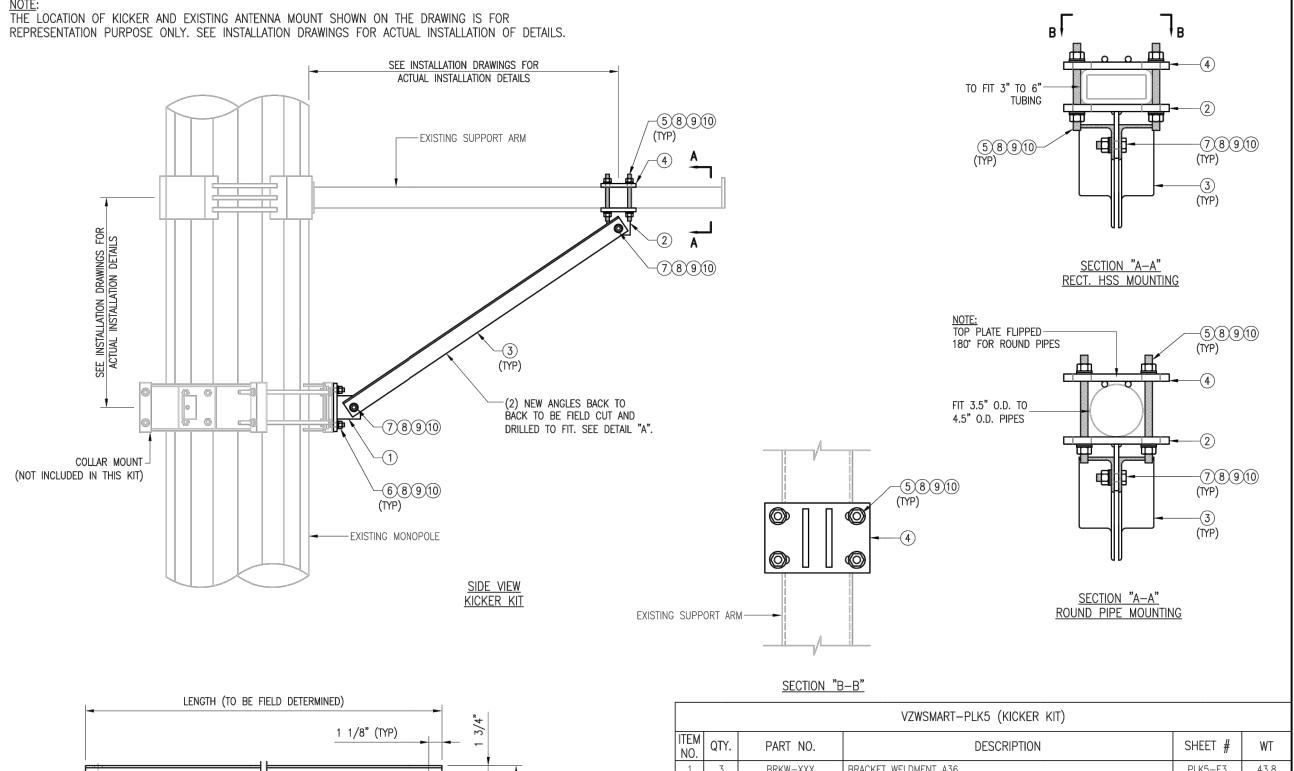
STAMFORD 1055 Washington Bou Stamford, CT 0690

Stamford, CT 0690*
Phone: 203.324.080
COLLIERS ENGINEERING & DESIGN
DOING RUSINESS AS MASER CON

MOUNT PHOTOS

SHEET NUMBER

SS-2



NOTES:

1. ALL HOLES ARE 11/16" DIA. U.N.O

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- 2. HOT-DIPPED GALVANIZED PER ASTM A123.
- 3. FIT UP TO 6" SQ. TUBING OR 4 1/2" O.D. PIPE

DETAIL "A"

-FIELD DRILL

11/16"ø HOLE

			VZWSMART-PLK5 (KICKER KIT)		
ITEM NO.	QTY.	PART NO.	DESCRIPTION	SHEET #	WT
1	3	BRKW-XXX	BRACKET WELDMENT A36	PLK5-F3	43.8
2	3	BRKW-XXXX	BRACKET WELDMENT A36	PLK5-F2	35.7
3	6	L331875-8	L 3" X 3" X 3/16" X 8'-0" A36	PLK5-F4	182.9
4	3	PL-KI	PL 5/8" X 6" X 9" A36	PLK5-F1	29.0
5	12		THREADED ROD 5/8" DIA. X 1'-0" F1554-36 HDG		
6	6		BOLT 5/8" X 2" A325		
7	12		BOLT 5/8" X 2 1/2" A325		
8	42	FW-625	5/8" HDG USS FLAT WASHER		3
9	42	LW-625	5/8" HDG LOCK WASHER		1
10	42	NUT-625	5/8" HDG HEX NUT		5
				GALVANIZED WT	291

VzW SMART Tool[©] Vendor





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SHEET TITLE:

VZWSMART-PLK5 KICKER KIT

SHEET NUMBER:	REV #:
VZWSMART-PLK5	0



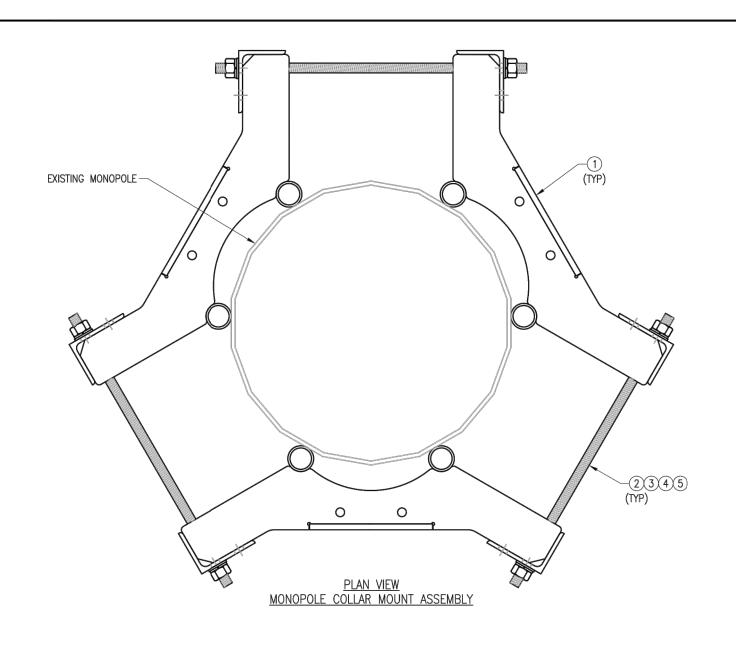

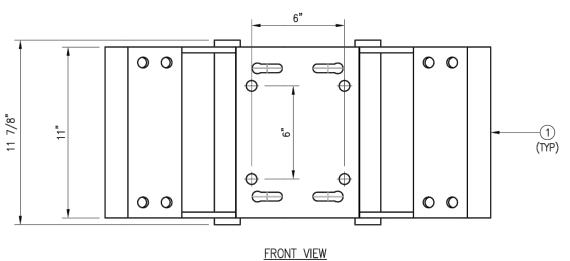VZWSMART-PLK7	(MONOPOLE	COLLAR	MOUNT	ASSEMBLY)
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ITEM NO.	QTY.	PART NO.	DESCRIPTION	SHEET #	WT
1	3	CM-1245	COLLAR MOUNT ASSEMBLY	PLK7-F1	147
2	6		THREADED ROD 5/8" X 4'-0" A193-B7		
3	12	FW-625	5/8" HDG USS FLAT WASHER		1
4	12	LW-625	5/8" HDG LOCK WASHER		0
5	12	NUT-625	5/8" HDG HEX NUT		1
	GALVANIZED WT				150

VzW SMART Tool[©] Vendor



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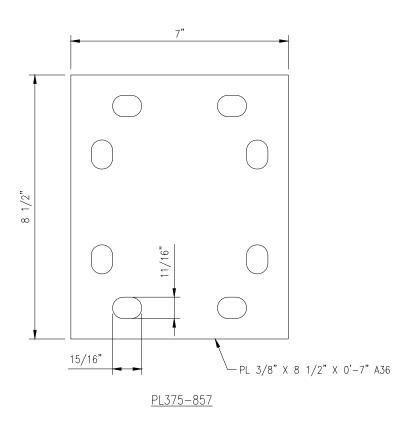
VZWSMART-PLK7 MONOPOLE COLLAR MOUNT ASSEMBLY

SHEET NUMBER:	REV #:
VZWSMART-PLK7	0

NOTES:
1. FIT 12" TO 45" DIA MONOPOLE.

2. HOT—DIPPED GALVANIZED PER ASTM A123.

FITS 2.375" O.D. AND 2.875" O.D. — VERTICAL PIPE. (NOT INCLUDED IN THIS KIT) -2345 -FITS 2.375" O.D. AND 2.875" O.D. HORIZONTAL PIPE. (NOT INCLUDED IN THIS KIT) 2345



	VZWSMART-MSK1 (CROSSOVER PLATE)						
ITEM NO.	QTY.	PART NO.	DESCRIPTION	SHEET #	WT		
1	1	PL375-857	PL 3/8" X 8 1/2" X 0'-7" A36	MSK1-F1	6		
2	4	MS02-625-300-500	RU-BOLT 5/8" X 3" I.W. X 5" I.L. A36 (OR EQUIV.)	RBC-1	5		
3	8	FW-625	5/8" HDG USS FLAT WASHER		1		
4	8	LW-625	5/8" HDG LOCK WASHER		0		
5	8	NUT-625	5/8" HDG HEX NUT		1		
			GA	_VANIZED_WT	14		

VzW SMART Tool® Vendor



DRAWN BY:	CHECKED	BY	: HMA	
REV.	DESCRIPTION		BY	DATE
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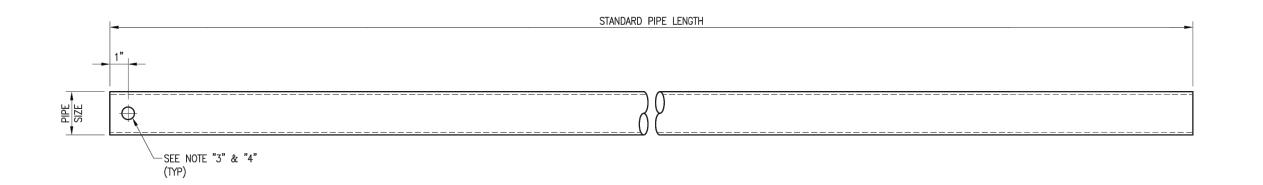
SHEET TITLE:

VZWSMART-MSK1 CROSSOVER PLATE

SHEET NUMBER: REV #: VZWSMART-MSK1

NOTES:

1. HOT-DIPPED GALVANIZED PER ASTM A123.



VZWSMART Standard Pipe				
VZWSMART Number	Length			
P40-238X048	PIPE 2 SCH40 (2.375" OD x 0.154" THK)	48"		
P40-238X072	PIPE 2 SCH40 (2.375" OD x 0.154" THK)	72"		
P40-238X096	PIPE 2 SCH40 (2.375" OD x 0.154" THK)	96"		
P40-238X120	PIPE 2 SCH40 (2.375" OD x 0.154" THK)	120"		
P40-238X126	PIPE 2 SCH40 (2.375" OD x 0.154" THK)	126"		
P40-238X150	PIPE 2 SCH40 (2.375" OD x 0.154" THK)	150"		
P40-238X174	PIPE 2 SCH40 (2.375" OD x 0.154" THK)	174"		
P40-278X048	PIPE 2.5 SCH40 (2.875" OD x 0.203" THK)	48"		
P40-278X072	PIPE 2.5 SCH40 (2.875" OD x 0.203" THK)	72"		
P40-278X096	PIPE 2.5 SCH40 (2.875" OD x 0.203" THK)	96"		
P40-278X120	PIPE 2.5 SCH40 (2.875" OD x 0.203" THK)	120"		
P40-278X126	PIPE 2.5 SCH40 (2.875" OD x 0.203" THK)	126"		
P40-278X150	PIPE 2.5 SCH40 (2.875" OD x 0.203" THK)	150"		
P40-278X174	PIPE 2.5 SCH40 (2.875" OD x 0.203" THK)	174"		
P40-312X048	PIPE 3 SCH40 (3.5" OD x 0.216" THK)	48"		
P40-312X072	PIPE 3 SCH40 (3.5" OD x 0.216" THK)	72"		
P40-312X126	PIPE 3 SCH40 (3.5" OD x 0.216" THK)	126"		
P40-312X150	PIPE 3 SCH40 (3.5" OD x 0.216" THK)	150"		
P40-312X174	PIPE 3 SCH40 (3.5" OD x 0.216" THK)	174"		

NOTE:
APPROVED SMART KIT VENDORS ARE ALLOWED TO SUBSTITUTE AT THEIR DISCRETION PIPES LISTED ON THIS PAGE FOR CUSTOM LENGTH COMPONENTS OF MATCHING SIZE. SUBSTITUTIONS SHALL MEET THE ORIGINAL STRUCTURAL INTENT.

- NOTES:
 1. ALL PIPE GRADE A53-B OR BETTER.
- 2. HOT-DIPPED GALVANIZED PER ASTM A123.
- 3. ALL HOLES ARE 11/16" DIA. U.N.O
- 4. HOLES MAY OR MAY NOT BE PRESENT, DEPEND UPON MANUFACTURE DISCRETION.
- 5. ALL FIELD CUT AND DRILLED SURFACES SHALL BE REPAIRED WITH A MINIMUM OF TWO COATS OF ZINGA OR ZINC COTE PER ASTM A780 AND MANUFACTURER'S RECOMMENDATIONS.

VzWSMART Tool® Vendor


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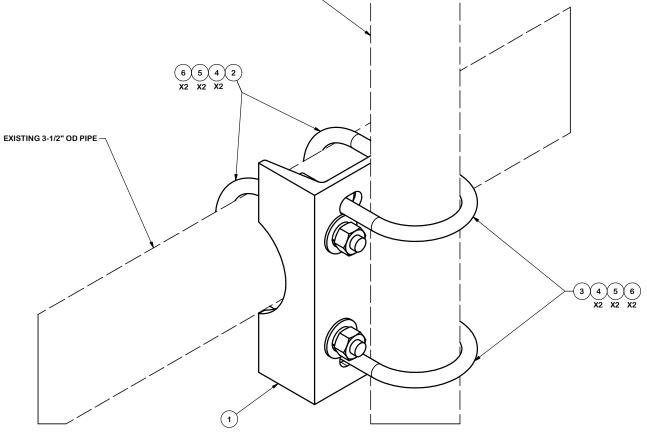
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EV. DESCRIPTION SIRST ISSUE		BY BT	DATE 08/04/2
HEET TITLE:			


VZWSMART STANDARD PIPE

SHEET NUMBER: VZWSMART-PIPE

REV #:



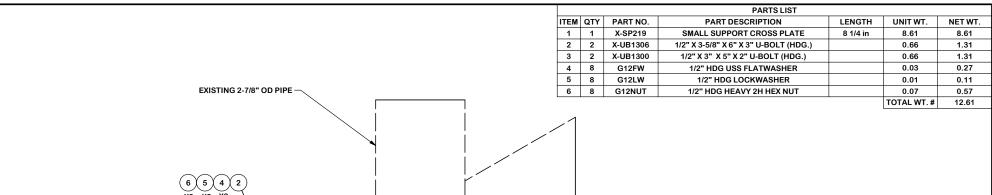

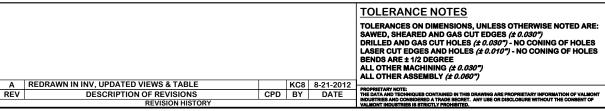

DESCRIPTION 2-7/8" TO 3-1/2"

PIPE MOUNT ASSEMBLY



Engineering Support Team: 1-888-753-7446

Locations: New York, NY Atlanta, GA Los Angeles, CA Plymouth, IN Salem, OR Dallas, TX

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