

ATC SITE NAME: MADISON CT
ATC SITE NUMBER: 283421
VERIZON SITE NAME: MADISON 5 CT
VERIZON SITE NUMBER: 467699
SITE ADDRESS: 15 ORCHARD PARK ROAD
MADISON, CT 06443-2268



VERIZON UPGRADE-RRH ANTENNA AMENDMENT DRAWINGS

COMPLIANCE CODE	PROJECT SUMMARY	PROJECT DESCRIPTION	SHEET INDEX					
<p>ALL WORK SHALL BE PERFORMED AND MATERIALS INSTALLED IN ACCORDANCE WITH THE CURRENT EDITIONS OF THE FOLLOWING CODES AS ADOPTED BY THE LOCAL GOVERNMENT AUTHORITIES. NOTHING IN THESE PLANS IS TO BE CONSTRUED TO PERMIT WORK NOT CONFORMING TO THESE CODES.</p> <ol style="list-style-type: none"> 1. 2022 CONNECTICUT STATE BUILDING CODE-AMENDMENTS TO IBC 2021 2. INTERNATIONAL BUILDING CODE 2015, INTERNATIONAL CODE COUNCIL 3. TIA-222-G-4, STRUCTURAL STANDARD FOR ANTENNA SUPPORTING STRUCTURES AND ANTENNAS 4. ASCE 7-10 MINIMUM DESIGN LOADS FOR BUILDINGS AND OTHER STRUCTURES, AMERICAN SOCIETY OF CIVIL ENGINEERS 5. STEEL CONSTRUCTION MANUAL 14TH EDITION, AMERICAN INSTITUTE OF STEEL CONSTRUCTION 6. CITY/COUNTY ORDINANCES 	<p><u>SITE ADDRESS:</u> 15 ORCHARD PARK ROAD MADISON, CT 06443-2268 <u>COUNTY:</u> NEW HAVEN <u>GEOGRAPHIC COORDINATES:</u> LATITUDE: 41.28308333 LONGITUDE: -72.623075 <u>GROUND ELEVATION:</u> 20' AMSL</p>	<p>THE PROPOSED PROJECT INCLUDES MODIFYING GROUND BASED AND TOWER MOUNTED EQUIPMENT AS INDICATED PER BELOW:</p> <p><u>TOWER WORK:</u> REMOVE (12) ANTENNA(s), (9) RRU(s) AND (2) OVP(s) INSTALL MOUNT MODIFICATION(s), (3) SBS MOUNT(s), (12) ANTENNA(s), (6) RRU(s), (1) OVP(s) AND (2) FIBER CABLE(s)</p> <p><u>PROJECT NOTES</u></p> <p>1. THE FACILITY IS UNMANNED. 2. A TECHNICIAN WILL VISIT THE SITE APPROXIMATELY ONCE A MONTH FOR ROUTINE INSPECTION AND MAINTENANCE. 3. THE PROJECT WILL NOT RESULT IN ANY SIGNIFICANT LAND DISTURBANCE OR EFFECT OF STORM WATER DRAINAGE. 4. NO SANITARY SEWER, POTABLE WATER OR TRASH DISPOSAL IS REQUIRED. 5. HANDICAP ACCESS IS NOT REQUIRED. 6. THE PROJECT DEPICTED IN THESE PLANS QUALIFIES AS AN ELIGIBLE FACILITIES REQUEST ENTITLED TO EXPEDITED REVIEW UNDER 47 U.S.C. § 1455(A) AS A MODIFICATION OF AN EXISTING WIRELESS TOWER THAT INVOLVES THE COLLOCATION, REMOVAL, AND/OR REPLACEMENT OF TRANSMISSION EQUIPMENT THAT IS NOT A SUBSTANTIAL CHANGE UNDER CFR § 1.6100 (B)(7).</p> <p><u>PROJECT TEAM</u></p> <p><u>TOWER OWNER:</u> AMERICAN TOWER 10 PRESIDENTIAL WAY WOBURN, MA 01801 <u>APPLICANT:</u> VERIZON WIRELESS 51 ALDER STREET MEDWAY, MA 02053 <u>ENGINEER:</u> DEWBERRY ENGINEERS, INC. 99 SUMMER STREET SUITE 700 BOSTON, MA 02110 <u>PROPERTY OWNER:</u> 15 ORCHARD PARK ROAD LLC 15 ORCHARD PARK ROAD - MADISON - CT - 06443</p>	<p>SHEET NO:</p> <p>G-001</p> <p>G-002</p> <p>C-101</p> <p>C-201</p> <p>C-401</p> <p>C-501</p> <p>E-501</p> <p>R-601</p> <p>R-602</p> <p>R-603</p>	<p>DESCRIPTION:</p> <p>TITLE SHEET</p> <p>GENERAL NOTES</p> <p>DETAILED SITE PLAN</p> <p>TOWER ELEVATION</p> <p>ANTENNA INFORMATION & SCHEDULE</p> <p>CONSTRUCTION DETAILS</p> <p>GROUNDING DETAILS</p> <p>SUPPLEMENTAL</p> <p>SUPPLEMENTAL</p> <p>SUPPLEMENTAL</p>	<p>REV:</p> <p>1</p> <p>1</p> <p>1</p> <p>1</p> <p>1</p> <p>1</p> <p>1</p> <p>1</p> <p>1</p>	<p>DATE:</p> <p>01/09/24</p> <p>01/09/24</p> <p>01/09/24</p> <p>01/09/24</p> <p>01/09/24</p> <p>01/09/24</p> <p>01/09/24</p> <p>01/09/24</p> <p>01/09/24</p>	<p>BY:</p> <p>VL</p> <p>VL</p> <p>VL</p> <p>VL</p> <p>VL</p> <p>VL</p> <p>VL</p> <p>VL</p> <p>VL</p>	
UTILITY COMPANIES			MOUNT MOD DRAWINGS (11 PAGES)					
POWER COMPANY: EVERSOURCE PHONE: (877) 659-6326								
TELEPHONE COMPANY: FRONTIER COMMUNICATIONS PHONE: (877) 641-3250								
 Know what's below. Call before you dig.								

REV.	DESCRIPTION	BY	DATE
A	PRELIM	ZP	06/17/21
0	FINAL	SL	03/14/23
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verizon

DATE DRAWN: 06/17/21
ATC JOB NO: 13684191
CUSTOMER ID: MADISON 5 CT
CUSTOMER #: 467699

TITLE SHEET

SHEET NUMBER: G-001
REVISION: 1



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GENERAL CONSTRUCTION NOTES:

- OWNER FURNISHED MATERIALS, VERIZON "THE COMPANY" WILL PROVIDE AND THE CONTRACTOR WILL INSTALL
 - BTS EQUIPMENT FRAME (PLATFORM) AND ICEBRIDGE SHELTER (GROUND BUILD/CO-LOCATE ONLY)
 - AC/TELCO INTERFACE BOX (PPC)
 - ICE BRIDGE (CABLE TRAY WITH COVER) (GROUND BUILD/CO-LOCATE ONLY, GC TO FURNISH AND INSTALL FOR ROOFTOP INSTALLATION)
 - TOWERS, MONOPOLES
 - TOWER LIGHTING
 - GENERATORS & LIQUID PROPANE TANK
 - ANTENNA STANDARD BRACKETS, FRAMES AND PIPES FOR MOUNTING
 - ANTENNAS (INSTALLED BY OTHERS)
 - TRANSMISSION LINE
 - TRANSMISSION LINE JUMPERS
 - TRANSMISSION LINE CONNECTORS WITH WEATHERPROOFING KITS
 - TRANSMISSION LINE GROUND KITS
 - HANGERS
 - HOISTING GRIPS
 - BTS EQUIPMENT
- THE CONTRACTOR IS RESPONSIBLE TO PROVIDE ALL OTHER MATERIALS FOR THE COMPLETE INSTALLATION OF THE SITE INCLUDING, BUT NOT LIMITED TO, SUCH MATERIALS AS FENCING, STRUCTURAL STEEL SUPPORTING SUB-FRAME FOR PLATFORM, ROOFING LABOR AND MATERIALS, GROUNDRING RINGS, GROUNDRING WIRES, COPPER-CLAD OR XIT CHEMICAL GROUND ROD(S), BUSS BARS, TRANSFORMERS AND DISCONNECT SWITCHES WHERE APPLICABLE, TEMPORARY ELECTRICAL POWER, CONDUIT, LANDSCAPING, COMPOUND STONE, CRANES, CORE DRILLING, SLEEPERS AND RUBBER MATTING, REBAR, CONCRETE CAISSENS, PADS AND/OR AUGER MOUNTS, MISCELLANEOUS FASTENERS, CABLE TRAYS, NON-STANDARD ANTENNA FRAMES AND ALL OTHER MATERIAL AND LABOR REQUIRED TO COMPLETE THE JOB ACCORDING TO THE DRAWINGS AND SPECIFICATIONS. IT IS THE POSITION OF VERIZON TO APPLY FOR PERMITTING AND CONTRACTOR RESPONSIBLE FOR PICKUP AND PAYMENT OF REQUIRED PERMITS.
- ALL WORK SHALL CONFORM TO ALL CURRENT APPLICABLE FEDERAL, STATE, AND LOCAL CODES, INCLUDING ANSI/EIA/TIA-222, AND COMPLY WITH ATC CONSTRUCTION SPECIFICATIONS.
- CONTRACTOR SHALL CONTACT LOCAL 811 FOR IDENTIFICATION OF UNDERGROUND UTILITIES PRIOR TO START OF CONSTRUCTION.
- CONTRACTOR SHALL BE RESPONSIBLE FOR COORDINATING ALL REQUIRED INSPECTIONS.
- ALL DIMENSIONS TO, OF, AND ON EXISTING BUILDINGS, DRAINAGE STRUCTURES, AND SITE IMPROVEMENTS SHALL BE VERIFIED IN FIELD BY CONTRACTOR WITH ALL DISCREPANCIES REPORTED TO THE ENGINEER.
- DO NOT CHANGE SIZE OR SPACING OF STRUCTURAL ELEMENTS.
- DETAILS SHOWN ARE TYPICAL; SIMILAR DETAILS APPLY TO SIMILAR CONDITIONS UNLESS OTHERWISE NOTED.
- THESE DRAWINGS DO NOT INCLUDE NECESSARY COMPONENTS FOR CONSTRUCTION SAFETY WHICH SHALL BE THE SOLE RESPONSIBILITY OF THE CONTRACTOR.
- CONTRACTOR SHALL BRACE STRUCTURES UNTIL ALL STRUCTURAL ELEMENTS NEEDED FOR STABILITY ARE INSTALLED. THESE ELEMENTS ARE AS FOLLOWS: LATERAL BRACING, ANCHOR BOLTS, ETC.
- CONTRACTOR SHALL DETERMINE EXACT LOCATION OF EXISTING UTILITIES, GROUNDS DRAINS, DRAIN PIPES, VENTS, ETC. BEFORE COMMENCING WORK.
- INCORRECTLY FABRICATED, DAMAGED, OR OTHERWISE MISFITTING OR NONCONFORMING MATERIALS OR CONDITIONS SHALL BE REPORTED TO THE VERIZON REP PRIOR TO REMEDIAL OR CORRECTIVE ACTION. ANY SUCH REMEDIAL ACTION SHALL REQUIRE WRITTEN APPROVAL BY THE VERIZON REP PRIOR TO PROCEEDING.
- EACH CONTRACTOR SHALL COOPERATE WITH THE VERIZON REP, AND COORDINATE HIS WORK WITH THE WORK OF OTHERS.
- CONTRACTOR SHALL REPAIR ANY DAMAGE CAUSED BY CONSTRUCTION OF THIS PROJECT TO MATCH EXISTING PRE-CONSTRUCTION CONDITIONS TO THE SATISFACTION OF THE VERIZON CONSTRUCTION MANAGER.
- ALL CABLE/CONDUIT ENTRY/EXIT PORTS SHALL BE WEATHERPROOFED DURING INSTALLATION USING A SILICONE SEALANT.
- WHERE EXISTING CONDITIONS DO NOT MATCH THOSE SHOWN IN THIS PLAN SET, CONTRACTOR SHALL NOTIFY THE VERIZON REP AND ENGINEER OF RECORD IMMEDIATELY.
- CONTRACTOR SHALL ENSURE ALL SUBCONTRACTORS ARE PROVIDED WITH A COMPLETE AND CURRENT SET OF DRAWINGS AND SPECIFICATIONS FOR THIS PROJECT.
- CONTRACTOR SHALL REMOVE ALL RUBBISH AND DEBRIS FROM THE SITE AT THE END OF EACH DAY.
- CONTRACTOR SHALL COORDINATE WORK SCHEDULE WITH AMERICAN TOWER CORPORATION (ATC) AND TAKE PRECAUTIONS TO MINIMIZE IMPACT AND DISRUPTION OF OTHER OCCUPANTS OF THE FACILITY.
- CONTRACTOR SHALL FURNISH VERIZON AND AMERICAN TOWER CORPORATION (ATC) WITH A PDF MARKED UP AS-BUILT SET OF DRAWINGS UPON COMPLETION OF WORK.
- PRIOR TO SUBMISSION OF BID, CONTRACTOR SHALL COORDINATE WITH VERIZON REP TO DETERMINE WHAT, IF ANY, ITEMS WILL BE PROVIDED. ALL ITEMS NOT PROVIDED SHALL BE PROVIDED AND INSTALLED BY THE CONTRACTOR. CONTRACTOR WILL INSTALL ALL ITEMS PROVIDED.

- PRIOR TO SUBMISSION OF BID, CONTRACTOR SHALL COORDINATE WITH VERIZON REP TO DETERMINE IF ANY PERMITS WILL BE OBTAINED BY CONTRACTOR. ALL REQUIRED PERMITS NOT OBTAINED BY VERIZON MUST BE OBTAINED, AND PAID FOR, BY THE CONTRACTOR.
- CONTRACTOR SHALL INSTALL ALL SITE SIGNAGE IN ACCORDANCE WITH VERIZON SPECIFICATIONS AND REQUIREMENTS.
- CONTRACTOR SHALL SUBMIT ALL SHOP DRAWINGS TO VERIZON FOR REVIEW AND APPROVAL PRIOR TO FABRICATION.
- ALL EQUIPMENT SHALL BE INSTALLED ACCORDING TO MANUFACTURER'S SPECIFICATIONS AND LOCATED ACCORDING TO VERIZON SPECIFICATIONS, AND AS SHOWN IN THESE PLANS.
- THE CONTRACTOR SHALL SUPERVISE AND DIRECT THE PROJECT DESCRIBED HEREIN. THE CONTRACTOR SHALL BE SOLELY RESPONSIBLE FOR ALL THE CONSTRUCTION MEANS, METHODS, TECHNIQUES, SEQUENCES AND PROCEDURES AND FOR COORDINATING ALL PORTIONS OF THE WORK UNDER THE CONTRACT.
- CONTRACTOR SHALL NOTIFY VERIZON REP A MINIMUM OF 48 HOURS IN ADVANCE OF POURING CONCRETE OR BACKFILLING ANY UNDERGROUND UTILITIES, FOUNDATIONS OR SEALING ANY WALL, FLOOR OR ROOF PENETRATIONS FOR ENGINEERING REVIEW AND APPROVAL.
- CONTRACTOR SHALL BE RESPONSIBLE FOR SITE SAFETY INCLUDING COMPLIANCE WITH ALL APPLICABLE OSHA STANDARDS AND RECOMMENDATIONS AND SHALL PROVIDE ALL NECESSARY SAFETY DEVICES INCLUDING PPE AND PPM AND CONSTRUCTION DEVICES SUCH AS WELDING AND FIRE PREVENTION, TEMPORARY SHORING, SCAFFOLDING, TRENCH BOXES/SLOPING, BARRIERS, ETC.
- THE CONTRACTOR SHALL PROTECT AT HIS OWN EXPENSE, ALL EXISTING FACILITIES AND SUCH OF HIS NEW WORK LIABLE TO INJURY DURING THE CONSTRUCTION PERIOD. ANY DAMAGE CAUSED BY NEGLECT ON THE PART OF THIS CONTRACTOR OR HIS REPRESENTATIVES, OR BY THE ELEMENTS DUE TO NEGLECT ON THE PART OF THIS CONTRACTOR OR HIS REPRESENTATIVES, EITHER TO THE EXISTING WORK, OR TO HIS WORK OR THE WORK OF ANY OTHER CONTRACTOR, SHALL BE REPAIRED AT HIS EXPENSE TO THE OWNER'S SATISFACTION.
- ALL WORK SHALL BE INSTALLED IN A FIRST CLASS, NEAT AND WORKMANLIKE MANNER BY MECHANICS SKILLED IN THE TRADE INVOLVED. THE QUALITY OF WORKMANSHIP SHALL BE SUBJECT TO THE APPROVAL OF THE VERIZON REP. ANY WORK FOUND BY THE VERIZON REP TO BE OF INFERIOR QUALITY AND/OR WORKMANSHIP SHALL BE REPLACED AND/OR REWORKED AT CONTRACTOR EXPENSE UNTIL APPROVAL IS OBTAINED.
- IN ORDER TO ESTABLISH STANDARDS OF QUALITY AND PERFORMANCE, ALL TYPES OF MATERIALS LISTED HEREINAFTER BY MANUFACTURER'S NAMES AND/OR MANUFACTURER'S CATALOG NUMBER SHALL BE PROVIDED BY THESE MANUFACTURERS AS SPECIFIED.
- VERIZON FURNISHED EQUIPMENT SHALL BE PICKED-UP AT THE VERIZON WAREHOUSE, NO LATER THAN 48HR AFTER BEING NOTIFIED INSURED, STORED, UNCRATE, PROTECTED AND INSTALLED BY THE CONTRACTOR WITH ALL APPURTENANCES REQUIRED TO PLACE THE EQUIPMENT IN OPERATION, READY FOR USE. THE CONTRACTOR SHALL BE RESPONSIBLE FOR THE EQUIPMENT AFTER PICKING IT UP.
- VERIZON OR HIS ARCHITECT/ENGINEER RESERVES THE RIGHT TO REJECT ANY EQUIPMENT OR MATERIALS WHICH, IN HIS OWN OPINION ARE NOT IN COMPLIANCE WITH THE CONTRACT DOCUMENTS, EITHER BEFORE OR AFTER INSTALLATION AND THE EQUIPMENT SHALL BE REPLACED WITH EQUIPMENT CONFORMING TO THE REQUIREMENTS OF THE CONTRACT DOCUMENTS BY THE CONTRACTOR AT NO COST TO VERIZON OR THEIR ARCHITECT/ENGINEER.

SPECIAL CONSTRUCTION

ANTENNA INSTALLATION NOTES:

- WORK INCLUDED:
 - ANTENNA AND COAXIAL CABLES ARE FURNISHED BY VERIZON UNDER A SEPARATE CONTRACT. THE CONTRACTOR SHALL ASSIST ANTENNA INSTALLATION CONTRACTOR IN TERMS OF COORDINATION AND SITE ACCESS. ERECTION SUBCONTRACTOR SHALL BE RESPONSIBLE FOR THE PROTECTION OF PERSONNEL AND
 - INSTALL ANTENNA AS INDICATE ON DRAWINGS AND VERIZON SPECIFICATIONS.
 - INSTALL GALVANIZED STEEL ANTENNA MOUNTS AS INDICATED ON DRAWINGS
 - INSTALL FURNISHED GALVANIZED STEEL OR ALUMINUM WAVEGUIDE AND PROVIDE PRINTOUT OF THAT TEST.
 - CONTRACTOR SHALL PROVIDE FOUR (4) SETS OF SWEEP TESTS USING ANRITZU-PACKARD 8713B RF SCALAR NETWORK ANALYZER. SUBMIT FREQUENCY DOMAIN REFLECTOMETER(FDR) TESTS RESULTS TO THE PROJECT MANAGER. SWEEP TESTS SHALL BE AS PER ATTACHED RFS "MINIMUM FIELD TESTING RECOMMENDED FOR ANTENNA AND HELIAX COAXIAL CABLE SYSTEMS" DATED 10/5/93. TESTING SHALL BE PERFORMED BY AN INDEPENDENT TESTING SERVICE AND BE BOUND AND SUBMITTED WITHIN ONE WEEK OF WORK COMPLETION.
 - INSTALL COAXIAL CABLES AND TERMINATING BETWEEN ANTENNAS AND EQUIPMENT PER MANUFACTURER'S RECOMMENDATIONS. WEATHERPROOF ALL CONNECTIONS BETWEEN THE ANTENNA AND EQUIPMENT PER MANUFACTURER'S REQUIREMENTS. TERMINATE ALL COAXIAL CABLE THREE (3) FEET IN EXCESS OF ENTRY PORT LOCATION UNLESS OTHERWISE STATED.
 - ANTENNA AND COAXIAL CABLE GROUNDING:
- ALL EXTERIOR #6 GROUND WIRE "DAISY CHAIN" CONNECTIONS ARE TO BE WEATHER SEALED WITH RFS CONNECTORS/SPICE WEATHERPROOFING KIT #221213 OR EQUAL.
- ALL COAXIAL CABLE GROUNDING KITS ARE TO BE INSTALLED ON STRAIGHT RUNS OF COAXIAL CABLE (NOT WITHIN BENDS)

STRUCTURAL STEEL NOTES:

- STRUCTURAL STEEL SHALL CONFORM TO THE LATEST EDITION OF THE AISC "SPECIFICATION FOR THE DESIGN, FABRICATION AND ERECTION OF STRUCTURAL STEEL FOR BUILDINGS."
- STRUCTURAL STEEL ROLLED SHAPES, PLATES AND BARS SHALL CONFORM TO THE FOLLOWING ASTM DESIGNATIONS:
 - ASTM A-572, GRADE 50 - ALL W SHAPES, UNLESS NOTED OR A992 OTHERWISE
 - ASTM A-36 - ALL OTHER ROLLED SHAPES, PLATES AND BARS UNLESS NOTED OTHERWISE.
 - ASTM A-500, GRADE B - HSS SECTION (SQUARE, RECTANGULAR, AND ROUND)
 - ASTM A-325, TYPE SC OR N - ALL BOLTS FOR CONNECTING STRUCTURAL MEMBERS
 - ASTM F-1554 07 - ALL ANCHOR BOLTS, UNLESS NOTED OTHERWISE
- ALL EXPOSED STRUCTURAL STEEL MEMBERS SHALL BE HOT-DIPPED GALVANIZED AFTER FABRICATION PER ASTM A123. EXPOSED STEEL HARDWARE AND ANCHOR BOLTS SHALL BE GALVANIZED PER ASTM A153 OR B695.
- ALL FIELD CUT SURFACES, FIELD DRILLED HOLES AND GROUND SURFACES WHERE EXISTING PAINT OR GALVANIZATION REMOVAL WAS REQUIRED SHALL BE REPAIRED WITH (2) BRUSHED COATS OF ZRC GALVILITE COLD GALVANIZING COMPOUND PER ASTM A780 AND MANUFACTURER'S RECOMMENDATIONS.
- DO NOT DRILL HOLES THROUGH STRUCTURAL STEEL MEMBERS EXCEPT AS SHOWN AND DETAILED ON STRUCTURAL DRAWINGS.
- CONNECTIONS:
 - ALL WELDING TO BE PERFORMED BY AWS CERTIFIED WELDERS AND CONDUCTED IN ACCORDANCE WITH THE LATEST EDITION OF THE AWS WELDING CODE D1.1.

ALL DISCREPANCIES FROM WHAT IS SHOWN ON THESE CONSTRUCTION DRAWINGS SHALL BE COMMUNICATED TO ATC ENGINEERING IMMEDIATELY FOR CORRECTION OR RE-DESIGN. FAILURE TO COMMUNICATE DIRECTLY WITH ATC ENGINEERING OR ANY CHANGES FROM THE DESIGN CONDUCTED WITHOUT PRIOR APPROVAL FROM ATC ENGINEERING SHALL BE THE SOLE RESPONSIBILITY OF THE GENERAL CONTRACTOR.



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SEAL:



verizon®

DATE DRAWN: 06/17/21
ATC JOB NO: 13684191
CUSTOMER ID: MADISON 5 CT
CUSTOMER #: 467699


GENERAL NOTES

SHEET NUMBER: G-002
REVISION: 1

SITE PLAN NOTES:

1. THIS SITE PLAN REPRESENTS THE BEST PRESENT KNOWLEDGE AVAILABLE TO THE ENGINEER AT THE TIME OF THIS DESIGN. THE CONTRACTOR SHALL VISIT THE SITE PRIOR TO CONSTRUCTION AND VERIFY ALL EXISTING CONDITIONS RELATED TO THE SCOPE OF WORK FOR THIS PROJECT.
2. ICE BRIDGE, CABLE LADDER, COAX PORT, AND COAX CABLE ARE SHOWN FOR REFERENCE ONLY. CONTRACTOR SHALL CONFIRM THE EXACT LOCATION OF ALL PROPOSED AND EXISTING EQUIPMENT AND STRUCTURES DEPICTED ON THIS PLAN. BEFORE UTILIZING EXISTING CABLE SUPPORTS, COAX PORTS, INSTALLING NEW PORTS OR ANY OTHER EQUIPMENT, CONTRACTOR SHALL VERIFY ALL ASPECTS OF THE COMPONENTS MEET THE ATC SPECIFICATIONS.
3. THIS PROJECT INCLUDES NO INSTALL OR MODIFICATION AT GRADE.

LEGEND	
ATS	GROUNDING TEST WELL
B	AUTOMATIC TRANSFER SWITCH
CSC	BOLLARD
D	CELL SITE CABINET
E	DISCONNECT
F	ELECTRICAL
GEN	FIBER
G	GENERATOR
HH, V	GENERATOR RECEPTACAL
IB	HAND HOLE, VAULT
ICE	ICE BRIDGE
K	KENTROX BOX
LC	LIGHTING CONTROL
M	METER
PB	PULL BOX
PP	POWER POLE
T	TELCO
TRN	TRANSFORMER
— x —	CHAINLINK FENCE

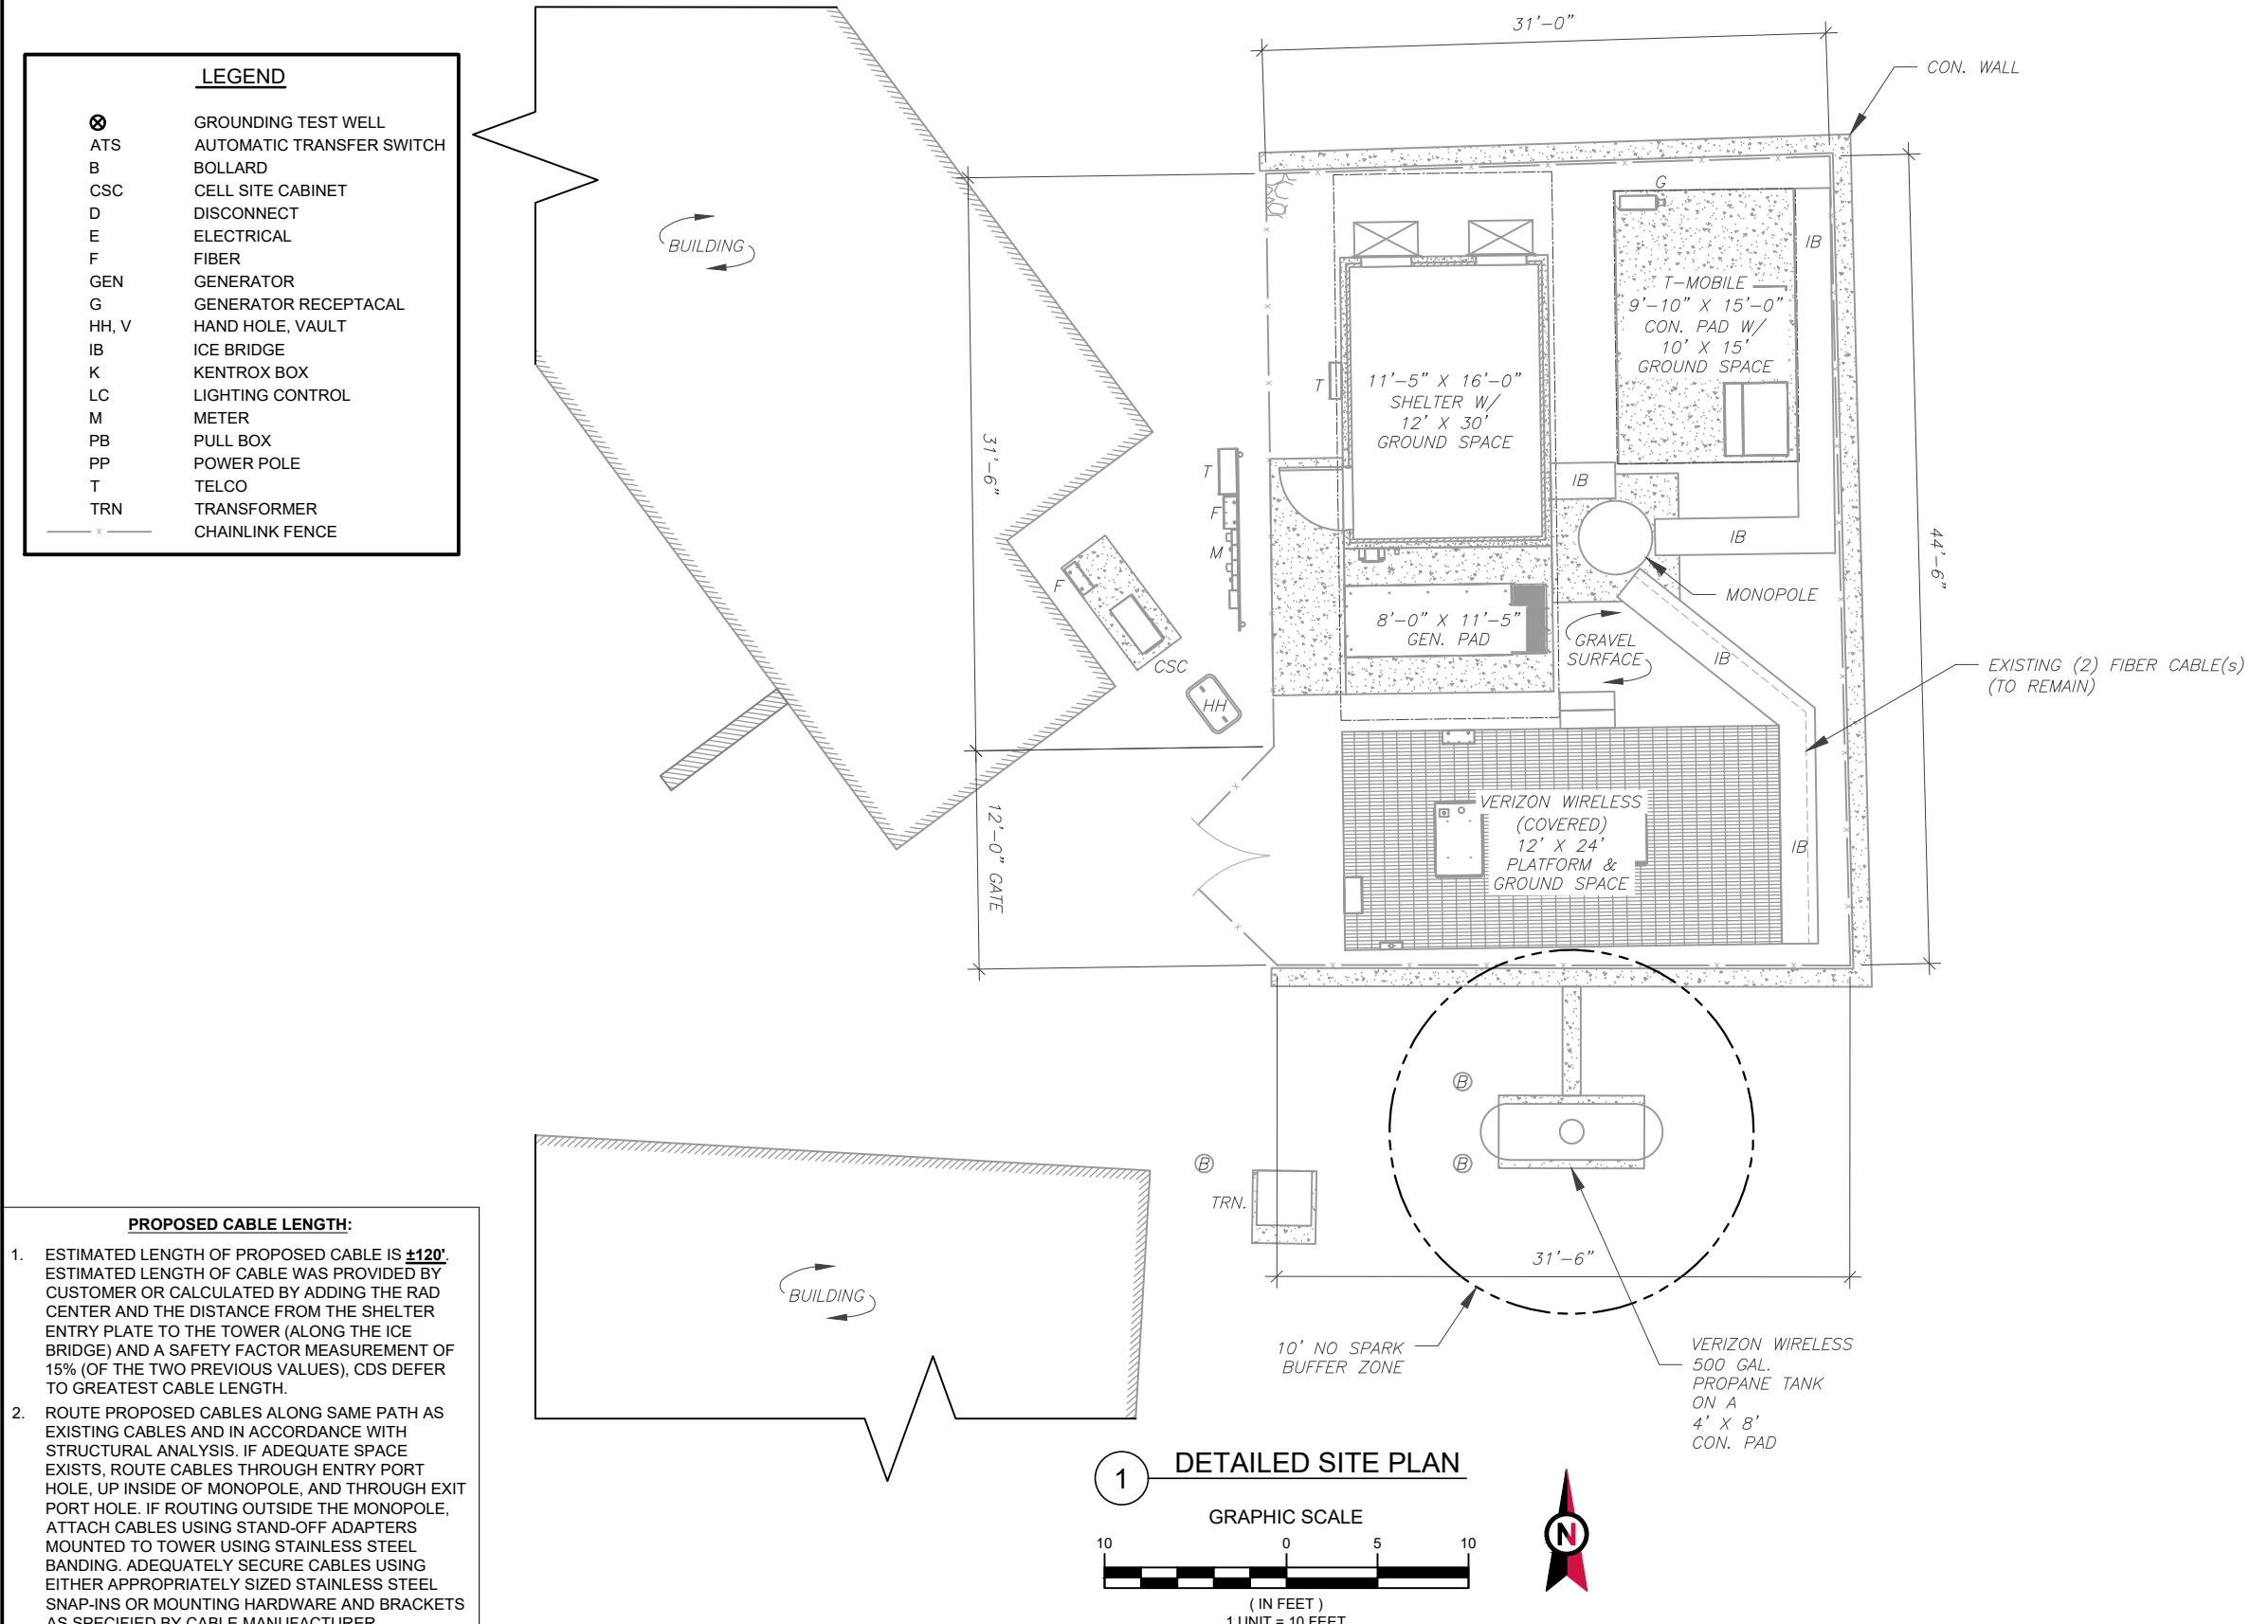

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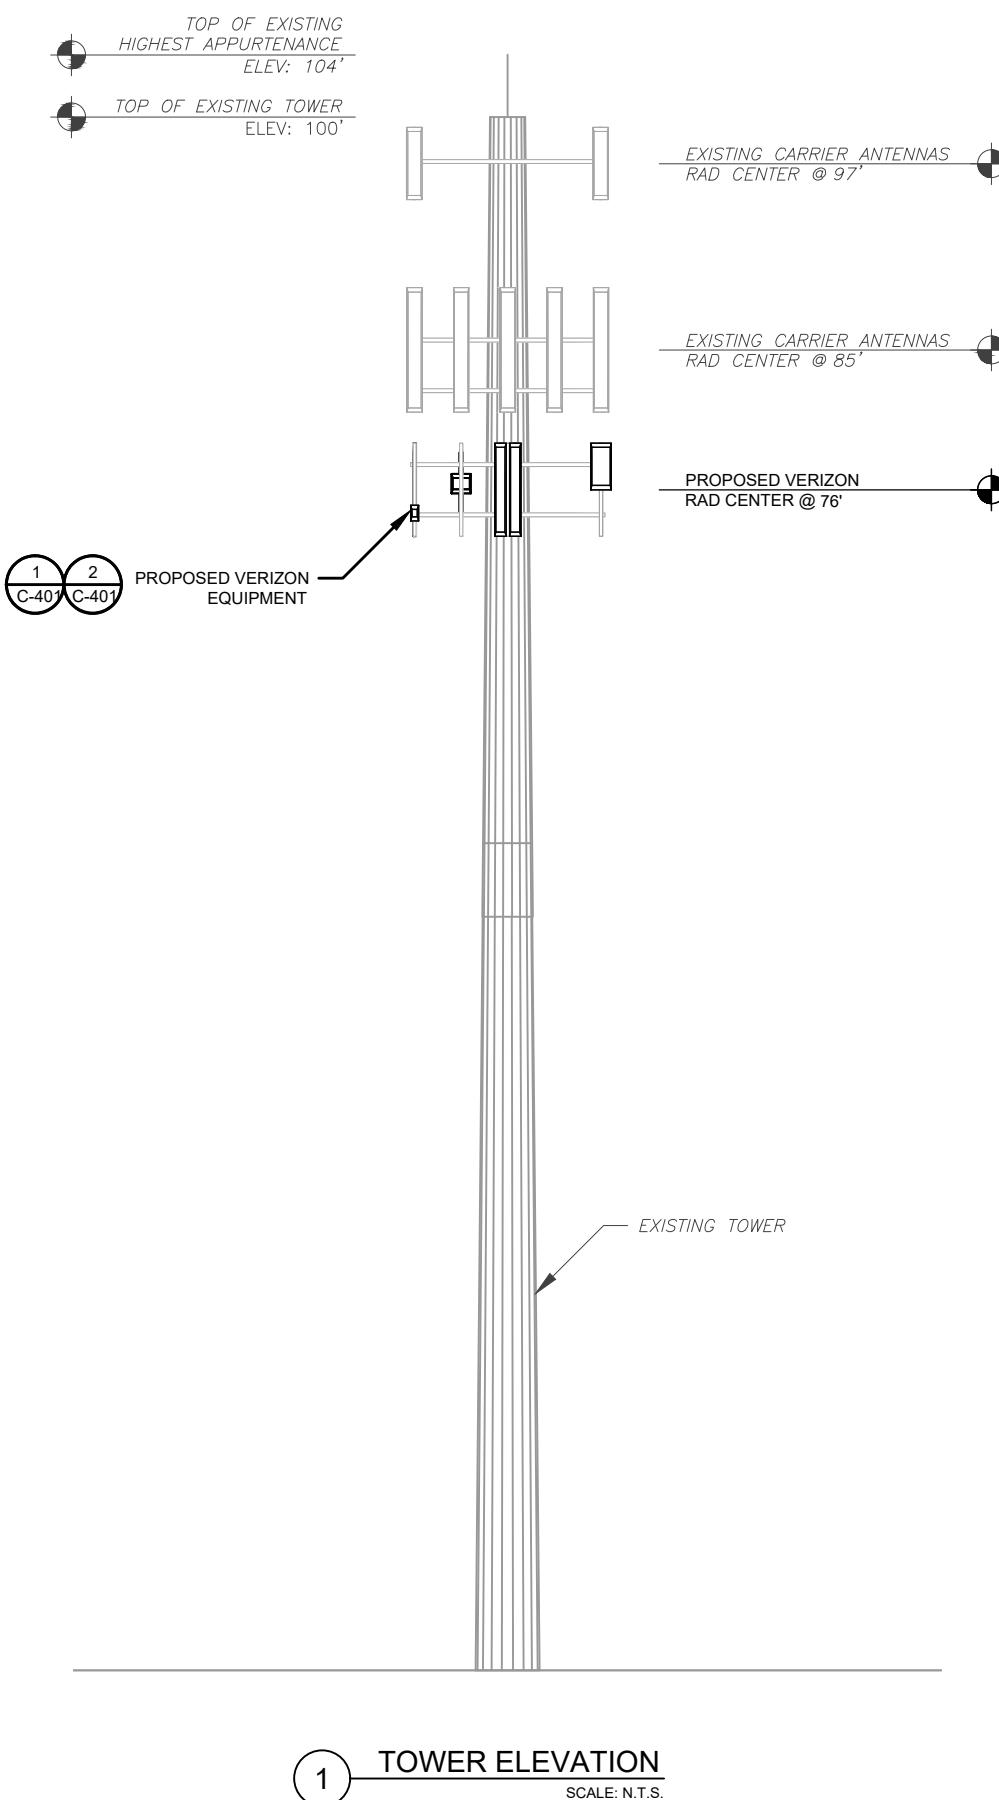


verizon

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DETAILED SITE PLAN

SHEET NUMBER: C-101 REVISION: 1



PER MOUNT ANALYSIS COMPLETED BY COLLIER'S ENGINEERING & DESIGN, DATED 10/10/23, THE EXISTING MOUNT MUST BE MODIFIED TO ADEQUATELY SUPPORT THE PROPOSED LOADING. THE MOUNT MODIFICATION DETAILED AT THE END OF THIS PLAN SET, MUST BE INSTALLED PRIOR TO THE INSTALLATION OF THE PROPOSED ANTENNAS AND OTHER EQUIPMENT.



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TOWER ELEVATION

SHEET NUMBER:
C-201

REVISION:
1


TOWER NOTE:

1. IT IS THE CONTRACTOR'S RESPONSIBILITY TO CONFIRM WITH THE PROJECT MANAGER THAT THEY HAVE THE MOST RECENT VERSION OF THE STRUCTURAL ANALYSIS BEFORE COMMENCING WORK. EXISTING AND PROPOSED TOWER APPURTENANCES, MOUNTS, AND ANTENNAS ARE SHOWN BASED ON THE STRUCTURAL ANALYSIS.
2. WHERE APPLICABLE, ALL NEW ANTENNAS, EQUIPMENT, MOUNTS, CABLING, ETC. SHALL BE PAINTED/SOCKED TO MATCH EXISTING EQUIPMENT IN ACCORDANCE WITH FAA, JURISDICTION, AND/OR OTHER LOCAL REQUIREMENTS.
3. ROUTE PROPOSED CABLES ALONG SAME PATH AS EXISTING CABLES AND IN ACCORDANCE WITH STRUCTURAL ANALYSIS. IF ADEQUATE SPACE EXISTS, ROUTE CABLES THROUGH ENTRY PORT HOLE, UP INSIDE OF MONOPOLE, AND THROUGH EXIT PORT HOLE. IF ROUTING OUTSIDE THE MONOPOLE, ATTACH CABLES USING STAND-OFF ADAPTERS MOUNTED TO TOWER USING STAINLESS STEEL BANDING. ADEQUATELY SECURE CABLES USING EITHER APPROPRIATELY SIZED STAINLESS STEEL SNAP-INS OR MOUNTING HARDWARE AND BRACKETS AS SPECIFIED BY CABLE MANUFACTURER.
4. TOWER ELEVATIONS ARE MEASURED FROM TOP OF BASE PLATE TO MATCH STRUCTURAL ANALYSIS. ELEVATIONS DO NOT REFLECT TRUE ABOVE GROUND LEVEL (A.G.L.)




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1 EXISTING ANTENNA PLAN

SCALE: N.T.S.

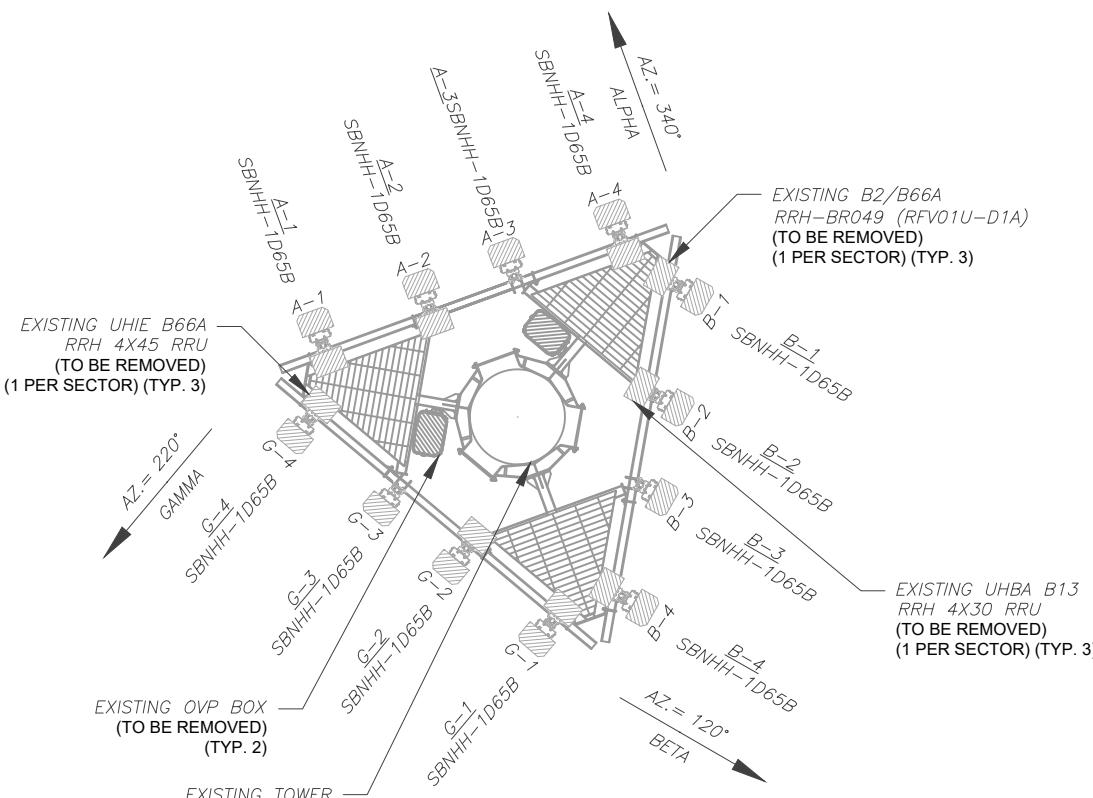

3 FINAL ANTENNA PLAN

SCALE: N.T.S.

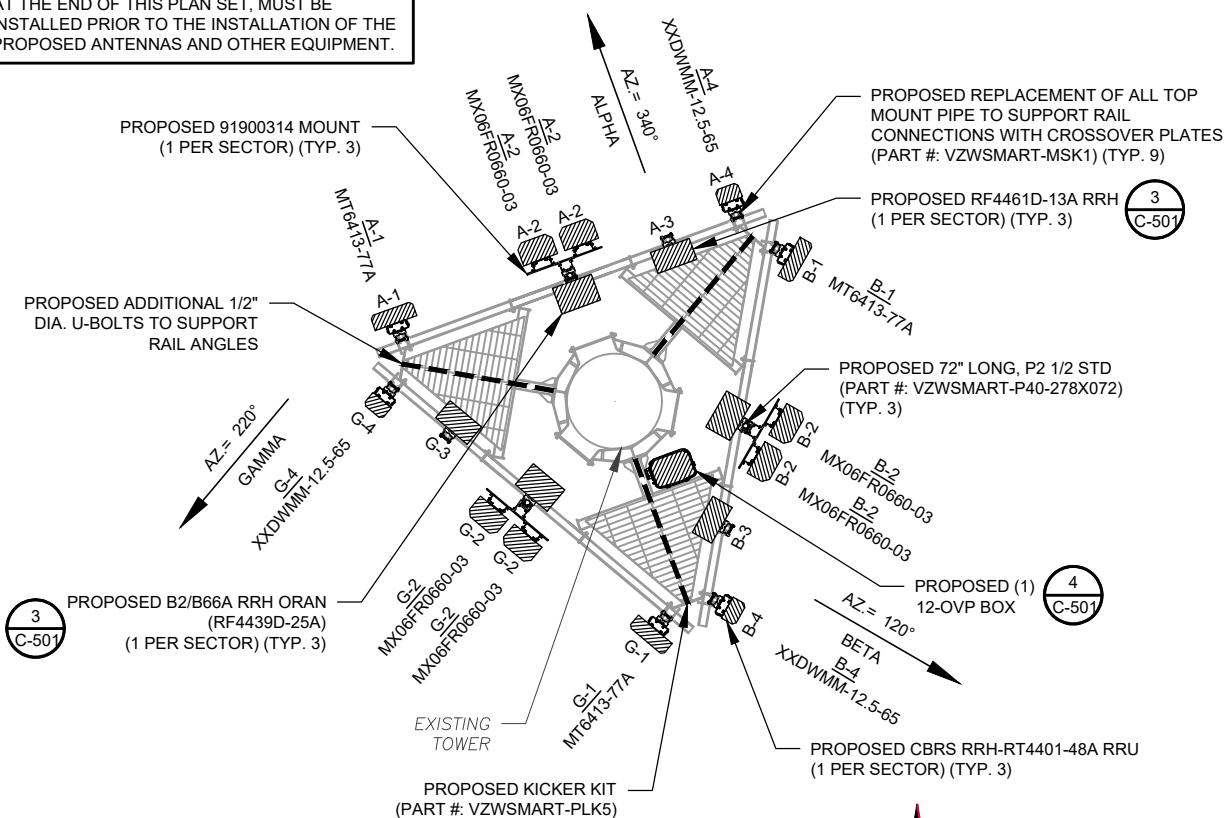EXISTING ANTENNA SCHEDULE									
LOCATION			ANTENNA SUMMARY					NON ANTENNA SUMMARY	
SECTOR	RAD	AZ	POS	ANTENNA	BAND	MECH/ELEC D-TILT	STATUS	ADDITIONAL TOWER MOUNTED EQUIPMENT	STATUS
ALPHA	76'	340°	A1	SBNHH-1D65B	LTE 700, LTE AWS	0/4,2	RMV	B2/B66A RRH-BR049 (RFV01U-D1A)	RMV
			A2	SBNHH-1D65B	LTE 700, LTE AWS	0/4,2	RMV	UHBA B13 RRH 4X30	RMV
			A3	SBNHH-1D65B	LTE 700, LTE AWS	0/4,2	RMV	—	—
			A4	SBNHH-1D65B	LTE 700, LTE AWS	0/4,2	RMV	UHIE B66A RRH 4X45	RMV
BETA	76'	120°	B1	SBNHH-1D65B	LTE 700, LTE AWS	0/4,2	RMV	B2/B66A RRH-BR049 (RFV01U-D1A)	RMV
			B2	SBNHH-1D65B	LTE 700, LTE AWS	0/4,2	RMV	UHBA B13 RRH 4X30	RMV
			B3	SBNHH-1D65B	LTE 700, LTE AWS	0/4,2	RMV	—	—
			B4	SBNHH-1D65B	LTE 700, LTE AWS	0/4,2	RMV	UHIE B66A RRH 4X45	RMV
GAMMA	76'	220°	G1	SBNHH-1D65B	LTE 700, LTE AWS	0/4,2	RMV	B2/B66A RRH-BR049 (RFV01U-D1A)	RMV
			G2	SBNHH-1D65B	LTE 700, LTE AWS	0/4,2	RMV	UHBA B13 RRH 4X30	RMV
			G3	SBNHH-1D65B	LTE 700, LTE AWS	0/4,2	RMV	—	—
			G4	SBNHH-1D65B	LTE 700, LTE AWS	0/4,2	RMV	UHIE B66A RRH 4X45	RMV

IS

1. CONFIRM WHETHER
FOR APPLICABILITY
UPDATES/REVIEWS
MOST RECENT
CONFIGURATION
TO CAP ALL UN
PROPOSED ETC
CAUSE TOWER
NOR IMPEDE THE
PEGS.
2. CONFIRM SPACE
PROPOSED ETC
CAUSE TOWER
NOR IMPEDE THE
PEGS.

STATUS ABB

RMV: TO BE REMOVED
RMVN: TO REMOVE
REL: TO BE RELEASED
ADD: TO BE ADDED

CABLE LENGTHS

JUNCTION BOX
RRU TO AN


TES H VZRON REP LE SISONS AND RFDS FOR NSN ON (CONFIG). GC USED PORTS. CING OF QUIP DOES NOT R CONFLICTS OWER CLIMBING	FINAL ANTENNA SCHEDULE									
	LOCATION			ANTENNA SUMMARY				NON ANTENNA SUMMARY		
	SECTOR	RAD	AZ	POS	ANTENNA	BAND	MECH/ELEC D-TILT	STATUS	ADDITIONAL TOWER MOUNTED EQUIPMENT	STATUS
REViations REMOVED MAIN RELOCATED ADDED	ALPHA	77.5'	340°	A1	MT6413-77A	5G L-SUB6	0/6	ADD	-	-
		76'		A2	MX06FR0660-03	LTE 700, 5G 850, LTE 850, LTE 1900, LTE AWS	0/6,4,2	ADD	B2/B66A RRH ORAN (RF4439D-25A)	ADD
		76'		A2	MX06FR0660-03	LTE 700, 5G 850, LTE 850, LTE 1900, LTE AWS	0/6,4,2	ADD		
		-		A3	-	-	-	-	RF4461D-13A	ADD
		74'		A4	XXDWMM-12.5-65	LTE CBRS	0/8	ADD	CBRS RRH-RT4401-48A	ADD
S FOR JUMPERS X TO RRU: 15' TENNA: 10'	BETA	77.5'	120°	B1	MT6413-77A	5G L-SUB6	0/6	ADD	-	-
		76'		B2	MX06FR0660-03	LTE 700, 5G 850, LTE 850, LTE 1900, LTE AWS	0/6,4,2	ADD	B2/B66A RRH ORAN (RF4439D-25A)	ADD
		76'		B2	MX06FR0660-03	LTE 700, 5G 850, LTE 850, LTE 1900, LTE AWS	0/6,4,2	ADD		
		-		B3	-	-	-	-	RF4461D-13A	ADD
		74'		B4	XXDWMM-12.5-65	LTE CBRS	0/8	ADD	CBRS RRH-RT4401-48A	ADD
S FOR JUMPERS X TO RRU: 15' TENNA: 10'	GAMMA	77.5'	220°	C1	MT6413-77A	5G L-SUB6	0/6	ADD	-	-
		76'		C2	MX06FR0660-03	LTE 700, 5G 850, LTE 850, LTE 1900, LTE AWS	0/6,4,2	ADD	B2/B66A RRH ORAN (RF4439D-25A)	ADD
		76'		C2	MX06FR0660-03	LTE 700, 5G 850, LTE 850, LTE 1900, LTE AWS	0/6,4,2	ADD		
		-		C3	-	-	-	-	RF4461D-13A	ADD
		74'		C4	XXDWMM-12.5-65	LTE CBRS	0/8	ADD	CBRS RRH-RT4401-48A	ADD

3 EQUIPMENT SCHEDULES

FINAL FIBER DISTRIBUTION / OVP BOX		FINAL CABLING SUMMARY		
MODEL NUMBER	STATUS	COAX	HYBRID	STATUS
(1) 12-OVP BOX	ADD	-	-	-
(2) FIBER CABLE(s)	RMN	-	-	-

ANTENNA INFORMATION & SCHEDULE

APPENDIX & SCHEDULE

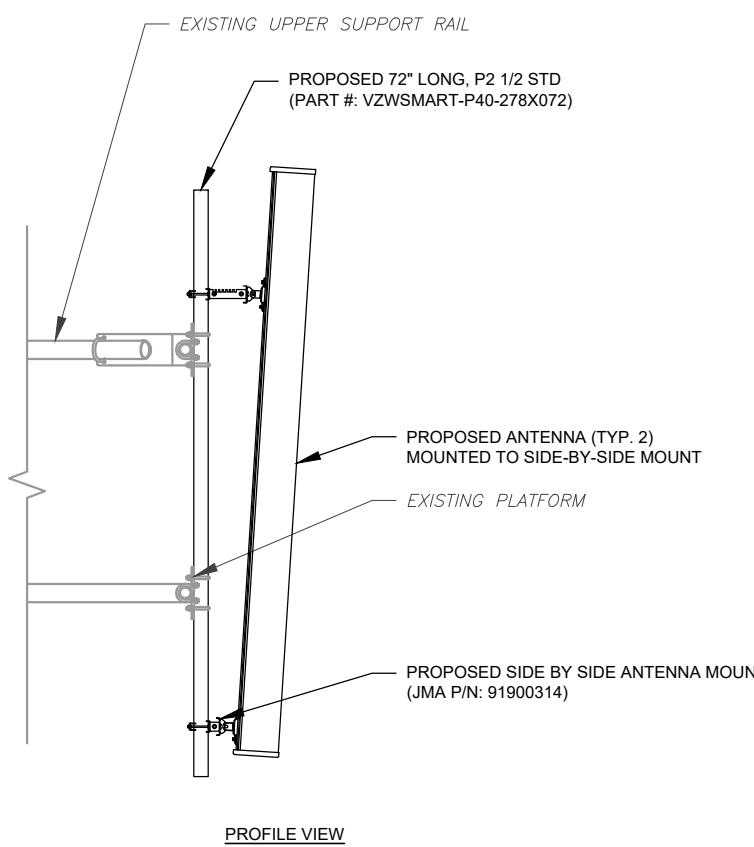


PROFILE VIEW

ISOMETRIC VIEW (BY MANUFACTURER)


① **PROPOSED SIDE-BY-SIDE MOUNT**

SCALE: NOT TO SCALE

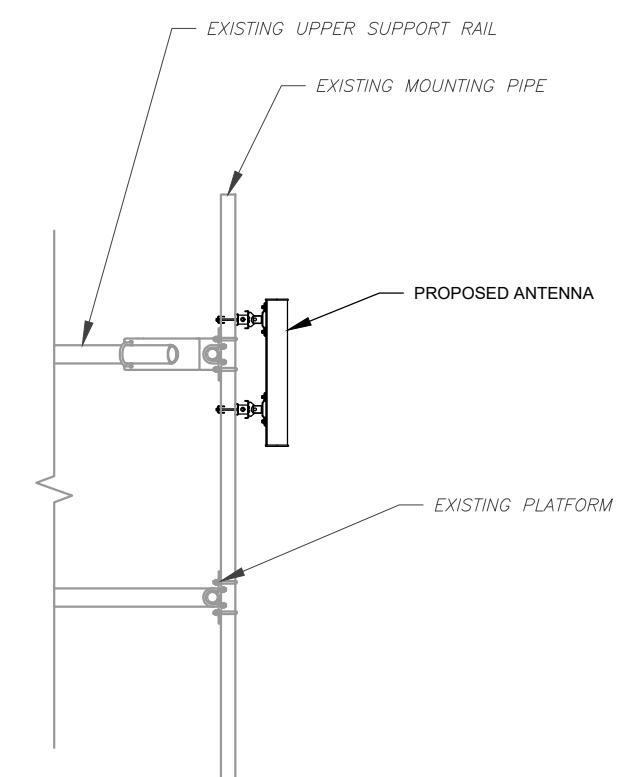


② **PROPOSED 5G ANTENNA MOUNTING DETAIL - TYPICAL**

SCALE: N.T.S.

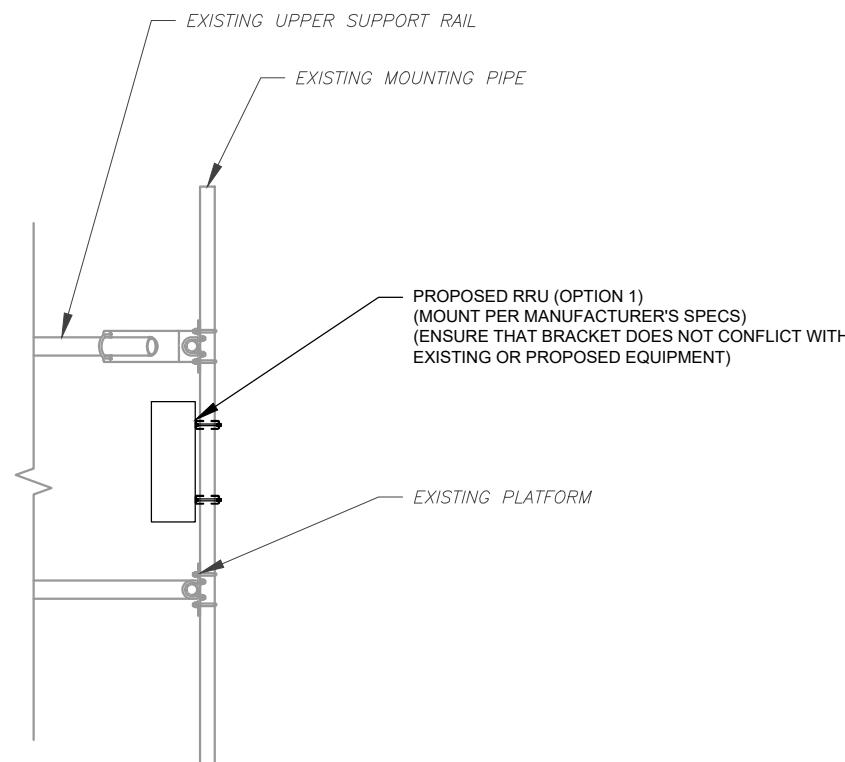

③ **PROPOSED RRU MOUNTING DETAIL - TYPICAL**

SCALE: N.T.S.

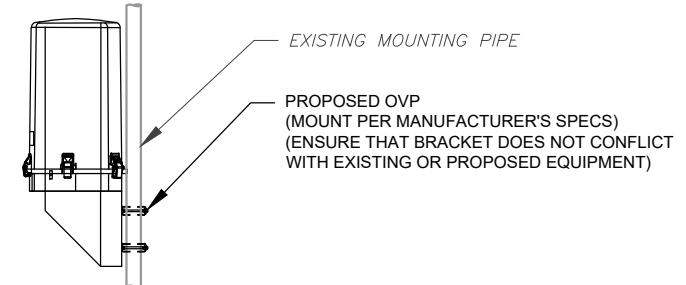

④ **PROPOSED OVP MOUNTING**

SCALE: N.T.S.



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FAX: 617.695.3310

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REV.	DESCRIPTION	BY	DATE
△	PRELIM	ZP	06/17/21
○	FINAL	SL	03/14/23
△	FINAL	VL	01/09/24
△			
△			

ATC SITE NUMBER:
283421

ATC SITE NAME:
MADISON CT

VERIZON SITE NAME:
MADISON 5 CT

SITE ADDRESS:
15 ORCHARD PARK ROAD
MADISON, CT 06443-2268

SEAL:



verizon

DATE DRAWN: 06/17/21

ATC JOB NO: 13684191

CUSTOMER ID: MADISON 5 CT

CUSTOMER #: 467699

**CONSTRUCTION
DETAILS**


SHEET NUMBER:
C-501

REVISION:
1



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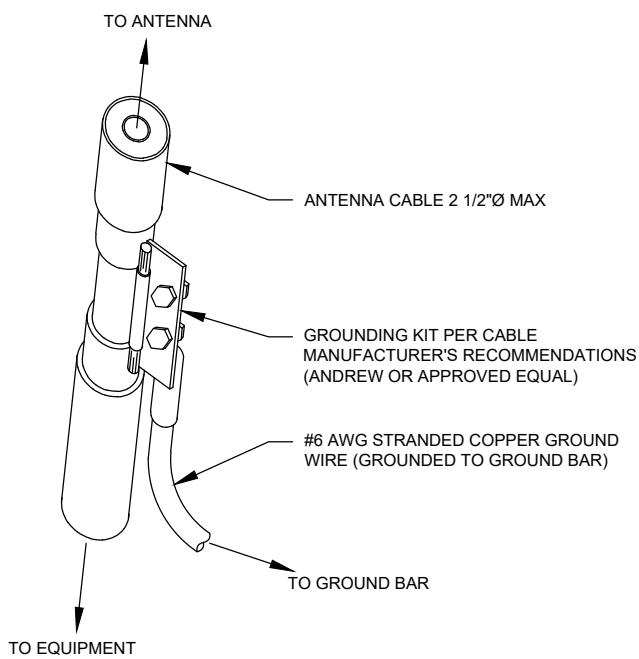


1 TYPICAL ANTENNA GROUNDING DIAGRAM

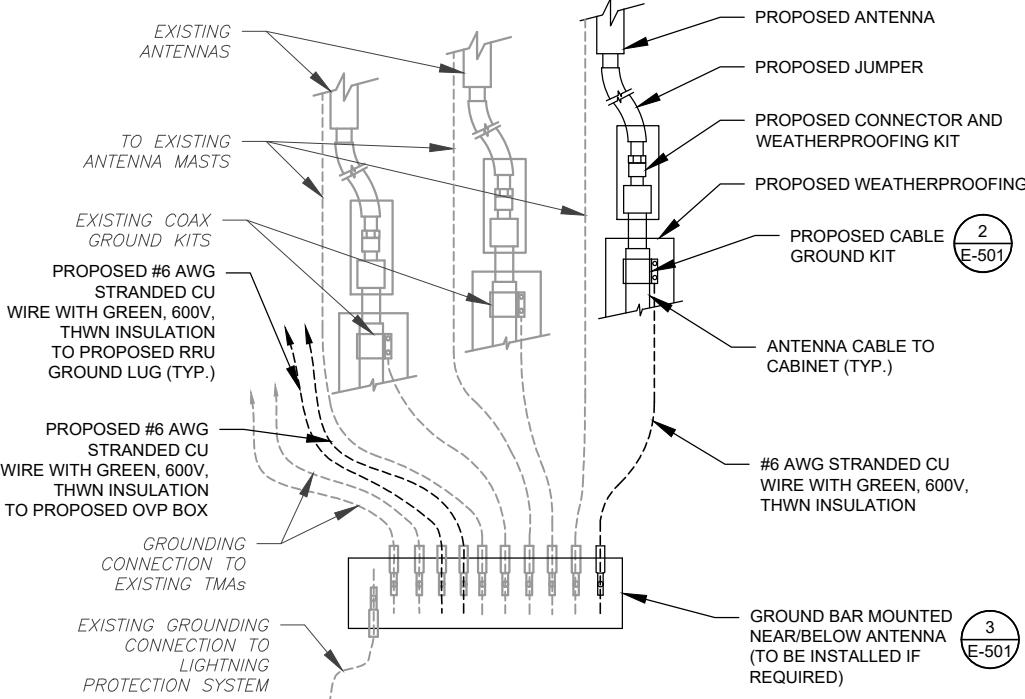SCALE: N.T.S.


2 CABLE GROUND KIT CONNECTION DETAIL

SCALE: N.T.S.



GROUND KIT NOTES:

1. DO NOT INSTALL CABLE GROUND KIT AT A BEND AND ALWAYS DIRECT GROUND WIRE DOWN TO GROUND BAR.
2. CONTRACTOR SHALL PROVIDE WEATHERPROOFING KIT (ANDREW PART NUMBER 221213) AND INSTALL/TAPE PER MANUFACTURER'S SPECIFICATIONS.

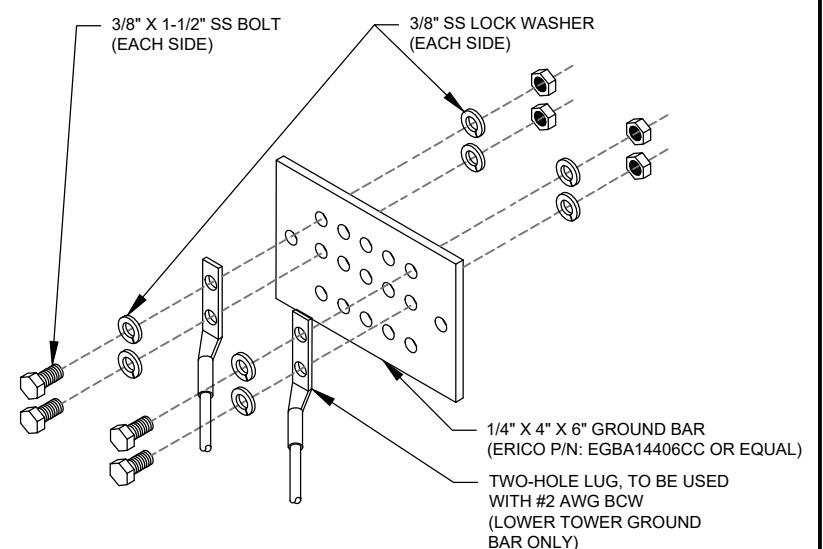

GROUND BAR NOTES:

1. GROUND BAR KITS COME WITH ALL HARDWARE, NUTS, BOLTS, WASHERS, ETC. EXCEPT THE STRUCTURAL MOUNTING MEMBER(S).
2. GROUND BAR TO BE BONDED DIRECTLY TO TOWER.

3 TOWER GROUND BAR DETAIL

SCALE: N.T.S.

verizon


DATE DRAWN: 06/17/21
ATC JOB NO: 13684191
CUSTOMER ID: MADISON 5 CT
CUSTOMER #: 467699

GROUNDING DETAILS


SHEET NUMBER:	REVISION:
E-501	1

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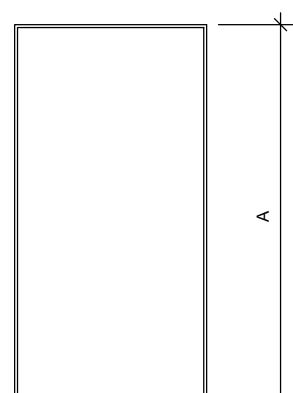
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99 SUMMER STREET
SUITE 700
BOSTON, MA 02110
PHONE: 617.531.0801
FAX: 617.695.3310

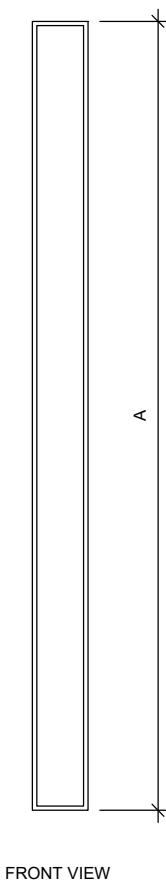


FRONT VIEW

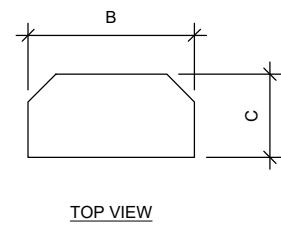


TOP VIEW




FRONT VIEW

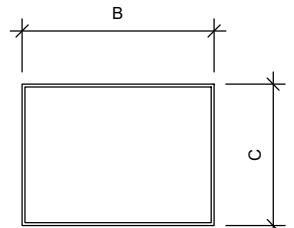


TOP VIEW

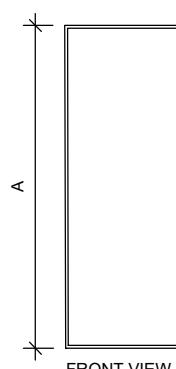

FRONT VIEW

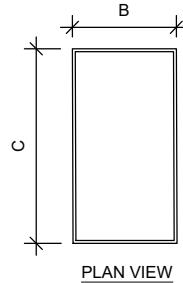

PLAN VIEW

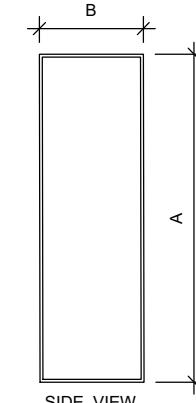

SIDE VIEW

1 ANTENNA SPECIFICATIONS

FOR ILLUSTRATIVE PURPOSES ONLY - NOT TO SCALE

ANTENNA SPECIFICATIONS				
ANTENNA MODEL	A	B	C	WEIGHT (LBS)
MT6413-77A	29.5"	15.8"	5.5"	55.1
MX06FR0660-03	71.3"	15.4"	10.7"	60.0
XXDWMM-12.5-65	12.3"	8.66"	1.35"	2.86

2 RRU SPECIFICATIONS

FOR ILLUSTRATIVE PURPOSES ONLY - NOT TO SCALE

RRU SPECIFICATIONS				
RRU MODEL	A	B	C	WEIGHT (LBS)
B2/B66A RRH ORAN (RF4439D-25A)	15.0"	15.0"	10.0"	74.7
RF4461D-13A	15.0"	15.0"	10.2"	79.1

3 OVP SPECIFICATIONS

FOR ILLUSTRATIVE PURPOSES ONLY - NOT TO SCALE

OVP SPECIFICATIONS				
OVP MODEL	A	B	C	WEIGHT (LBS)
RVZDC-6627-PF-48	29.5"	16.5"	12.6"	32.0

DATE DRAWN: 06/17/21
ATC JOB NO: 13684191
CUSTOMER ID: MADISON 5 CT
CUSTOMER #: 467699

SUPPLEMENTAL

SHEET NUMBER:
R-601

NOTE: THIS SHEET WAS CREATED BY OTHERS AND PROVIDED AT THE REQUEST OF THE CUSTOMER WITHOUT EDIT. PLEASE REFERENCE THE MOUNT ANALYSIS REPORT FOR COMPLETE MOUNT ANALYSIS CALCULATIONS AND DETAILS. SUPPLEMENTAL PAGES INCLUDED IN THE CONSTRUCTION DRAWINGS ARE FOR REFERENCE ONLY. GENERAL CONTRACTOR IS TO VERIFY THEY HAVE THE MOST RECENT MOUNT ANALYSIS PRIOR TO CONSTRUCTION.



Colliers Engineering & Design, Architecture, Landscape Architecture, Surveying, CT P.C.
1055 Washington Boulevard
Stamford, CT 06901
203.324.0800
peter.albano@collierseng.com

Post-Modification Antenna Mount Analysis Report and PMI Requirements

Mount Fix

SMART Tool Project #: 10210298
Colliers Engineering & Design Project #: 21777875 (Rev. 1)

October 10, 2023

<u>Site Information</u>	<p>Site ID: 5000392629-VZW / MADISON 5 CT - FTP Site Name: Orchard Park Carrier Name: MADISON 5 CT - FTP Orchard Park Address: Verizon Wireless 15 Orchard Park Rd Madison, Connecticut 06443 New Haven County Latitude: 41.28308333° Longitude: -72.62308333°</p>
<u>Structure Information</u>	<p>Tower Type: 120-Ft Monopole Mount Type: 12.58-Ft Platform</p>

FUZE ID # 16067465

Analysis Results

Platform: 60.8% Pass w/ Modifications*

*Antennas and equipment to be installed in compliance with PMI Requirements of this mount analysis.

***Contractor PMI Requirements:

Included at the end of this MA report

Available & Submitted via portal at <https://pmi.vzwsmart.com>

For additional questions and support, please reach out to:

pmisupport@colliersengineering.com

Report Prepared By: Grant Walters



Mount Post-Modification Analysis Report
(1) 12.50-Ft Platform

October 10, 2023
Site ID: 5000392629-VZW / MADISON 5 CT
Page | 5

Requirements:

The existing mount will be **SUFFICIENT** for the final loading configuration (attachment 2) **after the modifications detailed in attachment 3 are successfully completed.**

ANSI/ASSP rigging plan review services compliant with the requirements of ANSI/TIA 322 are available for a Construction Class IV site or other, if required. Separate review fees will apply.

Attachments:

1. Contractor Required PMI Report Deliverables
2. Antenna Placement Diagrams
3. Mount Modification Drawings
4. Mount Photos
5. Mount Mapping Report (for reference only)
6. Analysis Calculations



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PHONE: 617.531.0801
FAX: 617.695.3310

ATC SITE NUMBER:
283421

ATC SITE NAME:
MADISON CT

VERIZON SITE NAME:
MADISON 5 CT

SITE ADDRESS:
15 ORCHARD PARK ROAD
MADISON, CT 06443-2268

DATE DRAWN: 06/17/21
ATC JOB NO: 13684191
CUSTOMER ID: MADISON 5 CT
CUSTOMER #: 467699

SUPPLEMENTAL

SHEET NUMBER:
R-602

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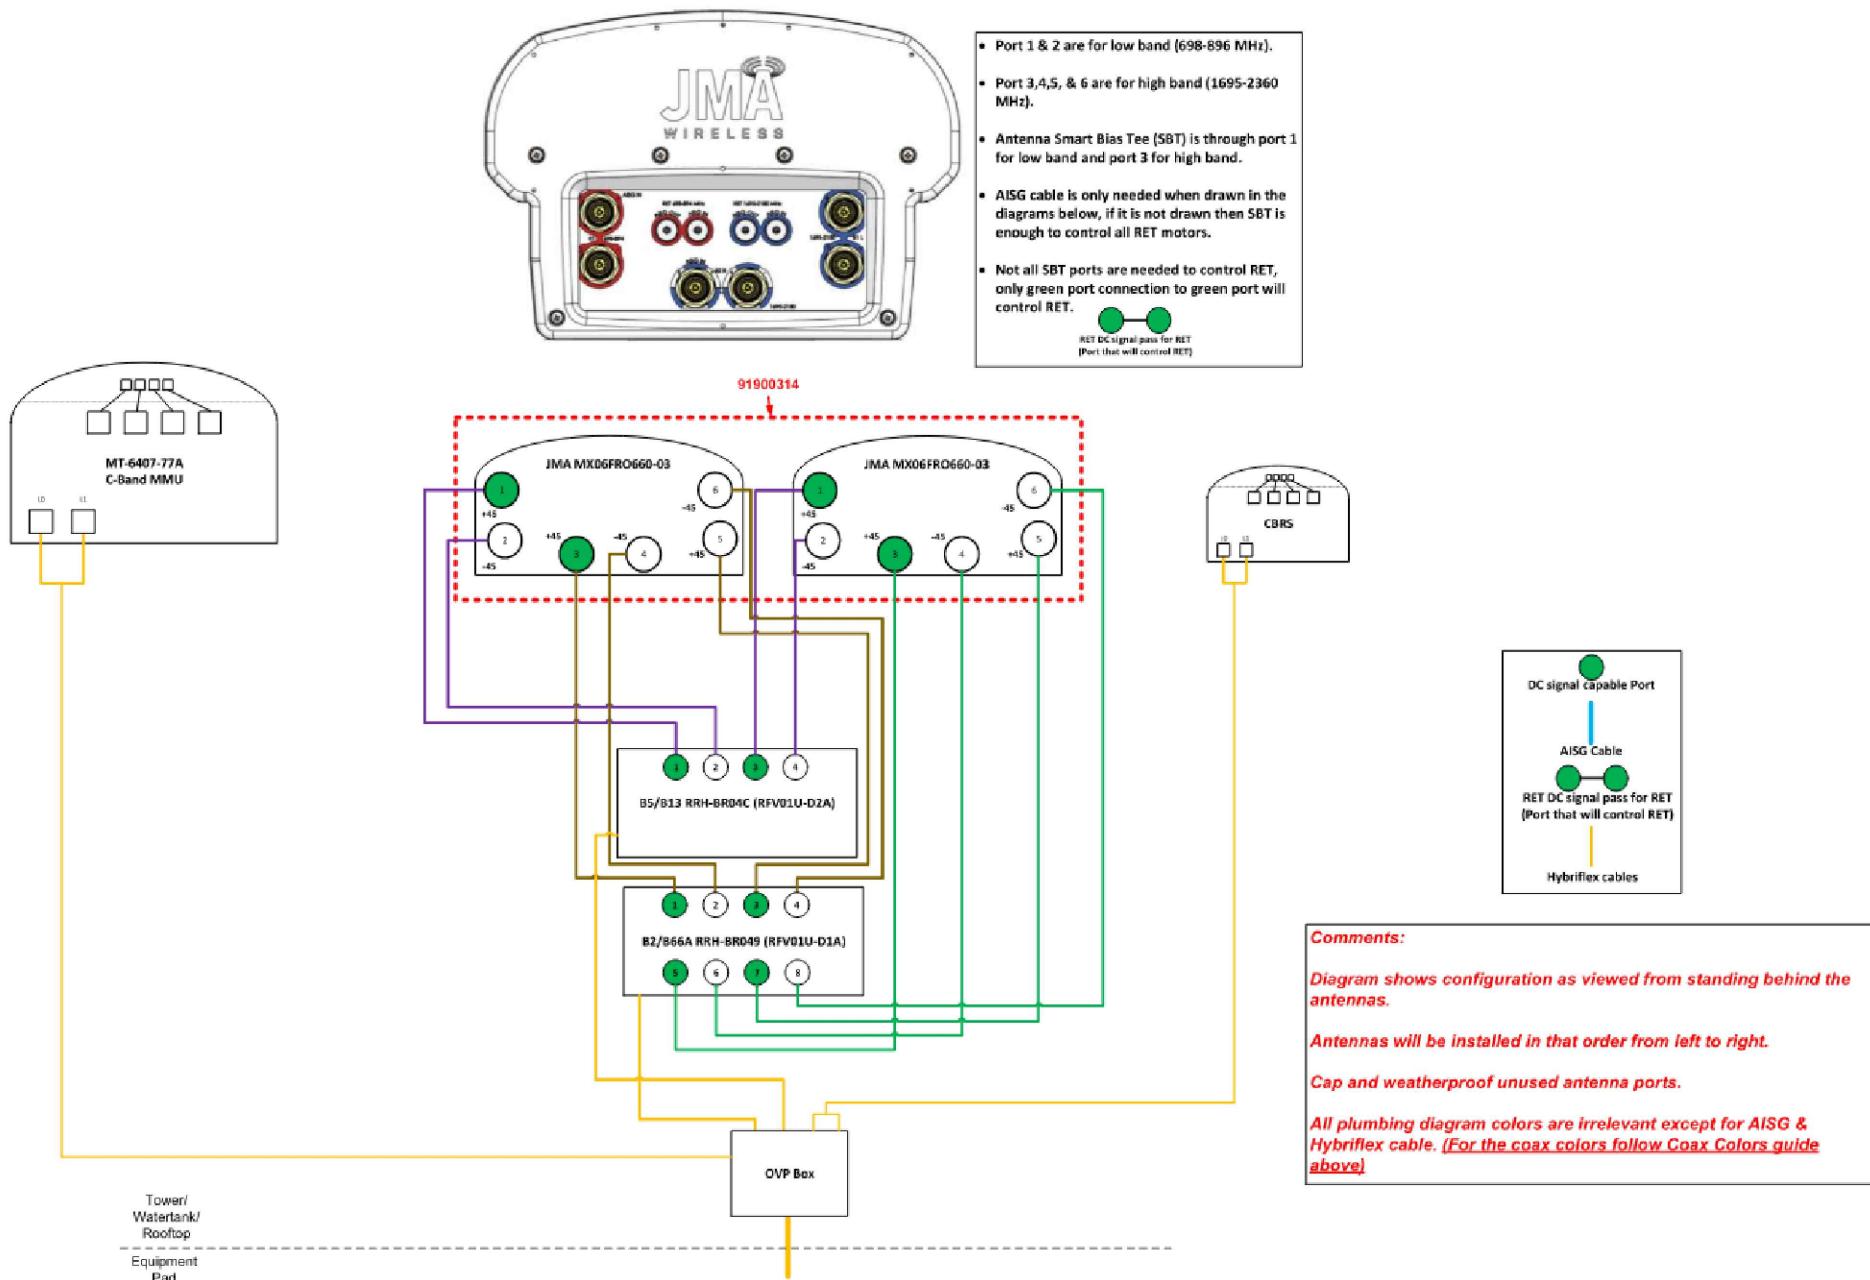
ATC SITE NAME:
MADISON CT

VERIZON SITE NAME:
MADISON 5 CT
SITE ADDRESS:
15 ORCHARD PARK ROAD
MADISON, CT 06443-2268

DATE DRAWN: 06/17/21
ATC JOB NO: 13684191
CUSTOMER ID: MADISON 5 CT
CUSTOMER #: 467699

SUPPLEMENTAL

SHEET NUMBER:
R-603





MOUNT MODIFICATION DRAWINGS EXISTING 12.58' PLATFORM

**TOWER OWNER: AMERICAN TOWER CO.
TOWER OWNER SITE NUMBER: 283421**

**CARRIER SITE NAME: MADISON 5 CT-FTP ORCHARD PARK
CARRIER SITE NUMBER: 5000392629
FUZE ID: 16067465**






15 ORCHARD PARK RD
MADISON, CT 06443
NEW HAVEN COUNTY

LATITUDE: 41.28308333° N
LONGITUDE: 72.62308333° W

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UPON FOR ANY OTHER PURPOSE WITHOUT THE EXPRESS WRITTEN
CONSENT OF COLLIER'S ENGINEERING & DESIGN

DESIGN CRITERIA		PROJECT INFORMATION	SHEET INDEX	
<u>WIND LOADS</u>		<u>APPLICANT/LESSEE</u>		
BASIC WIND SPEED (3 SECOND GUST), V = 125 MPH		COMPANY: VERIZON WIRELESS	ST-I	TITLE SHEET
EXPOSURE CATEGORY B			SBOM-I	BILL OF MATERIALS
TOPOGRAPHIC CATEGORY I		<u>CLIENT REPRESENTATIVE</u>	SGN-I	GENERAL NOTES
MEAN BASE ELEVATION (AMSL) = 18.26'		COMPANY: VERIZON WIRELESS	SCF-I	CLIMBING FACILITY DETAIL
<u>ICE LOADS</u>		<u>PROJECT MANAGER</u>	SS-I	MODIFICATION DETAILS
ICE WIND SPEED (3 SECOND GUST), V = 50 MPH		COMPANY: COLLIER'S ENGINEERING & DESIGN	SS-2	MOUNT PHOTOS
ICE THICKNESS = 1.00 IN		CONTACT: PETER ALBANO		SPECIFICATION SHEETS
<u>SEISMIC LOADS</u>		PHONE: 856.797.0412		
SEISMIC DESIGN CATEGORY B		E-MAIL: PETER.ALBANO@COLLIERSENGINEERING.COM		
SHORT TERM MCER GROUND MOTION, S_s = .206				
LONG TERM MCER GROUND MOTION, S_s = .054				
<u>CONTRACTOR PMI REQUIREMENTS</u>				
<p>PMI LOCATION: HTTPS://PMI.VZWSMART.COM</p> <p>SMART TOOL PROJECT #: 10210298</p> <p>VZW LOCATION CODE (MDG): 5000392629</p> <p>ANALYSIS DATE: 10/10/2023</p>				
PMI REQUIREMENTS EMBEDDED WITHIN MOUNT MODIFICATION REPORT				

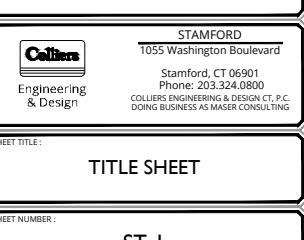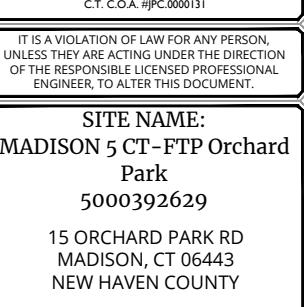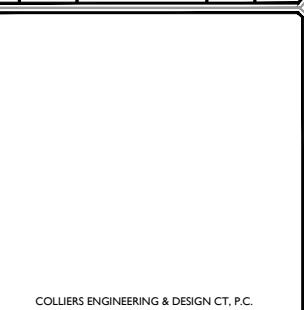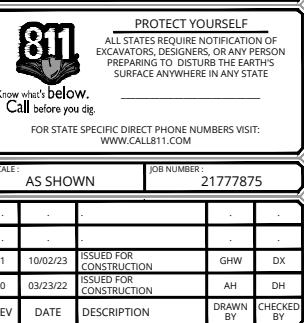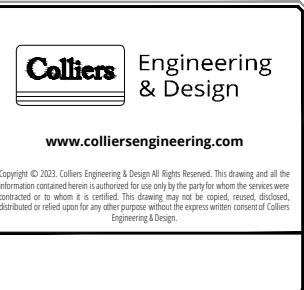

PROJECT NOTES

- SEE MODIFICATION NOTES
- THE CONTRACTOR SHALL COMPLY WITH ALL APPLICABLE CODES, ORDINANCES, LAWS AND REGULATIONS OF ALL MUNICIPALITIES, UTILITY COMPANIES OR OTHER PUBLIC/GOVERNING AUTHORITIES.
- THE CONTRACTOR SHALL BE RESPONSIBLE FOR OBTAINING ALL PERMITS AND INSPECTIONS THAT MAY BE REQUIRED BY ANY FEDERAL, STATE, COUNTY OR MUNICIPAL AUTHORITIES.
- THE CONTRACTOR SHALL NOTIFY THE CONSTRUCTION MANAGER, IN WRITING, OF ANY CONFLICTS, ERRORS OR OMISSIONS PRIOR TO THE SUBMISSION OF BIDS OR PERFORMANCE OF WORK.
- THE CONTRACTOR SHALL BE RESPONSIBLE FOR PROTECTING ALL EXISTING SITE IMPROVEMENTS PRIOR TO COMMENCING CONSTRUCTION. THE CONTRACTOR SHALL REPAIR ANY DAMAGE AS A RESULT OF CONSTRUCTION OF THIS FACILITY AT THE CONTRACTOR'S EXPENSE TO THE SATISFACTION OF THE OWNER.
- THE SCOPE OF WORK FOR THIS PROJECT SHALL INCLUDE PROVIDING ALL MATERIALS, EQUIPMENT AND LABOR REQUIRED TO COMPLETE THIS PROJECT. ALL EQUIPMENT SHALL BE INSTALLED IN ACCORDANCE WITH MANUFACTURER'S RECOMMENDATIONS.
- THE CONTRACTOR SHALL VISIT THE PROJECT SITE PRIOR TO SUBMITTING THE BID TO VERIFY THAT THE PROJECT CAN BE CONSTRUCTED IN ACCORDANCE WITH THE CONTRACT DOCUMENTS AND CONSTRUCTION DRAWINGS.
- THE CONTRACTOR SHALL VERIFY ALL EXISTING DIMENSIONS AND CONDITIONS PRIOR TO COMMENCING ANY WORK. ALL DIMENSIONS OF EXISTING CONSTRUCTION SHOWN ON THESE DRAWINGS MUST BE VERIFIED. THE CONTRACTOR SHALL NOTIFY THE CONSTRUCTION MANAGER OF ANY DISCREPANCIES PRIOR TO ORDERING MATERIAL OR PROCEEDING WITH CONSTRUCTION.
- SINCE THE CELL SITE MAY BE ACTIVE, ALL SAFETY PRECAUTIONS MUST BE TAKEN WHEN WORKING AROUND HIGH LEVELS OF ELECTROMAGNETIC RADIATION. EQUIPMENT SHOULD BE SHUTDOWN PRIOR TO PERFORMING ANY WORK THAT COULD EXPOSE THE WORKERS TO DANGER. PERSONAL RF EXPOSURE MONITORS ARE REQUIRED TO BE WORN TO ALERT OF ANY POTENTIALLY DANGEROUS EXPOSURE LEVELS.
- NO NOISE, SMOKE, DUST OR ODOR WILL RESULT FROM THIS FACILITY AS TO CAUSE A NUISANCE.
- THE FACILITY IS UNMANNED AND NOT FOR HUMAN HABITATION (NO HANDICAP ACCESS IS REQUIRED).

GENERAL NOTES

- THESE MODIFICATIONS HAVE BEEN DESIGNED IN ACCORDANCE WITH THE GOVERNING PROVISIONS OF THE TELECOMMUNICATIONS INDUSTRY STANDARD TIA-222-H. MATERIALS AND SERVICES PROVIDED BY THE CONTRACTOR SHALL CONFORM TO THE ABOVE MENTIONED CODES.
- CONTRACTOR SHALL TAKE ALL PRECAUTIONS NECESSARY TO PREVENT DAMAGE TO EXISTING STRUCTURES. ANY DAMAGE TO EXISTING STRUCTURES AS A RESULT OF THE CONTRACTOR'S WORK OR FROM DAMAGE DUE TO OTHER CAUSES SHALL BE REPAIRED AT THE CONTRACTOR'S EXPENSE TO THE SATISFACTION OF THE OWNER.
- CONTRACTOR SHALL VERIFY ALL DIMENSIONS AND EXISTING CONDITIONS BEFORE BEGINNING WORK, ORDERING MATERIAL, AND PREPARING OF SHOP DRAWINGS. ANY DISCREPANCIES BETWEEN FIELD CONDITIONS AND THE CONTRACT DOCUMENTS SHALL BE BROUGHT TO THE IMMEDIATE ATTENTION OF THE ENGINEER. IF THE CONTRACTOR DISCOVERS ANY EXISTING CONDITIONS THAT ARE NOT REPRESENTED ON THESE DRAWINGS, OR ANY CONDITIONS THAT WOULD INTERFERE WITH THE INSTALLATION OF THE MODIFICATIONS, NOTIFY THE ENGINEER IMMEDIATELY.
- IT IS ASSUMED THAT ANY STRUCTURAL MODIFICATION WORK SPECIFIED ON THESE PLANS WILL BE ACCOMPLISHED BY KNOWLEDGEABLE WORKMEN WITH TOWER CONSTRUCTION EXPERIENCE.
- THE CONTRACTOR SHALL SUPERVISE AND DIRECT THE WORK AND SHALL BE SOLELY RESPONSIBLE FOR ALL CONSTRUCTION METHODS, MEANS, TECHNIQUES, SEQUENCES, AND PROCEDURES.
- ALL CONSTRUCTION MEANS AND METHODS; INCLUDING BUT NOT LIMITED TO, ERECTION PLANS, RIGGING PLANS, CLIMBING PLANS, AND RESCUE PLANS SHALL BE THE RESPONSIBILITY OF THE GENERAL CONTRACTOR RESPONSIBLE FOR THE EXECUTION OF THE WORK CONTAINED HEREIN AND SHALL MEET ANSI/TIA-322 (LATEST EDITION), OSHA, AND GENERAL INDUSTRY STANDARDS. ALL RIGGING PLANS SHALL ADHERE TO ANSI/TIA-322 (LATEST EDITION) INCLUDING THE REQUIRED INVOLVEMENT OF A QUALIFIED ENGINEER FOR CLASS IV CONSTRUCTION.
- THE CONTRACTOR IS SOLELY RESPONSIBLE FOR INITIATING, MAINTAINING, AND SUPERVISING ALL SAFETY PROGRAMS IN ACCORDANCE WITH APPLICABLE SAFETY CODES.
- WORK SHALL ONLY BE PERFORMED DURING CALM DRY DAYS (WINDS LESS THAN 30-MPH). THE STRUCTURE SHOWN ON THE DRAWINGS IS STRUCTURALLY SOUND ONLY IN THE COMPLETED FORM. THE

CONTRACTOR SHALL BE RESPONSIBLE FOR THE STRENGTH AND STABILITY OF THE STRUCTURE DURING ERECTION. CONTRACTOR SHALL PROVIDE TEMPORARY SUPPORT, SHORING, BRACING AND ANY OTHER STRUCTURAL SYSTEMS AS REQUIRED TO RESIST ALL FORCES THAT MAY OCCUR DURING HANDLING AND ERECTION UNTIL THE STRUCTURE IS FULLY COMPLETED. TEMPORARY SUPPORTS, BRACING AND OTHER STRUCTURAL SYSTEMS REQUIRED DURING CONSTRUCTION SHALL REMAIN THE CONTRACTOR'S PROPERTY AFTER THEIR USE.

9. ALL INSTALLATIONS PERFORMED ON THIS STRUCTURE SHALL BE COMPLETED IN ACCORDANCE WITH THE GOVERNING PROVISIONS OF THE STANDARD FOR INSTALLATION, ALTERATION AND MAINTENANCE OF ANTENNA SUPPORTING STRUCTURES AND ANTENNAS, ANSI/TIA-322.

10. CONTRACTOR SHALL SECURE SITE BACK TO EXISTING CONDITION UNDER SUPERVISION OF OWNER. ALL FENCE, STONE, GEOFABRIC, GROUNDING, AND SURROUNDING GRADE SHALL BE REPLACED AND REPAIRED AS REQUIRED TO ACHIEVE OWNER APPROVAL. POSITIVE DRAINAGE AWAY FROM TOWER SITE SHALL BE MAINTAINED.

11. CONNECTIONS BETWEEN ITEMS SUPPORTED BY THE STRUCTURE AND THE STRUCTURE NOT SPECIFICALLY DETAILED IN THE CONTRACT DOCUMENTS ARE THE RESPONSIBILITY OF THE CONTRACTOR. SUCH CONNECTIONS SHALL BE DESIGNED, COORDINATED AND INSPECTED BY A PROFESSIONAL STRUCTURAL ENGINEER LICENSED IN THE STATE OF THE PROJECT. SUBMIT SIGNED AND SEALED CALCULATIONS DURING SHOP DRAWING REVIEW.

12. DO NOT SCALE DRAWINGS.

13. DO NOT USE THESE DRAWINGS FOR ANY OTHER SITE.

14. ALL MATERIAL UTILIZED FOR THIS PROJECT MUST BE NEW AND FREE OF ANY DEFECTS. ANY MATERIAL SUBSTITUTIONS, INCLUDING BUT NOT LIMITED TO ALTERED SIZE AND/OR STRENGTHS, MUST BE APPROVED BY THE OWNER AND ENGINEER IN WRITING.

15. THE MOUNT UNDER NO CIRCUMSTANCES SHOULD BE USED AS A TIE OFF POINT.

STRUCTURAL STEEL

1. DESIGN, DETAILING, FABRICATION AND ERECTION OF STRUCTURAL STEEL SHALL CONFORM TO THE FOLLOWING PUBLICATIONS EXCEPT AS SPECIFICALLY INDICATED IN THE CONTRACT DOCUMENTS.

- AMERICAN INSTITUTE OF STEEL CONSTRUCTION (AISC) MANUAL OF STEEL CONSTRUCTION (15TH EDITION)
- SPECIFICATION FOR STRUCTURAL JOINTS USING ASTM A325 OR A490 BOLTS
- AISC CODE OF STANDARD PRACTICE

2. STRUCTURAL STEEL SHALL CONFORM TO THE FOLLOWING UNLESS OTHERWISE SHOWN:

CHANNELS, ANGLES, PLATES, ETC.	ASTM A36 (GR 36)
STEEL PIPE	ASTM A53 (GR 35)
BOLTS	ASTM A325
NUTS	ASTM A563
LOCK WASHERS	LOCKING STRUCTURAL GRADE

3. ALL SUBSTITUTIONS PROPOSED BY THE CONTRACTOR SHALL BE APPROVED IN WRITING BY THE ENGINEER. CONTRACTOR SHALL PROVIDE DOCUMENTATION TO ENGINEER FOR VERIFYING THE SUBSTITUTE IS SUITABLE FOR USE AND MEETS ORIGINAL DESIGN CRITERIA. DIFFERENCES FROM THE ORIGINAL DESIGN, INCLUDING MAINTENANCE, REPAIR AND REPLACEMENT, SHALL BE NOTED. ESTIMATES OF COSTS/CREDITS ASSOCIATED WITH THE SUBSTITUTION (INCLUDING RE-DESIGN COSTS AND COSTS TO SUB-CONTRACTORS) SHALL BE PROVIDED TO THE ENGINEER. CONTRACTOR SHALL PROVIDE ADDITIONAL DOCUMENTATION AND/OR SPECIFICATIONS TO THE ENGINEER AS REQUESTED.

4. PROVIDE STRUCTURAL STEEL SHOP DRAWINGS TO ENGINEER FOR APPROVAL PRIOR TO FABRICATION.

- SUBMIT SHOP DRAWINGS TO

PETER.ALBANO@COLLIERSENGINEERING.COM

b. PROVIDE MASER CONSULTING PROJECT # AND MASER CONSULTING PROJECT ENGINEER CONTACT IN THE BODY OF THE EMAIL.

5. DRILL NO HOLES IN ANY NEW OR EXISTING STRUCTURAL STEEL MEMBERS OTHER THAN THOSE SHOWN ON STRUCTURAL DRAWINGS WITHOUT THE APPROVAL OF THE ENGINEER OF RECORD.

6. GALVANIZED ASTM A325 BOLTS SHALL NOT BE REUSED.

7. ALL NEW STEEL SHALL BE HOT DIPPED GALVANIZED FOR FULL WEATHER PROTECTION. IN ADDITION ALL NEW STEEL SHALL BE PAINTED TO MATCH EXISTING STEEL. CONTRACTOR SHALL OBTAIN WRITTEN PERMISSION TO PROTECT STEEL BY ANY OTHER MEANS.

8. CONTRACTOR SHALL PROTECT CUT ENDS OF ALL FIELD-CUT STEEL WITH TWO (2) COATS OF COLD GALVANIZATION (ZINGA OR ZINC COAT).

9. ALL BOLT ASSEMBLIES FOR STRUCTURAL MEMBERS REPRESENTED IN THIS DRAWING REQUIRE LOCKING DEVICES TO BE INSTALLED IN ACCORDANCE WITH TIA-222-H SECTION 4.9.2 REQUIREMENTS.

10. WHERE CONNECTIONS ARE NOT FULLY DETAILED ON THESE DRAWINGS, FABRICATOR SHALL DESIGN CONNECTIONS TO RESIST LOADS AND FORCES WHERE SHOWN ON DRAWINGS AND AS OUTLINED IN SPECIFICATIONS.

11. FOR MEMBERS BEING REPLACED, PROVIDE NEW BOLTS AND MATCH EXISTING SIZE AND GRADE. MAINTAIN AISC REQUIREMENTS FOR MINIMUM BOLT DISTANCE AND SPACING.

12. ALL PROPOSED AND/OR REPLACED BOLTS SHALL BE OF SUFFICIENT LENGTH SUCH THAT THE END OF THE BOLT IS AT LEAST FLUSH WITH THE FACE OF THE NUT. IT IS NOT PERMITTED FOR THE BOLT END TO BE BELOW THE FACE OF THE NUT AFTER TIGHTENING IS COMPLETED.

13. GALVANIZED ASTM A325 BOLTS SHALL NOT BE REUSED.

14. ALL EXISTING PAINTED/GALVANIZED SURFACES DAMAGED DURING REHAB INCLUDING AREAS UNDER STIFFENER PLATES SHALL BE WIRE BRUSHED CLEAN, REPAIRED BY COLD GALVANIZING (ZINGA OR ZINC COAT), AND REPAINTED TO MATCH THE EXISTING FINISH (IF APPLICABLE).

15. ALL HOLES IN STEEL MEMBERS SHALL BE SIZED 1/16" LARGER THAN THE BOLT DIAMETER. STANDARD HOLES SHALL BE USED UNLESS NOTED OTHERWISE.

WELDING NOTES

1. ALL WELDING SHALL BE DONE IN ACCORDANCE WITH AWS D1.0 (LATEST EDITION). THIS SHALL INCLUDE A CERTIFIED WELD INSPECTION (CWI) FOR ACCEPTANCE OR REJECTION OF ALL WELDING OPERATIONS, PRE, DURING, AND POST INSTALLATION, USING THE ACCEPTANCE CRITERIA OF AWS D1.1.

2. CONTRACTOR IS RESPONSIBLE FOR COMMISSIONING A THIRD PARTY CERTIFIED WELD INSPECTOR (CWI) THROUGHOUT THE ENTIRETY OF THE PROJECT. A PASSING CWI REPORT SHALL BE PROVIDED TO THE ENGINEER UPON COMPLETION OF THE PROJECT.

3. THE CERTIFIED WELD INSPECTOR SHALL INDICATE, IN A WRITTEN CWI REPORT, THAT ALL WELDING OPERATIONS PRE, DURING, AND POST INSTALLATION WERE CONDUCTED IN ACCORDANCE WITH AWS D1.1 WITH PHOTOGRAPHS AND DOCUMENTATION SUPPORTING THE ACCEPTANCE OR REJECTION OF ALL WELDING. ALL CWI WELD INSPECTION DOCUMENTATION AND PHOTOS SHALL BE SUBMITTED DURING THE PMI.

4. IN CASES WHERE A WELD IS SPECIFIED BETWEEN TWO MEMBERS IN WHICH THERE IS A GAP IN BETWEEN, THE WELD IS TO BE BUILT-UP SUCH THAT THE SIZE OF WELD ON THE MEMBER IS EQUAL TO THAT SHOWN IN THE DRAWINGS.


5. OXY FUEL GAS WELDING OR BRAZING IS STRICTLY PROHIBITED. SPECIFICALLY, NO TORCH CUTTING IS PERMITTED ON SITE. ALL HOLES SHALL BE CUT WITH A GRINDER.

6. CONTRACTOR SHALL EXERCISE CAUTION WHEN WELDING A GALVANIZED SURFACE.

7. CONTRACTOR SHALL HAVE A FIRE PROTECTION PLAN IN PLACE THAT CONFORMS WITH ALL OSHA, ANSI/ASSP A10.48, ANSI Z49.1, AND LOCAL JURISDICTIONAL REQUIREMENTS.

BOLT SCHEDULE (IN.)				
BOLT DIAMETER	STANDARD HOLE	SHORT SLOT	MIN. EDGE DISTANCE	SPACING
1/2	9/16	9/16 x 11/16	7/8	1 1/2
5/8	11/16	11/16 x 7/8	1 1/8	1 7/8
3/4	13/16	13/16 x 1	1 1/4	2 1/4
7/8	15/16	15/16 x 1 1/8	1 1/2	2 5/8
1	1 1/16	1 1/16 x 1 5/16	1 3/4	3



WORKABLE GAGES (IN.)	
LEG	GAGE
4	2 1/2
3 1/2	2
3	1 3/4
2 1/2	1 3/8
2	1 1/8

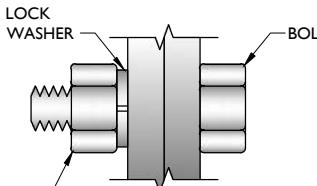

TYP. BOLT ASSEMBLY

NOTES:

- ALL DIMENSIONS REPRESENTED IN THE ABOVE TABLES ARE AISC MINIMUM REQUIREMENTS. CONTRACTOR SHALL VERIFY EXISTING CONDITIONS IN FIELD AND NOTIFY ENGINEER IF DISTANCES ARE LESS THAN THOSE PROVIDED.
- THE DIMENSIONS PROVIDED ARE MINIMUM REQUIREMENTS. ACTUAL DIMENSIONS OF PROPOSED MEMBERS WITHIN THESE DRAWINGS MAY VARY FROM THE AISC MINIMUM REQUIREMENTS.
- SHORT SLOT HOLES SHALL ONLY BE USED WHEN DEPICTED IN THE DRAWINGS
- MATCH EXISTING GAGES WHEN APPLICABLE, UNLESS MINIMUM EDGE DISTANCES ARE COMPROMISED.

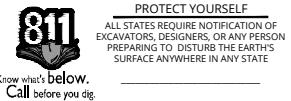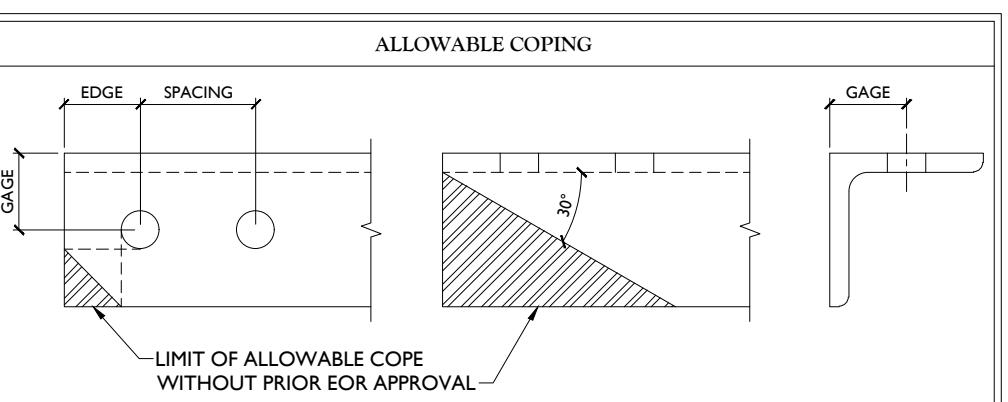

SCALE:	AS SHOWN	JOB NUMBER:	21777875
1	10/02/23	ISSUED FOR CONSTRUCTION	GHW DX
0	03/23/22	ISSUED FOR CONSTRUCTION	AH DH
REV	DATE	DESCRIPTION	DRAWN BY CHECKED BY

COLLIERS ENGINEERING & DESIGN CT, P.C.
C.T. C.O.A. #IPC.0000131


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SITE NAME:
MADISON 5 CT-FTP Orchard Park
5000392629
15 ORCHARD PARK RD
MADISON, CT 06443
NEW HAVEN COUNTY

STAMFORD
1055 Washington Boulevard
Stamford, CT 06901
Phone: 203.324.2000
COLLIERS ENGINEERING & DESIGN CT, P.C.
DOING BUSINESS AS MASER CONSULTING

SHEET TITLE: MODIFICATION NOTES

SHEET NUMBER: SGN-1

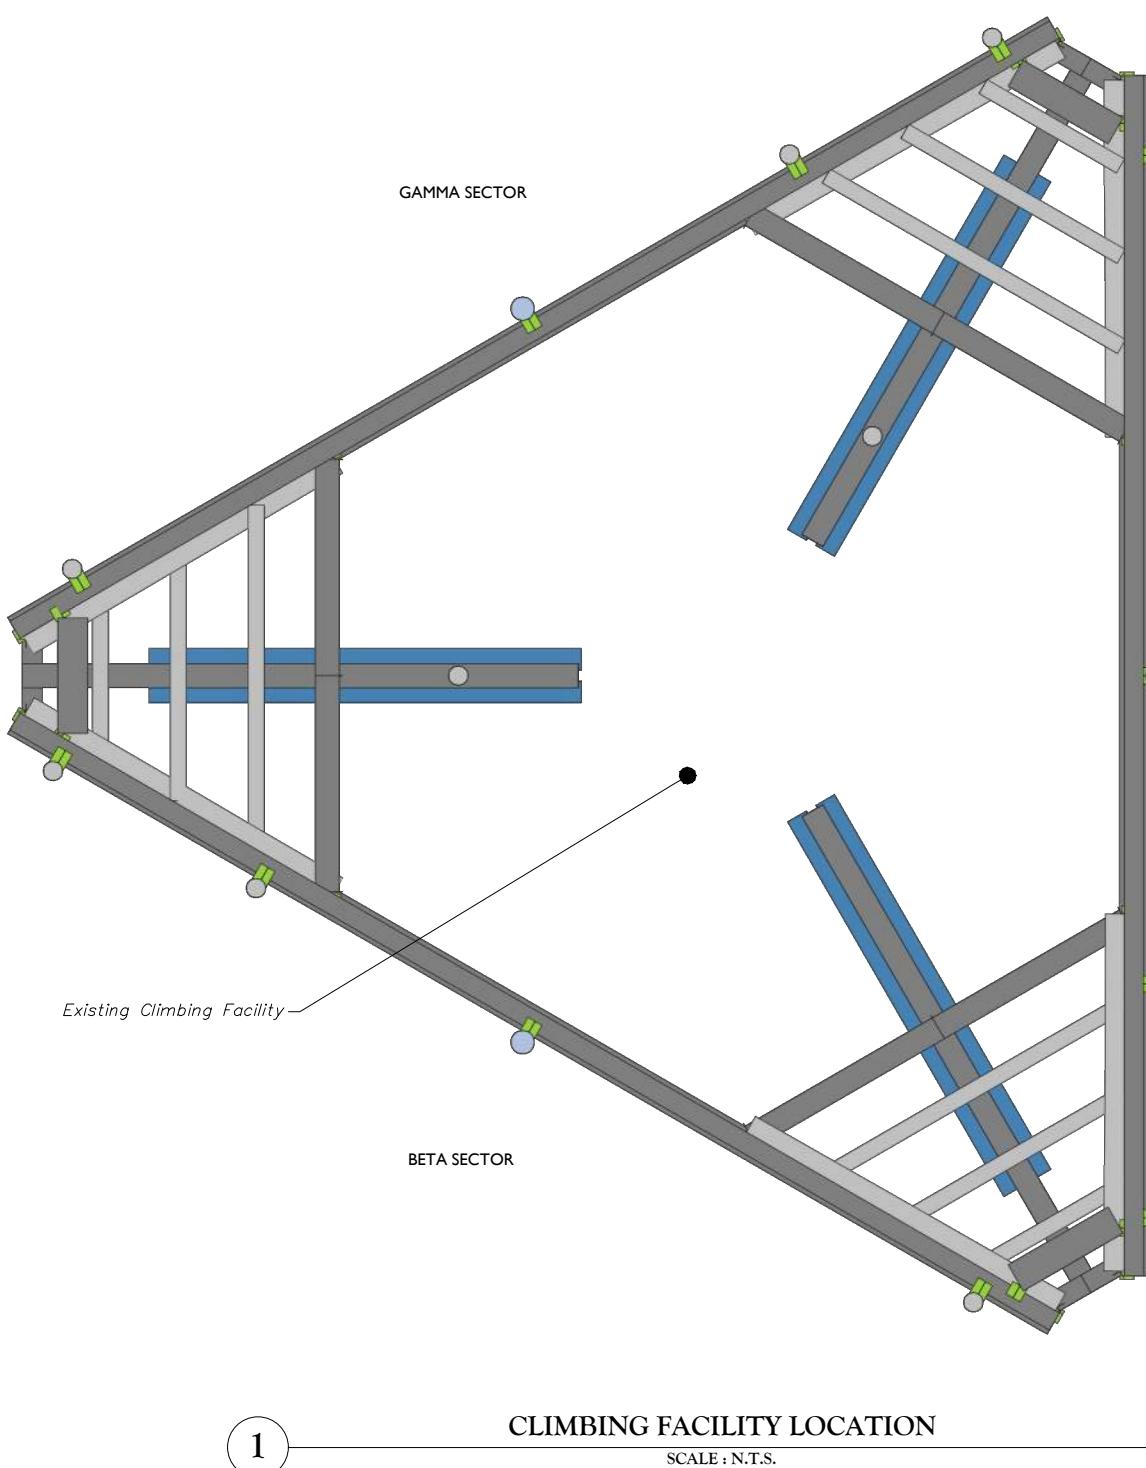

STRUCTURAL NOTES:

1. PER THE MOUNT MAPPING COMPLETED BY HUDSON DESIGN GROUP, LLC ON 10/6/2021, THE SAFETY CLIMB AND CLIMBING FACILITIES UP TO THE VERIZON MOUNT ELEVATION (73'-9") ARE IN GOOD CONDITION. COLLIER'S ENGINEERING & DESIGN DOES NOT WARRANT THIS INFORMATION.
2. INSTALL SHALL NOT CAUSE HARM TO THE STRUCTURE, CLIMBING FACILITY, SAFETY CLIMB, OR ANY SYSTEM INSTALLED ON THE STRUCTURE. TIMELY NOTICE AND DOCUMENTATION SHALL BE PROVIDED BY CONTRACTORS TO THE EOR (OF STRUCTURAL DESIGN) IF AN OBSTRUCTION WAS REQUIRED TO MEET THE RF SYSTEM DESIGN REQUIREMENTS AND PERFORMANCES.

ITEM #	QTY	PART NUMBER	DESCRIPTIONS
A	1	PV-SCRB-RM-U	WIRE ROPE GUIDE (PERFECT VISION OR EQUIV)

PROPOSED WIRE ROPE GUIDE ATTACHMENT - PLAN VIEW

SCALE : N.T.S.

NOTE: CONTRACTOR SHALL ENSURE THAT WIRE ROPE GUIDE DOES NOT PUSH THE WIRE ROPE OUTSIDE OF THE VERTICAL PLANE OF THE SAFETY CLIMB. CONTRACT FOR WITH PHOTOS OF SAFETY CLIMB AND COLLAR FOR FURTHER DIRECTION IF NEEDED.



CLIMBING FACILITY PHOTO


LEGEND:

	PROPOSED
	RELOCATED
	EXISTING

MOUNT MODIFICATION SCHEDULE				
NO.	ELEVATION	QUANTITY	DESCRIPTION	NOTES
1	73'-9"	1	PROPOSED KICKER KIT (PART #: VZWSMART-PLK5)	CONTRACTOR TO VERIFY THE LENGTH REQUIRED AND TRIM AS NECESSARY IN ACCORDANCE WITH THE 'STRUCTURAL STEEL' NOTES ON SHEET SGN-1. CONNECT OTHER END OF KICKER KIT TO MONOPOLE COLLAR MOUNT ASSEMBLY (PART #: VZWSMART-PLK7).
2		3	PROPOSED 72" LONG, P2 1/2 STD (PART #: VZWSMART-P40-278X072)	CONNECT NEW MOUNT PIPE TO EXISTING TOP HORIZONTAL WITH CROSSOVER PLATES (PART #: VZWSMART-MSK1). CONNECT TO EXISTING BOTTOM HORIZONTAL WITH CROSSOVER PLATES (SITE PRO 1 - SP219-H).
3		9	CROSSOVER PLATE	CONTRACTOR SHALL REPLACE ALL EXISTING TOP MOUNT PIPE TO SUPPORT RAIL CONNECTIONS WITH NEW CROSSOVER PLATES (VZWSMART-MSK1). CONTRACTOR SHALL ADJUST SUPPORT RAIL AND CORNER ANGLES AS NEEDED TO BE AGAINST MOUNT PIPES AND MAINTAIN VERTICAL ANTENNA PIPE ORIENTATION.
4		6	1/2" DIA. U-BOLTS	CONTRACTOR SHALL INSTALL ADDITIONAL U-BOLTS TO THE SUPPORT RAIL CORNER ANGLES SUCH THAT THERE ARE 2 U-BOLTS PER CONNECTION (4 PER CORNER ANGLE).

NOTES.


MOUNT MEMBERS NOT SHOWN FOR CLARITY U.N.O.
CONTRACTOR SHALL INSTALL THE PROPOSED OVP ON THE EXISTING OVP PIPE ON THE BETA/GAMMA SECTOR STANOFF. INSTALL THE OVP 12" DOWN FROM THE TOP OF THE PIPE. THREADED ROD FROM PROPOSED KITS SHALL BE TRIMMED TO EXTEND NO MORE THAN 3" BEYOND THE LOCK NUT. TREAT ALL CUT ENDS WITH (2) COATS OF COLD GALVANIZATION (ZINC KOTE, OR EOR APPROVED EQUAL).

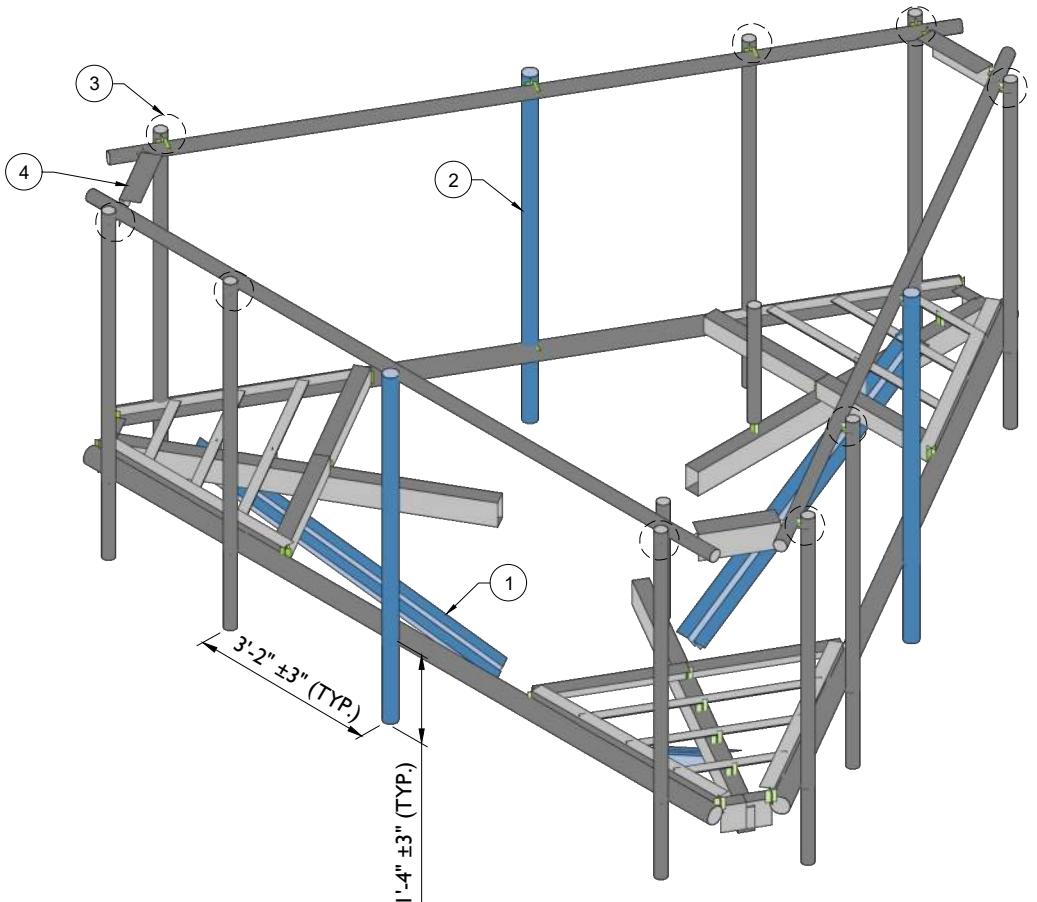

PROPOSED ISOMETRIC VIEW

SCALE : N.T.S.

1

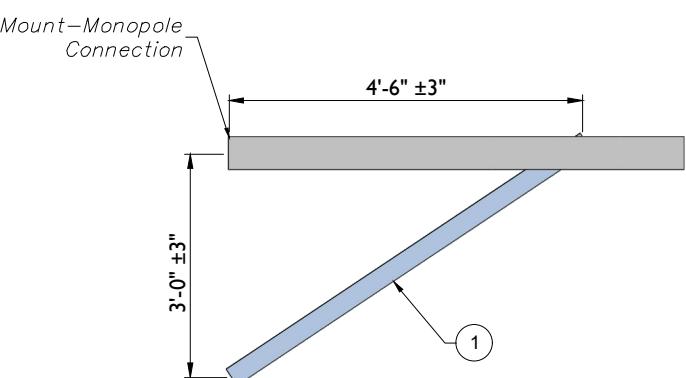

PROPOSED SIDE ELEVATION VIEW (TYP. ALL SECTORS)

SCALE : N.T.S.

2

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SCALE: AS SHOWN JOB NUMBER: 21777875

REV	DATE	DESCRIPTION	DRAWN BY	CHECKED BY
1	10/02/23	ISSUED FOR CONSTRUCTION	GHW	DX
0	03/23/22	ISSUED FOR CONSTRUCTION	AH	DH

COLLIERS ENGINEERING & DESIGN CT, P.C.
C.T. C.O.A. #JPC.0000131
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ENGINEER, TO ALTER THIS DOCUMENT.

SITE NAME:
MADISON 5 CT-FTP Orchard Park
5000392629
15 ORCHARD PARK RD
MADISON, CT 06443
NEW HAVEN COUNTY

STAMFORD
1055 Washington Boulevard
Stamford, CT 06901
Phone: 203.324.0000
COLLIERS ENGINEERING & DESIGN CT, P.C.
DOING BUSINESS AS MAKER CONSULTING

SHEET TITLE: MODIFICATION DETAILS

SHEET NUMBER: SS-1



MOUNT PHOTO 1



MOUNT PHOTO 2



MOUNT PHOTO 3



MOUNT PHOTO 4



PROTECT YOURSELF
ALL STATES REQUIRE NOTIFICATION OF
EXCAVATORS, DESIGNERS, OR ANY PERSON
PREPARING TO DISTURB THE EARTH'S
SURFACE ANYWHERE IN ANY STATE
Know what's below.
Call before you dig.
FOR STATE SPECIFIC DIRECT PHONE NUMBERS VISIT:
WWW.CALL811.COM

SCALE:	AS SHOWN	JOB NUMBER:	21777875
1	10/02/23	ISSUED FOR CONSTRUCTION	GHW DX
0	03/23/22	ISSUED FOR CONSTRUCTION	AH DH
REV	DATE	DESCRIPTION	DRAWN BY CHECKED BY

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SITE NAME:
MADISON 5 CT-FTP Orchard Park
5000392629



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MADISON, CT 06443
NEW HAVEN COUNTY

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1055 Washington Boulevard
Stamford, CT 06901
Phone: 203.321.0000
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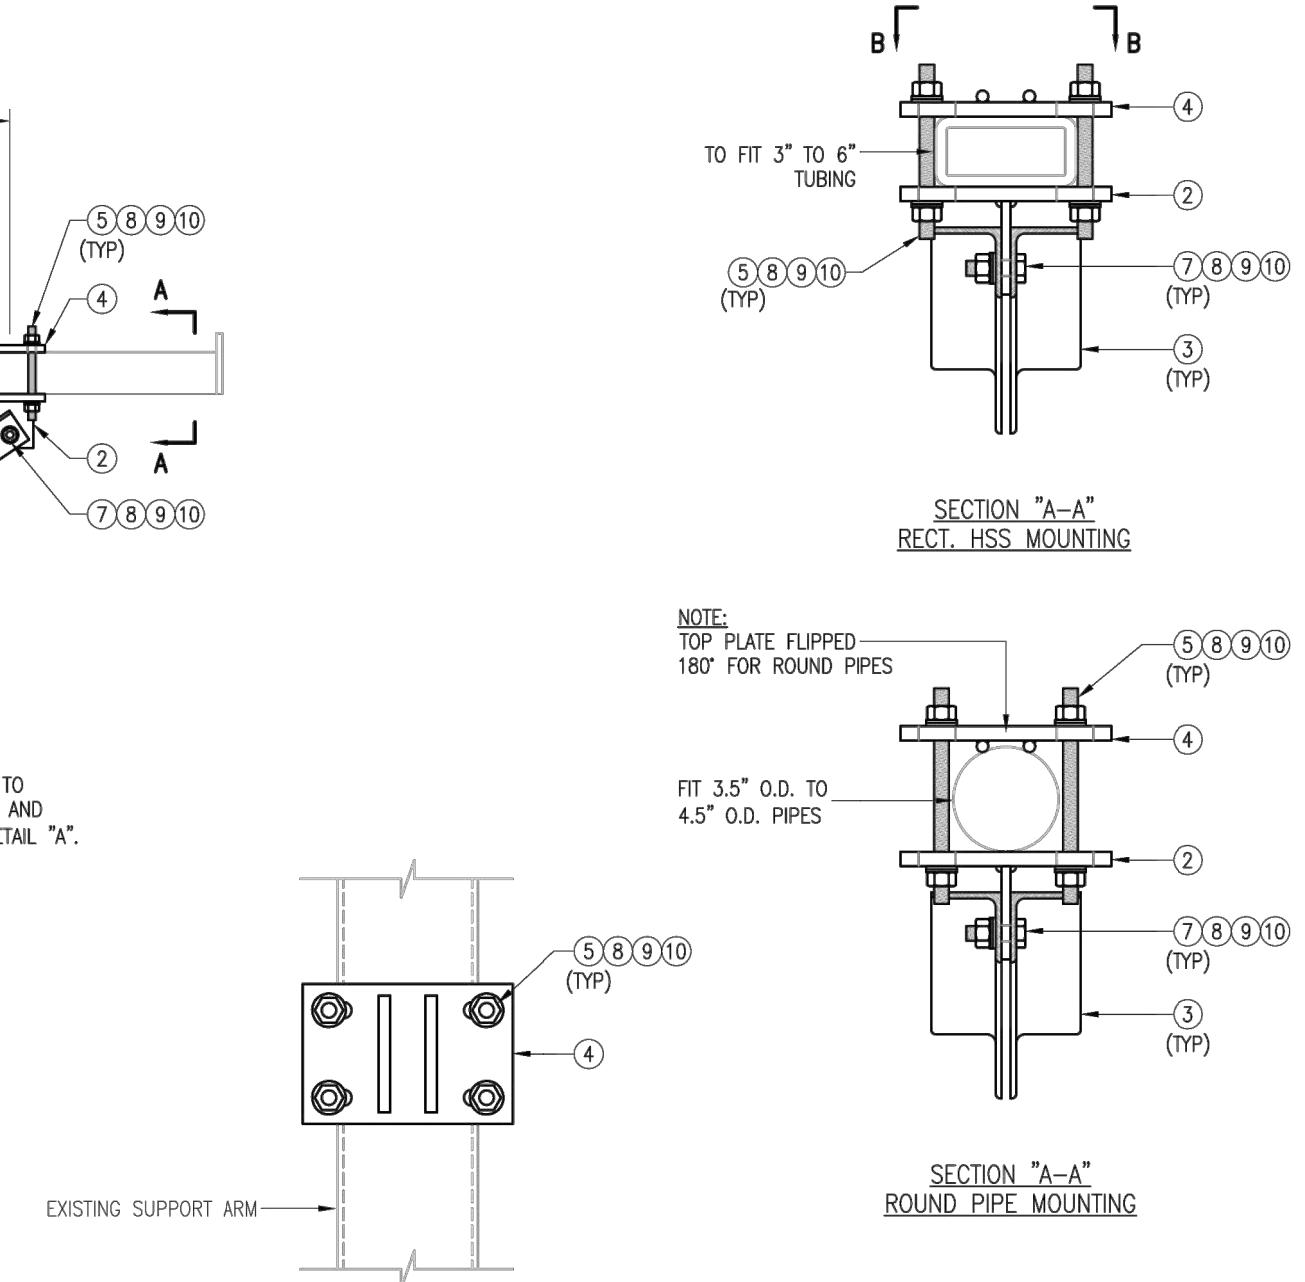
SHEET TITLE: MOUNT PHOTOS

SHEET NUMBER: SS-2

NOTE:
THE LOCATION OF KICKER AND EXISTING ANTENNA MOUNT SHOWN ON THE DRAWING IS FOR
REPRESENTATION PURPOSE ONLY. SEE INSTALLATION DRAWINGS FOR ACTUAL INSTALLATION OF DETAILS.

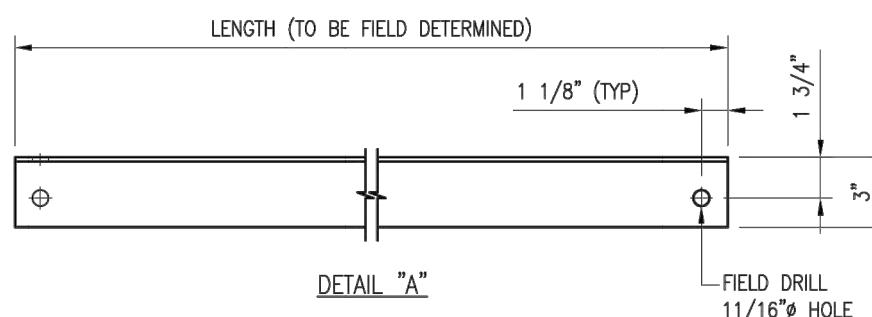
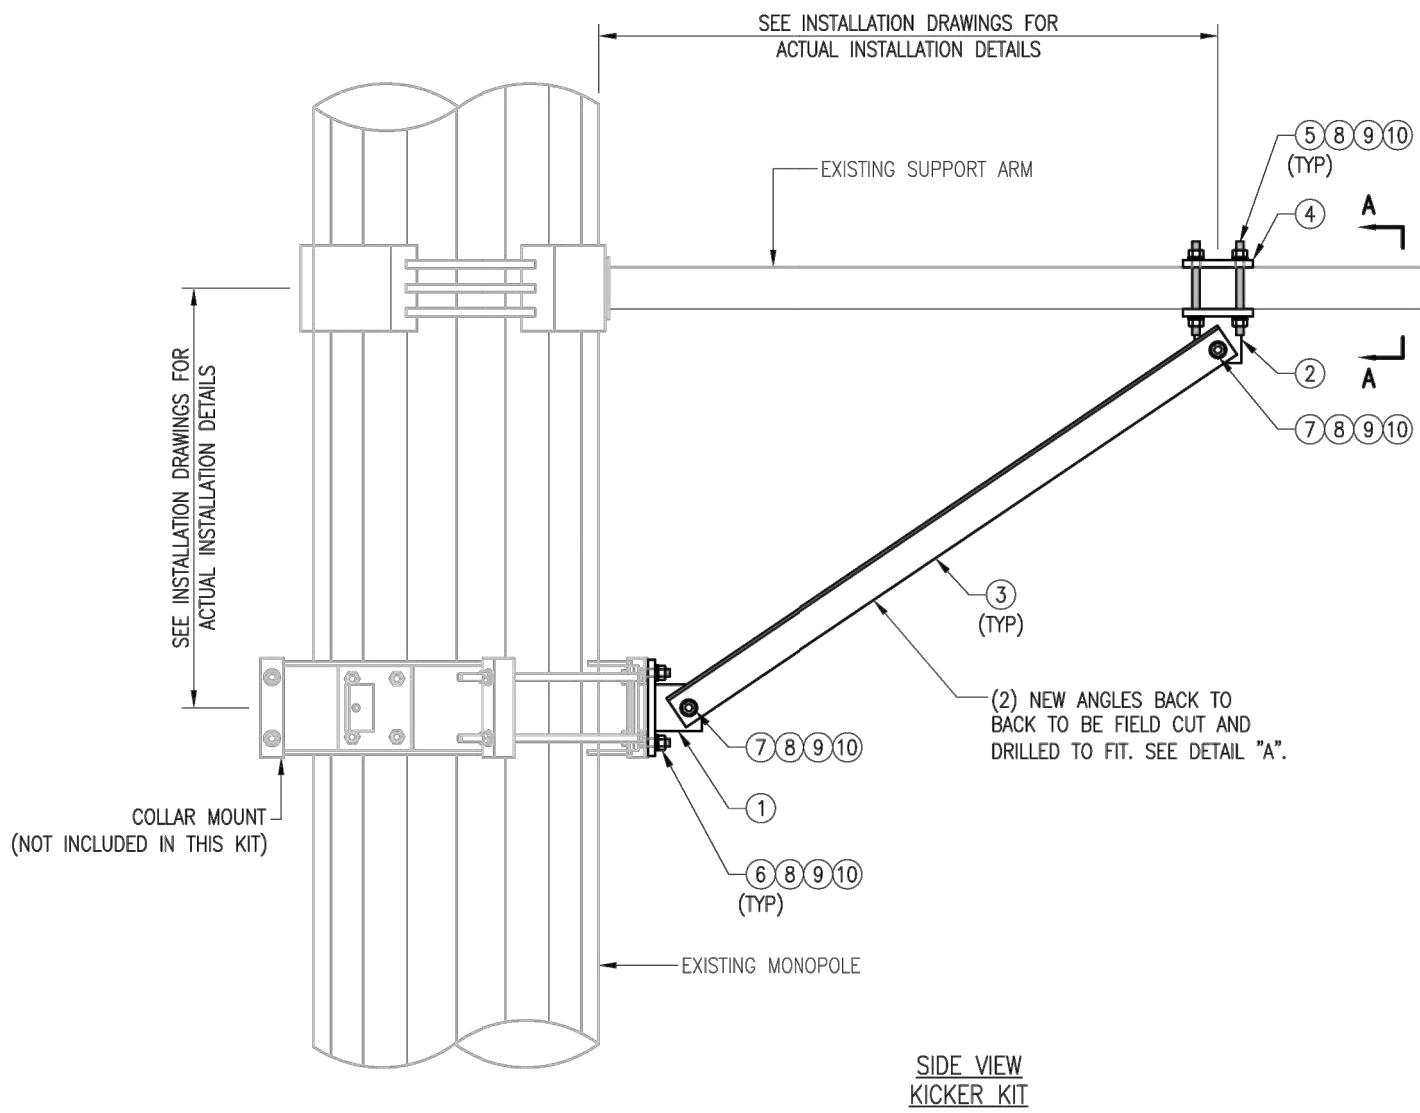


NOTES:
1. ALL HOLES ARE $11/16$ " DIA. U.N.O
2. HOT-DIPPED GALVANIZED PER ASTM A123.
3. FIT UP TO 6" SQ. TUBING OR 4 $1/2$ " O.D. PIPE



VZWSMART-PLK5 (KICKER KIT)						
ITEM NO.	QTY.	PART NO.	DESCRIPTION	SHEET #	WT	
1	3	BRKW-XXX	BRACKET WELDMENT A36	PLK5-F3	43.8	
2	3	BRKW-XXXX	BRACKET WELDMENT A36	PLK5-F2	35.7	
3	6	L331875-8	L 3" X 3" X 3/16" X 8'-0" A36	PLK5-F4	182.9	
4	3	PL-KI	PL 5/8" X 6" X 9" A36	PLK5-F1	29.0	
5	12	---	THREADED ROD 5/8" DIA. X 1'-0" F1554-36 HDG	---	---	
6	6	---	BOLT 5/8" X 2" A325	---	---	
7	12	---	BOLT 5/8" X 2 1/2" A325	---	---	
8	42	FW-625	5/8" HDG USS FLAT WASHER	---	3	
9	42	LW-625	5/8" HDG LOCK WASHER	---	1	
10	42	NUT-625	5/8" HDG HEX NUT	---	5	
GALVANIZED WT						291

DRAWN BY: MN		CHECKED BY: HMA/KW	
REV.	DESCRIPTION	BY	DATE
△	FIRST ISSUE	△	05/08/20
△		△	
△		△	
△		△	
SHEET TITLE:			
VZWSMART-PLK5 KICKER KIT			
SHEET NUMBER:	REV #:		
VZWSMART-PLK5	0		

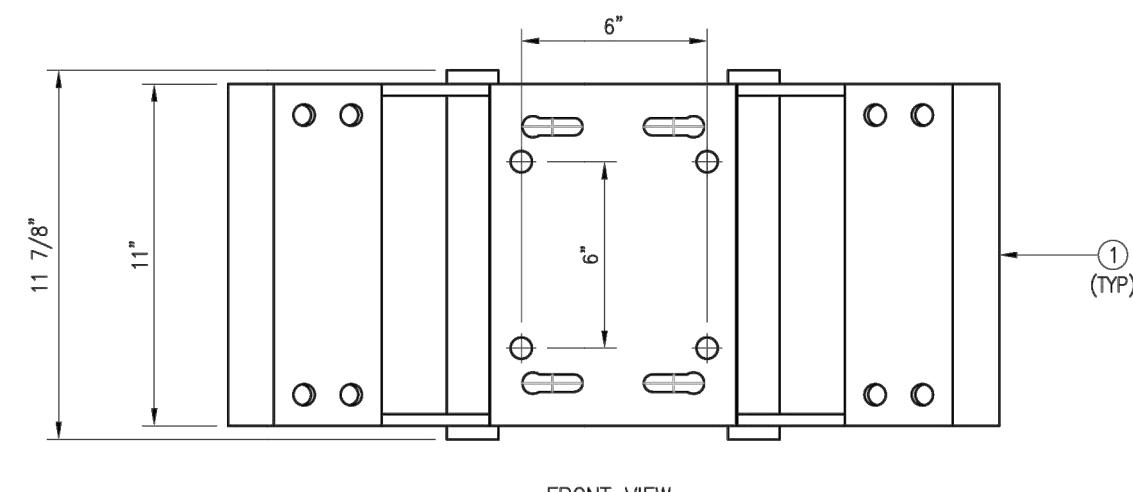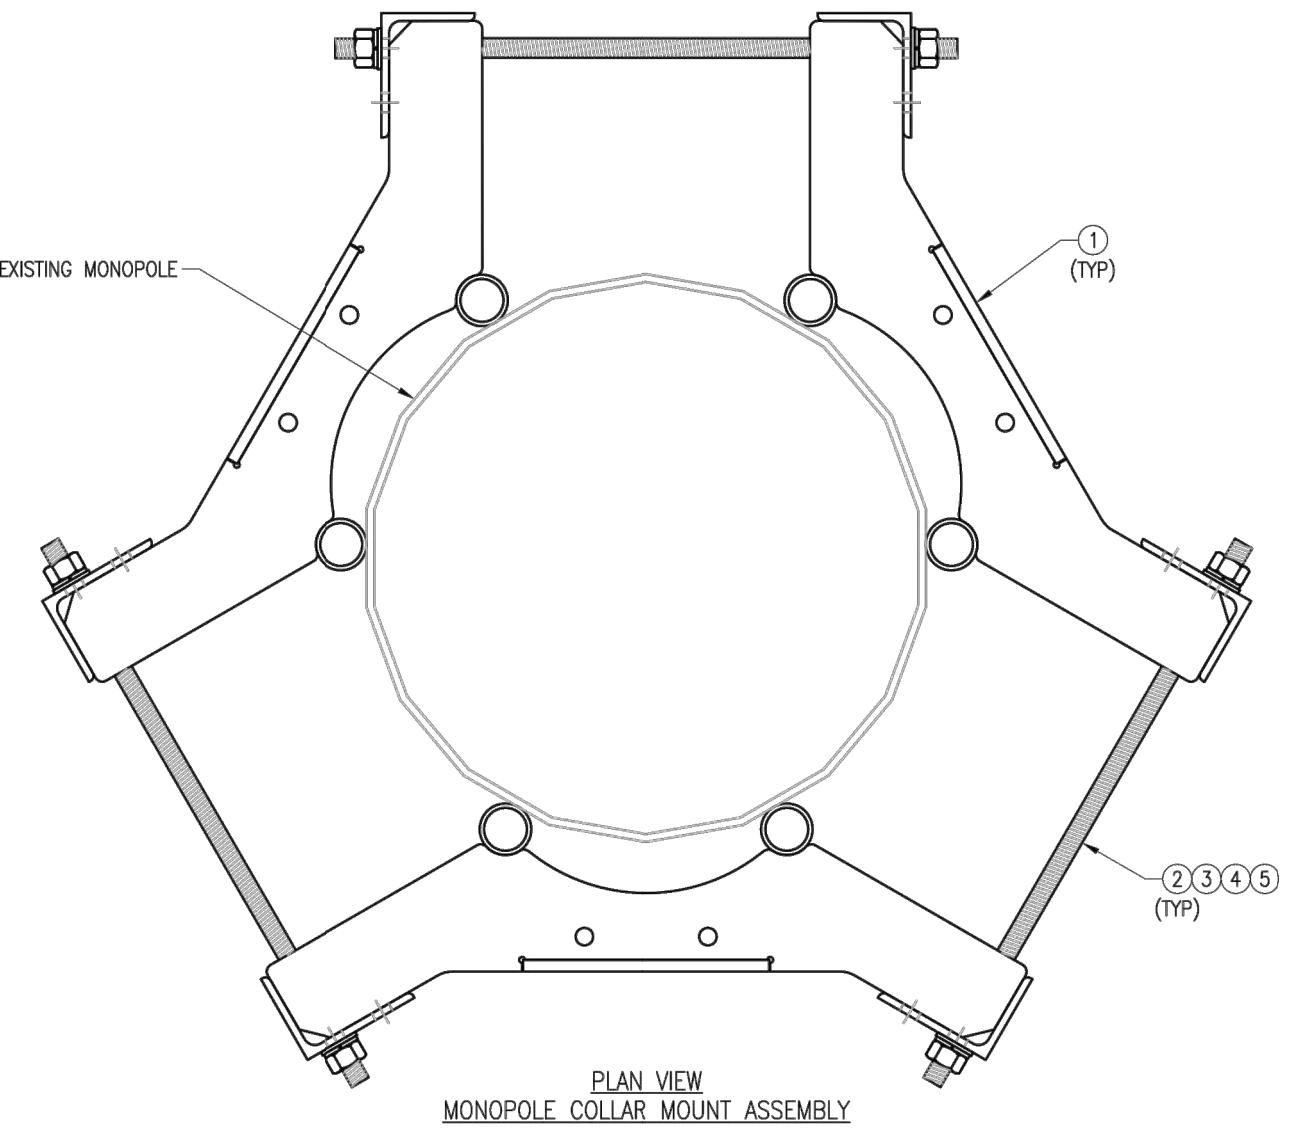

NOTES:
1. FIT 12" TO 45" DIA MONPOLE.
2. HOT-DIPPED GALVANIZED PER ASTM A123.

ITEM NO.	QTY.	PART NO.	DESCRIPTION	SHEET #	WT
1	3	CM-1245	COLLAR MOUNT ASSEMBLY	PLK7-F1	147
2	6	---	THREADED ROD 5/8" X 4'-0" A193-B7	---	
3	12	FW-625	5/8" HDG USS FLAT WASHER	---	1
4	12	LW-625	5/8" HDG LOCK WASHER	---	0
5	12	NUT-625	5/8" HDG HEX NUT	---	1
					GALVANIZED WT 150



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REV. DESCRIPTION BY DATE
△ FIRST ISSUE BT 05/11/20

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SHEET TITLE:
VZWSMART-PLK7
MONOPOLE COLLAR
MOUNT ASSEMBLY

SHEET NUMBER: VZWSMART-PLK7 | REV #: 0



PL375-857

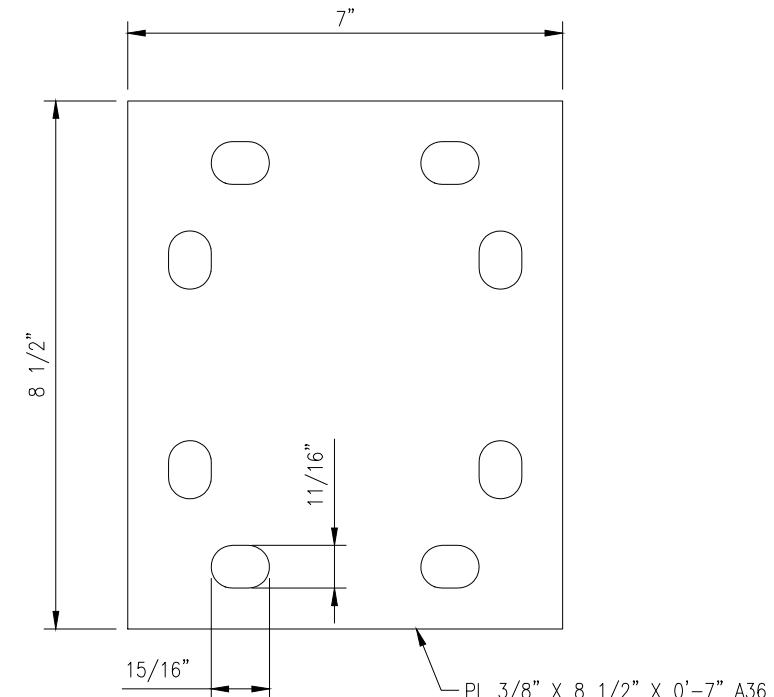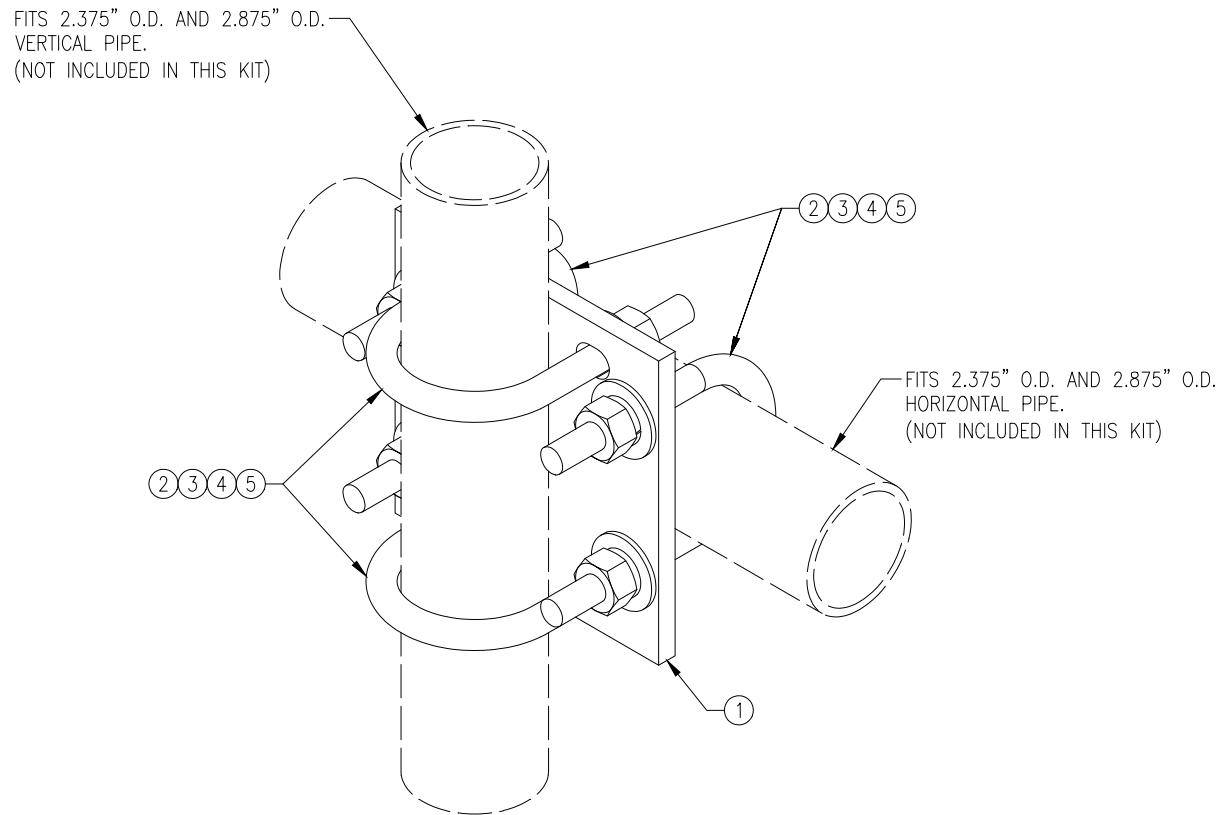VZWSMART-MSK1 (CROSSOVER PLATE)						
ITEM NO.	QTY.	PART NO.	DESCRIPTION	SHEET #	WT	
1	1	PL375-857	PL 3/8" X 8 1/2" X 0'-7" A36	MSK1-F1	6	
2	4	MS02-625-300-500	RU-BOLT 5/8" X 3" I.W. X 5" I.L. A36 (OR EQUIV.)	RBC-1	5	
3	8	FW-625	5/8" HDG USS FLAT WASHER	---	1	
4	8	LW-625	5/8" HDG LOCK WASHER	---	0	
5	8	NUT-625	5/8" HDG HEX NUT	---	1	
GALVANIZED WT						14

NOTES:

1. HOT-DIPPED GALVANIZED PER ASTM A123.


DRAWN BY: H.R. | CHECKED BY: HMA

REV. DESCRIPTION BY DATE
 △ FIRST ISSUE H.R. 05/08/20

△
 △
 △
 △

SHEET TITLE:
 VZWSMART-MSK1
 CROSSOVER PLATE

SHEET NUMBER: VZWSMART-MSK1 | REV #: 0

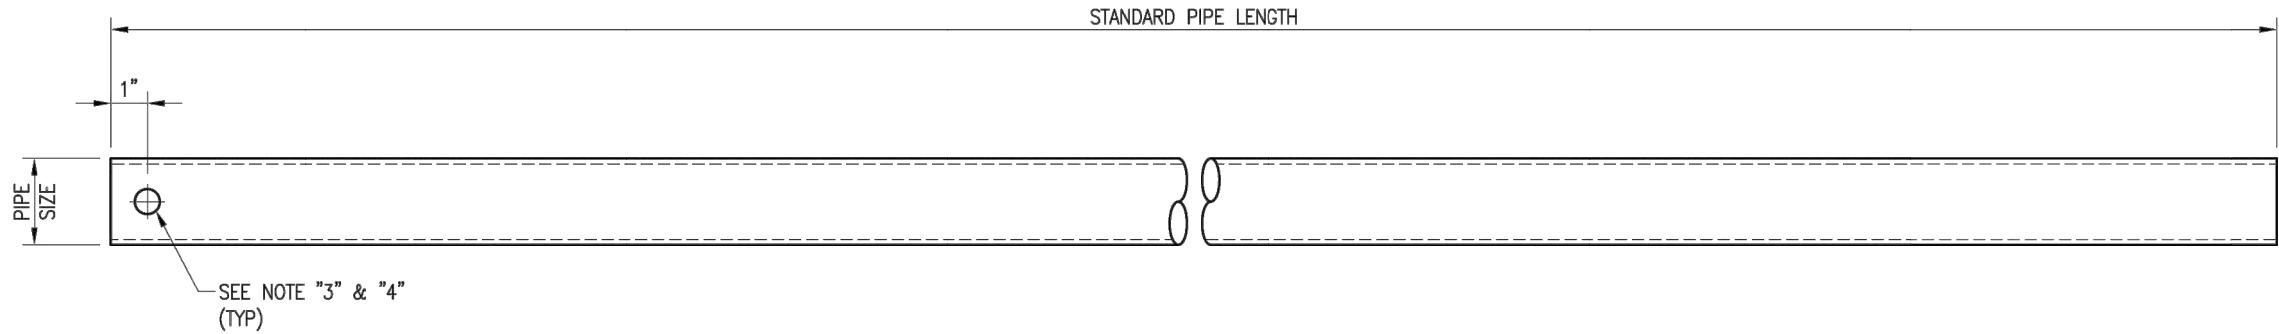

VZWSMART Standard Pipe		
VZWSMART Number	Size	Length
P40-238X048	PIPE 2 SCH40 (2.375" OD x 0.154" THK)	48"
P40-238X072	PIPE 2 SCH40 (2.375" OD x 0.154" THK)	72"
P40-238X096	PIPE 2 SCH40 (2.375" OD x 0.154" THK)	96"
P40-238X120	PIPE 2 SCH40 (2.375" OD x 0.154" THK)	120"
P40-238X126	PIPE 2 SCH40 (2.375" OD x 0.154" THK)	126"
P40-238X150	PIPE 2 SCH40 (2.375" OD x 0.154" THK)	150"
P40-238X174	PIPE 2 SCH40 (2.375" OD x 0.154" THK)	174"
P40-278X048	PIPE 2.5 SCH40 (2.875" OD x 0.203" THK)	48"
P40-278X072	PIPE 2.5 SCH40 (2.875" OD x 0.203" THK)	72"
P40-278X096	PIPE 2.5 SCH40 (2.875" OD x 0.203" THK)	96"
P40-278X120	PIPE 2.5 SCH40 (2.875" OD x 0.203" THK)	120"
P40-278X126	PIPE 2.5 SCH40 (2.875" OD x 0.203" THK)	126"
P40-278X150	PIPE 2.5 SCH40 (2.875" OD x 0.203" THK)	150"
P40-278X174	PIPE 2.5 SCH40 (2.875" OD x 0.203" THK)	174"
P40-312X048	PIPE 3 SCH40 (3.5" OD x 0.216" THK)	48"
P40-312X072	PIPE 3 SCH40 (3.5" OD x 0.216" THK)	72"
P40-312X126	PIPE 3 SCH40 (3.5" OD x 0.216" THK)	126"
P40-312X150	PIPE 3 SCH40 (3.5" OD x 0.216" THK)	150"
P40-312X174	PIPE 3 SCH40 (3.5" OD x 0.216" THK)	174"

NOTE:
APPROVED SMART KIT VENDORS ARE ALLOWED TO SUBSTITUTE AT THEIR DISCRETION
PIPES LISTED ON THIS PAGE FOR CUSTOM LENGTH COMPONENTS OF MATCHING SIZE.
SUBSTITUTIONS SHALL MEET THE ORIGINAL STRUCTURAL INTENT.

NOTES:

1. ALL PIPE GRADE A53-B OR BETTER.
2. HOT-DIPPED GALVANIZED PER ASTM A123.
3. ALL HOLES ARE 11/16" DIA. U.N.O.
4. HOLES MAY OR MAY NOT BE PRESENT, DEPEND UPON MANUFACTURE DISCRETION.
5. ALL FIELD CUT AND DRILLED SURFACES SHALL BE REPAIRED WITH A MINIMUM OF TWO COATS OF ZINGA OR ZINC COATE PER ASTM A780 AND MANUFACTURER'S RECOMMENDATIONS.

DRAWN BY: BT | CHECKED BY: HMA/KW

REV. DESCRIPTION BY DATE
△ FIRST ISSUE BT 08/04/21


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SHEET TITLE:

VZWSMART
STANDARD PIPE

SHEET NUMBER: VZWSMART-PIPE | REV #: 0

PARTS LIST							
ITEM	QTY	PART NO.	PART DESCRIPTION	LENGTH	UNIT WT.	NET WT.	
1	1	X-SP219	SMALL SUPPORT CROSS PLATE	8 1/4 in	8.61	8.61	
2	2	X-UB1306	1/2" X 3-5/8" X 6" X 3" U-BOLT (HDG.)		0.66	1.31	
3	2	X-UB1300	1/2" X 3" X 5" X 2" U-BOLT (HDG.)		0.66	1.31	
4	8	G12FW	1/2" HDG USS FLATWASHER		0.03	0.27	
5	8	G12LW	1/2" HDG LOCKWASHER		0.01	0.11	
6	8	G12NUT	1/2" HDG HEAVY 2H HEX NUT		0.07	0.57	
							TOTAL WT. # 12.61

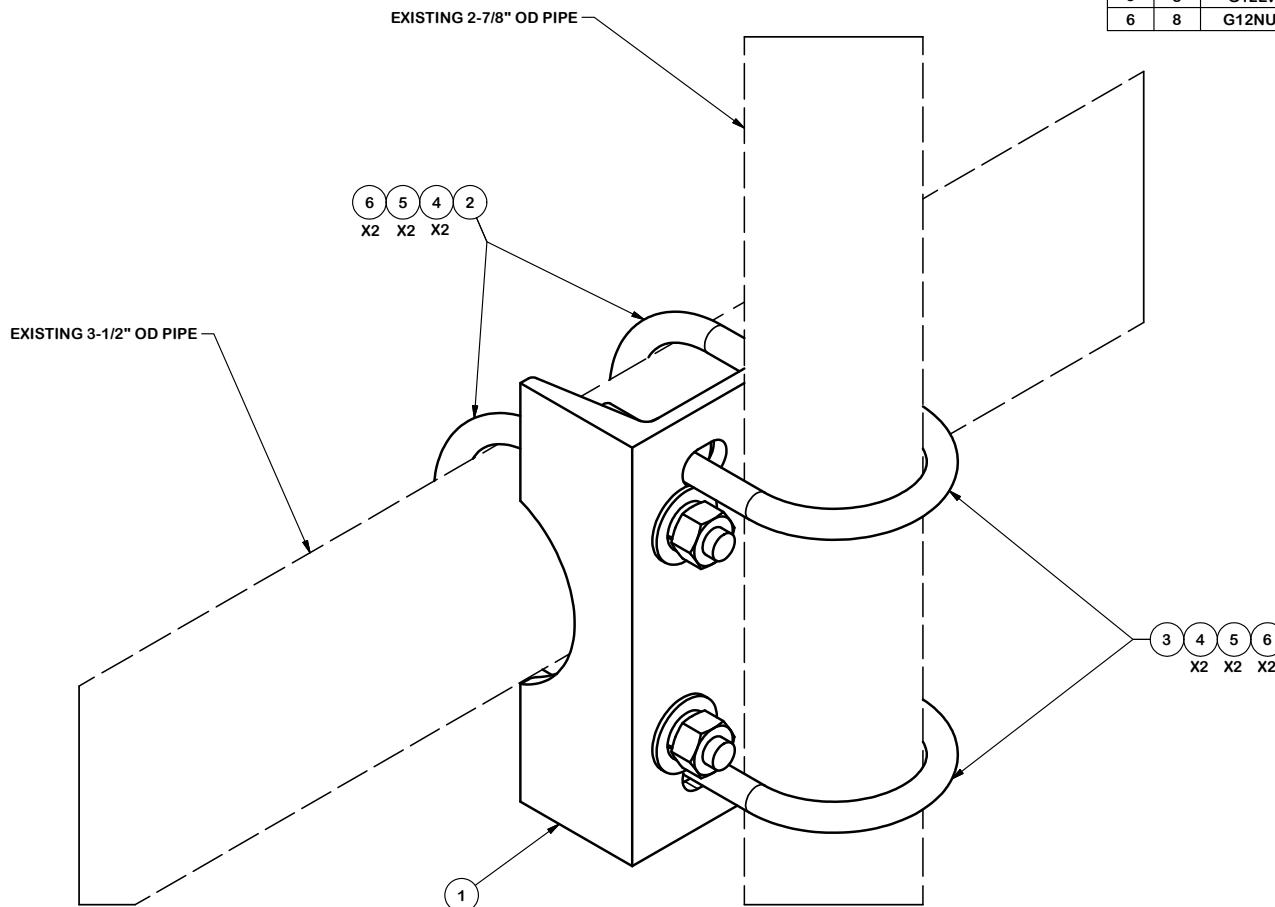

TOLERANCE NOTES				DESCRIPTION				Locations			
TOLERANCES ON DIMENSIONS, UNLESS OTHERWISE NOTED ARE: SAWED, SHEARED AND GAS CUT EDGES ($\pm 0.030"$) DRILLED AND GAS CUT HOLES ($\pm 0.030"$) - NO CONING OF HOLES LASER CUT EDGES AND HOLES ($\pm 0.010"$) - NO CONING OF HOLES BENDS ARE $\pm 1/2$ DEGREE ALL OTHER MACHINING ($\pm 0.030"$) ALL OTHER ASSEMBLY ($\pm 0.060"$)				2-7/8" TO 3-1/2" PIPE MOUNT ASSEMBLY				New York, NY Atlanta, GA Los Angeles, CA Plymouth, IN Salem, OR Dallas, TX			
PROPRIETARY NOTE: THE DATA AND TECHNIQUES CONTAINED IN THIS DRAWING ARE PROPRIETARY INFORMATION OF VALMONT INDUSTRIES AND CONSIDERED A TRADE SECRET. ANY USE OR DISCLOSURE WITHOUT THE CONSENT OF VALMONT INDUSTRIES IS STRICTLY PROHIBITED.				CPD NO. 4518 DRAWN BY BMC 6/3/2009 ENG. APPROVAL				PART NO. SP219-H			
A REDRAWN IN INV, UPDATED VIEWS & TABLE				CLASS 81 SUB 01 DRAWING USAGE CUSTOMER CHECKED BY CEK 2/18/2013				DWG. NO. SP219-H			
REV	DESCRIPTION OF REVISIONS										
	REVISION HISTORY										