

STATE OF CONNECTICUT

CONNECTICUT SITING COUNCIL

Ten Franklin Square, New Britain, CT 06051 Phone: (860) 827-2935 Fax: (860) 827-2950 E-Mail: siting.council@ct.gov www.ct.gov/csc

April 21, 2011

Mark Hulshart, Principal Hulshart & Associates, LLC 3009 Federal Hill Drive Falls Church, VI 22044

EM-SPRINT-076-110329 - Sprint Spectrum L.P. notice of intent to modify an existing RE: telecommunications facility located at 135 New Road, Madison, Connecticut. Dear Mr. Hulshart:

The Connecticut Siting Council (Council) hereby acknowledges your notice to modify this existing telecommunications facility, pursuant to Section 16-50j-73 of the Regulations of Connecticut State Agencies

- Any deviation from the proposed modification as specified in this notice and supporting materials with Council shall render this acknowledgement invalid;
- Any material changes to this modification as proposed shall require the filing of a new notice with the
- Not less than 45 days after completion of construction, the Council shall be notified in writing that
- The validity of this action shall expire one year from the date of this letter; and
- The applicant may file a request for an extension of time beyond the one year deadline provided that such request is submitted to the Council not less than 60 days prior to the expiration;

The proposed modifications including the placement of all necessary equipment and shelters within the tower compound are to be implemented as specified here and in your notice dated March 23, 2011. The modifications are in compliance with the exception criteria in Section 16-50j-72 (b) of the Regulations of Connecticut State Agencies as changes to an existing facility site that would not increase tower height, extend the boundaries of the tower site, increase noise levels at the tower site boundary by six decibels, and increase the total radio frequencies electromagnetic radiation power density measured at the tower site boundary to or above the standard adopted by the State Department of Environmental Protection pursuant to General Statutes § 22a-162. This facility has also been carefully modeled to ensure that radio frequency emissions are conservatively below State and federal standards applicable to the frequencies now used on this tower.

This decision is under the exclusive jurisdiction of the Council. Please be advised that the validity of this action shall expire one year from the date of this letter. Any additional change to this facility will require explicit notice to this agency pursuant to Regulations of Connecticut State Agencies Section 16-50j-73. Such notice shall include all relevant information regarding the proposed change with cumulative worst-case modeling of radio frequency exposure at the closest point of uncontrolled access to the tower base, consistent with Federal Communications Commission, Office of Engineering and Technology, Bulletin 65. Thank you Very truly yours,

Executive Director

LR/CDM/laf

The Honorable Fillmore McPherson, First Selectman, Town of Madison Marilyn M. Ozols, Planning & Zoning Administrator, Town of Madison Robert D. Gray, Program Administrator, Third Party Attachments Transmission Projects, Northeast Utilities Service Company

EM-SPRINT-076-110329

FEDERAL HILL DRIVE IRCH, VIRGINIA 22044 phone 703.533.1006

March 23, 2011

ORIGINALD MARZEZON

Chairman Daniel F. Caruso Connecticut Siting Council 10 Franklin Square New Britain, CT 06051

SITING COUNCIL

SUBJECT:

Sprint Spectrum Realty Company L.P.'s Notice of Intent to Make an Exempt Modification to an Existing Facility at 135 New Road, Madison, CT 06443 (Site # CT03XC023)

Dear Chairman Caruso:

Pursuant to R.C.S.A. Sections 16-50j-73 and 16-50j-72(b), Sprint Spectrum Realty Company L.P. (Sprint) hereby gives notice to the Connecticut Siting Council (Council) and the Town of Madison of its intent to make an exempt modification to an existing telecommunications facility located at 135 New Road, Madison, Connecticut.

Sprint plans to install a hydrogen fuel cell at its 135 New Road facility to provide emergency backup power in the event of an electric outage. This planned installation does not constitute a modification subject to the Council's review as it falls within those activities provided for in R.C.S.A. Section 16-50j-72(b)(2). Specifically, this installation will not change the height of the existing tower, will not extend the boundaries of the existing compound, will not increase noise levels at the site by six decibels or more, and will not increase the total radio frequency electromagnetic radiation power density at the site to levels above applicable standards.

PROPOSED INSTALLATION

Sprint plans to install a 4kW ReliOn hydrogen fuel cell generator within the existing fenced equipment compound; the entire installation mounted to a new 6'0" x 9'0" concrete pad. The fuel cell will be inside a cabinet measuring 3'4" x 2'4" x 6'0". There will also be four cabinets with dimensions of 4'8" x 4'8" x 6'0", each cabinet houses four hydrogen cylinders.

Please contact me at 703.533.1006 should you have any questions about this planned modification.

Sincerely,

Mark Hulshart

Principal

cc: Fillmore McPherson, First Selectman, Town of Madison

Marco Charamella, Connecticut Light & Power, property owner (135 New Road)

PARTON OF PARTON AND PROPERTY SOLUTION





Features:

- T-2000® Outdoor Solution
- Ideal for site loads ranging from 0 4kW
 - Simple installation
 - Minimal site footprint
- Modular fuel storage solutions available for extended run capabilities

	07 50 (40 700 /70 404 400)
Dimensions (w x d x h)	27.5" x 41" x 72" (70 cm x 104 cm x 183 cm)
Weight	654 lbs / 297.3 kg without cylinders
Rated net power	0 to 4,000 Watts
Rated current	0 to 160A @ 24 VDC / 0 to 80A @ 48 VDC
DC voltage	24 or 48 VDC nominal
Fuel Composition	Standard industrial grade hydrogen (99.95%)
Supply pressure to unit	3.5 to 6 psig / 24 to 41 KPag / 0.24 bar to 0.41 bar
Fuel Consumption	60 slpm @ 4,000 Watts
Hydrogen Storage Capacity	Modular fuel storage solutions available
Ambient temperature	-40°F to 115°F / -40°C to 46°C
Relative humidity	0 to 95% non-condensing
Altitude -197 ft to 13,800 ft / -60m to 4,206m	
Location	Outdoors
Safety Compliance	UL/CSA/CE/NEBS
Water emissions	Max. 30mL / kWh
Noise	47 dBA @ 5 ft
Remote Monitoring/Control	System configuration & status / Historical & operational data
Communications	RJ45 / DB9/ Dry Contact



SITE NAME:

MADISON CONNECTICUT LIGHT & POWER

T-1

C-1

C-2

S-1

S-2

M-1

E-1

E-2

E-3

E-4

G-1

SITE NUMBER:

CT03XC023

SITE ADDRESS:

135 NEW ROAD

MADISON, CT 06443

SITE TYPE:

[145]

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EXISTING 180'-0" GUYED TOWER





6580 SPRINT PARKWAY OVERLAND PARK, KANSAS 66251



10950 GRANDVIEW DRIVE OVERLAND PARK, KANSAS 66210 (913) 458-2000

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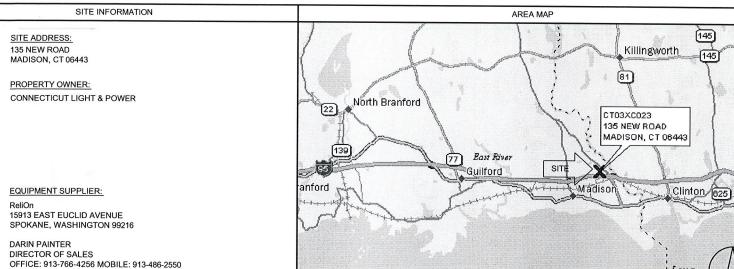
DIRECTION OF A LICENSED PROFESSIONAL ENGINEER, TO ALTER THIS DOCUMENT.

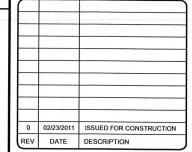MADISON CONNECTICUT LIGHT & POWER CT03XC023 135 NEW ROAD MADISON, CT 06443 **CO-LOCATION**

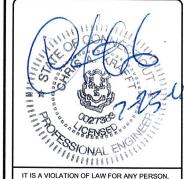SHEET TITLE

TITLE SHEET & **PROJECT DATA**

T-1



dpainter@relion-inc.com

CONNECTICUT LIGHT & POWER PHONE: 800-286-5000

POWER COMPANY:

TELCO COMPANY:

LATITUDE (NAD83):

LONGITUDE (NAD83):

CONTACT ENGINEER:

WORK: 913-458-7343

E-MAIL: hansenbj@bv.com


41° 17' 36.348" N

72° 34' 42.157" W -72.578377

BRYAN HANSEN

COUNTY: NEW HAVEN

41.293430

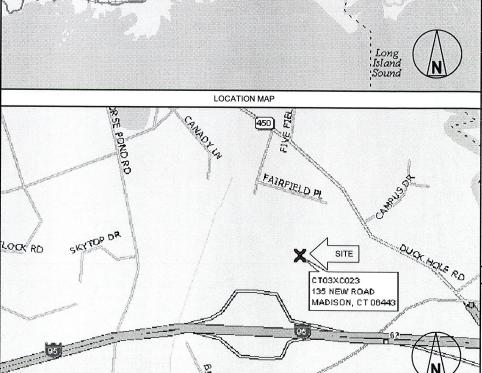

PROJECT DESCRIPTION INSTALL POWER BACK UP EQUIPMENT TO EXISTING SITE WITHIN EXISTING COMPOUND. INSTALL (1) NEW FUEL CELL WITH (1) FUEL

IN THE EVENT OF CONFLICT, THE MOST RESTRICTIVE CODE SHALL

APPLICABLE CODES

ALL WORK SHALL COMPLY WITH THE FOLLOWING APPLICABLE

2003 INTERNATIONAL BUILDING CODE WITH 2005 STATE OF

2003 INTERNATIONAL MECHANICAL CODE OF CONNECTICUT

2003 INTERNATIONAL PLUMBING CODE OF CONNECTICUT

CONNECTICUT MODIFICATIONS

2005 NEC NATIONAL ELECTRICAL CODE

STORAGE CABINET ON CONCRETE PAD AND CONNECT TO THE SITE'S

ENGINEER OF RECORD

DRAWING INDEX

TITLE SHEET & PROJECT DATA

EQUIPMENT CABINET DETAILS

HYDROGEN PIPING SCHEMATIC

ELECTRICAL ONE-LINE DIAGRAM

ELECTRICAL WIRING DIAGRAM

GROUNDING PLAN AND DETAILS

OVERALL CONDUIT DETAILS

FUEL CELL INSTALL DETAIL

CONCRETE PAD DETAILS

OVERALL SITE PLAN


SITE PLAN

CHRISTOPHER ALAN KRAFFT PE # 0027383

BLACK & VEATCH CORPORATION

DRIVING DIRECTIONS FROM NEAREST AIRPORT

GRISWOLD AIRPORT: HEAD NORTH TOWARD US-1 S/BOSTON POST ROAD, SHARP LEFT AT US-1 S/BOSTON POST ROAD, TAKE THE 3RD RIGHT ONTO HAMMONASSET CON, MERGE ONTO I-95 S VIA THE RAMP TO NEW HAVEN, TAKE THE EXIT, CONTINUE STRAIGHT, DESTINATION WILL BE ON THE RIGHT

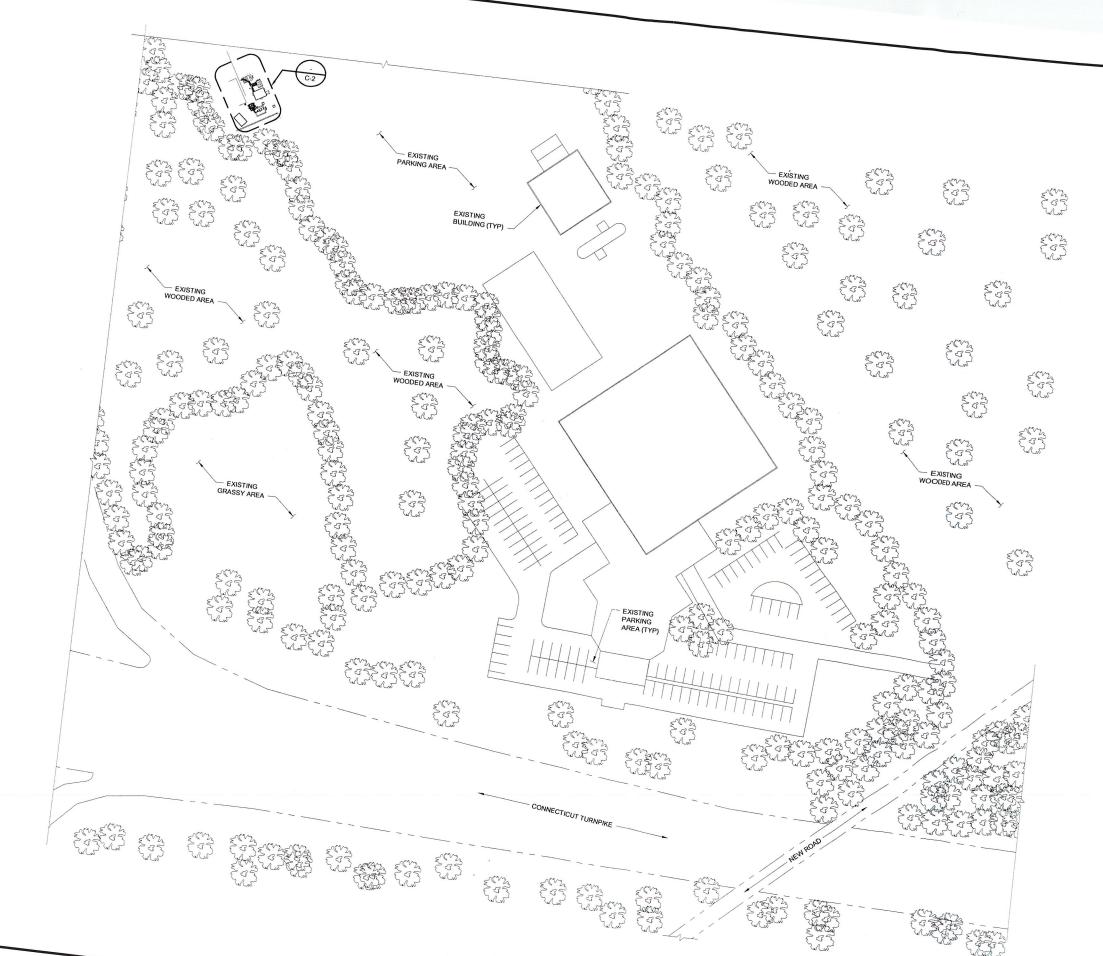





10950 GRANDVIEW DRIVE OVERLAND PARK, KANSAS 66210 (913) 458-2000

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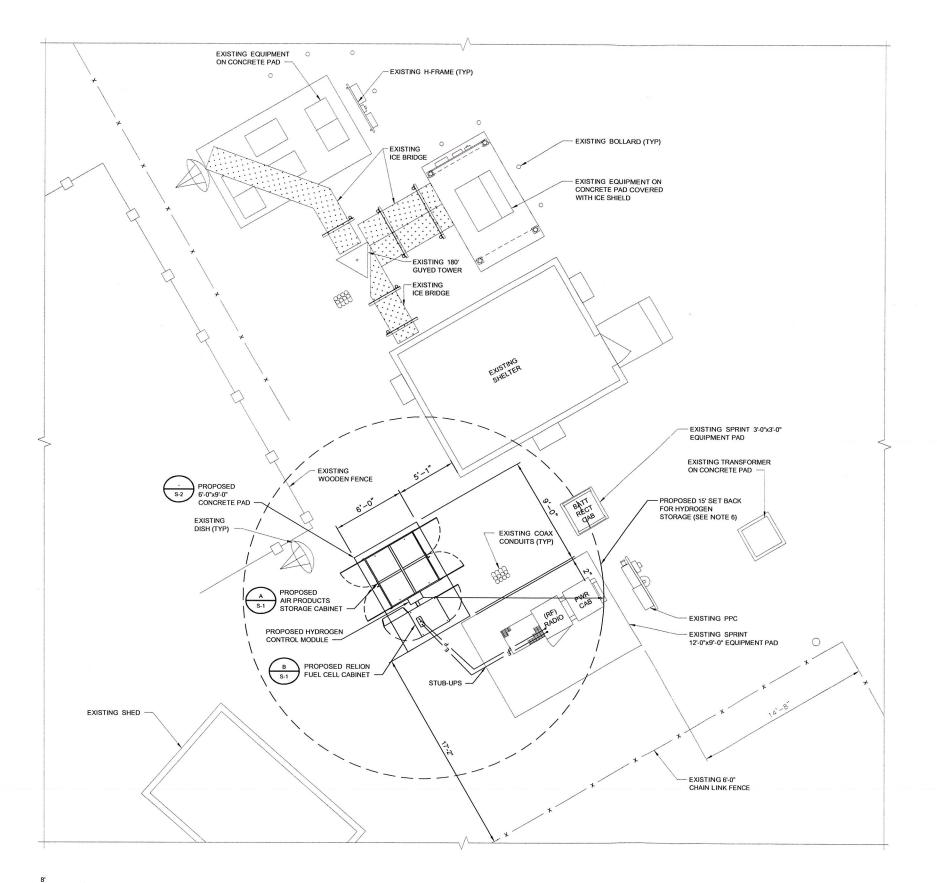
MADISON CONNECTICUT LIGHT & POWER
CT03XC023
135 NEW ROAD
MADISON, CT 06443
CO-LOCATION

SHEET TITLE

OVERALL SITE PLAN

OVERALL SITE PLAN

NO SCALE



SITE PLAN

GENERAL NOTES:

- CONTRACTOR SHALL GROUND ALL NEW EQUIPMENT TO THE NEAREST GROUND RING (SEE G-1).
- CONTRACTOR SHALL ROUTE CONDUIT TO AVOID TRIP HAZARDS BY EITHER
 UTILIZING EXISTING CABLE TRAY, OVERHEAD ICE BRIDGE, UNDERNEATH RAISED
 PLATFORM, OR AROUND EDGE OF CONCRETE PAD.
- 3. CONTRACTOR SHALL FOLLOW ALL MANUFACTURER'S RECOMMENDATIONS FOR INSTALLATION OF ALL NEW EQUIPMENT.
- 4. CONTRACTOR SHALL VERIFY THE ALARM CABLES ARE OF SUFFICIENT LENGTH.
- 5. EXCESS CABLES SHALL BE LACED IN A NEAT AND ORGANIZED MANNER.
- HYDROGEN STORAGE CABINET HAS A REQUIRED SET BACK OF 15' FROM IGNITION SOURCES & AIR INTAKES.



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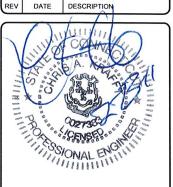


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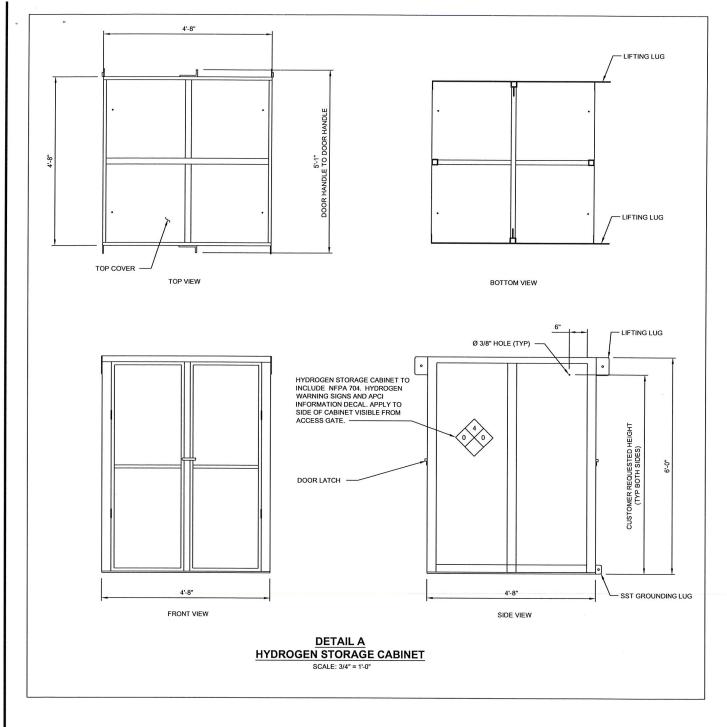
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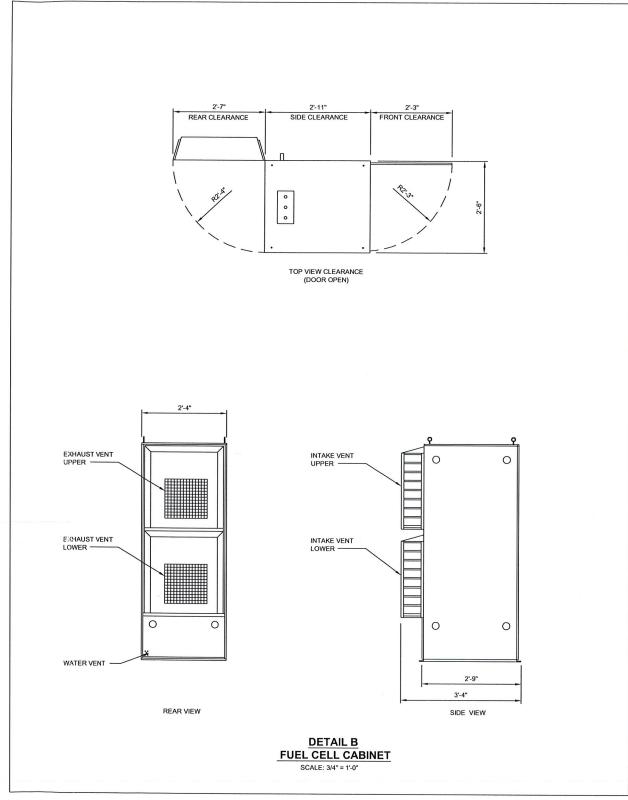
SHEET TITLE

SITE PLAN

SHEET NUMBER

C-2









10950 GRANDVIEW DRIVE OVERLAND PARK, KANSAS 66210 (913) 458-2000

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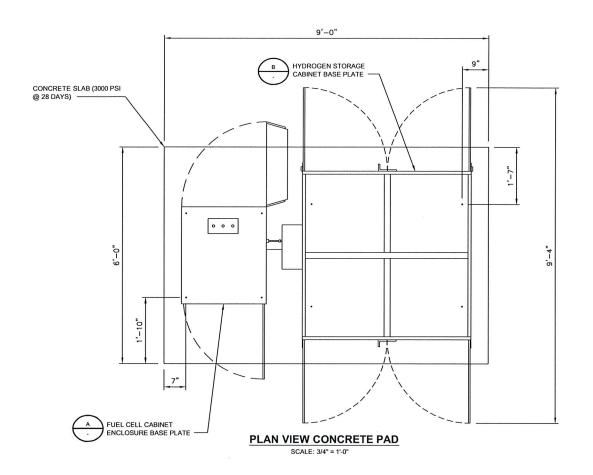
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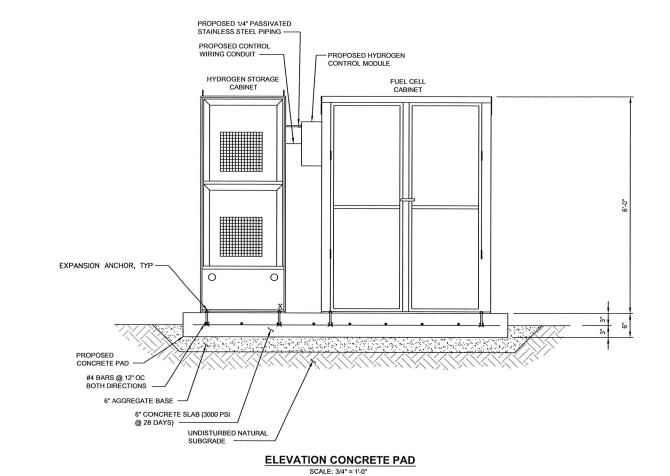
SHEET TITLE

EQUIPMENT CABINET DETAILS

SHEET NUMBER

S-1






CONDUIT ACCESS
OPENING IN ENCLOSURE

(4) 1/2"Ø HILTI KWIK BOLT 3
EXPANSION ANCHORS FOR
FUEL CELL CABINET. 3 1/4" MIN.
EMBEDMENT

DETAIL A
CABINET
BOLT PATTERN
SCALE: 1" = 1'-0"

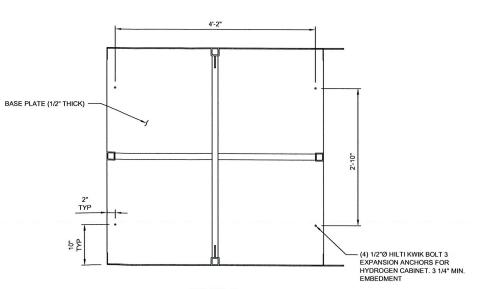

DETAIL B
HYDROGEN STORAGE CABINET
BOLT PATTERN

Sprint *****

6580 SPRINT PARKWAY OVERLAND PARK, KANSAS 66251



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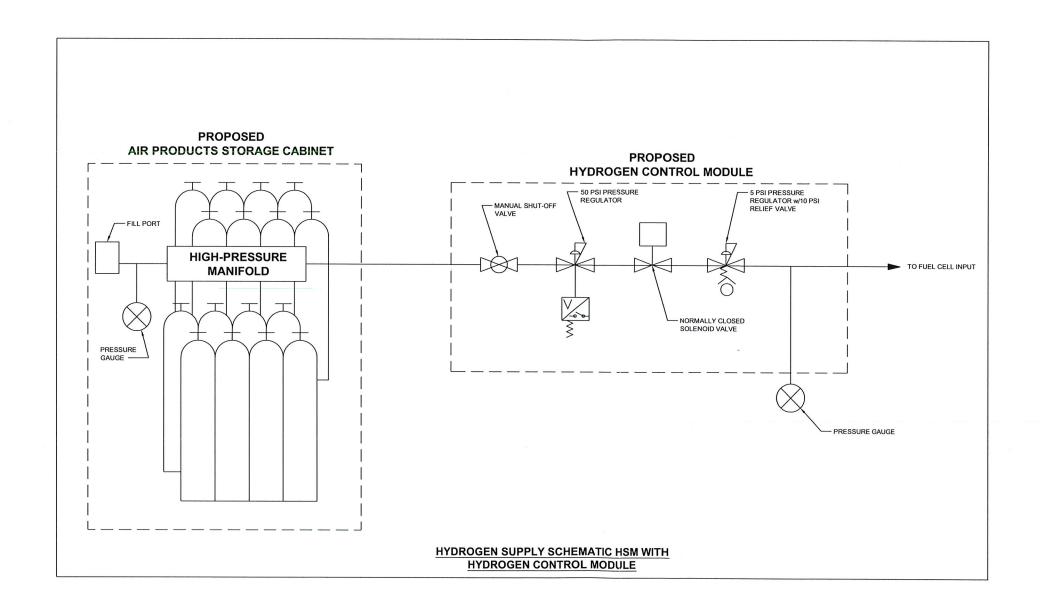
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SHEET TITLE

CONCRETE PAD DETAILS

SHEET NUMBER

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10950 GRANDVIEW DRIVE OVERLAND PARK, KANSAS 66210 (913) 458-2000

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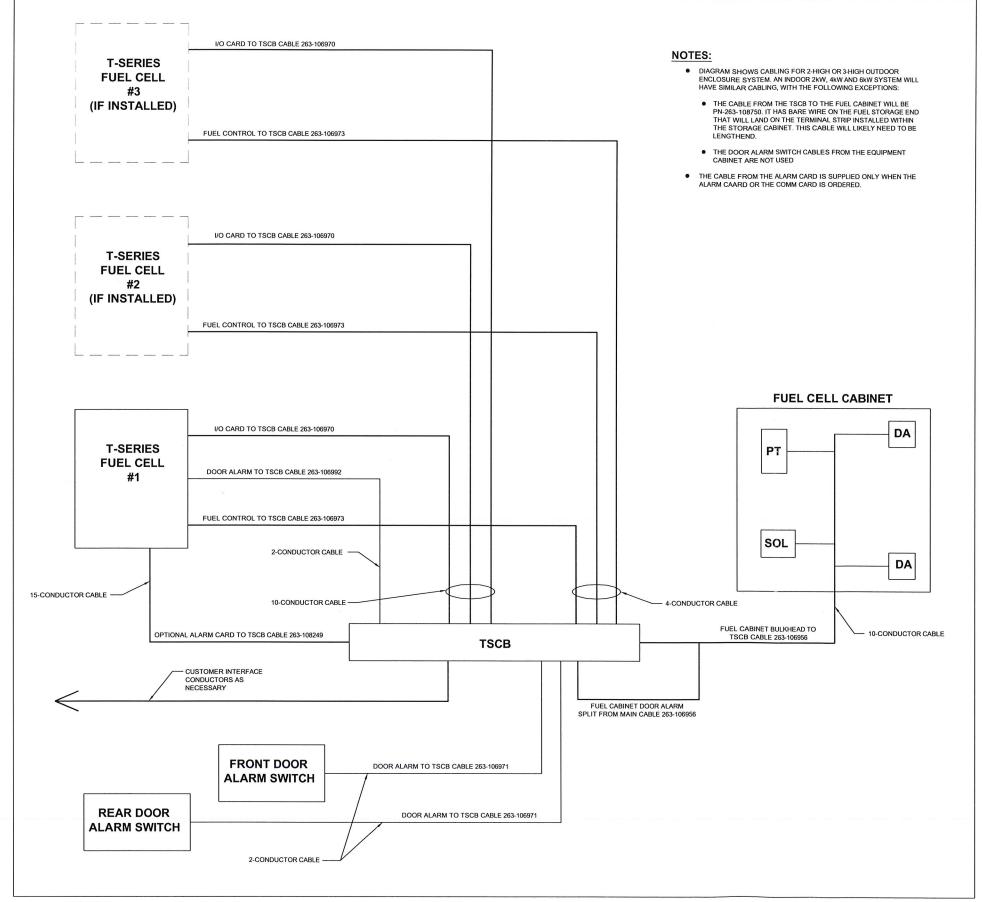
MADISON CONNECTICUT LIGHT & POWER
CT03XC023
135 NEW ROAD
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SHEET TITLE

HYDROGEN PIPING SCHEMATIC

SHEET NUMBER

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T-SERIES SIGNAL INTERCONNECT DIAGRAM

GENERAL ELECTRICAL NOTES:

- ALL ELECTRICAL WORK SHALL CONFORM TO THE LATEST EDITION OF THE NATIONAL ELECTRICAL CODE (NEC), AND LOCAL CODES.
- 2. ALL ELECTRICAL MATERIALS, EQUIPMENT AND INSTALLATION PROCEDURES SHALL CONFORM WITH SPRINT'S STANDARD CONSTRUCTION SPECIFICATIONS.
- 3. ALL MATERIALS SHALL BE MANUFACTURED IN ACCORDANCE WITH APPLICABLE STANDARDS ESTABLISHED BY ANSI, NEMA NFPA, AND "UL" LISTED.
- 4. THE ELECTRICAL PLANS, DETAILS, AND DIAGRAMS SHOWN ON THESE DRAWINGS ARE DIAGRAMMATIC ONLY. ACTUAL FIELD CONDITIONS AND SITE REQUIREMENTS SHALL DICTATE THE AMOUNT AND LOCATION OF EQUIPMENT.
- THE ENTIRE ELECTRICAL INSTALLATION SHALL BE GROUNDED AS REQUIRED BY THE NEC AND ALL APPLICABLE LOCAL CODES.
- ALL CIRCUIT BREAKERS, FUSES AND ELECTRICAL EQUIPMENT SHALL HAVE A MINIMUM INTERRUPTING RATING OF 65,000 AIC (UNLESS NOTED OTHERWISE).
- REFER TO THE VENDOR DRAWINGS OF THE PPC CABINET, BATTERY, AND BTS CABINETS FOR COMPLETE INTERNAL WIRING AND ARRANGEMENT.
- 8. PATCH, REPAIR AND PAINT ANY AREA THAT HAS BEEN DAMAGED IN THE COURSE OF THE ELECTRICAL INSTALLATION.
- 9. LABEL ALL ELECTRICAL EQUIPMENT PER SPRINT'S SPECIFICATIONS.
- 10. ALL SINGLE-PHASE SELF-CONTAINED METER CONNECTION DEVICES MUST INCLUDE HORN TYPE BYPASS PROVISIONS SO THAT SERVICE WILL NOT BE INTERRUPTED WHEN A METER IS REMOVED FROM THE SOCKET.
- 11. USE METER CONNECTION DEVICES LABELED BY THE MANUFACTURER WITH THE LETTERS ""CECHA"
- 12. ALL INTERIOR CONDUITS AND BUSHINGS SHALL BE EMT. ALL EXTERIOR SHALL BE PVC UNLESS NOTED OTHERWISE (SEE SPRINT'S STANDARD CONSTRUCTION SPECIFICATIONS).
- 13. PROVIDE 2 PULL STRINGS SECURELY FASTENED AT EACH END OF ALL CONDUITS. THE PULL STRINGS ARE TO BE 200 LB. TEST POLYETHYLENE CORD. PROVIDE CAP ON THE END OF EACH CONDUIT AND MARK AS SHOWN ON THIS SITE PLAN.
- 14. THE CONTRACTOR SHALL LOCATE AND MARK ALL EXISTING UNDERGROUND POWER, TELCO, GROUNDING CONDUITS, AND ALL OTHER UTILITIES EASEMENTS AND/OR WIRES PRIOR TO TRENCHING. ANY DAMAGE CAUSED TO THE EXISTING UNDERGROUND SERVICES OR SYSTEMS SHALL BE REPAIRED AT THE CONTRACTOR'S EXPENSE. VERIFY WITH UTILITY NEW SERVICE HAS BEEN APPLIED FOR. THERE SHALL BE NO SPLICING OF GROUND CONDUCTORS BELOW GRADE.
- UTILITY RACK AND CONDUIT SIZES TO BE FIELD DETERMINED BY CONTRACTOR IN ACCORDANCE WITH THE LOCAL JURISDICTION.
- 16. ALL WORK SHALL MEET OR EXCEED ALL APPLICABLE LOCAL AND NATIONAL ELECTRICAL CODE REQUIREMENTS.
- 17. ALL INSTALLATION AND EQUIPMENT SHALL MEET OR EXCEED SPRINT CONSTRUCTION SPECIFICATIONS.

ELECTRICAL NOTES:

- LIGHT SHADED LINES INDICATE EXISTING CONSTRUCTION.
- CONTRACTOR TO VERIFY POWERWAVE MODEL AND ASSOCIATED POWER REQUIREMENTS.
 IF LARGER CIRCUIT BREAKERS ARE REQUIRED, CONTRACTOR SHALL PROVIDE CORRECT ELECTRICAL CONDUCTOR SIZES.



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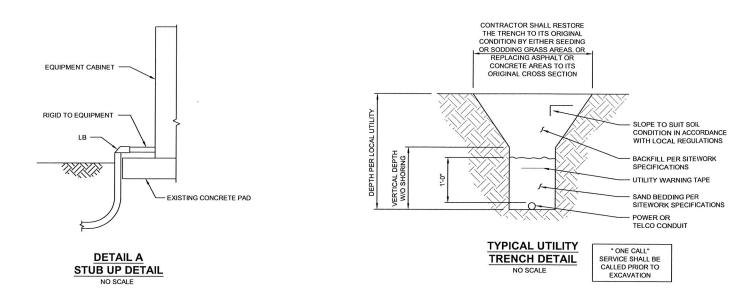
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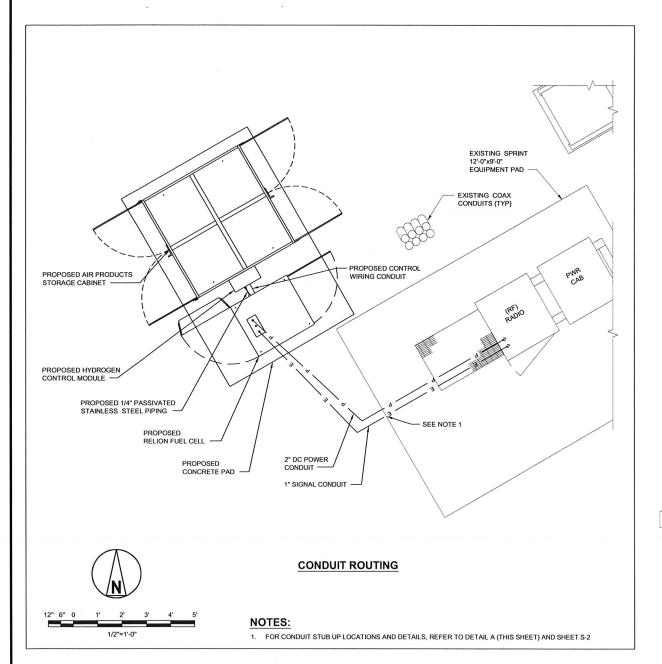
MADISON CONNECTICUT LIGHT & POWER
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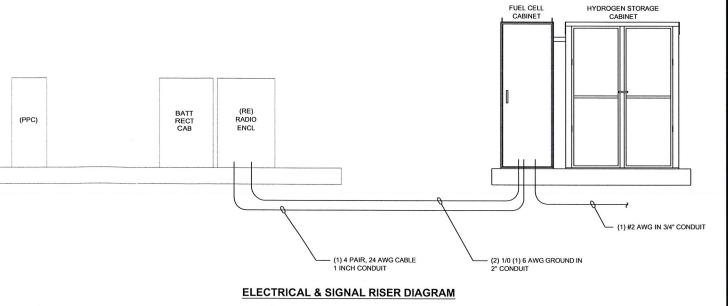
SHEET TITLE

ELECTRICAL ONE-LINE DIAGRAM

SHEET NUMBER







GENERAL NOTES:

- MATERIALS: ALL HANGERS, SUPPORTS, FASTENERS AND HARDWARE SHALL BE ZINC COATED OR OF EQUIVALENT CORROSION RESISTANCE BY TREATMENT OR INHERENT PROPERTY, AND SHALL BE MANUFACTURED PRODUCTS DESIGNED FOR THE APPLICATION. PRODUCTS FOR OUTDOOR USE SHALL BE HOT DIP GALVANIZED.
- CONDUIT SEALS: INSTALL CONDUIT SEAL FOR EACH CONDUIT PENETRATING AN EXTERIOR BUILDING WALL BELOW
 GRADE (UNLESS PENETRATION IS BELOW LOWEST BUILDING FLOOR SLAB), AND ELSEWHERE AS INDICATED, AND SO AS
 TO ACHIEVE A SEALED WATERTIGHT INSTALLATION. MATCH EXISTING CONDITIONS AND MEET OR EXCEED INTEGRITY OF
 WALLS.
- INSTALLATION: RIGIDLY SUPPORT AND SECURE ALL MATERIALS, RACEWAY AND EQUIPMENT TO BUILDING STRUCTURE USING HANGERS, SUPPORTS AND FASTENERS, SUITABLE FOR THE USE, MATERIALS AND LOADS ENCOUNTERED. PROVIDE ALL NECESSARY HARDWARE. PROVIDE CONDUIT SUPPORTS AT MAXIMUM 5 FT. O.C.
- STRUCTURAL MEMBERS: DO NOT CUT, DRILL OR WELD ANY STRUCTURAL MEMBER EXCEPT AS SPECIFICALLY APPROVED BY THE ENGINEER.
- INDEPENDENT SUPPORT: DO NOT SUPPORT MATERIALS OR EQUIPMENT FROM OTHER EQUIPMENT, PIPING, DUCTWORK OR SUPPORTS FOR SAME.
- MISCELLANEOUS SUPPORTS: PROVIDE ANY ADDITIONAL STRUCTURAL SUPPORT STEEL BRACKETS ANGLES, FASTENERS AND HARDWARE AS REQUIRED TO ADEQUATELY SUPPORT ALL ELECTRICAL MATERIALS AND EQUIPMENT.
- ONE HOLE STRAPS SHALL NOT BE USED FOR CONDUITS LARGER THAN 3/4"Ø.



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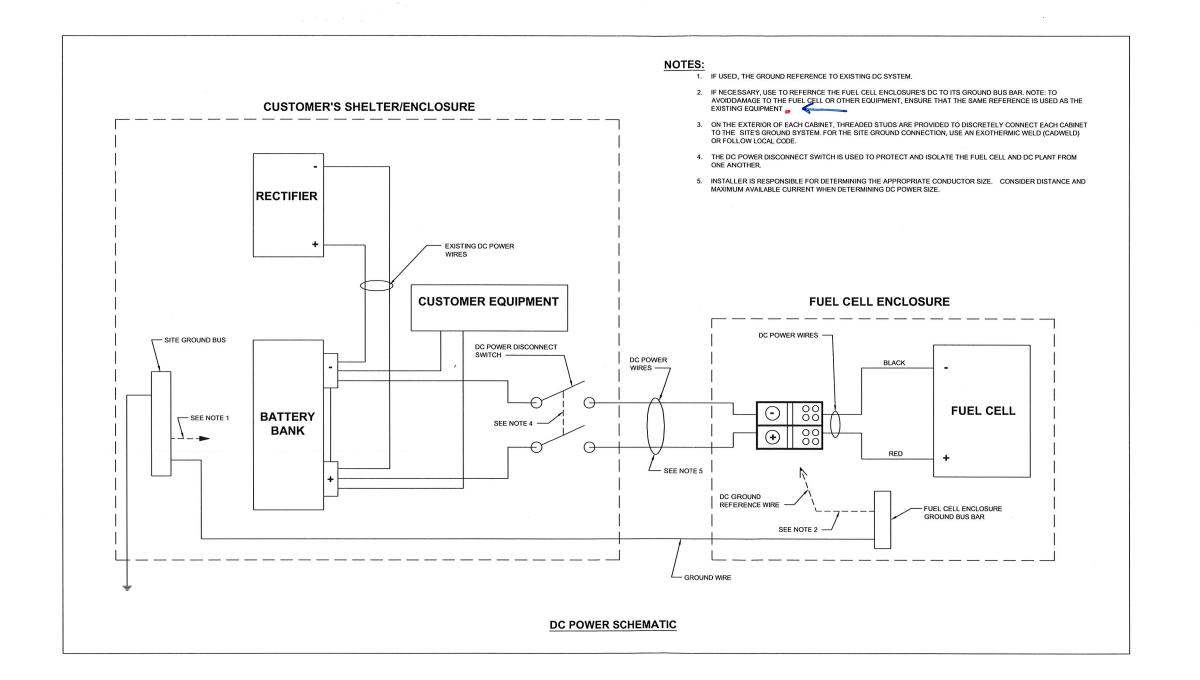
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SHEET TITLE

OVERALL CONDUIT DETAILS

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10950 GRANDVIEW DRIVE OVERLAND PARK, KANSAS 66210 (913) 458-2000

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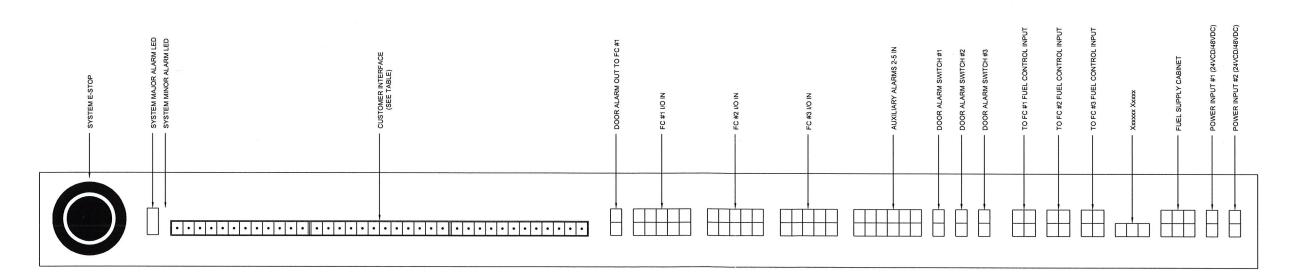
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SHEET TITLE

ELECTRICAL WIRING DIAGRAM

SHEET NUMBER

	CUSTOMER CONNECTIONS							
PIN	SIGNAL NAME	NOTES	PIN	SIGNAL NAME	NOTES	PIN	SIGNAL NAME	NOTES
1	DOOR SWITCH ALARM	THERE IS 1.1 k OHM SERIES RESISTANCE BETWEEN PINS 1 & 2	13	FC #1 AUX. ALARM RELAY (N.O.)	THERE IS 1.1 k OHM SERIES	25	AUX. 2 ALARM RELAY (N.O.)	AUXILIARY RELAYS 2 THROUGH 5
2	DOOR SWITCH ALARM RETURN	RESISTANCE DETWEEN FINS 1 & 2	14	FC #1 AUX. ALARM RELAY (COMMON.)	RESISTANCE BETWEEN PINS 1 & 2	26	AUX. 2 ALARM RELAY (COMMON.)	ARE AVAILABLE WITH THE ADDITION OF AN OPTIONAL ALARM CARD OR
3	NOT USED		15	FC #1 AUX. ALARM RELAY (N.C.)		27	AUX. 2 ALARM RELAY (N.C.)	COMM CARD INSTALLED ONTO ONE OF THE FUEL CELLS
4	NOT USED		16	FC #2 AUX. ALARM RELAY (N.O.)		28	AUX. 2 ALARM RELAY (N.O.)	
5	SYSTEM MAJOR ALARM (N.O.)		17	FC #2 AUX. ALARM RELAY (COMMON.)		29	AUX. 3 ALARM RELAY (COMMON.)	
6	SYSTEM MAJOR ALARM (COMMON.)		18	FC #2 AUX. ALARM RELAY (N.C.)		30	AUX. 3 ALARM RELAY (N.C.)	
7	SYSTEM MAJOR ALARM (N.C.)		19	FC #3 AUX. ALARM RELAY (N.O.)		31	AUX. 3 ALARM RELAY (N.O.)	
8	SYSTEM MINOR ALARM (N.O.)		20	FC #3 AUX. ALARM RELAY (COMMON.)		32	AUX. 4 ALARM RELAY (COMMON.)	
9	SYSTEM MINOR ALARM (COMMON.)		21	FC #3 AUX. ALARM RELAY (N.C.)		33	AUX. 4 ALARM RELAY (N.C.)	
10	SYSTEM MINOR ALARM (N.C.)		22	PRESSURE SW ALARM RELAY (N.O.)		34	AUX. 5 ALARM RELAY (N.O.)	
11	CONTACT START	THESE ARE WETTED CONTACTS; USE A CLOSED SWITCH TO ACTIVATE.	23	PRESSURE SW ALARM RELAY (COMMON.)		35	AUX. 5 ALARM RELAY (COMMON.)	
12	CONTACT START RETURN	A SESSED STATISTICS ACTIVATE.	24	PRESSURE SW ALARM RELAY (N.C.)		36	AUX. 5 ALARM RELAY (N.C.)	



T-SERIES SIGNAL AND CONTROL CONNECTIONS



6580 SPRINT PARKWAY OVERLAND PARK, KANSAS 66251



10950 GRANDVIEW DRIVE OVERLAND PARK, KANSAS 66210 (913) 458-2000

١	PROJECT NO:	168202
١	DRAWN BY:	SGS
- 1	CHECKED BY:	МВ

0	02/23/2011	ISSUED FOR CONSTRUCTION
REV	DATE	DESCRIPTION



IT IS A VIOLATION OF LAW FOR ANY PERSON, UNLESS THEY ARE ACTING UNDER THE DIRECTION OF A LICENSED PROFESSIONAL ENGINEER, TO ALTER THIS DOCUMENT.


MADISON CONNECTICUT LIGHT & POWER
CT03XC023
135 NEW ROAD
MADISON, CT 06443
CO-LOCATION


SHEET TITLE

FUEL CELL INSTALL DETAIL

SHEET NUMBER

THE DETAILS ON THIS SHEET APPLY ONLY AS CALLED OUT ON SITE PLANS OR SITE SPECIFIC DRAWINGS.

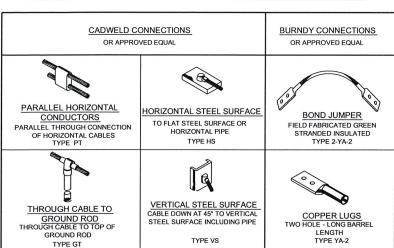

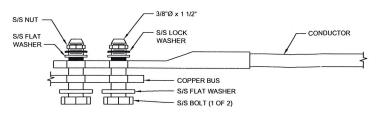

LUG DETAIL

NOTES:


- ALL HARDWARE 18-8 STAINLESS STEEL COAT ALL SURFACES WITH KOPR-SHIELD BEFORE MATING.
- FOR GROUND BOND TO STEEL ONLY: INSERT A DRAGON TOOTH WASHER BETWEEN LUG AND STEEL. COAT ALL SURFACES WITH ANTI-COLDATION COMPOUND (BURNDY PENETROX E, OR THOMAS & BETTS KOPR-SHIELD).

GROUNDING NOTES:

- THE SUBCONTRACTOR IS RESPONSIBLE FOR PROPERLY SEQUENCING INSTALLATION AS TO PREVENT ANY LOSS OF CONTINUITY IN THE GROUNDING SYSTEM OR DAMAGE TO THE CONDUIT.
- 2. ALL GROUND CONNECTIONS ABOVE GRADE (INTERIOR & EXTERIOR) SHALL BE FORMED USING HIGH PRESS CRIMPS.
- 3. ALL EXTERIOR GROUNDING CONNECTIONS SHALL BE COATED WITH A CORROSION RESISTANT MATERIAL.
- 4. ALL EXTERIOR GROUNDING CONDUCTORS SHALL BE 2 AWG SOLID TINNED COPPER UNLESS OTHERWISE INDICATED.
- 5. CONNECTIONS TO THE GROUNDING BUS SHALL NOT BE DOUBLED UP OR STACKED. BACK TO BACK CONNECTIONS ON OPPOSITE SIDES OF THE GROUND BUS ARE PERMITTED.
- USE OF 90° BENDS IN THE PROTECTION GROUNDING CONDUCTORS SHALL BE AVOIDED WHEN 45° BENDS CAN BE ADEQUATELY SUPPORTED.

HYDROGEN TANKS AND ENGINE STAND ALONE GROUNDING DETAIL (IF APPLICABLE)

 MAXIMUM RESISTANCE OF THE COMPLETED GROUND SYSTEM SHALL NOT EXCEED 5 OHMS. TESTING SHALL BE PERFORMED IN ACCORDANCE WITH PROJECT SPECIFICATIONS FOR FACILITY GROUNDING, USING FALL OF POTENTIAL METHOD

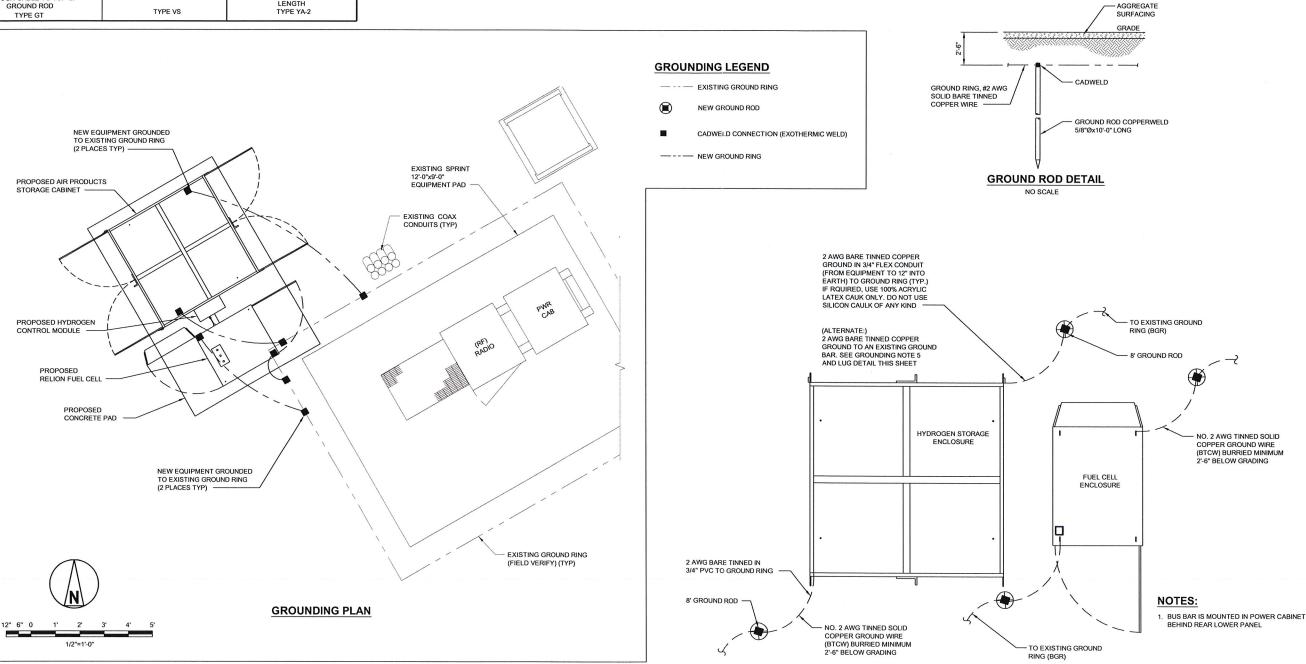



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SHEET TITLE

GROUNDING PLAN AND DETAILS

SHEET NUMBER

G-1