



# **BACKUP POWER PROJECT**

## SITE IDENTIFICATION:


SITE NUMBER: 10113274

SITE NAME: HADDAM

CHAMBERLAIN HILL ROAD

SITE ADRESS: 285 CHAMBERLAIN HILL ROAD

HADDAM, CT 06438

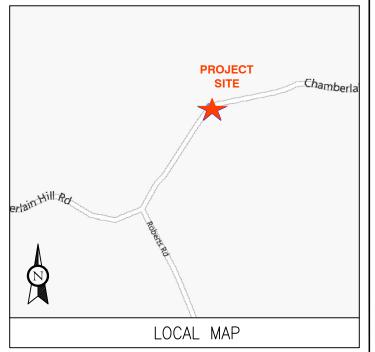

CONTRACTOR TO VERIFY EXISTING MUX LOCATION. IF MUX LOCATION IS OUTSIDE OF AT&T EQUIPMENT AREA, CONTRACTOR IS TO FIELD VERIFY THE PRESENCE OF EMERGENCY BACK-UP SERVICE TO THE MUX. IF EMERGENCY BACK-UP SERVICE IS NOT PRESENT, CONTRACTOR IS TO ROUTE NEW SERVICE FROM AT&T EQUIPMENT AREA.

# Know what's below. Call before you dig.

THIS FACILITY SHALL MEET OR EXCEED ALL FAA AND FCC REGULATORY REQUIREMENTS.

### PROJECT DESCRIPTION:

THE PROPOSED PROJECT INCLUDES PLACING A 50 KW GENERATOR IN AN EXISTING CELLULAR TOWER COMPOUND.

		STING CELLULAR TOWER COMPOUND	•				
PROJECT TEAM	PROJECT TEAM PROJECT SUMMARY PROJECT NOTES SHEET INDEX						
ENGINEER ADVANCED ENGINEERING GROUP, P.C.	GEOGRAPHIC COORDINATES:  LATITUDE: 41.495883	1. THE FACILITY IS UNMANNED.	SHT NO:	DESCRIPTION:	REV:	DATE:	BY:
500 NORTH BROADWAY EAST PROVIDENCE, RI 02914 TEL: 401-354-2403	LONGITUDE: -72.618324	A TECHNICIAN WILL VISIT THE SITE APPROXIMATELY ONCE     A MONTH FOR ROUTINE INSPECTION AND MAINTENANCE.	T-1	TITLE SHEET, VICINITY MAP AND GENERAL INFORMATION	1	11-26-2013	CJG
CUSTOMER REPRESENTATIVE	CODE BLOCK:	THE PROJECT WILL NOT RESULT IN ANY SIGNIFICANT LAND DISTURBANCE OR EFFECT OF STORM WATER	A-1	COMPOUND PLAN	1	11-26-2013	CJG
SABRE INDUSTRIES	BUILDING CODE: 2009 INTERNATIONAL BUILDING CODE	DRAINAGE.	A-2	CONCRETE PAD DETAILS	1	11-19-2013	CJG
PEGGY POOR MARKET LEAD — AT&T NE GENERATOR	AT&T OPS FOR POWER CUT OVER:	NO SANITARY SEWER, POTABLE WATER OR TRASH DISPOSAL AS REQUIRED.	E-1	WIRING DIAGRAM & ATS MOUNTING DETAIL	1	11-26-2013	CJG
PROGRAM 13010 MORRIS ROAD, 6TH FLOOR, BLDG 1	NEED 24 HOUR NOTICE	5. HANDICAP ACCESS IS NOT REQUIRED.	E-2	ELECTRICAL DETAILS	1	11-26-2013	CJG
ALPHARETTA, GA 30004 CELL 770—990—0137	DIAL: 1-800-638-2822		G-1	GROUNDING DETAILS	1	11-26-2013	CJG
LANDLORD	SELECT OPTION 1, THEN, OPTION 2	PROJECT LOCATION DIRECTIONS					
LANDLORD SBA PROPERTIES 5900 BROKEN SOUND PKWY, 2ND FLOOR BOCA RATON, FL 33487  UTILITIES: POWER COMPANY: NORTHEAST UTILITIES (NU) P.O. BOX 270 HARTFORD, CT 06141—0270 PHONE: 1—800—286—5000	NEED 24 HOUR NOTICE TO OPEN A TAP TICKET DIAL: 1-800-638-2822 SELECTRICAL DETAILS  5. HANDICAP ACCESS IS NOT REQUIRED.  E-2 ELECTRICAL DETAILS  G-1 GROUNDING DETAILS						



Surveying - Telecommunications 500 NORTH BROADWAY EAST PROVIDENCE, RI 02914 PH: 401–354–2403 FAX: 401–633–6354



TOWER RESOURCE MANAGEMENT 16 CHESTNUT STREET, SUITE 220 FOXBORO, MA 02035 WWW.TRMCOM.COM



550 COCHITUATE ROAD, SUITE 13 & 14 FRAMINGHAM, MA 01701-4681



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HADDAM CHAMBERLAIN HILL
ROAD

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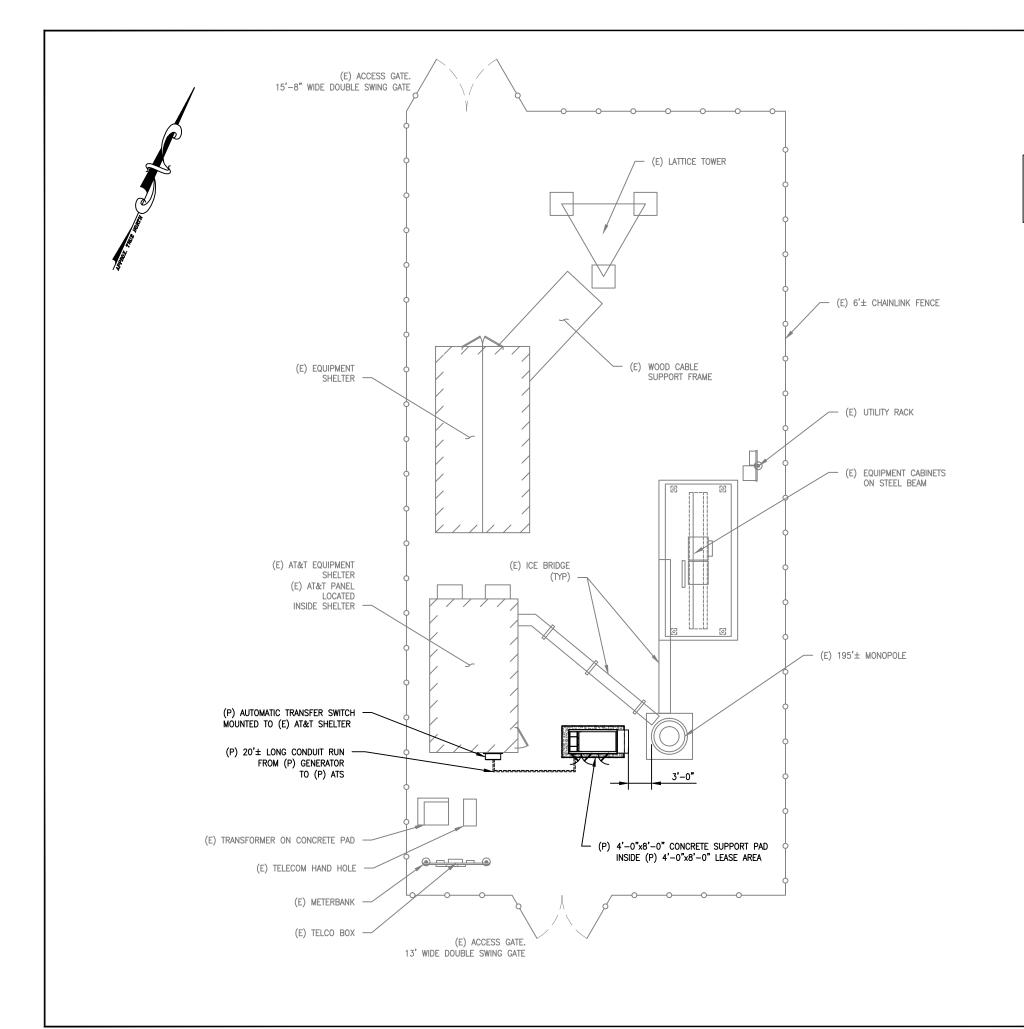
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JOB NO:	10113274

SHEET TITLE:

TITLE SHEET, VICINITY MAP AND GENERAL INFORMATION

SHEET NUMBER:	REV. #
T-1	1



NOTE:

A SITE VISIT/SURVEY WAS NOT CONDUCTED BY ADVANCED ENGINEERING GROUP, P.C. SITE INFORMATION AND PLANS ARE BASED UPON INFORMATION PROVIDED BY CLIENT

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COMPOUND PLAN

15'

30'

SCALE: 1" = 15'

7.5'



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13010 MORRIS ROAD, 6TH FLOOR, BLDG 1 ALPHARETTA, GA 30004

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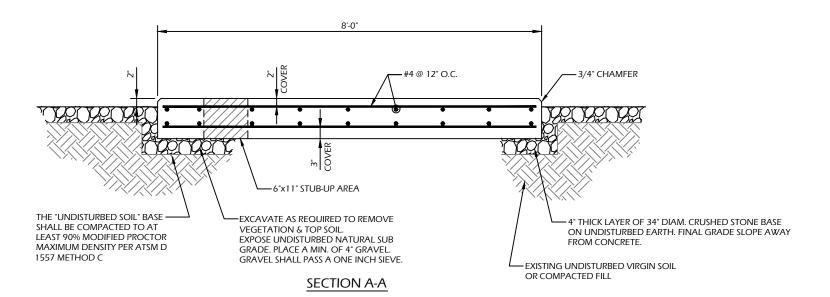
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**COMPOUND PLAN** 

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8'-0"

- AC LOAD LEAD CONDUIT

CONNECTION POINTS FOR CONTROL WIRES

PLAN VIEW

- OVERHANG

ANCHOR BOLT


(TYP) (4) PER SIDE

OUTLINE OF GENERATOR

11 1/2"

9 1/2"

11"

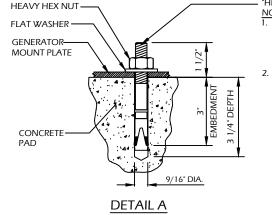

"HILTI" KWIK BOLT 3 EXPANSION ANCHOR

- BOLTS CAN BE INSTALLED 2 DAYS AFTER POURING CONCRETE PROVIDED THE KWIK BOLTS ARE ONLY TIGHTENED TO A SNUG TIGHT CONDITION.
- APPLY "HILTI" HIT-RE 500-SD EPOXY TO ALL GAPS TO PREVENT WATER/MOISTURE



ENGINEERING GROUP, P. Civil Engineering - Site Development

Surveying - Telecommunications

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#### CONCRETE PAD CONSTRUCTION NOTES

- 1. ALL REBAR (HORIZONTAL & VERTICAL) SHALL BE SECURELY WIRE TIED TO PREVENT DISPLACEMENT DURING POURING
- 2. CONCRETE TO HAVE A MINIMUM COMPRESSIVE STRENGTH OF 4000 PSI.
- 3. REINFORCED CONCRETE CONSTRUCTION AND MATERIALS SHALL BE IN ACCORDANCE WITH ACI STANDARDS 318.
- 4. MINIMUM CONCRETE COVER OVER REBAR IS 2 1/2".
- 5. REINFORCING MATERIAL SHALL BE IN ACCORDANCE WITH ASTM SPECIFICATION A615-85.

#### CONCRETE PAD AND EMBEDMENT TOLERANCES

- 1. CONCRETE DIMENSIONS: PLUS OR MINUS 1/4".
- 2. REINFORCING STEEL PLACEMENT: PLUS OR MINUS 1/4" INCLUDING CONCRETE COVER.

#### **NOTES**

- 1. FOUNDATION WAS DESIGNED BY ASSUMING ALLOWABLE SOIL BEARING CAPACITY OF 1000 PSI. THE SOIL BEARING CAPACITY FOR EACH SITE MUST BE VERIFIED USING THE SITE SPECIFIC GEOTECH REPORT. IF SHALLOW GROUNDWATER (≤3 FT.) WAS REPORTED, A FURTHER REVIEW OF THE DESIGN OR SPECIAL DESIGN MAY BE REQUIRED.
- 2. THE SOIL UNDERNEATH THE CONCRETE PAD MUST BE FREE OF ORGANIC MATTER OR OTHER DELETERIOUS SUBSTANCES, AND SHOULD BE COMPACTED AND LEVELED BEFORE PLACING THE FOUNDATION.
- 3. CONCRETE SLUMPS: 1"~3".
- 4. CONCRETE VOLUME: 2.4 CUBIC YARDS.

#### DESIGN

1. MAXIMUM DESIGN BASIC WIND SPEED (3-SECOND GUST): 155 MPH FOR GENERATOR MODELS SD050 AND SD080.


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**CONCRETE PAD DETAILS** 

SHEET NUMBER: REV. #



NOTES:

- ALL UNDERGROUND CABLE TO BE BURIED AT 36" MIN. SHIELD TAPED AT 12" AND STUBBED OUT OF GROUND IN SCH 40 PVC CONDUIT.
- LOW VOLTAGE CONTROL WIRE PROVIDED BY MONITORING PROVIDER IN SEPARATE 1/2" CONDUIT FROM ATS TO GENERATOR.
- 3. BTS SITES: THE TENANT CONTRACTOR TO COMPLETE CUSTOMER ELECTRICAL CONDUIT TO CUSTOMER METER PER STANDARD COLLOCATION INSTALL.
- F. TENANT CONTRACTOR HAS NOTHING TO INSTALL OR COMPLETE FOR ATC SHARED GEN DURING CUSTOMER COLLOCATION ON ATC TOWER.
- 5. ATC SHARED GEN INSTALL IS COMPLETED AFTER CUSTOMER TOWER COLLOCATION IS COMPLETE WITH LOAD ON CUSTOMER METER.
- ALL CONDUCTORS ARE SIZED FOR COPPER, BUT ALUMINUM CONDUCTORS ARE ALLOWED FOR FEEDERS PROVIDED THEY ARE UPSIZED PER NEC TABLE 310.16.
- 7. ALL ELECTRICAL WORK SHALL BE PER THE NATIONAL ELECTRICAL CODE (NFPA 70) AND ALL APPLICABLE LOCAL CODES.
- MAINTAIN 36" CLEAR WORKSPACE IN FRONT OF METER, TRANSFER SWITCH, GENERATOR, PANELS, ETC.
- 9. 800A PANEL HAS A COMMON NEUTRAL BUS. NEUTRALS BACK TO EACH CARRIER METER ARE SIZED ACCORDING TO THE DISTRIBUTION PANEL BRANCH BREAKER RATING. NEUTRAL IS BONDED AT THE PRIMARY SERVICE MAIN BONDING JUMPER ONLY.
- GENERATOR CONTROLS AND SENSORS SHALL HAVE GFCI SENSING CAPABILITY PER NEC 700-6(D).

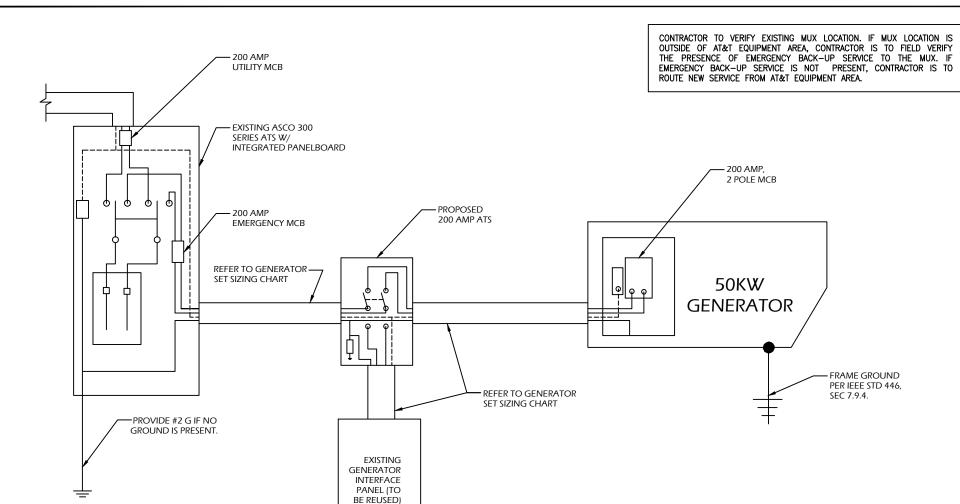SINGLE CARRIER WIRING DIAGRAM
SCALE: NOT TO SCALE

FEEDER SIZING CHART FOR GENERATOR					
GEN SET SIZE	VOLTS - PHASE	PRIME RATING KW - AMPS	SIZE OF INLINE BREAKER (AT GENERATOR)	MAIN BREAKER SIZE SERVING ANCHOR TENANT:	FEEDER SIZES FROM GEN SET BREAKER TO DISTRIBUTION PANEL / ATS.
50KW	120/240V - 1-PH	48KW - 200A	200A	200A 2-P C/B INTEGRAL TO GEN SET	3#3/0, 1#6G, IN 2°C

#### NOTES:

- 1. SERVICE VOLTAGE FOR EACH CARRIER IS 120/240 1-PHASE, AND SERVICE SIZES ARE TYPICAL 200A PER CARRIER.
- 2. DISTRIBUTION PANEL IS 800A, 120/240V 1-PHASE, WITH 200A C/B FOR THE LISTED CARRIER OUTPUT. PANEL HAS (3) 200A BREAKER SPACES FOR FUTURE CARRIERS.
- 3. AUTOMATIC TRANSFER SWITCH (ATS) ARE 200A 2-POLES, 120/240V 1-PHASE WITH SOLID NEUTRAL PER CARRIER.
- 4. ALL ELECTRICAL EQUIPMENT IS NEMA 3R RATED.
- 5. THE GENERATOR ELECTRICAL LOADS ARE ADEQUATE FOR THE CONNECTED LOADS.
- 6. ALL EQUIPMENT FURNISHED SHALL BE PROVIDED WITH EQUIPMENT RATED TO WITHSTAND FAULT CURRENT AVAILABLE AT PROJECT SITE.
  7. ALL WIRE AND PANEL BUSSING SHALL BE COPPER UNLESS ALLOWED ELSEWHERE IN THIS DOCUMENT SET, WIRE SIZES ARE BASED ON COPPER.
- 8. A NEW SET OF PLANS WILL BE PROVIDED AND SUBMITTED FOR ADDITIONAL CARRIERS.
- 9. ALL WORK SHALL CONFORM WITH THE CURRENT VERSION OF THE NEC AND ALL OTHER APPLICABLE CODES.
- 10. FIRST OVER-CURRENT PROTECTION DEVICE IS INTEGRAL TO GENERATOR. FEEDER SIZES INDICATED IN TABLE ABOVE ARE DOWNSTREAM OF THE FIRST OVER-CURRENT PROTECTION DEVICE.
- 11. INLINE BREAKER AT GENERATOR IS FACTORY INSTALLED, AND IS THE MANUFACTURER'S RECOMMENDED SIZE.

GENERATOR SET SIZING CHARTS



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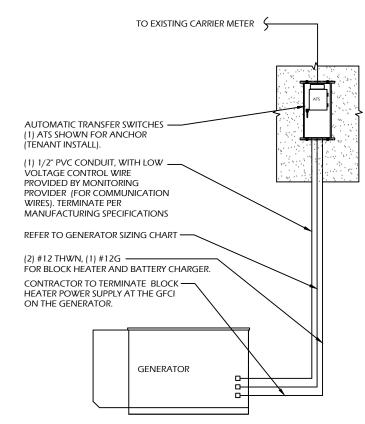
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WIRING DIAGRAM & H-FRAME LAYOUT

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NOTE: UTILITY POWER FEEDS SHALL BE CONNECTED TO THE TRANSFER SWITCH FROM THE LOAD SIDE OF THE EXISTING SERVICE DISCONNECT. NO MODIFICATIONS SHALL BE MADE



(1) 2" SCH 40 CONDUIT FROM-

CARRIER ATS TO GENERATOR

DISCONNECT POWER FEED FROM EXISTING METER TO EXISTING SHELTER. ROUTE NEW FEEDERS (SIZED BELOW) FROM METER TO NEW TRANSFER SWITCH AND BACK. RECONNECT NEW RETURN FEED FROM TRANSFER SWITCH TO SUPPLY POWER (UTILITY AND BACK-UP POWER) TO EXISTING SHELTER.



EXISTING SHELTER -UNISTRUT P/N 1000 OR APPROVED EQUAL, TYP. AUTOMATIC TRANSFER SWITCH -(1) 2" SCH 40 CONDUIT TO TOP VIEW CUSTOMER PANEL (1) 2" SCH 40 CONDUIT FROM -CARRIER METER TO ATS UNISTRUT P/N 1000 OR

> ATS MOUNTING DETAIL SCALE: NOT TO SCALE

SIDE VIEW

FRONT VIEW



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APPROVED EQUAL, TYP.

GRADE

- 3/8" LAG BOLT, TYP.

-EXISTING SHELTER

3/4" SCH 40 PVC FROM ATS

-(3) #10 (1) #10 IN

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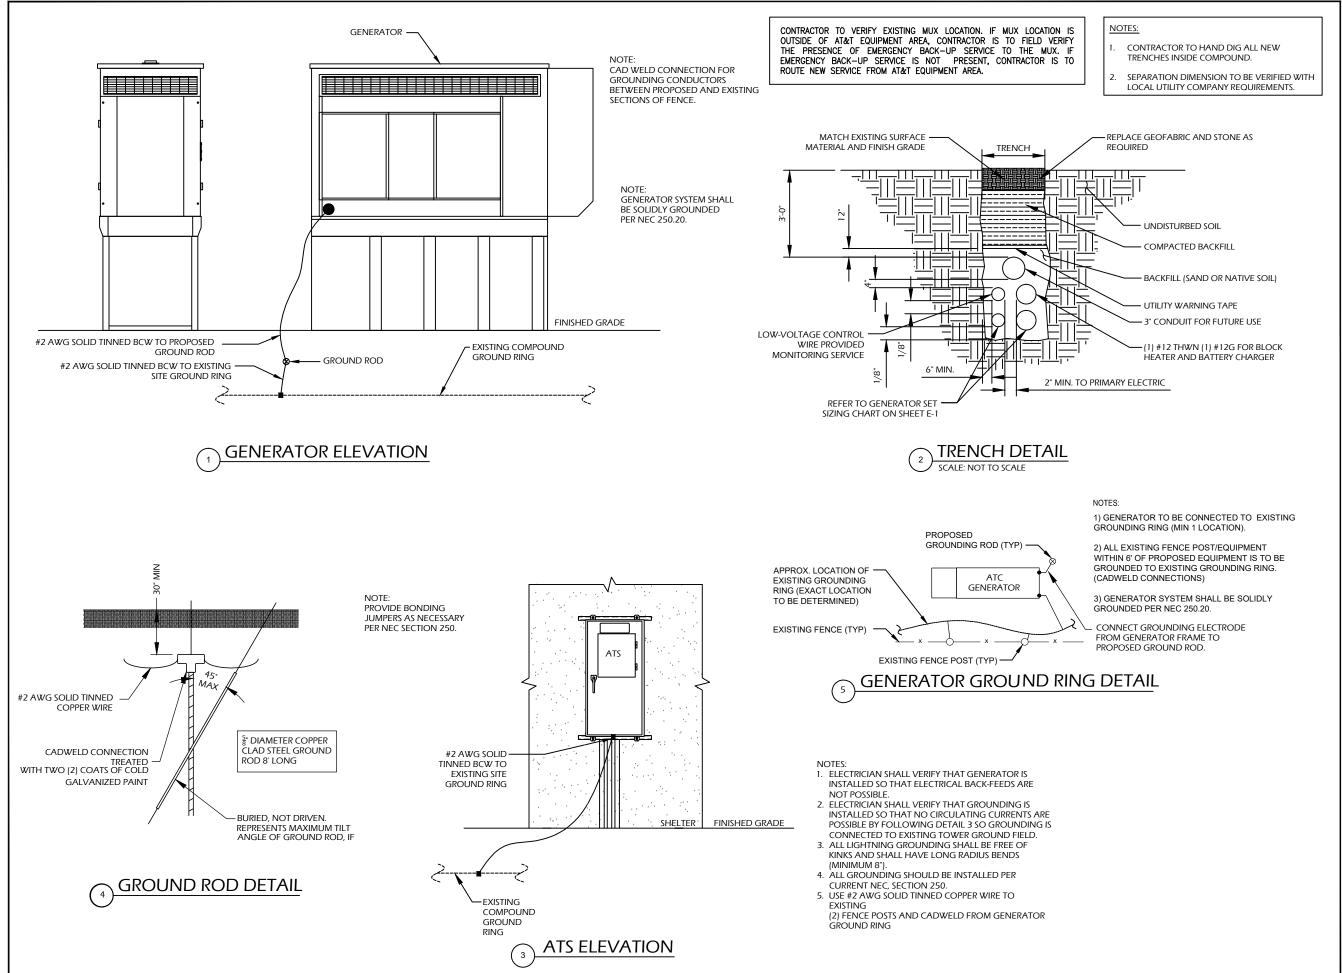
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**ELECTRICAL/MOUNTING DETAILS** 

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**GROUNDING DETAILS** 

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