From: Jason Blinkhorn < jblinkhorn@qualtekwireless.com>

Sent: Thursday, July 8, 2021 11:48 AM

**To:** CSC-DL Siting Council <Siting.Council@ct.gov>; hoeym@ci.guilford.ct.us **Cc:** Corey Michaud <cmichaud@qualtekwireless.com>; Michael Cypranowski

<mcypranowski@qualtekwireless.com>; Adam Trapani <atrapani@qualtekwireless.com>; Karin

Turner <a href="mailto:kturner@qualtekwireless.com">kturner@qualtekwireless.com</a>; Siyuan Liu <sliu@qualtekwireless.com</a>; ATT

Closeouts <attcloseouts@empiretelecomm.com>; New England Compliance

<newenglandcompliance@empiretelecomm.com>

Subject: CSC SITE EM-AT&T-060-210407 / ATT SITE CT2030

CSC team,

We would like to start this project 7-18-2021. Please see attached.

COP team,

Please note this will require additional COP documents for the CSC.

Thank You,

Jason Blinkhorn / Project Manager / 401-787-6007 / jblinkhorn@qualtekwireless.com
16 Esquire Rd, N Billerica MA 01862
125 Depot St, Bellingham, MA 02019



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CTV2030 AT&T SITE NAME: **AT&T FA CODE:** 10035042

MRCTB048592, MRCTB048471, MRCTB048634, MRCTB048476, MRCTB048475 SITE TYPE: AT&T PACE NUMBER:

SHEET#

T-2

C-1.1

C-3

C-4

LTE 3C, LTE 4C, 4TX4RX AT&T PROJECT:

**BUSINESS UNIT #: SITE ADDRESS:** 

GUILFORD, CT 06437 COUNTY: **NEW HAVEN MONOPOLE** 

806361

131 MANOR ROAD

**SITE PHOTO** 

150'-0" **TOWER HEIGHT:** 

### ATLANTA, GA 30319





AT&T SITE NUMBER: 61163

BU #: **806361** NHV 102 943127

131 MANOR ROAD GUILFORD, CT 06437

EXISTING 150'-0" MONOPOLE

-				-
		ISSUI	ED FOR:	
REV	DATE	DRWN	DESCRIPTION	DES./QA
0	03/10/2021	AM	CONSTRUCTION	AS
1	04/02/2021	AM	JURISDICTION	AS



IT IS A VIOLATION OF LAW FOR ANY PERSON, INLESS THEY ARE ACTING UNDER THE DIRECTION OF A LICENSED PROFESSIONAL ENGINEER,

SHEET NUMBER:

REVISION:

### SITE INFORMATION

131 MANOR ROAD

GUILFORD, CT 06437

CROWN CASTLE USA INC. NHV 102 943127

SITE ADDRESS:

SITE NAME:

NEW HAVEN COUNTY: MAP/PARCEL#: 090017 AREA OF CONSTRUCTION: EXISTING LATITUDE: 41° 19' 48.09'

-72° 43' 18.51" LONGITUDE NAD83 LAT/LONG TYPE: GROUND ELEVATION:

CURRENT ZONING: R-5 **JURISDICTION:** TOWN OF GUILFORD

OCCUPANCY CLASSIFICATION: U-UNMANNED

TYPE OF CONSTRUCTION:

TELCO PROVIDER:

A&E FIRM:

CROWN CASTLE

CONTACTS:

USA INC. DISTRICT

FACILITY IS UNMANNED AND NOT FOR A.D.A. COMPLIANCE: HUMAN HABITATION

PROPERTY OWNER: BISHOP B W & SONS INC.

1355 BOSTON POST RD GUILFORD, CT 06437

TOWER OWNER: CROWN CASTLE  $2000\ CORPORATE\ DRIVE$ 

CANONSBURG, PA 15317

CARRIER/APPLICANT: AT&T TOWER ASSET GROUP

575 MOROSGO DRIVE ATLANTA, GA 30324-3300

**PROJECT TEAM** 

3227 WELLINGTON COURT RALEIGH, NC 27615

FRANKLIN, TN 37067

PRIOR TO ACCESSING/ENTERING THE SITE YOU MUST CONTACT THE CROWN NOC AT (800) 788-7011 & CROWN CONSTRUCTION MANAGER.

ENGINEERED TOWER SOLUTIONS, PLLC

370 MALLORY STATION ROAD, SUITE 505

VERONICA DELIA - PROJECT MANAGER

JASON D'AMICO - CONSTRUCTION MANAGER

CROWNAESERVICES@ETS-PLLC.COM

ELECTRIC PROVIDER: CONNECTICUT LIGHT & POWER CO

03 397 276 LIGHTOWER



BE RESPONSIBLE FOR SAME

**DRAWING INDEX** 

EXISTING & FINAL EQUIPMENT PLANS

FINAL ELEVATION & ANTENNA PLANS

FINAL EQUIPMENT SCHEDULE

EQUIPMENT MOUNTING DETAILS I

EQUIPMENT MOUNTING DETAILS II

TITLE SHEET

SITE PLAN

TTACHED PLUMBING DIAGRAM

GENERAL NOTES

EQUIPMENT SPECS

GROUNDING SCHEMATIC

GROUNDING DETAILS

ATTACHED MOUNT MODIFICATION DRAWINGS

SHEET DESCRIPTION

# **LOCATION MAP**

ALL DRAWINGS CONTAINED HEREIN ARE FORMATTED FOR T&T. CONTRACTOR SHALL VERIFY ALL PLANS AND EXISTING DIMENSIONS AND CONDITIONS ON THE JOB SITE AND SHALL IMMEDIATELY NOTIFY THE ENGINEER IN WRITING OF ANY DISCREPANCIES BEFORE PROCEEDING WITH THE WORK OR

NO SCALE

THE EXISTING ELIGIBLE WIRELESS FACILITY.

- REMOVE (3) ERICSSON RRUS 11 B12
- INSTALL (3) OPA65R-BU6DA ANTENNAS

- INSTALL (3) ERICSSON 4478 B14 RRUs
- INSTALL (2) DC TRUNKS (7/8")
- INSTALL (2) FLEX CONDUIT

### GROUND SCOPE OF WORK:

- REMOVE (1) INDOOR POWER PLANT
- REMOVE BATTERY STRINGS
- REMOVE (2) RACK MOUNTED CONVERTER SHELVES
- REMOVE (6) DIPLEXERS
- INSTALL (1) RAYCAP DC12-48-60-0-25E
- INSTALL (1) 7100 VERTIV INDOOR POWER PLANT
- INSTALL (15) UP-CONVERTERS

THE PURPOSE OF THIS PROJECT IS TO ENHANCE BROADBAND CONNECTIVITY AND CAPACITY TO

### TOWER SCOPE OF WORK:

- REMOVE (3) POWERWAVE 7770 ANTENNAS
- REMOVE (3) ERICSSON RRUS 12 B2 + RRUS A2 B25
- REMOVE (6) DIPLEXERS
- INSTALL (3) DMP65R-BU6DA ANTENNAS
- INSTALL (3) ERICSSON 4449 B5/B12 RRUs
- INSTALL (3) ERICSSON 8843 B2/B66A RRUs
- INSTALL (1) RAYCAP DC6-48-60-18-8F SQUID
- INSTALL (1) FIBER TRUNK (3/8")

### • INSTALL (12) BATTERIES • INSTALL (1) IDLE CABLE

- INSTALL (1) 6630

- INSTALL (6) VERTIV RECTIFIERS • INSTALL (4) VERTIV 48V CONVERTERS

### PROJECT DESCRIPTION

CODES AS ADOPTED BY THE LOCAL GOVERNING AUTHORITIES. NOTHING IN THESE PLANS IS TO BE CONSTRUED TO PERMIT WORK NOT CONFORMING TO THESE CODES:

> MECHANICAL 2015 IMC ELECTRICAL 2017 NEC

### REFERENCE DOCUMENTS:

ORDER ID: 527516

ALL WORK SHALL BE PERFORMED AND MATERIALS INSTALLED IN ACCORDANCE WITH THE CURRENT EDITIONS OF THE FOLLOWING

APPLICABLE CODES/REFERENCE DOCUMENTS

CODE TYPE

STRUCTURAL ANALYSIS: CROWN CASTLE DATED: 02/08/2021

MOUNT ANALYSIS: POD DATED: 10/13/2020 RFDS REVISION: 1 DATED: 08/14/2020

### CROWN CASTLE USA INC. SITE ACTIVITY REQUIREMENTS:

- NOTICE TO PROCEED- NO WORK SHALL COMMENCE PRIOR TO CROWN CASTLE USA INC. WRITTEN NOTICE TO PROCEED (NTP) AND THE ISSUANCE OF A PURCHASE ORDER. PRIOR TO ACCESSING/ENTERING THE SITE YOU MUST CONTACT THE CROWN CASTLE USA INC. NOC AT 800-788-7011 & THE CROWN CASTLE USA INC. CONSTRUCTION MANAGER.
- "LOOK LIP" CROWN CASTLE LISA INC. SAFETY CLIMB REQUIREMENTS
- THE INTEGRITY OF THE SAFETY CLIMB AND ALL COMPONENTS OF THE CLIMBING FACILITY SHALL BE CONSIDERED DURING ALL STAGES OF DESIGN, INSTALLATION, AND INSPECTION. TOWER MODIFICATION, MOUNT REINFORCEMENTS, AND/OR FOLIPMENT INSTALLATIONS SHALL NOT COMPROMISE THE INTEGRITY OR FEINTORGEMENTS, AND/OW EQUIPMENT INSTALLATIONS SHALL NOT COMPROMISE THE INTEGRAT OF FUNCTIONAL USE OF THE SAFETY CLIMB OR ANY COMPONENTS OF THE CLIMBING FACILITY ON THE STRUCTURE. THIS SHALL INCLUDE, BUT NOT BE LIMITED TO: PINCHING OF THE WIRE ROPE, BENDING OF THE WIRE ROPE FROM ITS SUPPORTS, DIRECT CONTACT OR CLOSE PROXIMITY TO THE WIRE ROPE WHICH MAY CAUSE FRICTIONAL WEAR, IMPACT TO THE ANCHORAGE POINTS IN ANY WAY, OR TO IMPEDE/BLOCK ITS INTENDED USE. ANY COMPROMISED SAFETY CLIMB, INCLUDING EXISTING CONDITIONS MUST BE TAGGED OUT AND REPORTED TO YOUR CROWN CASTLE USA INC. POC OR CALL THE NOC TO GENERATE A SAFETY CLIM MAINTENANCE AND CONTRACTOR NOTICE TICKET.
- PRIOR TO THE START OF CONSTRUCTION, ALL REQUIRED JURISDICTIONAL PERMITS SHALL BE OBTAINED. THIS INCLUDES, BUT IS NOT LIMITED TO, BUILDING, ELECTRICAL, MECHANICAL, FIRE, FLOOD ZONE, ENVIRONMENTAL, AND ZONING, AFTER ONSITE ACTIVITIES AND CONSTRUCTION ARE COMPILETED, ALL REQUIRED PERMITS SHALL BE SATISFIED AND CLOSED OUT ACCORDING TO LOCAL JURISDICTIONAL REQUIREMENTS
- ALL CONSTRUCTION MEANS AND METHODS; INCLUDING BUT NOT LIMITED TO, ERECTION PLANS, RIGGING PLANS, CLIMBING PLANS, AND RESCUE PLANS SHALL BE THE RESPONSIBILITY OF THE GENERAL CONTRACTOR RESPONSIBLE FOR THE EXECUTION OF THE WORK CONTAINED HEREIN, AND SHALL MEET ANSI/ASSE A10.48 (LATEST EDITION); FEDERAL, STATE, AND LOCAL REGULATIONS; AND ANY APPLICABLE INDUSTRY CONSENSUS STANDARDS RELATED TO THE CONSTRUCTION ACTIVITIES BEING PERFORMED. ALL RIGGING PLANS SHALL ADHERE TO ANSI/ASSE A10.48 (LATEST EDITION) AND CROWN CASTLE USA INC. STANDARD CED-STD-10253, INCLUDING THE REQUIRED INVOLVEMENT OF A QUALIFIED ENGINEER FOR CLASS IV CONSTRUCTION, TO CERTIFY THE SUPPORTING STRUCTURE(S) IN ACCORDANCE WITH ANSI/TIA-322
- ALL SITE WORK TO COMPLY WITH OAS-STD-10068 "INSTALLATION STANDARDS FOR CONSTRUCTION ACTIVITIES ON CROWN CASTLE USA INC. TOWER SITE," CED-STD-10294 "STANDARD FOR INSTALLATION OF MOUNTS AND APPURTENANCES," AND LATEST VERSION OF ANSI/TIA-1019-A-2012 "STANDARD FOR
- INSTALLATION, ALTERATION, AND MAINTENANCE OF ANTENNA SUPPORTING STRUCTURES AND ANTENNAS."

  IF THE SPECIFIED EQUIPMENT CAN NOT BE INSTALLED AS SHOWN ON THESE DRAWINGS, THE CONTRACTOR SHALL PROPOSE AN ALTERNATIVE INSTALLATION FOR APPROVAL BY CROWN CASTLE USA INC. PRIOR TO PROCEEDING WITH ANY SUCH CHANGE OF INSTALLATION.
- PROCEEDING WITH ANY SUCH CHANGE OF INSTALLION.
  ALL MATERIALS FURNISHED AND INSTALLED SHALL BE IN STRICT ACCORDANCE WITH ALL APPLICABLE
  CODES, REGULATIONS AND ORDINANCES. CONTRACTOR SHALL ISSUE ALL APPROPRIATE NOTICES AND
  COMPLY WITH ALL LAWS, ORDINANCES, RULES, REGULATIONS AND LAWFUL ORDERS OF ANY PUBLIC
  AUTHORITY REGARDING THE PERFORMANCE OF THE WORK. ALL WORK CARRIED OUT SHALL COMPLY WIT
  ALL APPLICABLE MUNICIPAL AND UTILITY COMPANY SPECIFICATIONS AND LOCAL JURISDICTIONAL CODES, ORDINANCES AND APPLICABLE REGULATIONS.
- THE CONTRACTOR SHALL INSTALL ALL EQUIPMENT AND MATERIALS IN ACCORDANCE WITH MANUFACTURER'S RECOMMENDATIONS UNLESS SPECIFICALLY STATED OTHERWISE.
- RECOMMENDATIONS UNLESS SPECIFICALLY STATED OTHERWISE.

  1. THE CONTRACTOR SHALL CONTACT UTILITY LOCATING SERVICES PRIOR TO THE START OF CONSTRUCTION.

  1. ALL EXISTING ACTIVE SEWER, WATER, GAS, ELECTRIC AND OTHER UTILITIES WHERE ENCOUNTERED IN THE WORK, SHALL BE PROTECTED AT ALL TIMES AND WHERE REQUIRED FOR THE PROPER EXECUTION OF THE WORK, SHALL BE RELOCATED AS DIRECTED BY CONTRACTOR, EXTREME CAUTION SHOULD BE USED BY THE CONTRACTOR WHEN EXCAVATING OR DRILLING PIERS AROUND OR NEAR UTILITIES. CONTRACTOR SHALL PROVIDE SAFETY TRAINING FOR THE WORKING CREW. THIS WILL INCLUDE BUT NOT BE LIMITED TO A) FALL PROTECTION B) CONFINED SPACE C) ELECTRICAL SAFETY D) TRENCHING AND EXCAVATION E) CONSTRUCTION SAFFTY PROCEDURES
- CONSTRUCTION SAFELY PROCEDURES.
  ALL SITE WORK SHALL BE AS INDICATED ON THE STAMPED CONSTRUCTION DRAWINGS AND PROJECT
  SPECIFICATIONS, LATEST APPROVED REVISION.
  CONTRACTOR SHALL KEEP THE SITE FREE FROM ACCUMULATING WASTE MATERIAL, DEBRIS, AND TRASH AT
  THE COMPLETION OF THE WORK. IF NECESSARY, RUBBISH, STUMPS, DEBRIS, STICKS, STONES AND OTHER
  REFUSE SHALL BE REMOVED FROM THE SITE AND DISPOSED OF LEGALLY.
  ALL EXISTING INACTIVE SEWER, WATER, GAS, ELECTRIC AND OTHER UTILITIES, WHICH INTERFERE WITH THE
- EXECUTION OF THE WORK, SHALL BE REMOVED AND/OR CAPPED, PLUGGED OR OTHERWISE DISCONTINUED AT POINTS WHICH WILL NOT INTERFERE WITH THE EXECUTION OF THE WORK, SUBJECT TO THE APPROVAL OF CONTRACTOR, TOWER OWNER, CROWN CASTLE USA INC., AND/OR LOCAL UTILITIES.
- THE CONTRACTOR SHALL PROVIDE SITE SIGNAGE IN ACCORDANCE WITH THE TECHNICAL SPECIFICATION FOR SITE SIGNAGE REQUIRED BY LOCAL JURISDICTION AND SIGNAGE REQUIRED ON INDIVIDUAL PIECES OF EQUIPMENT, ROOMS, AND SHELTERS.
- THE SITE SHALL BE GRADED TO CAUSE SURFACE WATER TO FLOW AWAY FROM THE CARRIER'S EQUIPMENT
- THE SUB GRADE SHALL BE COMPACTED AND BROUGHT TO A SMOOTH UNIFORM GRADE PRIOR TO FINISHED SURFACE APPLICATION.
- THE AREAS OF THE OWNERS PROPERTY DISTURBED BY THE WORK AND NOT COVERED BY THE TOWER, EQUIPMENT OR DRIVEWAY, SHALL BE GRADED TO A UNIFORM SLOPE, AND STABILIZED TO PREVENT EROSION AS SPECIFIED ON THE CONSTRUCTION DRAWINGS AND/OR PROJECT SPECIFICATIONS.
- CONTRACTOR SHALL MINIMIZE DISTURBANCE TO EXISTING SITE DURING CONSTRUCTION FROSION CONTRO MEASURES, IF REQUIRED DURING CONSTRUCTION, SHALL BE IN CONFORMANCE WITH THE LOCAL GUIDELINES FOR EROSION AND SEDIMENT CONTROL.

  THE CONTRACTOR SHALL MINIMIZE DISTORBANCE TO EASIER OF THE LOCAL GUIDELINES FOR EROSION AND SEDIMENT CONTROL.
- STRUCTURES. ANY DAMAGED PART SHALL BE REPAIRED AT CONTRACTOR'S EXPENSE TO THE SATISFACTION
- CONTRACTOR SHALL LEGALLY AND PROPERLY DISPOSE OF ALL SCRAP MATERIALS SUCH AS COAXIAL
  CABLES AND OTHER ITEMS REMOVED FROM THE EXISTING FACILITY. ANTENNAS REMOVED SHALL BE RETURNED TO THE OWNER'S DESIGNATED LOCATION.

  CONTRACTOR SHALL LEAVE PREMISES IN CLEAN CONDITION. TRASH AND DEBRIS SHOULD BE REMOVED.
- FROM SITE ON A DAILY BASIS.
- 22. NO FILL OR EMBANKMENT MATERIAL SHALL BE PLACED ON FROZEN GROUND. FROZEN MATERIALS, SNOW OR ICE SHALL NOT BE PLACED IN ANY FILL OR EMBANKMENT.

### **GENERAL NOTES:**

- FOR THE PURPOSE OF CONSTRUCTION DRAWING, THE FOLLOWING DEFINITIONS SHALL APPLY: CONTRACTOR: GENERAL CONTRACTOR RESPONSIBLE FOR CONSTRUCTION CARRIER: AT&T TOWER OWNER: CROWN CASTLE USA INC.
- TOWER OWNER: CROWN CASTLE USA INC.
  THESE DRAWINGS HAVE BEEN PREPARED USING STANDARDS OF PROFESSIONAL CARE AND COMPLETENESS NORMALLY EXERCISED UNDER SIMILAR CIRCUMSTANCES BY REPUTABLE ENGINEERS IN THIS OR SIMILAR LOCALITIES. IT IS ASSUMED THAT THE WORK DEPICTED WILL BE PERFORMED BY AN EXPERIENCED CONTRACTOR AND/OR WORKPEOPLE WHO HAVE A WORKING KNOWLEDGE OF THE APPLICABLE CODE STANDARDS AND REQUIREMENTS AND OF INDUSTRY ACCEPTED STANDARD GOOD PRACTICE. AS NOT EVERY CONDITION OR ELEMENT IS (OR CAN BE) EXPLICITLY SHOWN ON THESE DRAWINGS. ON THESE DRAWINGS, THE CONTRACTOR SHALL USE INDUSTRY ACCEPTED STANDARD GOOD PRACTICE FOR MISCFLLANEOUS WORK NOT EXPLICITLY SHOWN.
- MISCELLANEOUS WORK NOT EXPLICITLY SHOWN.
  THESE DRAWINGS REPRESENT THE FINISHED STRUCTURE. THEY DO NOT INDICATE THE MEANS OR METHODS OF
  CONSTRUCTION. THE CONTRACTOR SHALL BE SOLELY RESPONSIBLE FOR THE CONSTRUCTION MEANS, METHODS,
  TECHNIQUES, SEQUENCES, AND PROCEDURES. THE CONTRACTOR SHALL PROVIDE ALL MEASURES NECESSARY FOR
  PROTECTION OF LIFE AND PROPERTY DURING CONSTRUCTION. SUCH MEASURES SHALL INCLUDE, BUT NOT BE LIMITED
  TO, BRACING, FORMWORK, SHORING, ETC. SITE VISITS BY THE ENGINEER OR HIS REPRESENTATIVE WILL NOT INCLUDE
  INSPECTION OF THESE ITEMS AND IS FOR STRUCTURAL OBSERVATION OF THE FINISHED STRUCTURE ONLY.
  NOTES AND DETAILS IN THE CONSTRUCTION DRAWINGS SHALL TAKE PRECEDENCE OVER GENERAL NOTES AND TYPICAL
  DETAILS. WHERE NO DETAILS ARE SHOWN, CONSTRUCTION SHALL CONFORM TO SIMILAR WORK ON THE PROJECT,
  AND/OR AS PROVIDED FOR IN THE CONTRACT DOCUMENTS. WHERE DISCREPANCIES OCCUR BETWEEN PLANS, DETAILS,
  GENERAL NOTES, AND SPECIFICATIONS, THE GREATER, MORE STRICT REQUIREMENTS, SHALL GOVERN. IF FURTHER
  CLARIFICATION IS REQUIRED CONTACT THE ENGINEER OF RECORD.
  SUBSTANTIAL EFFORT HAS BEEN MADE TO PROVIDE ACCURATE DIMENSIONS AND MEASUREMENTS ON THE DRAWINGS TO
  ASSIST IN THE FABRICATION AND OR PLACEMENT OF CONSTRUCTION SELECUTION IS THE SOLE RESPONSIBILITY.
- ASSIST IN THE FABRICATION AND/OR PLACEMENT OF CONSTRUCTION ELEMENTS BUT IT IS THE SOLE RESPONSIBILITY OF THE CONTRACTOR TO FIELD VERIFY THE DIMENSIONS, MEASUREMENTS, AND/OR CLEARANCES SHOWN IN THE CONSTRUCTION DRAWINGS PRIOR TO FABRICATION OR CUTTING OF ANY NEW OR EXISTING CONSTRUCTION ELEMENTS.
- CONSTRUCTION DRAWINGS PRIOR TO FABRICATION OR CUTTING OF ANY NEW OR EXISTING CONSTRUCTION ELEMENTS. IF IT IS DETERMINED THAT THERE ARE DISCREPANCIES AND/OR CONFLICTS WITH THE CONSTRUCTION DRAWINGS THE ENGINEER OF RECORD IS TO BE NOTIFIED AS SOON AS POSSIBLE.

  PRIOR TO THE SUBMISSION OF BIDS, THE BIDDING CONTRACTOR SHALL WSIT THE CELL SITE TO FAMILIARIZE WITH THE EXISTING CONDITIONS AND TO CONFIRM THAT THE WORK CAN BE ACCOMPLISHED AS SHOWN ON THE CONSTRUCTION DRAWINGS. ANY DISCREPANCY FOUND SHALL BE BROUGHT TO THE ATTENTION OF CROWN CASTLE.

  ALL MATERIALS FURNISHED AND INSTALLED SHALL BE IN STRICT ACCORDANCE WITH ALL APPLICABLE CODES, REGULATIONS AND ORDINANCES. CONTRACTOR SHALL ISSUE ALL APPROPRIATE NOTICES AND COMPLY WITH ALL LAWS, ORDINANCES. RULES, REGULATIONS AND LAWFUL ORDERS OF ANY PUBLIC AUTHORITY REGARDING THE PERFORMANCE OF THE WORK. ALL WORK CARRIED OUT SHALL COMPLY WITH ALL APPLICABLE MUNICIPAL AND UTILITY COMPANY SPECIFICATIONS AND LOCAL JURISDICTIONAL CODES, ORDINANCES AND APPLICABLE REGULATIONS.

  UNLESS NOTED OTHERWISE, THE WORK SHALL INCLUDE FURNISHING MATERIALS, EQUIPMENT, APPURTENANCES AND LABOR NECESSARY TO COMPLETE ALL INSTALLATIONS AS INDICATED ON THE DRAWINGS.

- THE CONTRACTOR SHALL INSTALLAL EQUIPMENT AND MATERIALS IN ACCORDANCE WITH MANUFACTURER'S RECOMMENDATIONS UNLESS SPECIFICALLY STATED OTHERWISE. IF THE SPECIFIED EQUIPMENT CAN NOT BE INSTALLED AS SHOWN ON THESE DRAWINGS, THE CONTRACTOR SHALL PROPOSE AN ALTERNATIVE INSTALLATION. FOR APPROVAL BY THE CARRIER AND CROWN CASTLE PRIOR TO PROCEEDING WITH ANY SUCH CHANGE OF INSTALLATION.

  CONTRACTOR IS TO PEFFORM A SITE INVESTIGATION AND IS TO DETERMINE THE BEST ROUTING OF ALL CONDUITS FOR POWER, AND TELCO AND FOR GROUNDING CABLES AS SHOWN IN THE POWER, TELCO, AND GROUNDING PLAN
- THE CONTRACTOR SHALL PROTECT EXISTING IMPROVEM<mark>ENTS, PAVEMENTS, CURBS, LANDS</mark>CAPING AND STRUCTURES, ANY
- DAMAGED PART SHALL BE REPAIRED AT CONTRACTOR'S EXPENSE TO THE SATISFACTION OF GROWN CASTLE USA INC. CONTRACTOR SHALL LEGALLY AND PROPERLY DISPOSE OF ALL SCRAP MATERIALS SUCH AS COAXIAL CABLES AND OTHER ITEMS REMOVED FROM THE EXISTING FACILITY. ANTENNAS REMOVED SHALL BE RETURNED TO THE OWNER'S DESIGNATED LOCATION
- CONTRACTOR SHALL LEAVE PREMISES IN CLEAN CONDITION. TRASH AND DEBRIS SHOULD BE REMOVED FROM SITE ON

### CONCRETE, FOUNDATIONS, AND REINFORCING STEEL:

- ALL CONCRETE WORK SHALL BE IN ACCORDANCE WITH THE ACI 301, ACI 318, ACI 336, ASTM A184, ASTM A185 AND THE DESIGN AND CONSTRUCTION SPECIFICATION FOR CAST-IN-PLACE CONCRETE.
  UNLESS NOTED OTHERWISE, SOIL BEARING PRESSURE USED FOR DESIGN OF SLABS AND FOUNDATIONS IS ASSUMED
- ALL CONCRETE SHALL HAVE A MINIMUM COMPRESSIVE STRENGTH (f'c) OF 3000 psi AT 28 DAYS, UNLESS NOTED OTHERWISE. NO MORE THAN 90 MINUTES SHALL ELAPSE FROM BATCH TIME TO TIME OF PLACEMENT UNLESS APPROVED BY THE ENGINEER OF RECORD. TEMPERATURE OF CONCRETE SHALL NOT EXCEED 90' AT TIME OF PLACEMENT.
- CONCRETE EXPOSED TO FREEZE-THAW CYCLES SHALL CONTAIN AIR ENTRAINING ADMIXTURES. AMOUNT OF AIR
- CONNETIE EXPOSED TO THEEZE—THAW CYCLES SHALL CONTAIN ANY ENTRAINING ADMIXTURES. AMOONT OF AIR ENTRAINMENT TO BE BASED ON SIZE OF AGGREGATE AND F3 CLASS EXPOSURE (VERY SEVERE). CEMENT USED TO BE TYPE II PORTLAND CEMENT WITH A MAXIMUM WATER—TO—CEMENT RATIO (W/C) OF 0.45.

  ALL STEEL REINFORCING SHALL CONFORM TO ASTM A615. ALL WELDED WIRE FABRIC (WWF) SHALL CONFORM TO ASTM A185. ALL SPLICES SHALL BE CLASS "B" TENSION SPLICES, UNLESS NOTED OTHERWISE. ALL HOOKS SHALL BE STANDARD 90 DEGREE HOOKS, UNLESS NOTED OTHERWISE. YIELD STRENGTH (Fy) OF STANDARD DEFORMED BARS ARE AS FOLLOWS: #4 BARS AND SMALLER
- ON DRAWINGS CONCRETE CAST AGAINST AND PERMANENTLY EXPOSED TO EARTH...
- CONCRETE EXPOSED TO EARTH OR WEATHER:
  #6 BARS AND LARGER..... #5 BARS AND SMALLER. .1-1/2'
- CONCRETE NOT EXPOSED TO EARTH OR WEATHER: BEAMS AND COLUMNS.
- A TOOLED EDGE OR A 3/4" CHAMFER SHALL BE PROVIDED AT ALL EXPOSED EDGES OF CONCRETE, UNLESS NOTED OTHERWISE, IN ACCORDANCE WITH ACI 301 SECTION 4.2.4.

### GREENFIELD GROUNDING NOTES:

COPPER FOR OUTDOOR BTS.

- ALL GROUND ELECTRODE SYSTEMS (INCLUDING TELECOMMUNICATION, RADIO, LIGHTNING PROTECTION AND AC POWER GES'S) SHALL BE BONDED TOGETHER AT OR BELOW GRADE, BY TWO OR MORE COPPER BONDING CONDUCTORS IN ACCORDANCE WITH THE NEC
- THE CONTRACTOR SHALL PERFORM IEEE FALL—OF—POTENTAL RESISTANCE TO EARTH TESTING (PER IEEE 1100 AND 81) FOR GROUND ELECTRODE SYSTEMS, THE CONTRACTOR SHALL FURNISH AND INSTALL SUPPLEMENTAL GROUND ELECTRODES AS NEEDED TO ACHIEVE A TEST RESULT OF 5 OHMS OR LESS.

  THE CONTRACTOR IS RESPONSIBLE FOR PROPERLY SEQUENCING GROUNDING AND UNDERGROUND CONDUIT INSTALLATION AS TO PREVENT ANY LOSS OF CONTINUITY IN THE GROUNDING SYSTEM OR DAMAGE TO THE CONDUIT AND PROVIDE METAL CONDUIT AND TRAY SHALL BE GROUNDED AND MADE ELECTRICALLY CONTINUOUS WITH LISTED BONDING FITTINGS OR BY BONDING ACROSS THE DISCONTINUITY WITH #6 COPPER WIRE UL APPROVED GROUNDING TYPE CONDUIT
- METAL RACEWAY SHALL NOT BE USED AS THE NEC REQUIRED EQUIPMENT GROUND CONDUCTOR. STRANDED COPPER CONDUCTORS WITH GREEN INSULATION, SIZED IN ACCORDANCE WITH THE NEC, SHALL BE FURNISHED AND INSTALLED WITH THE POWER CIRCUITS TO BTS EQUIPMENT.
- EACH CABINET FRAME SHALL BE DIRECTLY CONNECTED TO THE MASTER GROUND BAR WITH GREEN INSULATED SUPPLEMENTAL EQUIPMENT GROUND WIRES, #6 STRANDED COPPER OR LARGER FOR INDOOR BTS; #2 BARE SOLID TINNED
- CONNECTIONS TO THE GROUND BUS SHALL NOT BE DOUBLED UP OR STACKED BACK TO BACK CONNECTIONS ON OPPOSITE SIDE OF THE GROUND BUS ARE PERMITTED.
- ALL EXTERIOR GROUND CONDUCTORS BETWEEN EQUIPMENT/GROUND BARS AND THE GROUND RING SHALL BE #2 SOLID TINNED COPPER UNLESS OTHERWISE INDICATED.
  ALLMINUM CONDUCTOR OR COPPER CLAD STEEL CONDUCTOR SHALL NOT BE USED FOR GROUNDING CONNECTIONS.

  USE OF 90° BENDS IN THE PROTECTION GROUNDING CONDUCTORS SHALL BE AVOIDED WHEN 45° BENDS CAN BE ADEQUATELY SUPPORTED.

  EXCHERMIC WELDS SHALL BE USED FOR ALL GROUNDING CONNECTIONS BELOW GRADE.

- ALL GROUND CONNECTIONS ABOVE GRADE (INTERIOR AND EXTERIOR) SHALL BE FORMED USING HIGH PRESS CRIMPS.

  COMPRESSION GROUND CONNECTIONS MAY BE REPLACED BY EXOTHERMIC WELD CONNECTIONS.

  ICE BRIDGE BONDING CONDUCTORS SHALL BE EXOTHERMICALLY BONDED OR BOLTED TO THE BRIDGE AND THE TOWER GROUND BAR.

- ICE BRIDGE BONDING CONDUCTORS SHALL BE EXOTHERMICALLY BONDED OR BOLTED TO THE BRIDGE AND THE TOWER GROUND BAR.

  APPROVED ANTIOXIDANT COATINGS (i.e. CONDUCTIVE GEL OR PASTE) SHALL BE USON FALL BE USON FROM THE BRIDGE AND SHIP OR GROUND CONNECTIONS.

  ALL EXTERIOR GROUND CONNECTIONS SHALL BE COATED WITH A CORROSION RESISTANT MATERIAL.

  MISCELLANEOUS ELECTRICAL AND NON-ELECTRICAL METAL BOXES, FRAMES AND SUPPORTS SHALL BE BONDED TO THE GROUND RING, IN ACCORDANCE WITH THE NEC.

  BOND ALL METALLIC OBJECTS WITHIN 6 ft OF MAIN GROUND RING WITH (1) #2 BARE SOLID TINNED COPPER GROUND CONDUCTOR.

  GROUND CONDUCTORS USED FOR THE FACILITY GROUNDING AND LIGHTNING PROTECTION SYSTEMS SHALL NOT BE ROUTED THROUGH METALLIC OBJECTS THAT FORM A RING AROUND THE CONDUCTOR, SUCH AS METALLIC CONDUITS,

  METAL SUPPORT CLIPS OR SLEEVES THROUGH WALLS OR FLOORS. WHEN IT IS REQUIRED TO BE HOUSED IN CONDUIT TO MEET CODE REQUIREMENTS OR LOCAL CONDITIONS, NON-METALLIC MATERIAL SUCH AS PVC CONDUIT SHALL BE

  USED. WHERE USE OF METAL CONDUIT IS UNAVOIDABLE (i.e., NONMETALLIC CONDUIT PROHIBITED BY LOCAL CODE) THE GROUND CONDUCTOR SHALL BE BONDED TO EACH END OF THE METAL CONDUIT.

  ALL GROUNDS THAT TRANSITION FROM BELOW GRADE TO ABOVE GRADE MUST BE #2 BARE SOLID TINNED COPPER IN 3/4" NON-METALLIC, FLEXIBLE CONDUIT FROM 24" BELOW GRADE TO WITHIN 3" TO 6" OF CAD-WELD TERMINATION

  POINT THE EXPOSED PAID OF THE CONDUIT MIST BE SEALED WITH SUICODE CAULE AND PROVINCE THAT HAS METAL SOLID AS METALLIC CONDUIT.
- POINT. THE EXPOSED END OF THE CONDUIT MUST BE SEALED WITH SILICONE CAULK. (ADD TRANSITIONING GROUND STANDARD DETAIL AS WELL).
  BUILDINGS WHERE THE MAIN GROUNDING CONDUCTORS ARE REQUIRED TO BE ROUTED TO GRADE, THE CONTRACTOR SHALL ROUTE TWO GROUNDING CONDUCTORS FROM THE ROOFTOP, TOWERS, AND WATER TOWERS GROUNDING RING, TO THE EXISTING GROUNDING SYSTEM, THE GROUNDING CONDUCTORS SHALL NOT BE SMALLER THAN 2/0 COPPER. ROOFTOP GROUNDING RING SHALL BE BONDED TO THE EXISTING GROUNDING SYSTEM, THE BUILDING STEEL COLUMNS, LIGHTNING PROTECTION SYSTEM, AND BUILDING MAIN WATER LINE (FERROUS OR NONFERROUS METAL PIPING ONLY).

### **ELECTRICAL INSTALLATION NOTES:**

- ALL ELECTRICAL WORK SHALL BE PERFORMED IN ACCORDANCE WITH THE PROJECT SPECIFICATIONS, NEC AND ALL APPLICABLE
- FEDERAL, STATE, AND LOCAL CODES/ORDINANCES.
  CONDUIT ROUTINGS ARE SCHEMATIC. CONTRACTOR SHALL INSTALL CONDUITS SO THAT ACCESS TO EQUIPMENT IS NOT BLOCKED
- AND TRIP HAZARDS ARE FLIMINATED WIRING, RACEWAY AND SUPPORT METHODS AND MATERIALS SHALL COMPLY WITH THE REQUIREMENTS OF THE NEC

- WIRING, RACEWAY AND SUPPORT METHODS AND MATERIALS SHALL COMPLY WITH THE REQUIREMENTS OF THE NEC.

  ALL CIRCUITS SHALL BE SEGREGATED AND MAINTAIN MINIMUM CABLE SEPARATION AS REQUIRED BY THE NEC.

  ALL EQUIPMENT SHALL BEAR THE UNDERWRITERS LABORATORIES LABEL OF APPROVAL, AND SHALL CONFORM TO REQUIREMENT OF THE NATIONAL ELECTRICAL CODE.

  ALL OVERCURRENT DEVICES SHALL HAVE AN INTERRUPTING CURRENT RATING THAT SHALL BE GREATER THAN THE SHORT CIRCUIT CURRENT TO WHICH THEY ARE SUBJECTED, 22,000 AIC MINIMUM, VERYIPY AVAILABLE SHORT CIRCUIT CURRENT DOES NOT EXCEED THE RATING OF ELECTRICAL EQUIPMENT IN ACCORDANCE WITH ARTICLE 110.24 NEC OR THE MOST CURRENT ADDITED. ADOPTED CODE PRE THE GOVERNING JURISDICTION
- FACH END OF EVERY POWER PHASE CONDUCTOR GROUNDING CONDUCTOR, AND TELCO CONDUCTOR OR CABLE SHALL BE LABELED WITH COLOR-CODED INSULATION OR ELECTRICAL TAPE (3M BRAND, 1/2" PLASTIC ELECTRICAL TAPE WITH UV
- PROTECTION, OR EQUAL). THE IDENTIFICATION METHOD SHALL CONFORM WITH NEC AND OSHA.
  ALL ELECTRICAL COMPONENTS SHALL BE CLEARLY LABELED WITH LAMICOID TAGS SHOWING THEIR RATED VOLTAGE, PHASE CIRCUIT ID'S).

- PANEL BOARDS (ID NUMBERS) SHALL BE CLEARLY LABELED WITH PLASTIC LABELS.
  ALL TIE WRAPS SHALL BE CUT FLUSH WITH APPROVED CUTTING TOOL TO REMOVE SHARP EDGES.
  ALL POWER AND EQUIPMENT GROUND WIRING IN TUBING OR CONDUIT SHALL BE SINGLE COPPER CONDUCTOR (#14 OR LARGER)
  WITH TYPE THHW, THWN, THWN-2, XHHW, XHHW-2, THW, THW-2, RHW, OR RHW-2 INSULATION UNLESS OTHERWISE SPECIFIED.
- SUPPLEMENTAL EQUIPMENT GROUND WIRING LOCATED INDOORS SHALL BE SINGLE COPPER CONDUCTOR (#6 OR LARGER) WITH TYPE THHW, THWN, THWN-2, XHHW, XHHW-2, THW, THW-2, RHW, OR RHW-2 INSULATION UNLESS OTHERWISE SPECIFIED.

  POWER AND CONTROL WIRING IN FLEXIBLE CORD SHALL BE MULTI-CONDUCTOR, TYPE SOOW CORD (#14 OR LARGER) UNLESS
- OTHERWISE SPECIFIED.
- POWER AND CONTROL WIRING FOR USE IN CABLE TRAY SHALL BE MULTI-CONDUCTOR, TYPE TC CABLE (#14 OR LARGER), WITH TYPE TIHM, THWN, THWN, THWN-2, THHW, THWN-2, THW, THW-2, INW, THWN-2 INSULATION UNLESS OTHERWISE SPECIFIED. ALL POWER AND GROUNDING CONNECTIONS SHALL BE CRIMP-STYLE, COMPRESSION WIRE LUGS AND WIRE NUTS BY THOMAS AND BETTS (OR EQUAL). LUGS AND WIRE NUTS SHALL BE RATED FOR OPERATION NOT LESS THAN 75' C (90' C IF AVAILABLE).
- RACEWAY AND CABLE TRAY SHALL BE LISTED OR LABELED FOR ELECTRICAL USE IN ACCORDANCE WITH NEMA. UL. ANSI/IEEE
- 15. ELECTRICAL METALLIC TUBING (EMT), INTERMEDIATE METAL CONDUIT (IMC), OR RIGID METAL CONDUIT (RMC) SHALL BE USED FOR EXPOSED INDOOR LOCATIONS.
- ELECTRICAL METALLIC TUBING (EMT) OR METAL—CLAD CABLE (MC) SHALL BE USED FOR CONCEALED INDOOR LOCATIONS.

  SCHEDULE 40 PVC UNDERGROUND ON STRAIGHTS AND SCHEDULE 80 PVC FOR ALL ELBOWS/90s AND ALL APPROVED ABOVE
- GRADE PVC CONDUIT 18. LIQUID-TIGHT FLEXIBLE METALLIC CONDUIT (LIQUID-TITE FLEX) SHALL BE USED INDOORS AND OUTDOORS, WHERE VIBRATION
- COURS OR FLEXIBILITY IS NEEDED.

  COURS OR FLEXIBILITY IS NEEDED.

  CONDUIT AND TUBING FITTINGS SHALL BE THREADED OR COMPRESSION—TYPE AND APPROVED FOR THE LOCATION USED. SET SCREW FITTINGS ARE NOT ACCEPTABLE.
- 20. CABINETS, BOXES AND WIRE WAYS SHALL BE LABELED FOR ELECTRICAL USE IN ACCORDANCE WITH NEMA, UL, ANSI/IEEE AND
- WIREWAYS SHALL BE METAL WITH AN ENAMEL FINISH AND INCLUDE A HINGED COVER, DESIGNED TO SWING OPEN DOWNWARDS
- (WIREMOLD SPECMATE WIREWAY). SLOTTED WIRING DUCT SHALL BE PVC AND INCLUDE COVER (PANDUIT TYPE E OR EQUAL). 23. CONDUITS SHALL BE FASTENED SECURELY IN PLACE WITH APPROVED NON-PERFORATED STRAPS AND HANGERS. EXPLOSIVE
- CONDUITS SHALL BE FASTENED SECURELY IN PLACE WITH APPROVED NON-PERFORATED STRAPS AND HANGERS. EXPLOSIVE DEVICES (i.e. POWDER-ACTUATED) FOR ATTACHING HANGERS TO STRUCTURE WILL NOT BE PERMITTED. CLOSELY FOLLOW THE LINES OF THE STRUCTURE, MAINTAIN CLOSE PROXIMITY TO THE STRUCTURE AND KEEP CONDUITS IN TIGHT ENVELOPES. CHANGES IN DIRECTION TO ROUTE AROUND OBSTACLES SHALL BE MADE WITH CONDUIT OUTLET BODIES. CONDUIT SHALL BE INSTALLED IN A NEAT AND WORKMANLIKE MANNER. PARALLEL AND PERPENDICULAR TO STRUCTURE WALL AND CEILING LINES. ALL CONDUIT SHALL BE FISHED TO CLEAR OBSTRUCTIONS. ENDS OF CONDUITS SHALL BE TEMPORARILY CAPPED FLUSH TO FINISH GRADE TO PREVENT CONCRETE, PLASTER OR DIRT FROM ENTERING, CONDUITS SHALL BE RIGHLY CLAMPED TO BOXES BY GALVANIZED MALLEABLE IRON BUSHING ON INSIDE AND GALVANIZED MALLEABLE IRON LOCKNUT ON OUTSIDE AND INSIDE. COUPMENT CABINETS, TERMINAL BOXES, JUNCTION BOXES AND PULL BOXES SHALL BE GALVANIZED OR EPOXY—COATED SHEET STEEL SHALL MEET OR EXCEED UL 50 AND BE RATED NEMA 1 (OR BETTER) FOR INTERIOR LOCATIONS AND NEMA 3R (OR BETTER) FOR INTERIOR LOCATIONS AND NEMA 3R (OR
- BETTER) FOR EXTERIOR LOCATIONS. METAL RECEPTACLE, SWITCH AND DEVICE BOXES SHALL BE GALVANIZED, EPOXY—COATED OR NON—CORRODING; SHALL MEET OR EXCEED UL 514A AND NEMA OS 1 AND BE RATED NEMA 1 (OR BETTER) FOR INTERIOR LOCATIONS AND WEATHER PROTECTED (WP OR BETTER) FOR EXTERIOR LOCATIONS
- NONMETALLIC RECEPTACLE, SWITCH AND DEVICE BOXES SHALL MEET OR EXCEED NEMA OS 2 (NEWEST REVISION) AND BE RATED NEMA 1 (OR BETTER) FOR INTERIOR LOCATIONS AND WEATHER PROTECTED (WP OR BETTER) FOR EXTERIOR LOCATIONS.
- 27 THE CONTRACTOR SHALL NOTIFY AND OBTAIN NECESSARY AUTHORIZATION FROM THE CARRIER AND/OR CROWN CASTLE USA INC.
- THE CONTRACTOR SHALL NOTIFI AND DEVIAIN NECESSARY AND INTERPRETAIN FROM THE CARRIER AND/OR CROWN CASILE OSA INC BEFORE COMMENCING WORK ON THE AC POWER DISTRIBUTION PANELS.

  THE CONTRACTOR SHALL PROVIDE NECESSARY TAGGING ON THE BREAKERS, CABLES AND DISTRIBUTION PANELS IN ACCORDANCE WITH THE APPLICABLE CODES AND STANDARDS TO SAFEGUARD LIFE AND PROPERTY.

  INSTALL LAMICOID LABEL ON THE METER CENTER TO SHOW "AT&IT".
- 30. ALL EMPTY/SPARE CONDUITS THAT ARE INSTALLED ARE TO HAVE A METERED MULE TAPE PULL CORD INSTALLED.

COND	UCTOR COL	OR CODE
SYSTEM	CONDUCTOR	COLOR
	A PHASE	BLACK
120/240V, 1Ø	B PHASE	RED
120/2401, 16	NEUTRAL	WHITE
	GROUND	GREEN
	A PHASE	BLACK
	B PHASE	RED
120/208V, 3Ø	C PHASE	BLUE
	NEUTRAL	WHITE
	GROUND	GREEN
	A PHASE	BROWN
	B PHASE	ORANGE OR PURPLE
277/480V, 3Ø	C PHASE	YELLOW
	NEUTRAL	GREY
	GROUND	GREEN
DC VOLTAGE	POS (+)	RED**
DC VOLIAGE	NEG (-)	BLACK**

\* SEE NEC 210.5(C)(1) AND (2)
\*\* POLARITY MARKED AT TERMINATION

UMTS

EXISTING FACILITY INTERFACE FRAME GEN GPS GSM LTE MGB MW GENERATOR
GLOBAL POSITIONING SYSTEM
GLOBAL SYSTEM FOR MOBILE
LONG TERM EVOLUTION
MASTER GROUND BAR
MICROWAVE GENERATOR (N) NEC NEW NATIONAL ELECTRIC CODE PROPOSED POWER PLANT RECTIFIER RADIO BASE STATION REMOTE ELECTRIC TIL RFDS RRH RRU SIAD TMA TYP REMOTE ELECTRIC TILIT
RADIO FREQUENCY DATA SHEET
REMOTE RADIO HEAD
REMOTE RADIO UNIT
SMART INTEGRATED DEVICE

TOWER MOUNTED AMPLIFIER

UNIVERSAL MOBILE TELECOMMUNICATIONS SYSTEM

APWA UNIFORM COLOR CODE:

WHITE PROPOSED EXCAVATION TEMPORARY SURVEY MARKINGS ELECTRIC POWER LINES, CABLES, CONDUIT, AND LIGHTING CABLES

YELLOW GAS, OIL, STEAM, PETROLEUM, OR GASEOUS MATERIALS COMMUNICATION, ALARM OR SIGNAL LINES, CABLES, OR CONDUIT AND TRAFFIC LOOPS

POTABLE WATER RECLAIMED WATER, IRRIGATION, AND

SLURRY LINES SEWERS AND DRAIN LINES





FRANKLIN, TN 37067




AT&T SITE NUMBER: 61163

BU #: **806361** NHV 102 943127

131 MANOR ROAD GUILFORD, CT 06437


EXISTING 150'-0" MONOPOLE

Ε			ISSU	ED FOR:	
	REV	DATE	DRWN	DESCRIPTION	DES./C
	0	03/10/2021	AM	CONSTRUCTION	AS

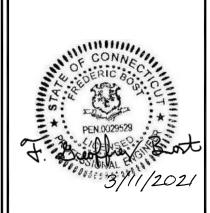

UNLESS THEY ARE ACTING UNDER THE DIRECTION OF A LICENSED PROFESSIONAL ENGINEER. TO ALTER THIS DOCUMENT.

SHEET NUMBER:

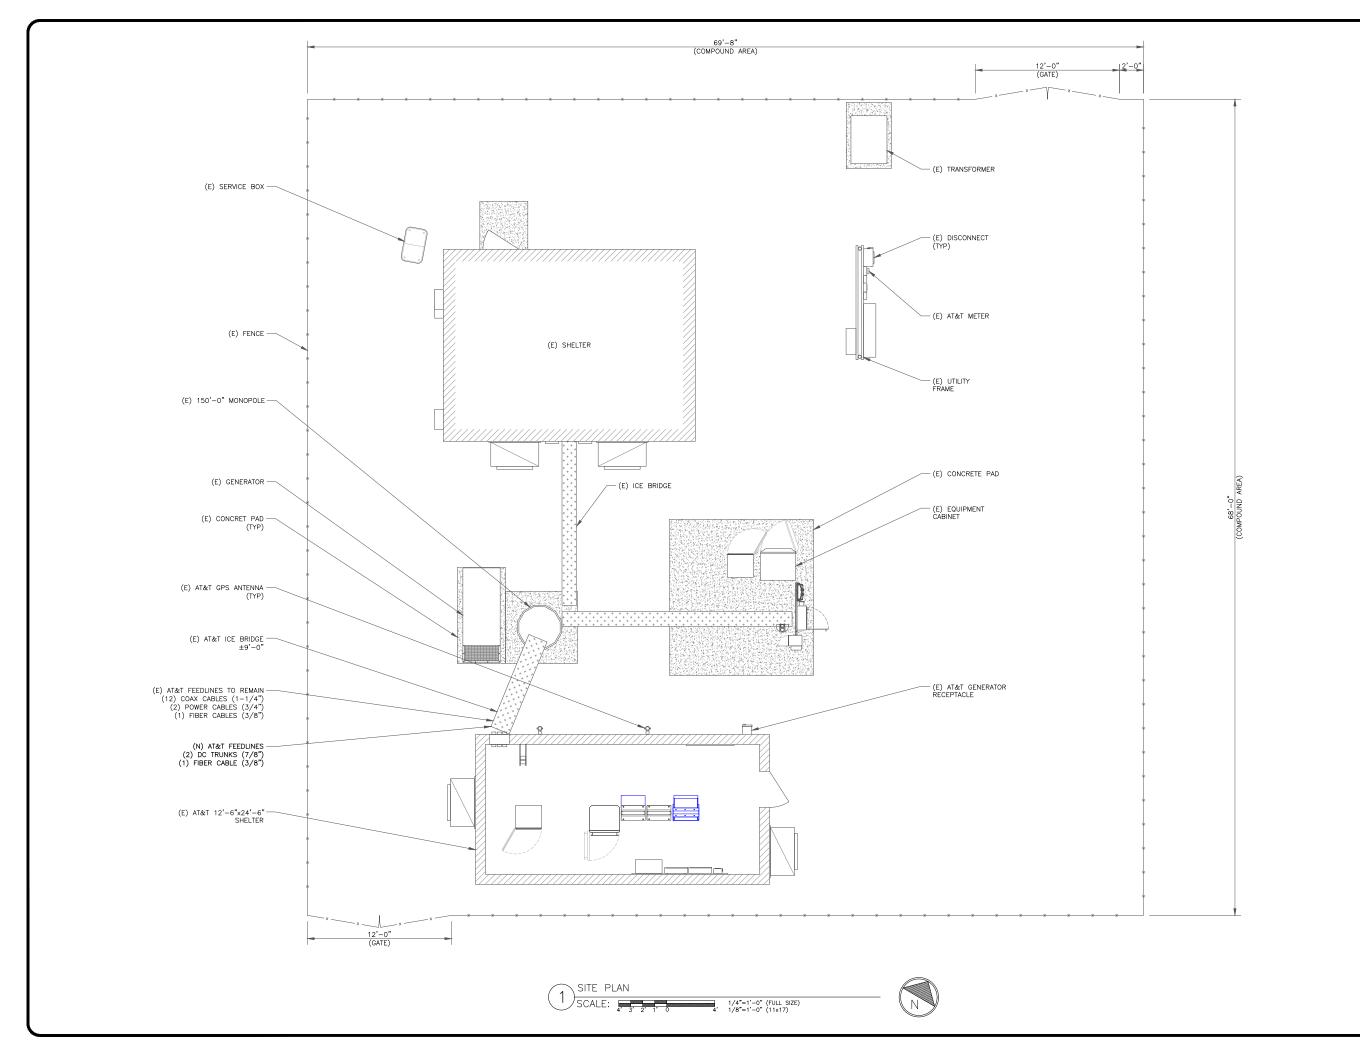







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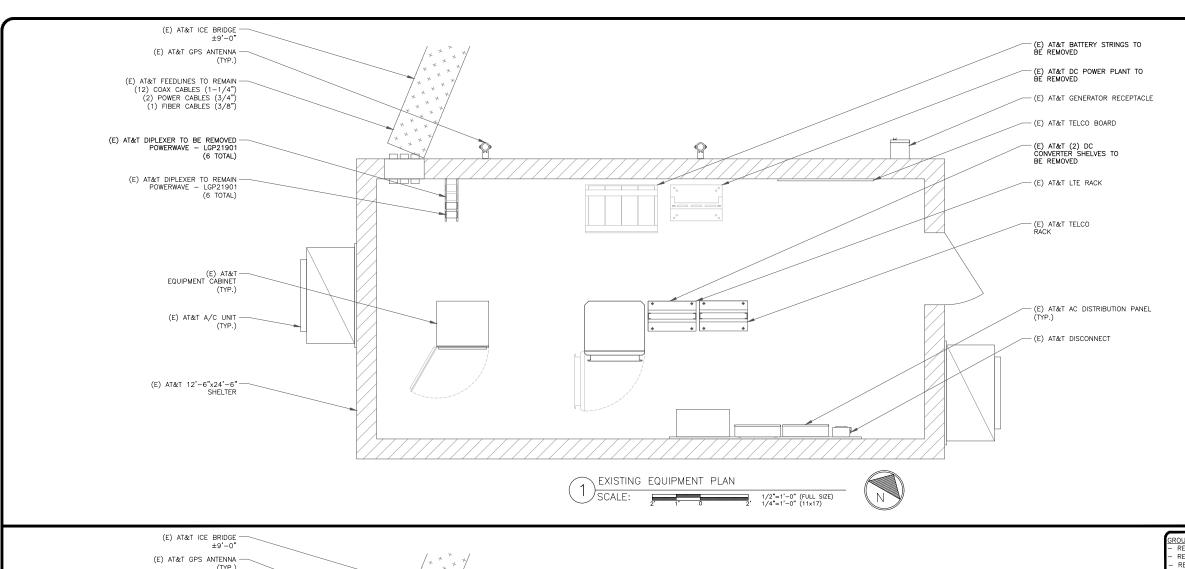
131 MANOR ROAD GUILFORD, CT 06437

EXISTING 150'-0" MONOPOLE

	ISSUED FOR:										
REV	DATE	DRWN	DESCRIPTION	DES./QA							
0	03/10/2021	AM	CONSTRUCTION	AS							
1	04/02/2021	AM	JURISDICTION	AS							



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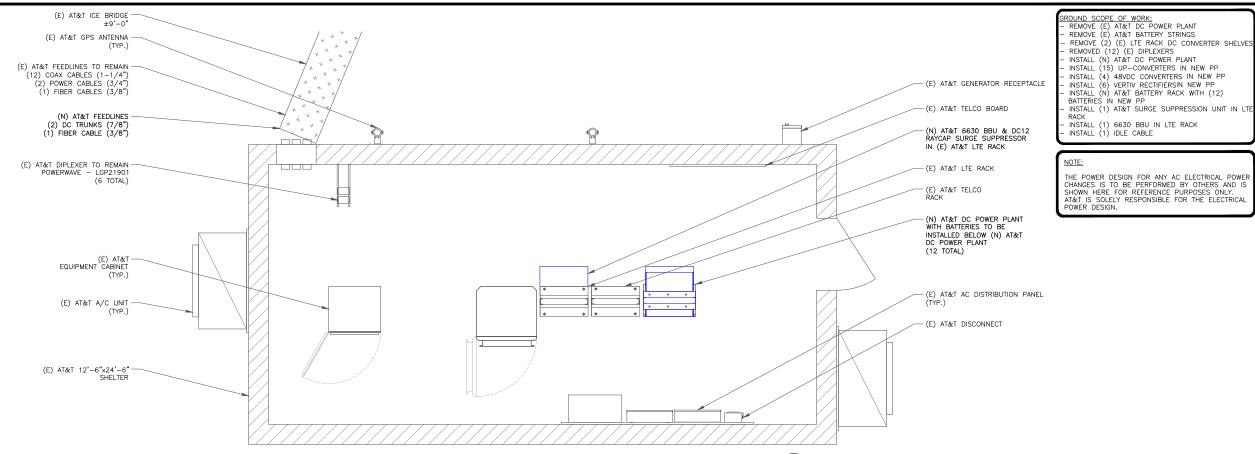


REVISION:

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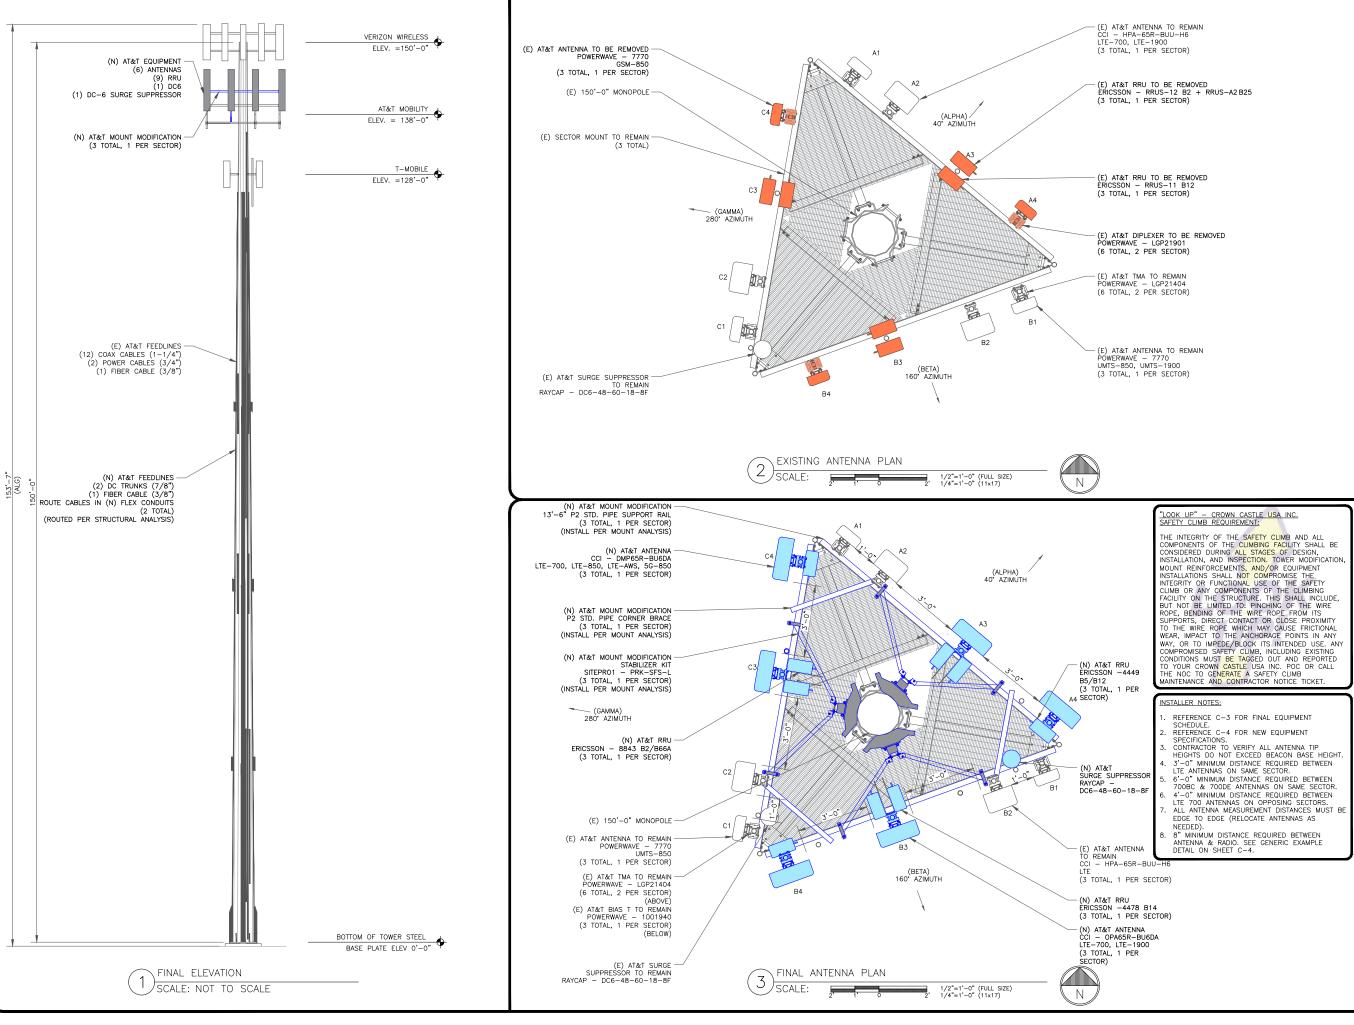
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SHEET NUMBER:



FINAL EQUIPMENT PLAN

(2) SCALE:









BU #: **806361 NHV 102 943127** 

131 MANOR ROAD GUILFORD, CT 06437

EXISTING 150'-0" MONOPOLE

		ISSU	ED FOR:	
REV	DATE	DRWN	DESCRIPTION	DES./QA
0	03/10/2021	AM	CONSTRUCTION	AS
1	04/02/2021	AM	JURISDICTION	AS



04/02/202
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SHEET NUMBER:

TO ALTER THIS DOCUMENT.

C-2


### FINAL EQUIPMENT SCHEDULE (VERIFY WITH CURRENT RFDS)

ALPHA						(												
		ANTENNA				RADIO			DIPLEXER			TMA		SURGE PROTECTION		CABLE	ES	
POSITION	TECH.	STATUS/MANUFACTURER MODEL	AZIMUTH	RAD CENTER	QTY.	STATUS/MODEL	LOCATION	QTY.	STATUS	LOCATION	QTY.	STATUS/MANUFACTURER MODEL	QTY	. STATUS/MODEL	QTY.	STATUS/TYPE	SIZE	LENGTH
A1	UMTS-850	(E) POWERWAVE	40°	140'	_	_	_	,	(E)	TOWER	2	(E) POWERWAVE - LGP21404		_		(E) COAX	1_1 //"	189'-0"
AI	OW12-820	7770	40	142'	_	_	_	2	(E)	IOWER	1	(E) POWERWAVE - 1001940	] _	_	4	(E) COAX	1-1/4	189 -0
A2	LTE	(E) CCI	40°	4.40'										(E) DC6-48-60-18-8F	2	(E) POWER SHARED	3/4"	189'-0"
AΖ	LIE	(E) CCI HPA-65R-BUU-H6	40	142'	_	-	_	_	_	_	-	_	'	SHARED	1	(E) FIBER SHARED	3/8"	189'-0"
A3	LTE-700	(N) CCI	40*	142'	1	(N) RADIO 4478 B14	TOWER				_	_				(N) POWER	7/8"	189'-0"
AS	LTE-1900	(N) CCI OPA65R-BU6DA	40	142	1	(N) 8843 B2/B66A	TOWER	_	_	_	_	_	1	(N) DC6-48-60-18-8F	2	(N) POWER SHARED	//8	189 -0
A4	LTE-700 LTE-850 LTE-AWS 5G-850	(N) CCI DMP65R-BU6DA	40*	142'	1	(N) 4449 B5/B12	TOWER	-	-	-	-	-		SHARED	1	(N) FIBER SHARED	3/8"	189'-0"

ВЕТА																		
B1	UMTS-850	(E) POWERWAVE 7770	40°	140'	_	_	_	0	(E)	TOWER	2	(E) POWERWAVE - LGP21404		_		(E) COAX	1_1 //"	189'-0"
В	OM15-650	7770	40	142'	_	_	ı	2	(E)	TOWER	1	(E) POWERWAVE - 1001940		_	4	(E) COAX	1-1/#	189 -0
B2	LTE	(E) CCI HPA-65R-BUU-H6	40°	142'	_	_	ı	1	_	_	-	_	_	SHARED	-	SHARED	-	-
52	LIL	HPA-65R-BUU-H6	40	142										SHARED	-	SHARED	-	-
B3	_	(N) CCI OPA65R-BU6DA	40°	142'	1	(N) RADIO 4478 B14	TOWER	_	_	_	_	_			_	SHARED	_	
		OPA65R-BU6DA	40	142	1	(N) 8843 B2/B66A	TOWER							SHARED		SHAKED		
B4	LTE-700 LTE-850 LTE-AWS 5G-850	(N) CCI DMP65R-BU6DA	40*	142'	1	(N) 4449 B5/B12	TOWER	-	-	-	_	-		S. MILLE	-	SHARED	_	-

GAMMA	Г Т									ı	ı		I	I	1 1		1	
C1	UMTS-850	(E) POWERWAVE	40*	142'	_	_	_	2	(E)	TOWER	2	(E) POWERWAVE - LGP21404	_	_	4	(E) COAX	1-1/4"	189'-0"
"	OW13 030	7770	1	142				2	(L)	TOWER	1	(E) POWERWAVE - 1001940			,	(2) 00///	'/'	109 -0
C2	LTE	(E) CCI HPA-65R-BUU-H6	40°	440'										SHARED	-	SHARED	=	-
C2	LIE	HPA-65R-BUU-H6	40	142'	-	-	-	ı	-	_	-	<del>-</del>	_	SHARED	-	SHARED	-	-
C3	LTE-700	(N) CCI	401		1	(N) RADIO 4478 B14	TOWER									0111050		
63	LTE-700 LTE-1900	(N) CCI OPA65R-BU6DA	40*	142'	1	(N) 8843 B2/B66A	IUWER	1	-	_	-	<del>-</del>		SHARED	_	SHARED	-	_
C4	LTE-700 LTE-850 LTE-AWS 5G-850	(N) CCI DMP65R-BU6DA	40*	142'	1	(N) 4449 B5/B12	TOWER	-	-	-	-	-		SHAKED	-	SHARED	-	-

NOTE: (E) - EXISTING (N) - NEW

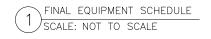







AT&T SITE NUMBER: 61163

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131 MANOR ROAD GUILFORD, CT 06437

EXISTING 150'-0" MONOPOLE

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0	03/10/2021	AM	CONSTRUCTION	AS								
1	04/02/2021	AM	JURISDICTION	AS								




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SHEET NUMBER:

C-3


revision:

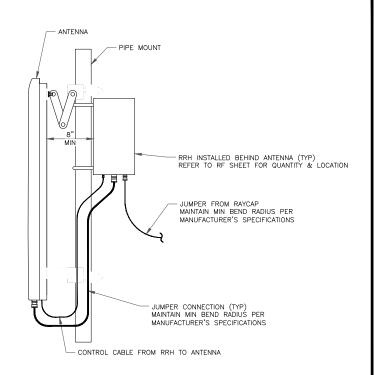

GENERIC ANTENNA MOUNTING ELEVATION SCALE: NOT TO SCALE

### INSTALLER NOTES:

- . COMPLY WITH MANUFACTURERS INSTRUCTIONS TO ENSURE THAT ALL RRHS RECEIVE ELECTRICAL POWER WITHIN 24 HOURS OF BEING REMOVED FROM THE
- HOURS OF BEING REMOVED FROM THE MANUFACTURER'S PACKAGING. 2. DO NOT OPEN RRH PACKAGES IN THE RAIN. 3. ALL PIPES, BRACKETS, AND MISCELLANEOUS HARDWARE TO BE GALVANIZED UNLESS NOTED OTHERWISE.

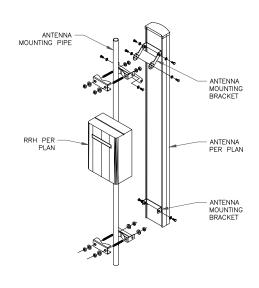


ANTENNA WITH RRH MOUNTING DETAIL (4) SCALE: NOT TO SCALE

### ERICSSON RRU MOUNTING KIT:

SXK 107 2839/1: SINGLE RRU SUPPORT KIT (PART # 5335) (OR ENGINEER APPROVED EQUIVALENT) SXK 107 2839/2: EXPANSION KIT (PART # 5336) (OR ENGINEER APPROVED EQUIVALENT)

REFER TO PRODUCT SPECS FOR BOLT SIZE & PIPE DIAMETER TOLERANCES. THE PART NO. SXK107-2839/2 IS REQUIRED FOR (2) RRUS.

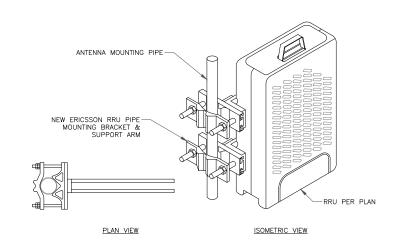


ERICSSON - SXK 107 2839 SCALE: NOT TO SCALE


### INSTALLER NOTES:

- COMPLY WITH MANUFACTURERS INSTRUCTIONS TO ENSURE THAT ALL RRHS RECEIVE ELECTRICAL POWER WITHIN 24 HOURS OF BEING REMOVED FROM THE
- HOURS OF BEING REMOVED FROM THE MANUFACTURER'S PACKAGING.

  DO NOT OPEN RRH PACKAGES IN THE RAIN . ALL PIPES, BRACKETS, AND MISCELLANEOUS HARDWARE TO BE GALVANIZED UNLESS NOTED OTHERWISE.

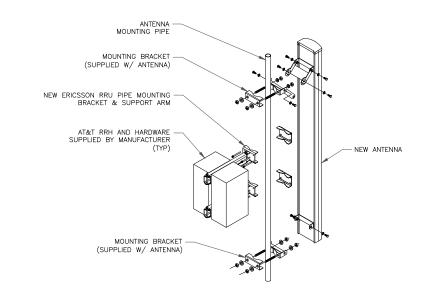

ANTENNA WITH DUAL RRH MOUNTING DETAIL SCALE: NOT TO SCALE

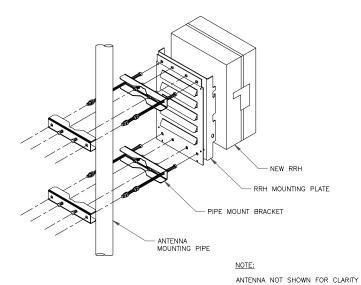


SINGLE RRH MOUNTING DETAIL


SCALE: NOT TO SCALE

DC6-48-60-18-8F

RAYCAP - DC6-48-60-18-8F SIZE: 11x31.25 IN. WEIGHT: 32.8 LBS WEIGHT: 32.8 LBS
NOMINAL OPERATING VOLTAGE: 48 VDC
VOLTAGE PROTECTION RATING: 400 V
WIND LOADING: 150 MPH SUSTAINED (105.7 LBS)
WIND LOADING: 195 MPH GUST (213.6 LBS)

CONTRACTOR TO USE "THREAD LUBRICANT" ON MOUNTING BOLTS DURING INSTALLATION

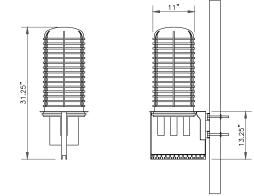

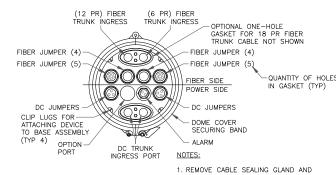

1. REMOVE CABLE SEALING GLAND AND INSTALL M32×1.5 METRIC-TO-1" NPT ADAPTER (COOPER CROUSE—HINES P/N CAP 740 994 OR EQUIVALENT MFR) WHEN CONNECTING CONDUIT TO OVP.

SQUID MOUNTING DETAIL 6) SCALE: NOT TO SCALE








AT&T SITE NUMBER: 61163

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131 MANOR ROAD GUILFORD, CT 06437

EXISTING 150'-0" MONOPOLE

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DATE	DRWN	DESCRIPTION	DES./QA							
03/10/2021	AM	CONSTRUCTION	AS							
		DATE DRWN	DATE DRWN DESCRIPTION							

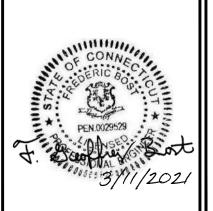


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SHEET NUMBER:

EMERSON N	NETSURE 721 DC P	OWER PLANT		
ITEM	WEIGHT/UNIT (LBS)	QTY	TOTAL WEIGHT (LBS)	
EMPTY RACK	500	1	500	
Rack+Rectifiers & Converters only	605.6	1	605.6	
Marathon M12V155FT Battery	119	0	0	
Marathon M12V180FT Battery	133	8	1064	
		TOTAL=	1669.6	LBS



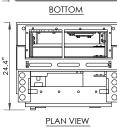


EQUIPMENT SPECIFICATIONS

MANUFACTURER: EMERSON/VERTIV
ATTM NUMBER: NEQ.17139
EMERSON NUMBER: 582127000ZZ011


HEIGHT: 84.0 IN WIDTH: 25 IN DEPTH: 23 IN

WEIGHT: SEE TABLE ABOVE

SAFETY COMPLIANCE: UL LISTED AND SEISMIC ZONE 4 COMPLIANT

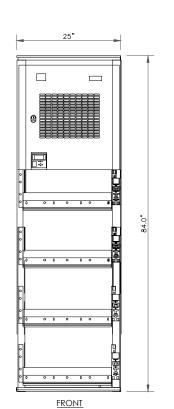

T EMERSON POWER PLANT SCALE: NOT TO SCALE

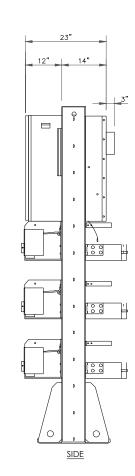

NOT USED

8 NOT USED SCALE: NOT TO SCALE

NOT USED
SCALE: NOT TO SCALE

NOT USED
SCALE: NOT TO SCALE

9 NOT USED
SCALE: NOT TO SCALE








AT&T SITE NUMBER: 61163

BU #: **806361** NHV 102 943127

131 MANOR ROAD GUILFORD, CT 06437


EXISTING 150'-0" MONOPOLE


_				_		
	ISSUED FOR:					
REV	DATE	DRWN	DESCRIPTION	DES./QA		
0	03/10/2021	AM	CONSTRUCTION	AS		

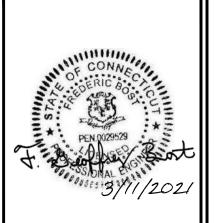

IT IS A VIOLATION OF LAW FOR ANY PERSON, UNLESS THEY ARE ACTING UNDER THE DIRECTION OF A LICENSED PROFESSIONAL ENGINEER, TO ALTER THIS DOCUMENT.

SHEET NUMBER:

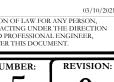


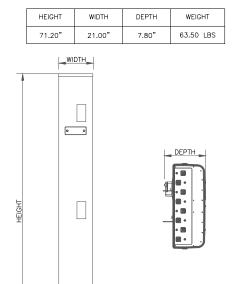

CCI - OPA65-BU6DA SCALE: NOT TO SCALE

0 0

HEIGHT	WIDTH	DEPTH	WEIGHT
71.20"	20.70"	7.70"	89.30 LBS

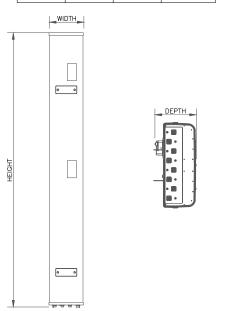


CCI - DMP65R-BU6D SCALE: NOT TO SCALE

HEIGHT

17.90"

HEIGHT	WIDTH	DEPTH	WEIGHT
16.50"	13.20"	7.70"	59.90 LBS

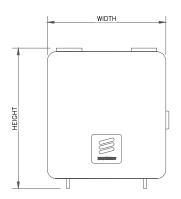

RADIO DETAIL: ERICSSON - 4478 B14 RADIO DETAIL. L....

SCALE: NOT TO SCALE








AT&T SITE NUMBER: 61163

BU #: **806361** NHV 102 943127

131 MANOR ROAD GUILFORD, CT 06437

EXISTING 150'-0" MONOPOLE


	ISSUED FOR:					
REV	DATE	DRWN	DESCRIPTION	DES./QA		
0	03/10/2021	AM	CONSTRUCTION	AS		

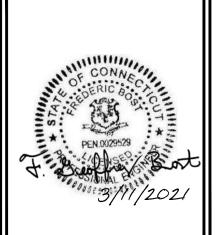


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SHEET NUMBER:

HEIGHT	WIDTH	DEPTH	WEIGHT
14.90"	13.20"	10.90"	72.00 LBS



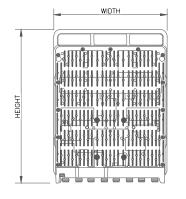

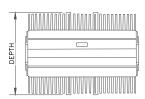SCALE: NOT TO SCALE

RADIO DETAIL: ERICSSON - 4449 B5/B12

WEIGHT

71.00 LBS

DEPTH


9.44"

WIDTH

13.19"

(6) SCALE: NOT TO SCALE

RADIO DETAIL: ERICSSON - 8843 B2/B66A 4) SCALE: NOT TO SCALE

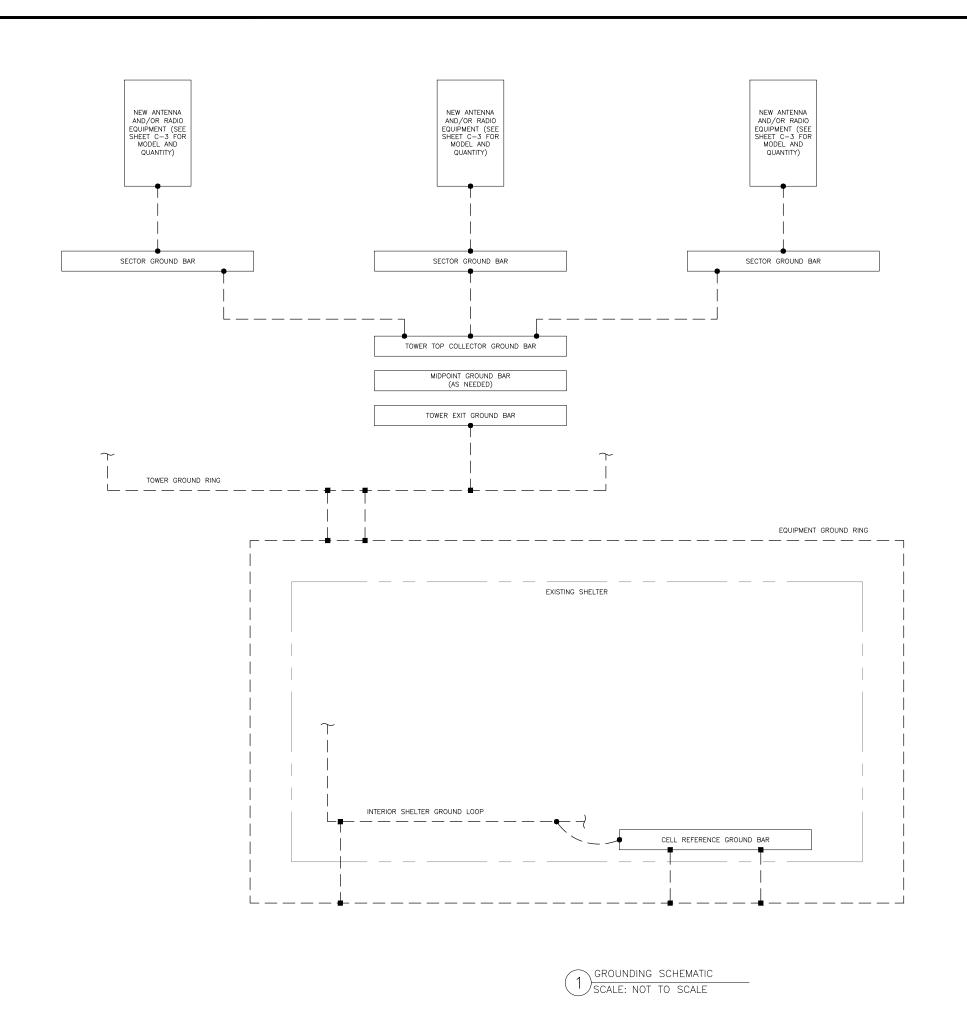

GROUNDING PLAN LEGEND:

--- GROUND WIRE

© COPPER GROUND ROD

■ EXOTHERMIC WELD

MECHANICAL CONNECTION

S GROUND ROD W/ TEST WELL

CELL REFERENCE GROUND BAR: POINT OF GROUND REFERENCE FOR ALL COMMUNICATIONS EQUIPMENT FRAMES. ALL BONDS ARE MADE WITH #2 STRANDED GREEN INSULATED COPPER CONDUCTORS. BOND TO GROUND RING WITH (2) #2 SOLID TINNED COPPER CONDUITS (ATT—TP—76416 7.6.7).

HATCH PLATE GROUND BAR: BOND TO THE INTERIOR GROUND RING WITH (2) #2 STRANDED GREEN INSULATED COPPER CONDUCTORS. WHEN A HATCH-PLATE AND A CELL REFERENCE GROUND BAR ARE BOTH PRESENT, THE CELL SITE REFERENCE GROUND BAR MUST BE CONNECTED TO THE HATCH-PLATE AND TO THE INTERIOR GROUND RING USING (2) #2 STRANDED GREEN INSULATED COPPER CONDUCTORS.

EXTERIOR CABLE ENTRY PORT GROUND BARS:
LOCATED AT THE ENTRANCE TO THE CELL SITE
BUILDING. BOND TO GROUND RING WITH A #2 SOLID
TINNED COPPER CONDUCTORS WITH AN EXOTHERMIC
WELD AND INSPECTION SLEEVE (ATT-TP-76416
7.6.7.2).

DURING ALL DC POWER SYSTEM CHANGES INCLUDING DC SYSTEM CHANGE OUTS, RECTIFIER REPLACEMENTS OR ADDITIONS, BREAKER DISTRIBUTION CHANGES, BATTERY ADDITIONS, BATTERY REPLACEMENTS AND INSTALLATIONS OR CHANGES TO DC CONVERTER SYSTEMS IT SHALL BE REQUIRED THAT SERVICES CONTRACTORS VERIFY ALL DC POWER SYSTEMS ARE EQUIPPED WITH MASTER DC SYSTEM RETURN GROUND CONDUCTOR FROM THE DC POWER SYSTEM COMMON RETURN BUS DIRECTLY CONNECTED TO THE CELL SITE REFERENCE GROUND BAR PER TP76300 SECTION H 6 AND TP76416 FIGURE 7-11 REQUIREMENTS.



1025 LENOX PARK BOULEVARD NE ATLANTA, GA 30319



FRANKLIN, TN 37067




AT&T SITE NUMBER: 61163

BU #: **806361 NHV 102 943127** 

131 MANOR ROAD GUILFORD, CT 06437

EXISTING 150'-0" MONOPOLE

	ISSUED FOR:				
REV	DATE	DRWN	DESCRIPTION	DES./QA	
0	03/10/2021	AM	CONSTRUCTION	AS	

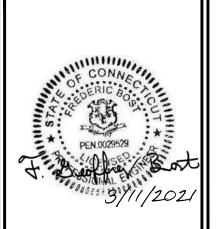


03/10/20

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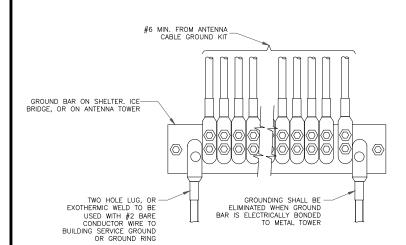
SHEET NUMBER:

G-1

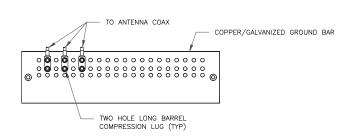


- DOUBLING UP "OR STACKING" OF CONNECTIONS IS NOT PERMITTED.
  EXTERIOR ANTIOXIDANT JOINT COMPOUND TO BE USED ON ALL EXTERIOR CONNECTIONS.
  GROUND BAR SHALL NOT BE ISOLATED FROM TOWER. MOUNT DIRECTLY TO ANTENNA MOUNT STEEL.

ANTENNA SECTOR GROUND BAR DETAIL SCALE: NOT TO SCALE




GROUNDWIRE INSTALLATION 4) SCALE: NOT TO SCALE

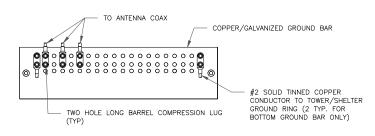


- EXTERIOR ANTIOXIDANT JOINT COMPOUND TO BE USED ON ALL EXTERIOR CONNECTIONS.
   GROUND BAR SHALL NOT BE ISOLATED FROM TOWER. MOUNT DIRECTLY TO TOWER STEEL (TOWER ONLY).
   GROUND BAR SHALL BE ISOLATED FROM BUILDING OR SHELTER.

TOWER/SHELTER GROUND BAR DETAIL (2) SCALE: NOT TO SCALE

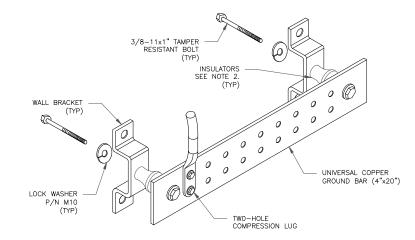


- 1. DOWN LEAD (HOME RUN) CONDUCTORS ARE <u>NOT</u> TO BE INSTALLED ON CROWN CASTLE USA INC. TOWER, PER THE GROUNDING DOWN CONDUCTOR POLICY QAS-STD-10091. NO MODIFICATION OR DRILLING TO TOWER STEEL IS ALLOWED IN ANY FORM OR FASHION, CAD-WELDING ON THE TOWER AND/OR IN THE AIR ARE NOT PERMITTED.
- 2. OMIT INSULATOR WHEN MOUNTING TO TOWER STEEL OR PLATFORM STEEL USE INSULATORS WHEN ATTACHING TO BUILDING OR SHELTERS.

GROUND BAR DETAIL <sup>2</sup> (5 SCALE: NOT TO SCALE

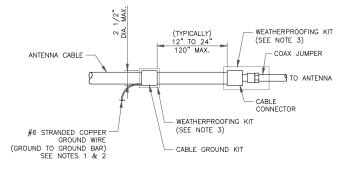


- DO NOT INSTALL CABLE GROUND KIT AT A BEND AND ALWAYS DIRECT GROUND WIRE DOWN TO GROUND BAR.
   GROUNDING KIT SHALL BE TYPE AND PART NUMBER AS SUPPLIED OR RECOMMENDED BY CABLE MANUFACTURER.
   WEATHER PROOFING SHALL BE TWO—PART TAPE KIT, COLD SHRINK SHALL NOT BE

CABLE GROUND KIT CONNECTION (6) SCALE: NOT TO SCALE

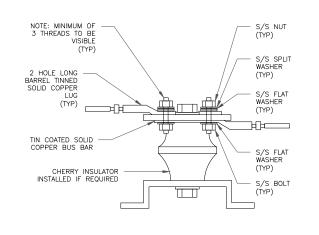



LUG DETAIL SCALE: NOT TO SCALE

WIRE SIZE BURNDY LUG BOLT SIZE #6 GREEN INSULATED YA6C-2TC38 3/8" - 16 NC SS 2 BOLT #2 SOLID TINNED YA3C-2TC38 3/8" - 16 NC SS 2 BOLT #2 STRANDED YA2C-2TC38 3/8" - 16 NC SS 2 BOLT #2/0 STRANDED YA26-2TC38 3/8" - 16 NC SS 2 BOLT #4/0 STRANDED YA28-2N 1/2" - 16 NC SS 2 BOLT

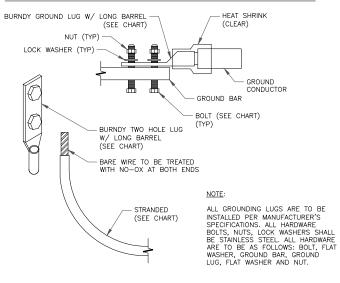


MECHANICAL LUG CONNECTION SCALE: NOT TO SCALE

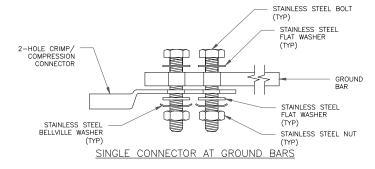

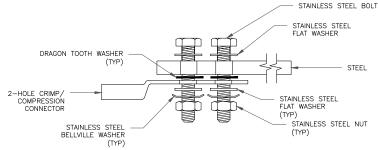

### SINGLE CONNECTOR AT STEEL OBJECTS

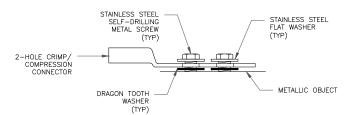

SINGLE CONNECTOR AT METALLIC/STEEL OBJECTS

HARDWARE DETAIL FOR EXTERIOR CONNECTIONS SCALE: NOT TO SCALE







AT&T SITE NUMBER: 61163

BU #: **806361** NHV 102 943127

131 MANOR ROAD GUILFORD, CT 06437

EXISTING 150'-0" MONOPOLE


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REV	DATE	DRWN	DESCRIPTION	DES./QA
0	03/10/2021	AM	CONSTRUCTION	AS



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SHEET NUMBER:

comments: Important Note: For detailed radio to antenna wiring refer to the latest field notice - Antenna Radio Connection Drawings Playbook v6.0 Ericsson



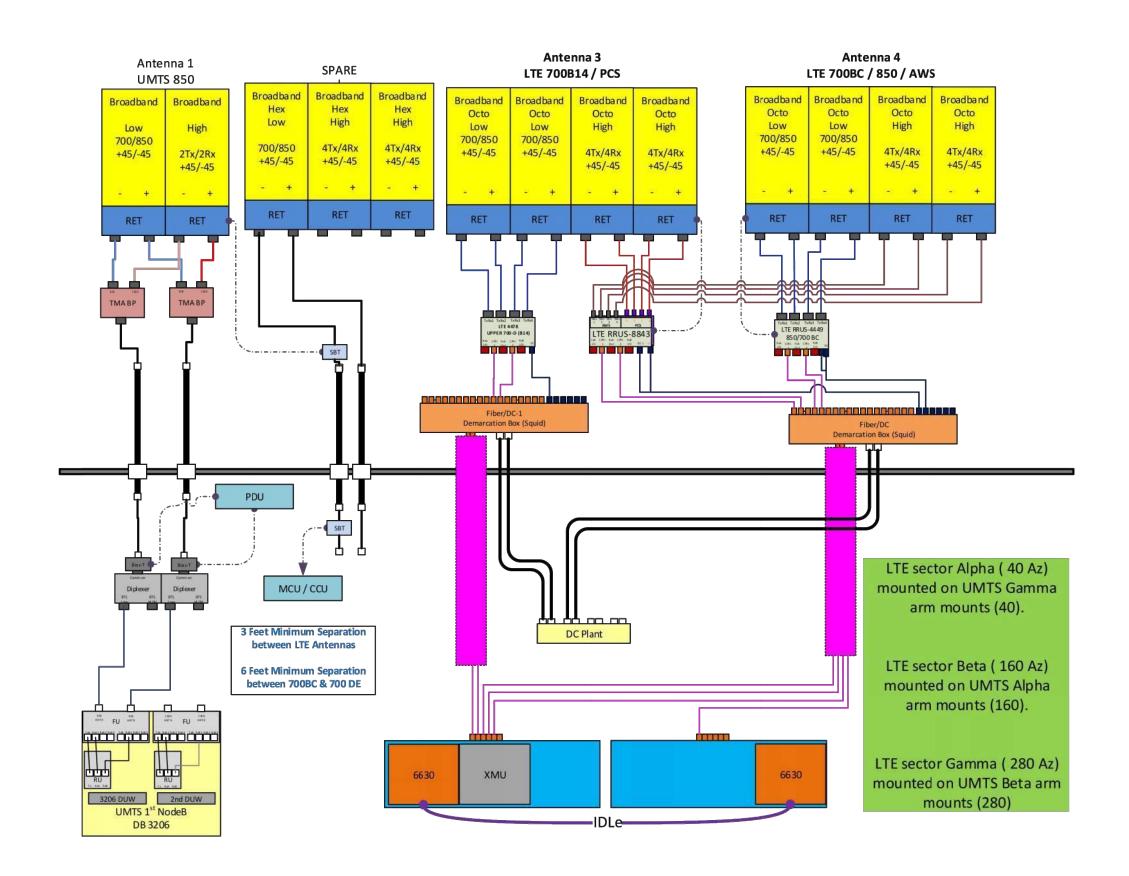

806361 NHV 102 943127 (10035042)

MODIFICATION DRAWING FOR AN EXISTING 13.5' PLATFORM W/ SUPPORT RAILS AT 138' ON A 150' MONOPOLE TOWER



### PROJECT INFORMATION

COUNTY:

SITE ADDRESS:


131 MANOR RD. GUILFORD, CT 06437

NEW HAVEN

LATITUDE: 41° 19' 48.09" LONGITUDE: -72° 43' 18.51'

### SCOPE OF WORK:

MOUNT MODIFICATION DRAWINGS INCLUDES: INSTALL PROPOSED SUPPORT RAILS, CORNER BRACES, STABILIZER KITS, & MOUNT PIPES.

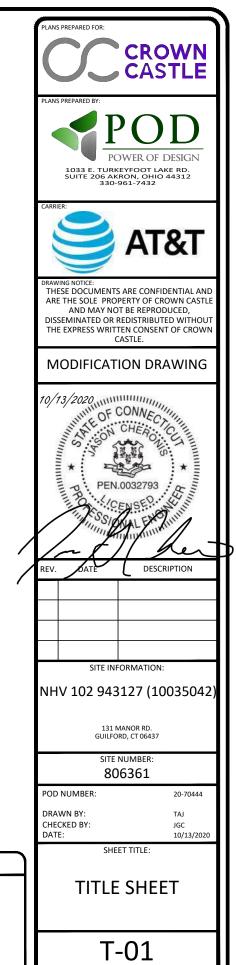

### GENERAL NOTES

THE MODIFICATIONS REPRESENTED IN THESE DRAWINGS ARE BASED ON THE STRUCTURAL DOCUMENTS
PROVIDED IN THE STRUCTURAL DOCUMENTS TABLE. THE CONTRACTOR SHALL OBTAIN AND BECOME
FAMILIAR WITH ALL REFERENCED DOCUMENTS.

REFERENCE DOCUMENTS		
DOCUMENT TYPE	DESIGNATION	
MOUNT ANALYSIS	POD PROJECT NUMBER: 20-70234 DATED: 10/02/2020	

 ALL MODIFICATIONS MUST BE INSTALLED TO BRING THE TOWER INTO CONFORMANCE WITH ALL APPLICABLE CODES.

GOVERNING CODES TIA-222-H

ULTIMATE WIND SPEED 122 MPH 3 SECOND GUST RADIAL ICE THICKNESS 1"

WIND SPEED W/ ICE 50 MPH 3 SECOND GUST

STRUCTURE CLASS II
EXPOSURE CATEGORY C

EXPOSURE CATEGORY C
TOPOGRAPHIC CATEGORY 1

SPECTRAL RESPONSE ACCELERATIONS SS= 0.206 & S1= 0.054


- 3. ALL WORK PRESENTED ON THESE DRAWINGS MUST BE COMPLETED BY THE CONTRACTOR UNLESS NOTED OTHERWISE OR APPROVED BY THE EOR. THE CONTRACTOR MUST HAVE CONSIDERABLE EXPERIENCE PERFORMING WORK SIMILAR TO THAT DESCRIBED WITHIN THESE DRAWINGS. BY ACCEPTANCE OF THIS PROJECT, THE CONTRACTOR IS ATTESTING THAT HE HAS SUFFICIENT EXPERIENCE AND ABILITY, THAT HE IS KNOWLEDGEABLE OF THE WORK TO BE PERFORMED AND THAT HE IS PROPERLY LICENSED AND REGISTERED TO PERFORM THE WORK IN THE PROJECT JURISDICTION.
- 4. WORK SHALL ONLY BE PERFORMED DURING CALM, DRY DAYS (WINDS LESS THAN 10XMPH). IT IS THE CONTRACTOR'S SOLE RESPONSIBILITY TO DETERMINE INSTILLATION PROCEDURE AND SEQUENCE TO INSURE THE SAFETY OF THE STRUCTURE AND ITS COMPONENT PARTS DURING ERECTION AND/OR MODIFICATIONS. THIS INCLUDES, BUT IS NOT LIMITED TO, THE ADDITION OF TEMPORARY BRACING, GUYS OR TIEXDOWNS THAT MAY BE NECESSARY. SUCH MATERIAL SHALL BE REMOVED AND SHALL REMAIN THE PROPERTY OF THE CONTRACTOR AFTER THE COMPLETION OF THE PROJECT.
- 5. ALL DIMENSIONS, ELEVATIONS AND EXISTING CONDITIONS SHOWN ON THE DRAWINGS SHALL BE FIELD VERIFIED BY THE CONTRACTOR PRIOR TO BEGINNING ANY MATERIALS ORDERING, FABRICATION OR CONSTRUCTION WORK ON THIS PROJECT. CONTRACTOR SHALL NOT SCALE CONTRACT DRAWINGS IN LIEU OF FIELD VERIFICATIONS. ANY DISCREPANCIES SHALL BE IMMEDIATELY BROUGHT TO THE ATTENTION OF THE OWNER AND EOR. THE DISCREPANCIES MUST BE RESOLVED BEFORE THE CONTRACTOR IS TO PROCEED WITH THE WORK. THE CONTRACT DOCUMENTS DO NOT INDICATE THE METHODS OF CONSTRUCTION. THE CONTRACTOR SHALL SUPERVISE AND DIRECT THE WORK AND IS SOLELY RESPONSIBLE FOR ALL CONSTRUCTION MEANS, METHODS, TECHNIQUES, SEQUENCES AND PROCEDURES. OBSERVATION VISITS TO THE SITE BY THE OWNER AND/OR THE EOR SHALL NOT INCLUDE INSPECTION OF THE PROTECTIVE MEASURES AND PROCEDURES.
- 6. THE DESIGN WITHIN THESE DRAWINGS ASSUMES THE TOWER AND ITS FOUNDATIONS HAVE BEEN WELL MAINTAINED, IN GOOD CONDITION AND ARE WITHOUT DEFECT. BENT MEMBERS, CORRODED MEMBER, LOOSE BOLTS, CRACKED WELDS, AND OTHER STRUCTURAL DEFECTS HAVE NOT BEEN CONSIDERED UNLESS SPECIFICALLY NOTED. THE TOWER IS ASSUMED TO BE PLUMB AND THE SITE IS ASSUMED LEVEL. THE OWNER AND/OR FOR SHALL BE NOTIFIED IMMEDIATELY IF ANY VARIANCES ARE FOUND.
- 7. THE CONTRACTOR SHALL ONLY WORK WITHIN THE LIMITS OF THE TOWER OWNER'S PROPERTY, LEASE AREA OR APPROVED EASEMENTS. IT IS THE RESPONSIBILITY OF THE CONTRACTOR TO VERIFY WORK IS PERFORMED WITHIN THESE BOUNDARIES. CONSTRUCTION STAKING AND BOUNDARY MARKING IS THE RESPONSIBILITY OF THE CONTRACTOR. THE CONTRACTOR SHALL EMPLOY A SURVEYOR AS REQUIRED. ANY WORK OUTSIDE THESE BOUNDARIES SHALL BE APPROVED IN WRITING BY THE OWNER.
- THE CONTRACTOR SHALL BE RESPONSIBLE FOR INITIATING, MAINTAIN AND SUPERVISING ALL SAFETY
  PRECAUTIONS AND PROGRAMS IN CONNECTION WITH THE WORK. THE CONTRACTOR IS RESPONSIBLE FOR
  INSURING THAT ALL WORK PERFORMED COMPLIES WITH ALL APPLICATION SAFETY CODES AND
  GOVERNING REGULATIONS.
- ACCESS TO THE PROPOSED WORK SITE MAY BE RESTRICTED. THE CONTRACTOR SHALL COORDINATE
   INTENDED CONSTRUCTION ACTIVITY, INCLUDING WORK SCHEDULES AND MATERIAL DELIVERIES, WITH THE
   OWNER/RESIDENT LEASING AGENT FOR APPROVAL.
- THE CONTRACTOR SHALL SECURE ALL NECESSARY PERMITS FOR THIS PROJECT FROM ALL APPLICABLE GOVERNING AGENCIES. THE CONTRACTOR WILL BE RESPONSIBLE FOR ABIDING BY ALL CONDITIONS AND REQUIREMENTS OF THE PERMITS
- 11. ALL MATERIAL UTILIZED FOR THIS PROJECT MUST BE NEW AND FREE OF ANY DEFECTS. ANY MATERIAL SUBSTITUTIONS, INCLUDED BUT NOT LIMITED TO ALTERED SIZED AND/OR STRENGTHS, MUST BE ADDROVED BY THE FOR
- 12. UNLESS NOTED OTHERWISE, ALL NEW MEMBERS SHALL MAINTAIN THE EXISTING MEMBER WORKING LINES AND NOT INTRODUCE ECCENTRICITIES INTO THE STRUCTURE.
- ALL DIMENSIONS AND QUANTITIES LISTED WITHIN THESE DRAWINGS ARE INTENDED TO AID THE CONTRACTOR. THE CONTRACTOR SHALL VERIFY ALL DIMENSION AND QUANTITIES PRIOR TO BIDDING AND/OR ORDERING MATERIALS.
- 14. ALL MANUFACTURERS' INSTRUCTIONS SHALL BE FOLLOWED EXACTLY. ANY DEVIATION REQUIRES WRITTEN APPROVAL FROM THE EOR.
- 15. THE CONTRACTOR IS RESPONSIBLE FOR TEMPORARILY REMOVING COAX, BRACKETS, ANTENNAS MOUNTS AND ANY OTHER TOWER APPURTENANCE THAT MAY INTERFERE WITH THE INSTILLATION OF THE TOWER MODIFICATIONS. ALL TOWER APPURTENANCES MUST BE REPLACE AND/OR RESTORED TO ITS ORIGINAL LOCATION. SOME MOUNTS OR ATTACHMENTS MAY REQUIRE CUSTOM MODIFICATION TO PROPERLY FIT THE MODIFIED REGION OF THE STRUCTURE. THESE CUSTOM MOUNTS OR ATTACHMENTS ARE DESIGNED BY OTHERS AND MUST BE APPROVED BY THE OWNER/EOR PRIOR TO REMOVAL. ANY CARRIER DOWNTIME MUST BE COORDINATED WITH THE OWNER IN WRITING.
- 16. DO NOT SCALE DRAWINGS.

### STRUCTURAL STEEL NOTES

- ALL DETAILING, FABRICATION AND ERECTION OF STRUCTURAL STEEL SHALL CONFORM TO THE AISC SPECIFICATIONS, LATEST EDITION.
- ALL STRUCTURAL STEEL ELEMENTS SHALL CONFORM TO THE FOLLOWING REQUIREMENTS.


MATERIAL SPECIFICATIONS				
ANGLES	ASTM A36 (36 KSI YIELD STRENGTH)			
PIPES	ASTM A53 GR.B (35 KSI YIELD STRENGTH)			
BOLTS	ASTM A325N			
NUTS	ASTM A563			
WASHER	ASTM F436			
PLATE	ASTM A36 (36 KSI YIELD STRENGTH)			
U-BOLTS	ASTM A307			

- ALL CONNECTIONS NOT FULLY DETAILED ON THESE PLANS SHALL BE DETAILED BY THE FABRICATOR IN ACCORDANCE WITH AISC SPECIFICATIONS, LATEST EDITION.
- 4. CAULKING SHALL BE PROVIDED AROUND PERIMETER OF ANY AND ALL MODIFICATION MEMBERS TO ENSURE COMPLETE SEAL BETWEEN EXISTING STRUCTURE AND REINFORCING MEMBERS IN FULL CONTACT WITH EXISTING STEEL. SEALANT IS TO BE EXTERIOR GRADE, PAINTABLE SILICONE CAULKING AS MANUFACTURED BY DOW AND ACCEPTABLE TO EOR.
- HOLES SHALL NOT BE FLAME CUT THROUGH STEEL UNLESS APPROVED BY THE EOR
- 5. ALL EXPOSED STEEL SHALL BE HOTXDIPPED GALVANIZED PER ASTM A123, ASTM A153/A153M, OR ASTM A653 G90, AS APPLICABLE FOR FULL WEATHER PROTECTION. FOR HIGH STRENGTH STEEL FASTENERS WHERE HOTXDIPPED GALVANIZING IS NOT PERMITTED DACROMET F1136 GRADE 3 COATING SHALL BE USED. IN ADDITION ALL NEW STEEL SHALL BE PAINTED TO MATCH EXISTING TOWER STEEL. CONTRACTOR SHALL OBTAIN EOR APPROVAL FOR STEEL PROTECTION BY ANY OTHER MEANS.
- REPAIR DAMAGED PAINTED/GALVANIZED SURFACES WITH TWO COATS OF BRUSH OR ROLL ON ZRC COLD
  GALVANIZING COMPOUND OR EOR APPROVED COATING. SURFACES MUST BE WIRE BRUSHED AND
  SOLVENT CLEANED PRIOR TO APPLICATION OF GALVANIZING COMPOUND.
- ALL BOLT ASSEMBLIES FOR STRUCTURAL MEMBERS REPRESENTED IN THIS DRAWING REQUIRE LOCKING DEVICES (LOCKING NUT/PAL NUT) TO BE INSTALLED IN ACCORDANCE WITH TIA/EIAX222 REQUIREMENTS.
- ALL PROPOSED AND/OR REPLACED BOLTS SHALL BE OF SUFFICIENT LENGTH SUCH THAT THE END OF THE BOLT BE AT LEAST FLUSH WITH THE FACE OF THE NUT. IT IS NOT PERMITTED FOR THE BOLT END TO BE BELOW THE FACE OF THE NUT AFTER TIGHTENING IS COMPLETED.

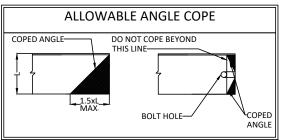

- ALL DIMENSIONS REPRESENTED IN THE ABOVE TABLES ARE AISC MINIMUM REQUIREMENTS. CONTRACTOR SHALL VERIFY EXISTING CONDITIONS IN FIELD AND NOTIFY ENGINEER IF DISTANCES ARE LESS THAN THOSE PROVIDED.
- THE DIMENSIONS PROVIDED ARE MINIMUM REQUIREMENTS. ACTUAL DIMENSIONS OF PROPOSED MEMBERS WITHIN THESE DRAWINGS MAY VARY FROM THE AISC MINIMUM REQUIREMENT

	BOLT SCHEDULE						
BOLT DIAMETER	STANDARD HOLE	SHORT SLOT	MIN. EDGE DISTANCE	SPACING			
1/2	9/16	9/16x11/16	7/8	1-1/2			
5/8	11/16	11/16x7/8	1-1/8	1-7/8			
3/4	13/16	13/16x1	1-1/4	2-1/4			
7/8	15/16	15/16x1-1/8	1-1/2	2-5/8			
1	1-1/16	1-1/16x1-5/16	1-3/4	3			
	<del>-</del> SPACING <del>+ </del>						

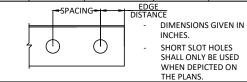

	WORK	ABLE GAGES	
LEG	2-1/2		
G	1-3/8		
	,,D,	INCHES	EXISTING WHEN

MODIFICACEC






1033 E. TURKEYFOOT LAKE RD. SUITE 206 AKRON, OHIO 44312 330-961-7432



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AND MAY NOT BE REPRODUCED,
DISSEMINATED OR REDISTRIBUTED WITHOUT
THE EXPRESS WRITTEN CONSENT OF CROWN

### CASTLE. MODIFICATION DRAWING

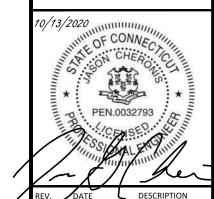

SITE INFORMATION:					
	NHV 10	02 943127			
	(100	35042)			
	(=00				

SITE NUMBER: 806361

POD NUMBER: 20-70444

DRAWN BY: TAJ

CHECKED BY: JGC

DATE: 10/13/202


SHEET TITLE:

NOTES

N-01

- ANTENNAE & GRATING NOT SHOWN FOR CLARITY

  ALL FIELD DRILLED HOLES SHALL BE SOLVENT CLEANED AND TOUCHED UP WITH TWO COATS OF ZRC RICH PAINT EXCESS MATERIALS SHALL BE REMOVED AND DISPOSED OFF SITE BY THE CONTRACTOR

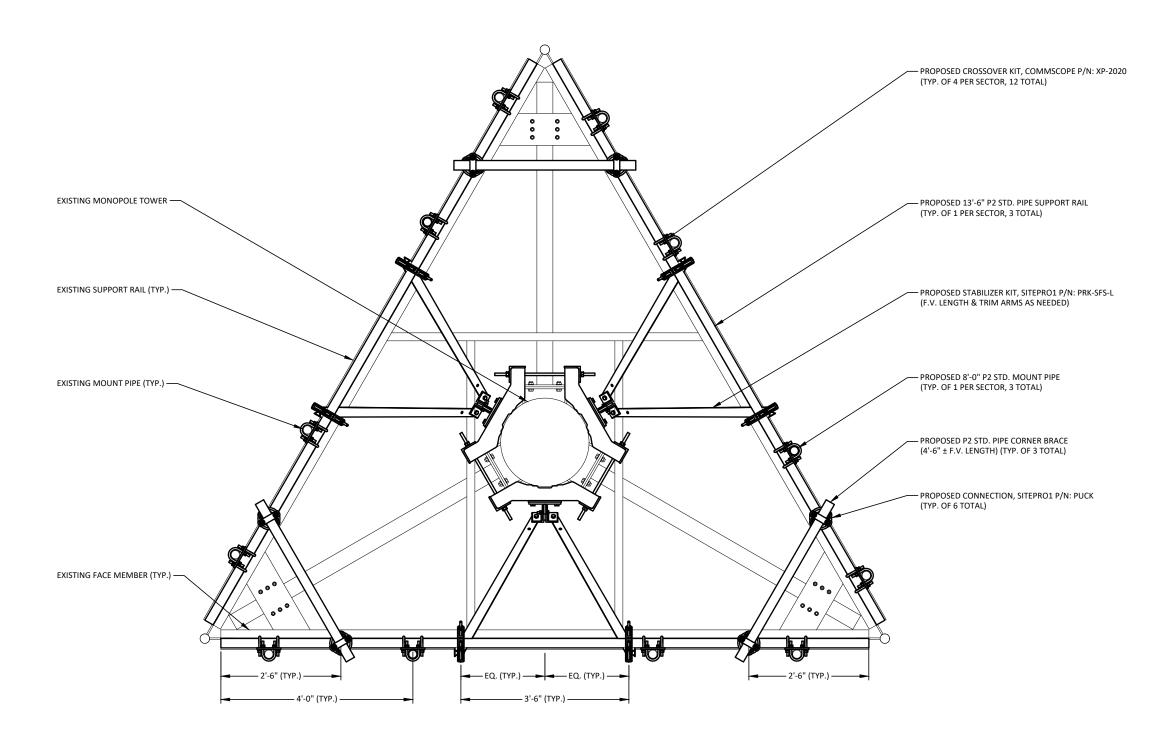


PLAN VIEW

1/2" = 1'-0"



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CASTLE.

### MODIFICATION DRAWING

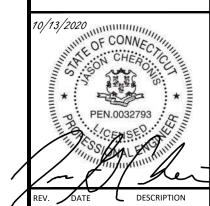

SITE INFORMATION: NHV 102 943127 (10035042)

131 MANOR RD. GUILFORD, CT 06437

SITE NUMBER: 806361


POD NUMBER: 20-70444

DRAWN BY: TAJ CHECKED BY: DATE: JGC 10/13/2020

SHEET TITLE:

**PLAN VIEW** 

S-01

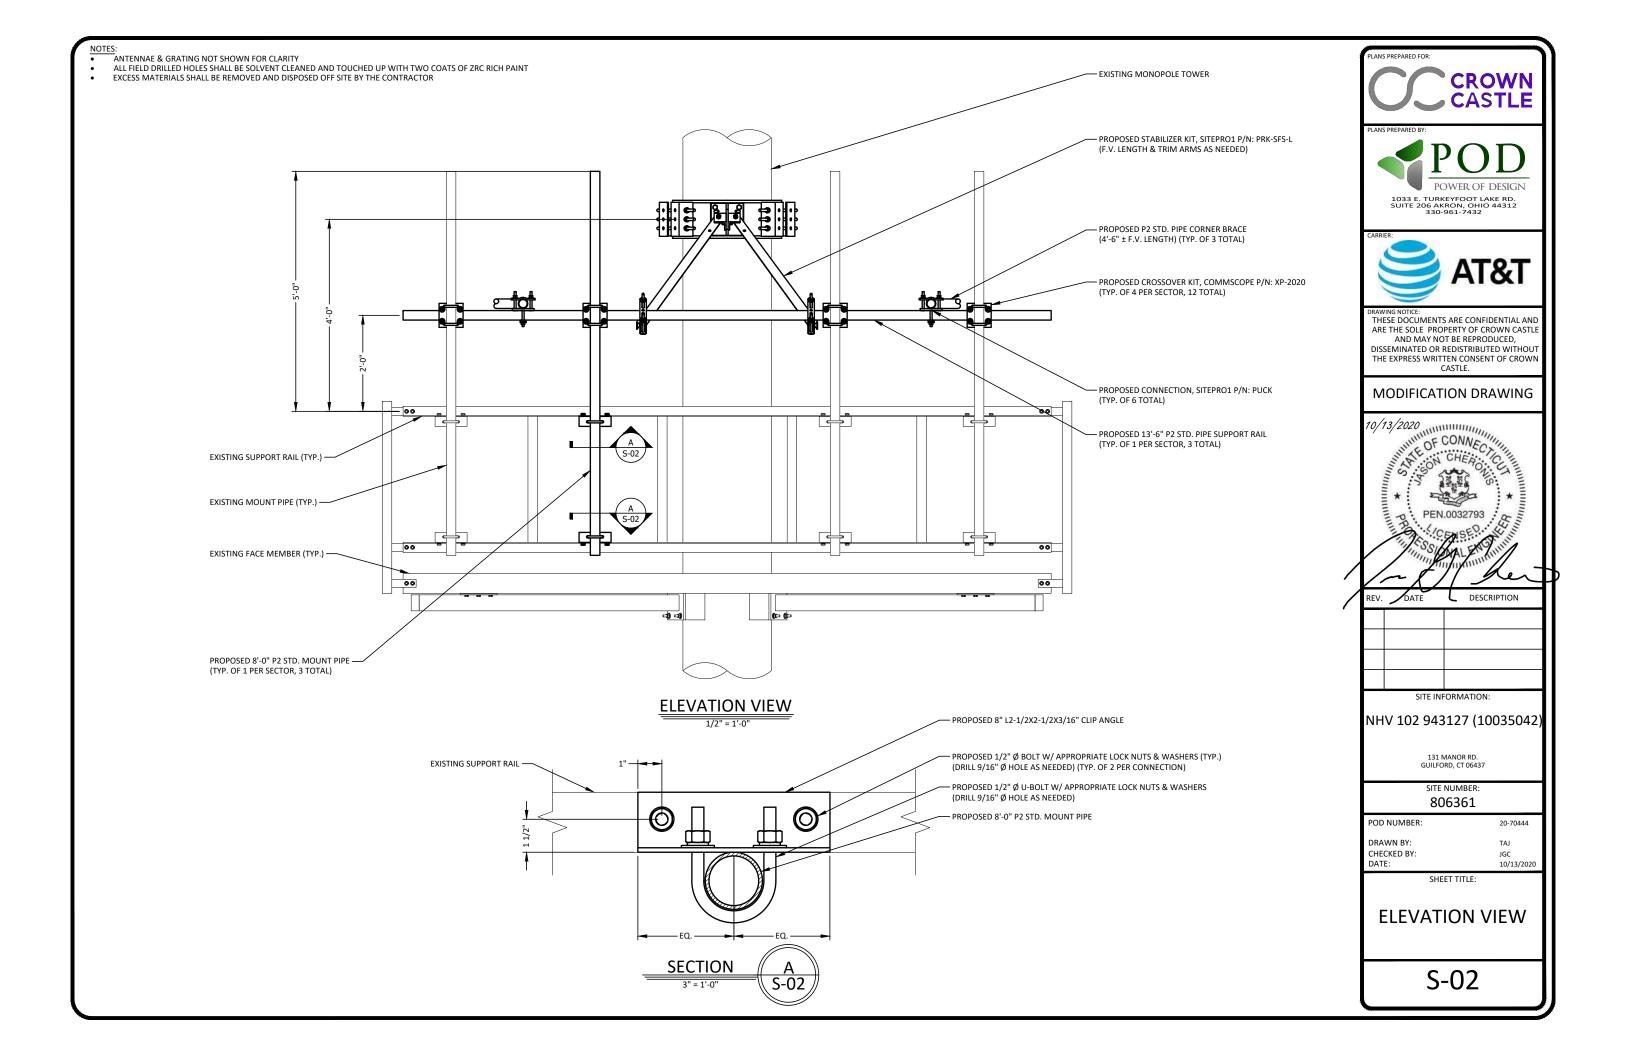

### MODIFICATION INSPECTION CHECKLIST

BEFORE CONSTRUCTION		DURING CONSTRUCTION		
CONSTRUCTION/INSTALLATION INSPECTION AND TESTING REQUIRED (COMPLETED BY ENGINEER OF RECORD)	REPORT ITEM	CONSTRUCTION/INSTALLATION INSPECTION AND TESTING REQUIRED (COMPLETED BY ENGINEER OF RECORD)	REPORT ITEM	
х	MODIFICATION INSPECTION CHECKLIST DWG	х	CONSTRUCTION INSPECTION	Ī
-	ENGINEER OF RECORD APPROVED SHOP DRAWINGS	-	FOUNDATION INSPECTION	Ī
-	FABRICATION INSPECTION	-	CONCRETE COMP. STRENGTH AND SLUMP TEST	Ī
х	MATERIAL TEST REPORT	-	POST INSTALLED ANCHOR ROD VERIFICATION	
-	FABRICATOR NDE INSPECTION	-	BASE PLATE GROUT VERIFICATION	
-	NDE REPORT OF MONOPOLE BASEPLATE (AS REQUIRED )	-	THIRD PARTY CERTIFIED WELD INSPECTION	
х	PACKING SLIP	-	EARTHWORK LIFT AND DENSITY (REPORT REQUIRED)	
ADDITIONAL TESTING AND INSPECTION		x	ON SITE COLD GALVANIZING VERIFICATION	
		-	GUY WIRE TENSION REPORT	
		х	GC AS-BUILT DOCUMENTS	
		ADDITIONAL TESTING AND INSPECTION		

### MODIFICATION INSPECTION NOTES:

### GENERAL:

- 1. THE MODIFICATION INSPECTION IS A VISUAL INSPECTION OF TOWER MODIFICATION AND A REVIEW OF CONSTRUCTION INSPECTION AND OTHER REPORTS TO ENSURE THE INSTALLATION WAS CONSTRUCTED IN ACCORDANCE WITH THE CONTRACT DOCUMENTS. NAMELY THE MODIFICATION DRAWINGS., AS
- 2. THE MODIFICATION INSPECTION IS TO CONFIRM INSTALLATION CONFIGURATION AND WORKMANSHIP ONLY AN IS NOT A REVIEW OF THE MODIFICATION DESIGN ITSELF. NOR DOES THE MODIFICATION INSPECTOR TAKE OWNERSHIP OF THE MODIFICATION DESIGN. OWNERSHIP OF THE STRUCTURAL MODIFICATION DESIGN EFFECTIVENESS AND INTENT RESIDES WITH THE ENGINEER OF RECORD AT ALL
- TO ENSURE THAT THE REQUIREMENT OF THE MODIFICATION INSPECTION ARE MET, IT IS VITAL THAT THE GENERAL CONTRACTOR (GC) AND THE MODIFICATION INSPECTOR BEGIN COMMUNICATION AND COORDINATING AS SOON AS A PO OR PAYMENT IS RECEIVED. IT IS EXPECTED THAT EACH PARTY WILL BE PROACTIVE IN REACHING OUT TO THE OTHER PARTY.

### MODIFICATION INSPECTOR:

- THE MODIFICATION INSPECTOR IS REQUIRED TO CONTACT THE GC AS SOON AS RECEIVING A PO OR PAYMENT FOR THE MODIFICATION INSPECTION TO:
- REVIEW THE REQUIREMENT OF THE MODIFICATION INSPECTION CHECKLIST
- WORK WITH THE GC TO DEVELOP A SCHEDULE TO CONDUCT ON-SITE
- DISCUSS ANY SITE SPECIFIC INSPECTIONS OR CONCERNS
- THE MODIFICATION INSPECTOR IS RESPONSIBLE FOR COLLECTING ALL GENERAL CONTRACTOR (GC) INSPECTION AND TEST REPORTS. REVIEWING THE DOCUMENTS FOR ADHERENCE TO THE CONTRACT DOCUMENTS. CONDUCTING THE INXFEILD INSPECTIONS, AND SUBMITTING THE MODIFICATION INSPECTION REPORT.

### GENERAL CONTRACTOR:

THE GC IS REQUIRED TO CONTACT THE MODIFICATION INSPECTOR AS SOON AS RECEIVING A PO OR PAYMENT FOR THE MODIFICATION INSTALLATION OR TURNKEY PROJECT TO:

- REVIEW THE REQUIREMENT OF THE MODIFICATION INSPECTION CHECKLIST
- WORK WITH THE MI INSPECTOR TO DEVELOP A SCHEDULE TO CONDUCT ON-SITE MODIFICATION INSPECTIONS, INCLUDING FOUNDATION INSPECTIONS
- BETTER UNDERSTAND ALL INSPECTION AND TESTING REQUIREMENTS
- THE GC SHALL PERFORM AND RECORD THE TEST AND INSPECTION RESULTS IN ACCORDANCE WITH THE REQUIREMENTS OF THE MODIFICATION INSPECTION

### RECOMMENDATIONS:

- IT IS SUGGESTED THAT THE GC PROVIDE A MINIMUM OF 5 BUSINESS DAYS NOTICE, TO THE MODIFICATION INSPECTOR AS TO WHEN THE SITE WILL BE READY FOR HE MODIFICATION INSPECTION TO BE CONDUCTED.
- THE GC AND MODIFICATION INSPECTION COORDINATE CLOSELY THROUGHOUT
- WHEN POSSIBLE IT IS PREFERRED TO HAVE THE MODIFICATION INSPECTOR AND GC ON-SITE SIMULTANEOUSLY FOR ANY GUY WIRE TENSIONING OR REXTENSIONING OPERATIONS.
- IT MAY BE BENEFICIAL TO INSTALL ALL TOWER MODIFICATIONS PRIOR TO CONDUCTING THE FOUNDATION INSPECTION TO ALLOW FOUNDATION AND MODIFICATION INSPECTION(S) DONE IN ONE SITE VISIT.
- WHEN POSSIBLE, IT IS PREFERRED TO HAVE THE GC AND MODIFICATION INSPECTOR ON-SITE DURING THE MODIFICATION INSPECTION. THEREFORE, THE GC MAY CHOOSE TO COORDINATE THE MODIFICATION INSPECTION CAREFULLY TO ENSURE ALL CONSTRUCTION FACILITIES AT THEIR DISPOSAL WHEN THE MI INSPECTOR IS ON SITE.

### CANCELLATION OR DELAYS IN SCHEDULED MODIFICATION INSPECTION:

IF THE GC AND MODIFICATION INSPECTOR AGREE TO A DATE ON WHICH THE MODIFICATION INSPECTION WILL BE CONDUCTED, AND EITHER ARTY CANCELS OR DELAYS, THE TOWER OWNER SHALL NOT BE RESPONSIBLE FOR ANY COSTS, FEES, LOSS OR DEPOSITS AND/OR OTHER PENALTIES RELATE TO THE CANCELLATION OR DELAY INCURRED BY EITHER PARTY FOR ANY TIME. EXCEPTIONS MAY BE MADE IN THE DELAY/ CANCELLATION IS CAUSED BY WEATHER OR OTHER CONDITIONS THAT MAY COMPROMISE THE SAFETY OF THE PARTIES INVOLVED.

### CORRECTION OF FAILING MODIFICATION INSPECTION:

1. IF THE MODIFICATION INSTALLATION WOULD FAIL THE MODIFICATION

INSPECTION ("FAILED MODIFICATION INSPECTION"), THE GC SHALL WORK WITH MODIFICATION INSPECTOR TO COORDINATE A REMEDIATION PLAN IN ONE OF

CORRECT FAILING ISSUES TO COMPLY WITH THE SPECIFICATIONS CONTAINED IN THE ORIGINAL CONTRACT DOCUMENTS AND COORDINATE A SUPPLEMENT MODIFICATION INSPECTION. OR, WITH TOWER OWNER'S APPROVAL, THE GC MAY WORK WITH THE ENGINEER OF RECORD TO REXANALYZE THE MODIFCATION/REINFORCEMENT USING AS-BUILT CONDITION.

### **VERIFICATION INSPECTIONS:**

AFTER CONSTRUCTION

REPORT ITEM

RECORD DRAWING(S)

**PHOTOGRAPHS** 

MODIFICATION INSPECTOR REDLINE OR

POST INSTALLED ANCHOR ROD PULL-OUT

CONSTRUCTION/INSTALLATION INSPECTION AND TESTING REQUIRED (COMPLETED BY

ADDITIONAL TESTING AND INSPECTION

ENGINEER OF RECORD)

- TOWER OWNER RESERVES THE RIGHT TO CONDUCT A VERIFICATION INSPECTION TO VERIFY THE ACCURACY AND COMPLETENESS OF PREVIOUSLY COMPLETED MODIFICATION AND INSPECTION(S) ON TOWER MODIFICATION PRODUCTS.
- VERIFICATION INSPECTION MAY BE CONDUCTED BY AN INDEPENDENT FIRM AFTER A MODIFICATION PROJECT IS COMPLETED, AS MARKED BY THE DATE OF AN ACCEPTED "PASSING MODIFICATION INSPECTION MODIFICATION INSPECTION" REPORT FOR THE ORIGINAL PROJECT.

- BETWEEN THE GC AND THE MI INSPECTOR THE FOLLOWING PHOTOGRAPHS ARE TO BE TAKEN AND INCLUDED IN THE MODIFICATION INSPECTION REPORT:
- PREXCONSTRUCTION GENERAL SITE CONDITION
- PHOTOGRAPHS DURING THE REINFORCEMENT MODIFICATION CONSTRUCTION/ERECTION AND INSPECTION
- •• RAW MATERIALS
  •• PHOTOS OF ALL CRITICAL DETAILS
- •• WELD PREPARATION
- FOUNDATION MODIFICATION
- •• BOLT INSTALLATION AND TORQUE
  •• FINAL INSTALLED CONDITION
- •• SURFACE COATING REPAIR
- POST CONDITION PHOTOGRAPHS
- FINAL INFIELD CONDITION ANY OTHER PHOTOS DEEMED RELEVANT TO SHOW COMPLETE DENTALS OF MODIFICATIONS
- 2. PHOTOS OF ELEVATED MODIFICATIONS TAKEN FROM THE GROUND SHALL BE




1033 E. TURKEYFOOT LAKE RD



SUITE 206 AKRON, OHIO 44312 330-961-7432

THESE DOCUMENTS ARE CONFIDENTIAL AN ARE THE SOLE PROPERTY OF CROWN CASTL AND MAY NOT BE REPRODUCED, DISSEMINATED OR REDISTRIBUTED WITHOUT THE EXPRESS WRITTEN CONSENT OF CROWN CASTLE.

### MODIFICATION DRAWING

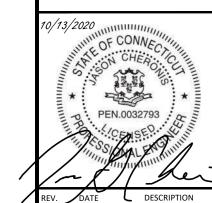

SITE INFORMATION

NHV 102 943127 (10035042)

GUILFORD, CT 06437

806361

POD NUMBER 20-70444

CHECKED BY DATE: SHEET TITLE:


**MODIFICATION** 

TAI

10/13/202

**CHECKLIST** 

MI-01

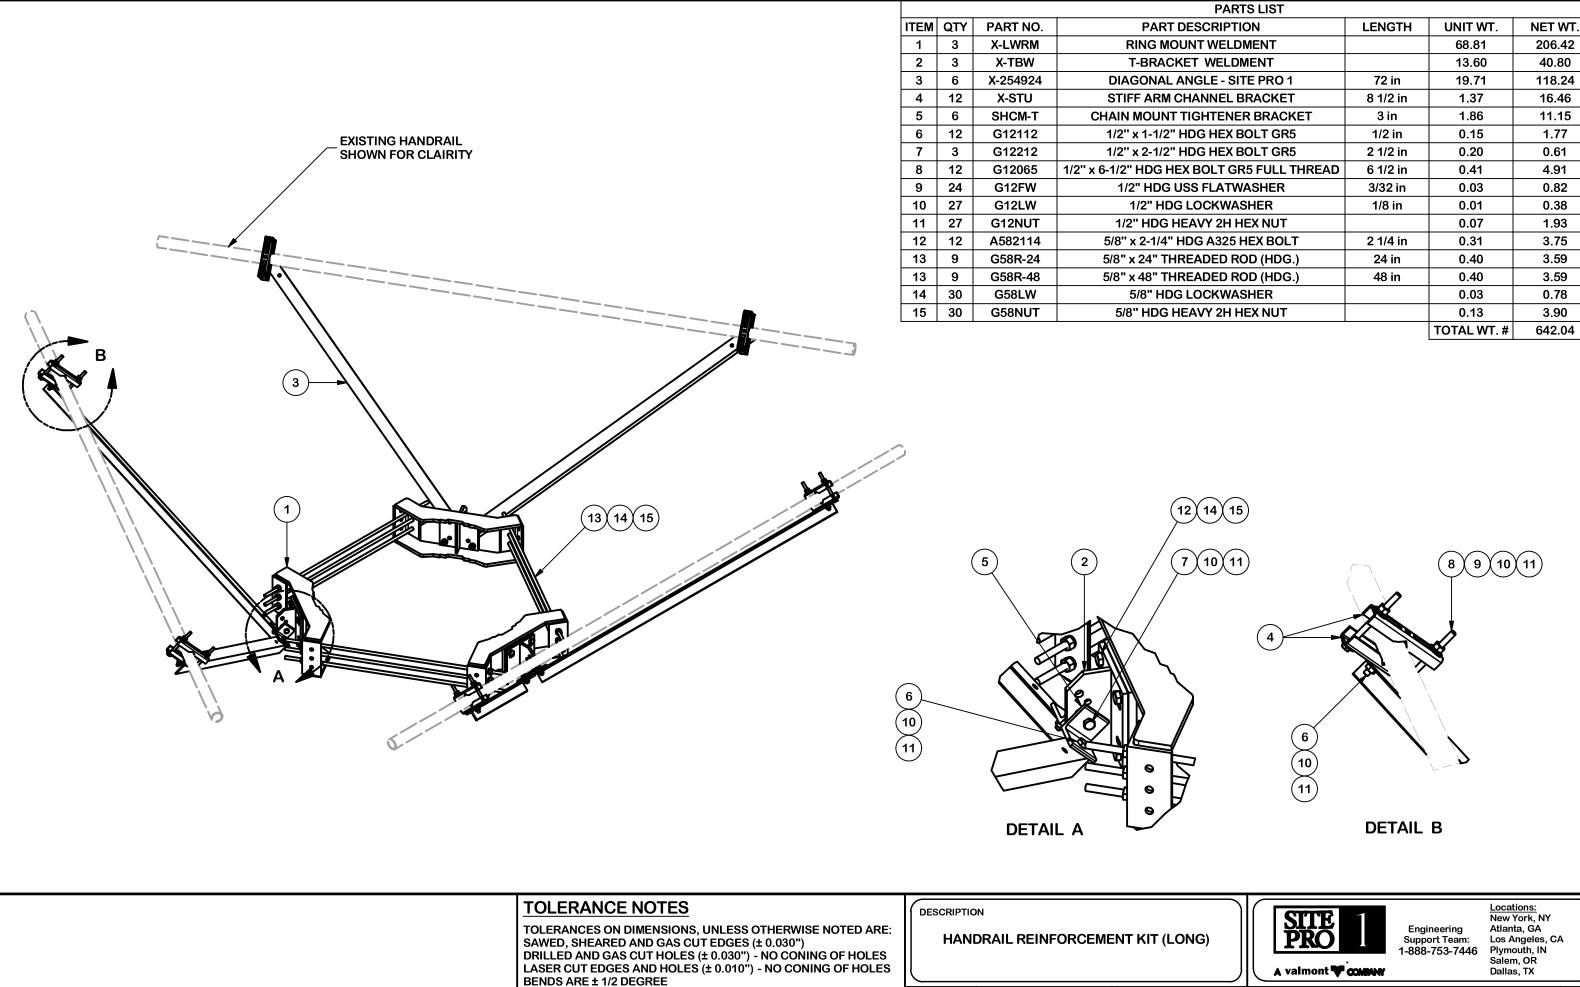

A CHANGED MAX. DIA. FOR HANDRAIL CONNECTION SP1 BC 10/25/2017 **DESCRIPTION OF REVISIONS** REV CPD BY DATE **REVISION HISTORY** 


PROPRIETARY NOTE:
THE DATA AND TECHNIQUES CONTAINED IN THIS DRAWING ARE PROPRIETARY INFORMATION OF VALMONT
INDUSTRIES AND CONSIDERED A TRADE SECRET. ANY USE OR DISCLOSURE WITHOUT THE CONSENT OF

ALL OTHER MACHINING (± 0.030") ALL OTHER ASSEMBLY (± 0.060")


CPD NO. DRAWN BY ENG. APPROVAL SP1 CSL3 2/23/2017 **3RD PARTY** DRAWING USAGE **CHECKED BY** CLASS SUB 81 02 **SHOP BMC** 9/8/2017

PRK-SFS-L DWG. NO.

**PRK-SFS-L** 

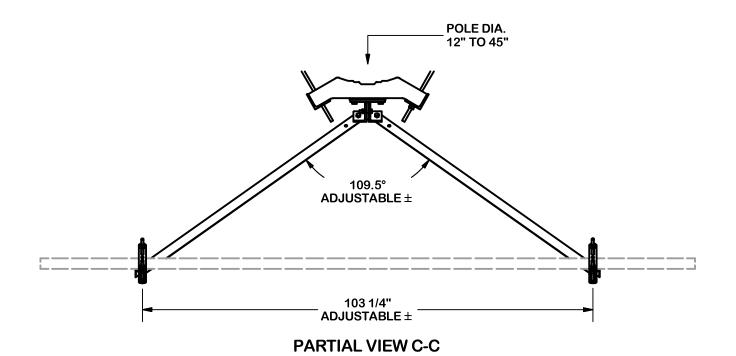

**VERTICAL POSITION** 

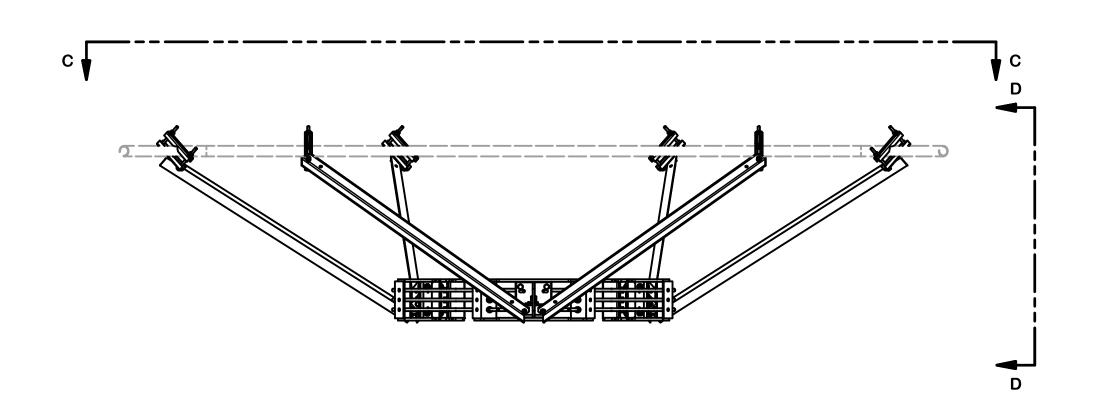

SP1 BC 10/25/2017

DATE


CPD BY

A CHANGED MAX. DIA. FOR HANDRAIL CONNECTION

**DESCRIPTION OF REVISIONS** 

**REVISION HISTORY** 

REV

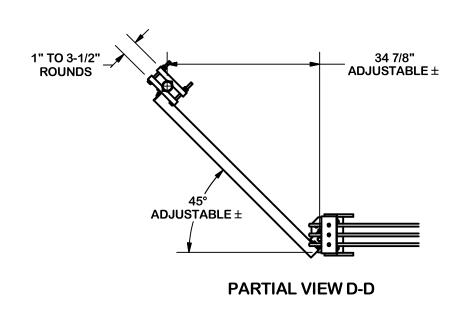

### **TOLERANCE NOTES**

TOLERANCES ON DIMENSIONS, UNLESS OTHERWISE NOTED ARE: SAWED, SHEARED AND GAS CUT EDGES ( $\pm\,0.030$ ") DRILLED AND GAS CUT HOLES (± 0.030") - NO CONING OF HOLES LASER CUT EDGES AND HOLES (± 0.010") - NO CONING OF HOLES BENDS ARE ± 1/2 DEGREE

ALL OTHER MACHINING (± 0.030")

ALL OTHER ASSEMBLY (± 0.060")

PROPRIETARY NOTE:
THE DATA AND TECHNIQUES CONTAINED IN THIS DRAWING ARE PROPRIETARY INFORMATION OF VALMONT
INDUSTRIES AND CONSIDERED A TRADE SECRET. ANY USE OR DISCLOSURE WITHOUT THE CONSENT OF
VALMONT INDUSTRIES IS STRICTLY PROHIBITED.

HANDRAIL REINFORCEMENT KIT (LONG)

DESCRIPTION



DWG. NO.


Engineering Support Team: 1-888-753-7446

Locations: New York, NY Atlanta, GA Los Angeles, CA Plymouth, IN Salem, OR Dallas, TX


CPD N	Ο.	DRAWN BY		ENG. APPROVAL	
SP1		CSL3	2/23/2017	3RD PARTY	
CLASS	SUB	DRAWING USAGE		CHECKED BY	
81	02	S	HOP	BMC	9/8/2017


PRK-SFS-L PRK-SFS-L

OF PAGE

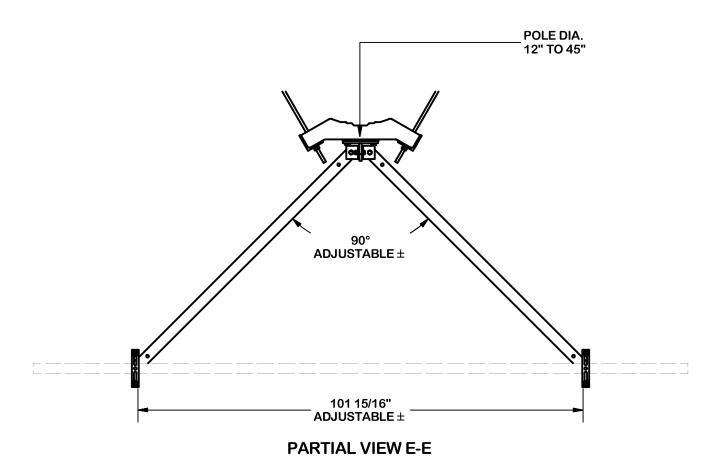

HORIZONTAL POSITION

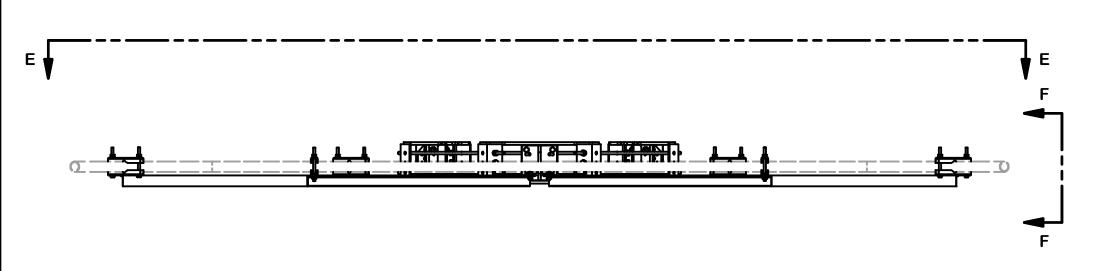

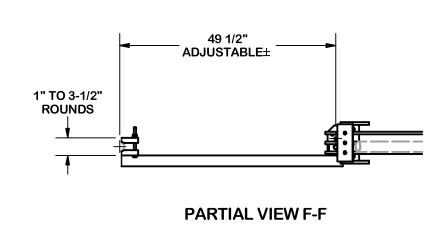

## TOLERANCE NOTES TOLERANCE NOTES TOLERANCE ON DIMENSIONS, UNLESS OTHERWISE NOTED ARE: SAWED, SHEARED AND GAS CUT EDGES (± 0.030") DRILLED AND GAS CUT HOLES (± 0.030") - NO CONING OF HOLES LASER CUT EDGES AND HOLES (± 0.010") - NO CONING OF HOLES BENDS ARE ± 1/2 DEGREE ALL OTHER MACHINING (± 0.030") ALL OTHER ASSEMBLY (± 0.060") REV DESCRIPTION OF REVISIONS CPD BY DATE PROPRIETARY NOTE: THE DATA AND TECHNIQUES CONTAINED IN THIS DRAWING ARE PROPRIETARY INFORMATION OF VALMONT INDUSTRIES AND CONSIDERED A TRADE SECRET. ANY USE OR DISCLOSURE WITHOUT THE CONSENT OF VALMONT INDUSTRIES SENICITLY PROHIBITED.

DESCRIPTION

HANDRAIL REINFORCEMENT KIT (LONG)



Engineering Support Team: 1-888-753-7446

Locations:
New York, NY
Atlanta, GA
eam: Los Angeles, CA
7446 Plymouth, IN
Salem, OR
Dallas, TX

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CPD NO. DRAWN BY		ENG. APPROVAL		PART NO.		
SF	21	CSL3 2/23/2017 3RD PARTY		RTY		
CLASS	SUB	DRAWING USAGE		CHECKED	ВҮ	DWG. NO.
81	02	S	HOP	BMC	9/8/2017	

PRK-SFS-L PRK-SFS-L

OF 3



### STATE OF CONNECTICUT CONNECTICUT SITING COUNCIL

Ten Franklin Square, New Britain, CT 06051 Phone: (860) 827-2935 Fax: (860) 827-2950 E-Mail: siting.council@ct.gov Web Site: portal.ct.gov/csc

### VIA ELECTRONIC MAIL

May 3, 2021

Denise Sabo Northeast Site Solutions 54 Main Street, Unit 3 Sturbridge, MA 01566

RE: **EM-AT&T-060-210407** – AT&T notice of intent to modify an existing telecommunications facility located at Long Hill Road (a/k/a 131 Manor Road), Guilford, Connecticut.

Dear Ms. Sabo:

The Connecticut Siting Council (Council) hereby acknowledges your notice to modify this existing telecommunications facility, pursuant to Section 16-50j-73 of the Regulations of Connecticut State Agencies with the following conditions:

- 1. Construction activities shall take place during daylight working hours consistent with the Condition No. 14 of the Council's Decision and Order in Docket No. 56;
- 2. Prior to AT&T's antenna installation, antenna mount modifications shall be installed in accordance with the Mount Analysis prepared by Power of Design Group, dated October 13, 2020 and stamped and signed by Jason Cheronis;
- 3. Within 45 days following completion of equipment installation, AT&T shall provide documentation certified by a Professional Engineer that its installation complied with the recommendations of the Mount Analysis;
- 4. Any deviation from the proposed modification as specified in this notice and supporting materials with the Council shall render this acknowledgement invalid;
- 5. Any material changes to this modification as proposed shall require the filing of a new notice with the Council;
- 6. The Council shall be notified in writing at least two weeks prior to the commencement of site construction activities:
- 7. Within 45 days after completion of construction, the Council shall be notified in writing that construction has been completed;
- 8. Any nonfunctioning antenna and associated antenna mounting equipment on this facility owned and operated by AT&T shall be removed within 60 days of the date the antenna ceased to function;
- 9. The validity of this action shall expire one year from the date of this letter; and

10. The applicant may file a request for an extension of time beyond the one year deadline provided that such request is submitted to the Council not less than 60 days prior to the expiration.

The proposed modifications including the placement of all necessary equipment and shelters within the tower compound are to be implemented as specified here and in your notice dated April 5, 2021. The modifications are in compliance with the exception criteria in Section 16-50j-72 (b) of the Regulations of Connecticut State Agencies as changes to an existing facility site that would not increase tower height, extend the boundaries of the tower site by any dimension, increase noise levels at the tower site boundary by six decibels or more, and increase the total radio frequencies electromagnetic radiation power density measured at the tower site boundary to or above the standards adopted by the Federal Communications Commission pursuant to Section 704 of the Telecommunications Act of 1996 and by the state Department of Energy and Environmental Protection pursuant to Connecticut General Statutes § 22a-162. This facility has also been carefully modeled to ensure that radio frequency emissions are conservatively below state and federal standards applicable to the frequencies now used on this tower.

This decision is under the exclusive jurisdiction of the Council. Please be advised that the validity of this action shall expire one year from the date of this letter. Any additional change to this facility will require explicit notice to this agency pursuant to Regulations of Connecticut State Agencies Section 16-50j-73. Such notice shall include all relevant information regarding the proposed change with cumulative worst-case modeling of radio frequency exposure at the closest point of uncontrolled access to the tower base, consistent with Federal Communications Commission, Office of Engineering and Technology, Bulletin 65. Thank you for your attention and cooperation.

Sincerely,

s/Melanie A. Bachman

Melanie A. Bachman Executive Director

MAB/IN/emr

c: The Honorable Matthew T. Hoey III, First Selectman, Town of Guilford (hoeym@ci.guilford.ct.us)



### Town of Guilford Building Department

50 Boston Street Guilford, CT 06437 Phone 203-453-8029 Fax 203-453-8034

### APPLICATION NO.

19639

PERMIT NO.

212911

Issue Date: 07/01/2021

Parcel ID	Location			
6	131 MANOR RD			
Subdivision Name	Subdivision Lot No.			
R-3	GUILFORD			
Owner Information				
Name: BISHOP B W & SONS Address: 1355 BOSTON POST RD GUILFORD, CT 06437	Owner ID: 517689 Phone Number: Email:			

### **Contractor Information**

Name: CROWN CASTLE USA Phone Number: (781) 970-0053

Address: 12 GILL ST, SUITE 5800 Contractor ID: 1773

WOBURN, MA 01801 Email:

Estimated Cost of Construction: \$ 30,000 Total Fees Paid: \$ 490.80

**Project Description: CELL TOWERS** 

Scope of Work:

ANTENNA UPGRADES

### **Permit Conditions:**

KIMBERLY NORMAN-ROSEDAM - PERMIT CONDITIONS WHERE APPLICABLE: ANTENNAS AND CELL TOWERS PERMIT CONDITIONS:

Permit valid one year. Permit will expire if work is not started within six months from date of issuance. Upon written request and payment of \$20.00 fee, permit may be renewed for six months at the discretion of the Building Officials. Required building inspections are (1) Temporary Electric Service (2) Footing (3) Footing Drains (4) Damp Proofing (5) Rough Electrical, HVAC, Plumbing and Framing (6) Insulation (7) Permanent Electrical (8) Final. Engineering Department Inspections (Required for New Construction and Substantial Improvement) are (1) Driveway Sight Lines (2) Driveway Grading (3) Paved Driveway Aprons (4) Drainage Systems.

CALL (203) 453-8029 Monday· Friday 8:30AM - 4:30 PM to SCHEDULE INSPECTIONS. 24 HOUR ADVANCE NOTICE IS REQUIRED. There is a charge for Certificate of Occupancy.

PROPERTY OWNER IS RESPONSIBLE TO SCHEDULE A FINAL INSPECTION.

- 1. THIS PROJECT REQUIRES SPECIAL INSPECTIONS IN ACCORDANCE WITH SECTION 1704, CSBC, WHICH SHALL BE CONDUCTED BY AN ACCREDITED INSPECTION AGENCY OR APPROVED INDIVIDUAL (CT REGISTERED PROFESSIONAL ENGINEER) AS NOTED ON THE SUBMITTED AND APPROVED "STATEMENT OF SPECIAL INSPECTIONS"
- a. SPECIAL INSPECTION REPORTS SHALL BE SUBMITTED DIRECTLY TO THIS OFFICE FROM THE AGENCY OR APPROVED INDIVIDUAL AS AVAILABLE.
- b. SUBMISSION OF A FINAL REPORT DOCUMENTING REQUIRED INSPECTIONS AND CORRECTIONS OF ANY DISCREPANCIES NOTED IN THE INSPECTIONS PRIOR TO CERTIFICATE OF OCCUPANCY
- 2. FIRE PROTECTION CONTRACTOR SHALL SUBMIT PRIOR TO COMMENCEMENT OF WORK DRAWINGS, UNDER SEAL FROM CT LICENSED LAYOUT TECHNICIAN, OF PROPOSED FM-200 WORK FOR REVIEW TO THE FIRE MARSHAL AND BUILDING DEPARTMENT FOR WORK IN NEWLY CONSTRUCTED AREAS.
- a. SUBMIT "AS-BUILT" DRAWINGS OF FIRE PROTECTION WORK PRIOR TO FINAL INSPECTION.
- 3. PRIOR TO ISSUANCE OF A CERTIFICATE OF APPROVAL SUBMIT A LETTER BY THE ENGINEER OF RECORD, A NOTARIZED "STATEMENT OF COMPLIANCE" BEARING A SEAL OF A CONNECTICUT REGISTERED PROFESSIONAL, VERIFYING THAT ALL CONSTRUCTION AND REPAIRS PERFORMED UNDER THIS PERMIT HAS BEEN COMPLETED, INSPECTED AND APPROVED AS CONFORMING TO THE APPROVED CONSTRUCTION DOCUMENTS.