

Northeast Site Solutions Victoria Masse 420 Main Street #2, Sturbridge, MA 01566 860-306-2326 victoria@northeastsitesolutions.com

September 2, 2021

Members of the Siting Council Connecticut Siting Council Ten Franklin Square New Britain, CT 06051

RE: Notice of Exempt Modification

160 Sound Beach Ave (aka Arcadia Road), Greenwich CT 06870

Latitude: 41.03302600 Longitude: -73.56729100

T-Mobile Site#: CT11001B_NHP

Dear Ms. Bachman:

T-Mobile currently maintains nine (9) antennas at the 105-foot mount on the existing 95-foot Utility Lattice Tower, located at 160 Sound Beach Ave (aka Arcadia Road), Greenwich CT. The tower is owned by owned by CL&P and the property is owned by Connecticut Department of Transportation. T-Mobile now intends to add a 25Kw generator to an expanded 7' X 18' concrete pad within existing compound.

Planned Modifications:

Ground work only-Install New:

- (1) GENERAC RD 25 KW AC DIESEL GENERATOR 240-gallon double walled self-contained tank with fuel sensor. Requires two (2) 12-minute run cycles by-weekly.
- (1) 7'x 18" Concrete pad
- (1) 3106 Cabinet (Remove)
- (1) S12000 Cabinet (Remove)



This facility was approved by the CT Siting Council. Per the attached Petition No. 526 – Dated October 3, 2001. T-Mobile (formally Voicestream) received approval to install on the existing transmission tower, with a total height of 112.5". Please see attached.

Please accept this letter as notification pursuant to Regulations of Connecticut State Agencies §16-50j-73, for construction that constitutes an exempt modification pursuant to R.C.S.A. § 16-50j-72(b)(2). In accordance with R.C.S.A. § 16-50j-73, a copy of this letter is being sent to the Honorable Fred Camillo, First Selectman of Greenwich, Katie DeLuca, AICP, Planning and Zoning Director and Eversource (CL&P) is the tower owner and property owner.

- 1. The proposed modifications will not result in an increase in the height of the existing structure.
- 2. The proposed modifications will not require the extension of the site boundary.
- 3. The proposed modifications will not increase noise levels at the facility by six decibels or more, or to levels that exceed state and local criteria.
- 4. The operation of the replacement antennas will not increase radio frequency emissions at the facility to a level at or above the Federal Communications Commission safety standard.
- 5. The proposed modifications will not cause a change or alteration in the physical or environmental characteristics of the site.
- 6. The existing structure and its foundation can support the proposed loading.

For the foregoing reasons, T-Mobile respectfully submits that the proposed modifications to the above referenced telecommunications facility constitute an exempt modification under R.C.S.A. § 16-50j-72(b)(2).

Sincerely,

Victoria Masse

Mobile: 860-306-2326 Fax: 413-521-0558

Office: 420 Main Street, Unit 2, Sturbridge MA 01566

Email: victoria@northeastsitesolutions.com



Attachments cc:

The Honorable Fred Camillo, First Selectman 101 Field Point Road First Floor Greenwich, CT 06830

Katie DeLuca, AICP, Planning and Zoning Director 101 Field Point Road 2nd Floor Greenwich, CT 06830

John A. Vitale- as property owner Transportation Rail Officer II Connecticut Department of Transportation Bureau of Public Transportation Office of Rails-Property Management Unit 4 Brewery Street, 4th Floor New Haven, Connecticut 06511

Eversource (CL&P)- as tower owner 107 Selden Street Berlin, CT 06037

Exhibit A

Petition No. 526 VoiceStream Wireless Greenwich, Connecticut Staff Report October 3, 2001

On October 1, 2001, Connecticut Siting Council (Council) member Edward S. Wilensky with Fred Cunliffe of Council staff met Voicestream Wireless (Voicestream) representatives Stephen Humes, Esq., Kurt Sheathelm, Haider Syed, and David Wicanpole for inspection of a Connecticut Light & Power Company (CL&P) electric transmission line structure (no. 1256) located at the Old Greenwich Metro North Railroad Station off Sound Beach Avenue, Greenwich. VoiceStream, with the agreement of CL&P, proposes to modify the structure by installing antennas and associated equipment for telecommunications use and is petitioning the Council for a declaratory ruling that no Certificate of Environmental Compatibility and Public Need (Certificate) is required for the modification.

VoiceStream proposes to install 12 antennas on a platform attached to an 18-inch by 18-inch lattice extension to the top of the existing 95-foot high transmission structure. The extension with antennas would rise 17.5 feet above the existing structure (112.5 feet above ground level). Also, a microwave dish antenna would be mounted four feet below the 12-antenna array for telephone switching from an adjacent site. Voicestream has agreed to move its antennas five feet lower or 12.5 feet above the existing structure (107.5 feet above ground level). This adjustment complies with CL&P's design requiring a minimum of six feet above the shield wire.

An alternative structure located east of the proposed site contains dense vegetation that would require clearing and is adjacent to railroad tracks, which would create difficult construction access. An alternative structure located to the west is being used by AT&T, approved by the Council in Petition No. 467, and is not structurally sound for sharing. Use of flush-mounted antennas on a pipe extension at the proposed site would not provide sufficient capacity for demand in the area.

Equipment cabinets will be mounted on a 16.5-foot x 5-foot concrete slab within a 10.6-foot x 24-foot fenced compound at the base of the tower. An underground conduit from an adjacent utility pole will provide power to the site. This fence would be architecturally treated with plastic slats in the chain-link fence. In addition, no vegetation would be cleared at this site.

Voicestream would access the site via the parking lot at the Old Greenwich Metro North Railroad Station. Voice stream has an agreement with the Connecticut Department of Transportation for the lease area at the base of the structure and access.

The zoning designation of this site is R-12 (residential); however, a Local Retail Business zone is located south beyond the parking lot. In addition to the railroad tracks and the high-voltage transmission right-of-way, other land uses across the railroad tracks are a General Business zone with an Industrial Re-Use overlay containing multi-family residential units.

The worst-case power density for the telecommunications operations at the site has been calculated to be 5.7% of the applicable standard for uncontrolled environments.

VoiceStream contends that the proposed modification of the structure would not require a Certificate because the increase in height of this monopole structure will not result in a substantial environmental effect nor will there be damage to existing scenic, historical or recreational values.and the proposed project will prevent the construction of a new tower in the area.

Exhibit B

TOWN OF GREENWICH C/O FINANCE DEPT

ARCADIA ROAD 0000

Printed 01/12/2021 card No. 1 of 1 299

PARCEL NUMBER

TOWN OF GREENWICH C/O FINANCE DEPT 101 FIELD POINT RD GREENWICH, CT 06830

LOT NO 11A 8A ARCADIA RD N5

TRANSFER OF OWNERSHIP

12/09/1954 NA \$0

Property Address ARCADIA ROAD 0000

111060 DISTRICT 6 S OLD GREENWICH [1]

TAXING DISTRICT INFORMATION

Greenwich, CT 001

ADMINISTRATIVE INFORMATION

057 Corporation District 06 Section & Plat 392 Routing Number 0220N0005

Site Description

Topography:

Public Utilities: Sewer, Electric

Street or Road:

R-12 Single Fam 12,000 $^{1}_{\text{S1}}$ Residential Land Zoning:

Legal Acres:

VALUATION RECORD

10/01/2016 10/01/2019 10/01/2020 10/01/2015 10/01/2015 10/01/2017 10/01/2018 Assessment Year Reason for Change 2015 Prelim 2015 Final 2016 List 2017 List 2018 List 2019 List 2020 List VALUATION L 4648300 4648300 4654300 4654300 4654300 4654300 4654300 Market В 453100 453100 453100 453100 453100 453100 453100 Τ 5101400 5101400 5107400 5107400 5107400 5107400 5107400 VALUATION L 3253810 3253810 3258010 3258010 3258010 3258010 3258010 70% Assessed В 317170 317170 317170 317170 317170 317170 317170 Τ 3570980 3570980 3575180 3575180 3575180 3575180 3575180

LAND DATA AND CALCULATIONS

Adjusted

Rate

Base

Rate

Rating Measured Table Prod. Factor Soil ID Acreage -or-Depth Factor -or-Actual Effective Effective -or-Frontage Frontage Depth Square Feet

EXEMPT

1.6168 1.00 1683448.00 1683448.00

Tax ID 440/039

Factor

Extended

Value

Influence

Value

2721800 B 71% 4654300

CKMP: 3484, 8701, 8702, 8725 & 8726 DBA: Railroad parking w/ access off Sound Beach Ave.

Permit Number

Land Type

Supplemental Cards

TRUE TAX VALUE

4654300

Type

FilingDate Est. Cost Field Visit Est. SqFt

> Supplemental Cards TOTAL LAND VALUE

4654300

06-4687/S Parent Parcel Number

Neighborhood

Property Class 299 Exempt Commercial

Jurisdiction 57 Area

Neighborhood:

1.6168

P: 213 spcs

06-4687/S Property Class: 299 ARCADIA ROAD 0000


IMPROVEMENT DATA

PHYSICAL CHARACTERISTICS Item Description Units Cost Total Pct

01

(LCM: 150.00)

SPECIAL FEATURES			SUMMARY OF IMPROVEMENTS																
Description	Value	ID	Use		Const Type		Year Const	Eff Year C	ond			Adj Si Rate <i>I</i>		Computed Value	Phys Obso Depr Dep				Value
		01	PAVING	0.00	85	Good	199	0 2000	VG	2.90	N	6.53	6950	0 45384	0 0	0 :	100	100	45380
		Data	a Collector	/Date	2	Apprai	ser/Da	te			Neig	ghborhood		Supplemen					
		JB	09/07/1999)	5	rog 1	0/01/2	015			Neig	gh 111060	AV	TOTAL IME	PROVEMENT	VALUE			453

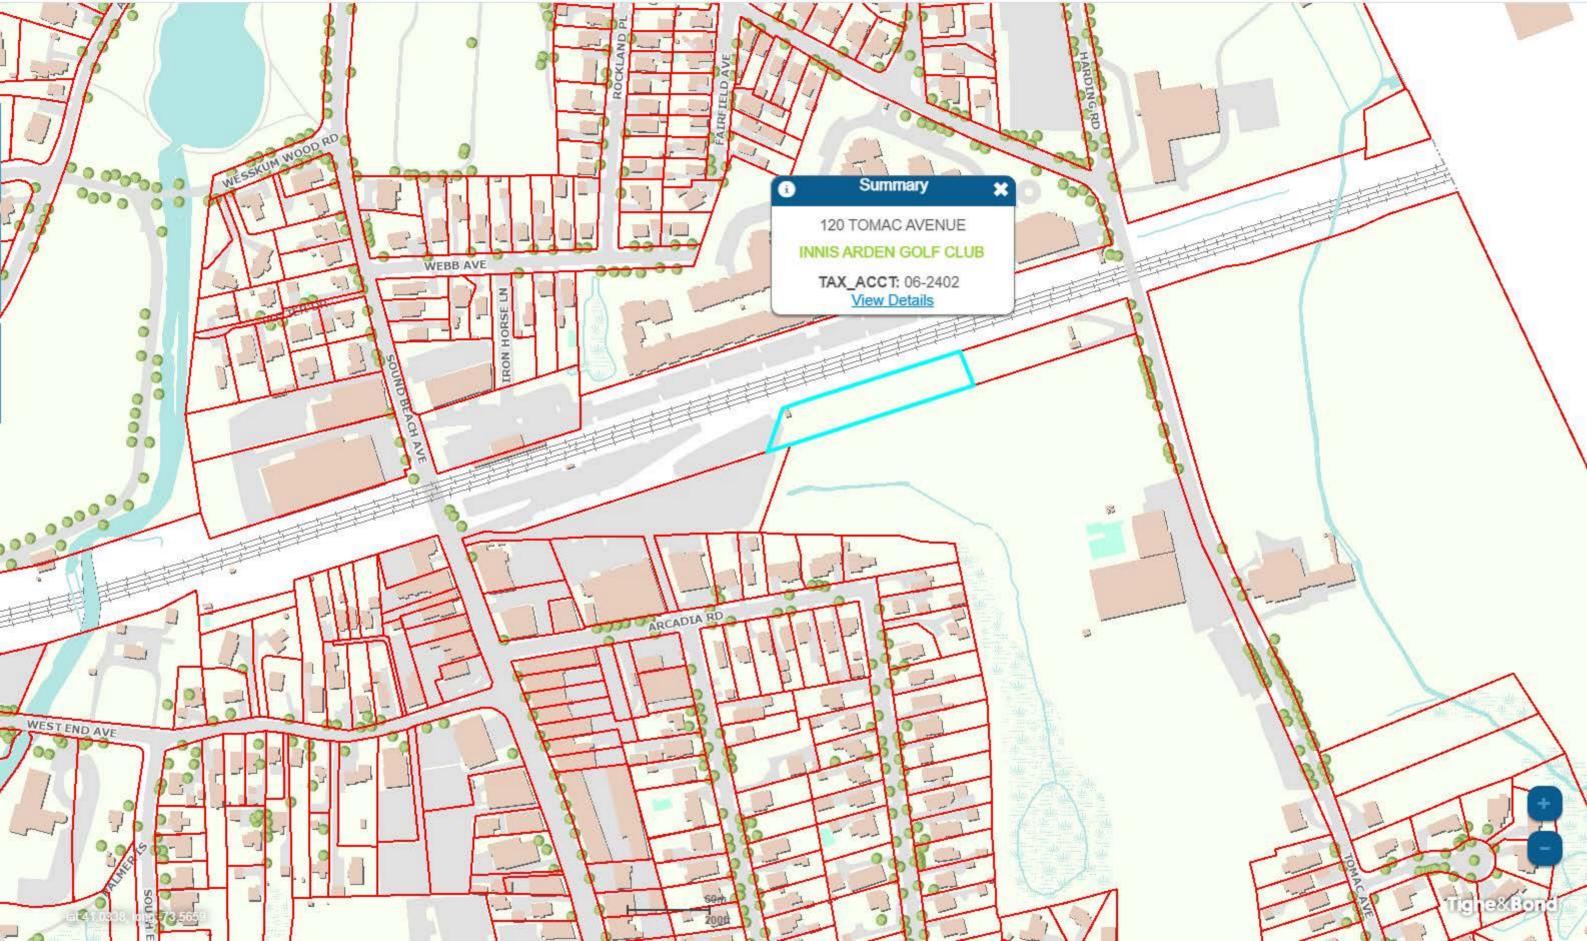



Victoria Masse <victoria@northeastsitesolutions.com>

T-Mobile Request for Property Record Card for 160 Sound Beach Ave, Greenwich CT

6 messages

Victoria Masse <victoria@northeastsitesolutions.com>

Wed, Aug 11, 2021 at 5:42 PM

To: prc@greenwichct.org

Cc: Denise Sabo <denise@northeastsitesolutions.com>, Deborah Chase <deborah@northeastsitesolutions.com>

Good Evening,

T-Mobile is looking to file an Exempt Modification with the Connecticut Siting Council for an antenna upgrade for an existing lattice tower located at 160 Sound Beach Ave, Greenwich CT. The Council requires that we provide a property card in our filing.

Can you please provide us with a copy of the property card for this address?

Address- 160 Sound Beach Ave, Greenwich CT The Parcel ID is- 126833

Thank you

--

Victoria Masse

Zoning & Permitting Specialist

Notary Public

Mobile: 860-306-2326

Office: 420 Main Street Unit 1 Box 2 Sturbridge, MA 01566

Email: victoria@northeastsitesolutions.com



PRC c@greenwichct.org>

Thu, Aug 12, 2021 at 8:12 AM

To: Victoria Masse <victoria@northeastsitesolutions.com>

Cc: Denise Sabo <denise@northeastsitesolutions.com>, Deborah Chase <deborah@northeastsitesolutions.com>

Ηi,

We do not have a 160 Sound Beach Avenue in our system, I also could not locate the property on google, the parcel id you provided is also not any parcel id in our system. Would you have a property owner name or a map that illustrates where the tower is?

From: Victoria Masse <victoria@northeastsitesolutions.com>

Sent: Wednesday, August 11, 2021 5:42 PM

Cc: Denise Sabo <denise@northeastsitesolutions.com>; Deborah Chase <deborah@northeastsitesolutions.com>

Subject: T-Mobile Request for Property Record Card for 160 Sound Beach Ave, Greenwich CT

[EXTERNAL]

[Quoted text hidden]

CAUTION: This email originated from outside the Town email system. Do not click links or open attachments unless you have verified the sender and know the content is safe.

Victoria Masse <victoria@northeastsitesolutions.com>

Thu, Aug 12, 2021 at 8:53 AM

To: PRC <prc@greenwichct.org>

Cc: Denise Sabo <denise@northeastsitesolutions.com>, Deborah Chase <deborah@northeastsitesolutions.com>

Good Morning,

I'm sorry the property itself is owned by Connecticut Department of Transportation Bureau of Public Transportation, I have attached to this email the parcel map that we have.

John A. Vitale

Transportation Rail Officer II

Connecticut Department of Transportation

Bureau of Public Transportation

Office of Rails-Property Management Unit

4 Brewery Street, 4th Floor

New Haven, Connecticut 06511

From google maps when I search by 160 Sound Beach Ave it takes me to this road and when I drop down for a closer look it looks like it shows it as 177 Sound Beach Ave-



I also tried to search the tax records to see if I could find a parcel ID when submitting my request and this is what I found for the 160 Sound Beach address-

BILL#	NAME/ADDRESS	PROPERTY/VEHICLE
2010-02-0003734	T-MOBILE NORTHEAST	160 SOUND BEACH
126833	LLC D/B/A T-MOBILE	AVENUE
(PERSONAL PROPERTY)		

Thank you!

[Quoted text hidden]

2 attachments



CT11001B-Parcel Map.pdf 382K



2021-0805_21051.03 CT11001B - Rev1 CDs (S&S).pdf 7651K

PRC c@greenwichct.org>

Thu, Aug 12, 2021 at 9:45 AM

To: Victoria Masse <victoria@northeastsitesolutions.com>

Cc: Denise Sabo <denise@northeastsitesolutions.com>, Deborah Chase <deborah@northeastsitesolutions.com>

If it is owned by the Connecticut Department of Transportation Bureau of Public Transporation then we would not have any parcel id or tax card for it. But if it fell within the boundaries depicted in the attached map, within the blue lines, then it would be 120 Tomac Avenue(for our purposes) and I have attached their Field card. There simply isn't any kind of property card if it is located within the railroad row.

From: Victoria Masse < victoria@northeastsitesolutions.com >

Sent: Thursday, August 12, 2021 8:53 AM

To: PRC c@greenwichct.org>

Cc: Denise Sabo <denise@northeastsitesolutions.com>; Deborah Chase <deborah@

northeastsitesolutions.com>

Subject: Re: T-Mobile Request for Property Record Card for 160 Sound Beach Ave, Greenwich CT

[Quoted text hidden]

2 attachments



bgnsmth.PNG 364K



PRC c@greenwichct.org>

Thu, Aug 12, 2021 at 10:28 AM

To: Victoria Masse <victoria@northeastsitesolutions.com>

Cc: Denise Sabo <denise@northeastsitesolutions.com>, Deborah Chase <deborah@northeastsitesolutions.com>

Hi,

I have been able to confirm that the correct property card is 0 Arcadia Road Parcel ID(06-4687) and I have attached it to this email.

Have a nice day!

From: Victoria Masse < victoria@northeastsitesolutions.com >

Sent: Thursday, August 12, 2021 8:53 AM

To: PRC c@greenwichct.org>

Cc: Denise Sabo <denise@northeastsitesolutions.com>; Deborah Chase <deborah@

northeastsitesolutions.com>

Subject: Re: T-Mobile Request for Property Record Card for 160 Sound Beach Ave, Greenwich CT

[Quoted text hidden]



Victoria Masse <victoria@northeastsitesolutions.com>

Thu, Aug 12, 2021 at 10:29 AM

To: PRC c@greenwichct.org>

Cc: Denise Sabo <denise@northeastsitesolutions.com>, Deborah Chase <deborah@northeastsitesolutions.com>

Thank you so much for all your help!

[Quoted text hidden]

Exhibit C

T··Mobile·

T-MOBILE NORTHEAST LLC **NATIONAL HARDENING PROJECT**

> **CL&P STRUCTURE #1256 SITE NUMBER: CT11001B**

SITE NAME: CT11001B-GREENWICH RIVERSIDE

SITE ADDRESS: 160 SOUND BEACH AVENUE

GREENWICH, CT 06870

PROJECT NOTES:

- THIS IS AN UNMANNED TELECOMMUNICATION FACILITY AND NOT FOR **HUMAN HABITATION:** HANDICAPPED ACCESS IS NOT REQUIRED.
- POTABLE WATER OR SANITARY SERVICE IS NOT REQUIRED. NO OUTDOOR STORAGE OR ANY SOLID WASTE RECEPTACLES REQUIRED.
- CONTRACTOR SHALL VERIEY ALL PLANS, EXISTING DIMENSIONS, AND CONDITIONS ON THE JOB SITE. CONTRACTOR SHALL IMMEDIATELY NOTIFY THE ARCHITECT/ENGINEER IN WRITING OF ANY DISCREPANCIES BEFORE PROCEEDING WITH THE WORK. FAILURE TO NOTIFY THE ARCHITECT/ENGINEER PLACES THE RESPONSIBILITY ON THE CONTRACTOR TO CORRECT THE DISCREPANCIES AT THE CONTRACTOR'S
- DEVELOPMENT AND USE OF THE SITE WILL CONFORM TO ALL APPLICABLE CODES. ORDINANCES AND SPECIFICATIONS.

CODE COMPLIANCE:

ALL WORK SHALL COMPLY WITH THE CURRENT NATIONAL AND CONNECTICUT STATE BUILDING AND LIFE SAFETY CODES, SUPPLEMENTS AND AMENDMENTS INCLUDING BUT NOT LIMITED TO THE LATEST EDITION OF

CONNECTICUT STATE BUILDING CODE (CSBC).

ANSI/TIA-222-G STRUCTURAL STANDARD FOR ANTENNA SUPPORTING STRUCTURES AND ANTENNAS.

NATIONAL ELECTRICAL CODE (NEC) FOR POWER AND GROUNDING REQUIREMENTS.

OCCUPATIONAL SAFETY AND HEALTH ACT (OSHA).

NFPA - NATIONAL FIRE PROTECTION ASSOCIATION.



Advance Notice: Minimum of 2 working days in advance, no more than 30 days in advance

APPROVALS:

FSA CM	DATE
RF ENGINEER	DATE
FOPS	DATE
T-MOBILE ENGINEERING AND DEVELOPMENT	
	DATE
	DATE





PROJECT SCOPE:

THE PROPOSED PROJECT SCOPE WILL CONSIST OF INSTALLING A NEW GENERAC RD 25 KW AC DIESEL GENERATOR AND TANK FOR AN EXISTING TELECOM BASE STATION. NO SIGNIFICANT GRADING IS REQUIRED.

PROJECT INFORMATION:

SITE NUMBER SITE NAME:

SITE ADDRESS:

STRUCTURE TYPE

41° 01' 58.73" N, 73° 34' 02.23" W 24'± (AMSL) COORDINATES: GROUND ELEV:

PROJECT TEAM:

APPLICANT:

T-MOBILE NORTHEAST LLC 35 GRIFFIN ROAD SOUTH BLOOMFIELD, CT 06002

CT11001B CT11001B-GREENWICH RIVERSIDE

160 SOUND BEACH AVENUE

GREENWICH, CT 06870

UTILITY POLE

TOWER OWNER: MCGUIRE ROAD ASSOCIATES LLC

111 FARM BROOK LANE SOUTH WINDSOR, CT 06074

TOWER OWNER: THE CONNECTICUT LIGHT AND POWER COMPANY

PROJECT MANAGER NORTHEAST SITE SOLUTIONS 420 MAIN STREET, BLDG 4

STURBRIDGE, MA 01566 SHELDON FREINCLE

SHELDON@NORTHEASTSITESOLUTIONS.COM TEL: 201-776-852

ENGINEERING CONSULTANTS: FORESITE LLC

462 WALNUT ST, SUITE 1 NEWTON, MA 02460

SAEED MOSSAVAT

SMOSSAVAT@FORESITELLC.COM

TEL: 617-212-3123

SHEET INDEX:

TITLE SHEET

GENERAL NOTES

SITE POINT CLOUD

SITE PLAN EQUIPMENT LAYOUT

GENERATOR SPECIFICATIONS AND DETAILS

GENERATOR SPECIFICATIONS AND DETAILS

AUTOMATIC TRANSFER SWITCH SPECIFICATIONS
UNDERGROUND CONDUIT AND CONCRETE PAD DETAILS

ELECTRICAL DETAILS

GROUNDING DETAILS

APPLICANT:

T - Mobile T-MOBILE NORTHEAST LLC

35 GRIFFIN ROAD SOUTH BLOOMFIELD, CT 06002 860-692-7100

PROJECT MANAGER




420 MAIN STREET BLDG 4 STURBRIDGE, MA 01566 203-275-6669

CONSULTANT:



462 WALNUT STREET NEWTON, MA 02460 617-212-3123

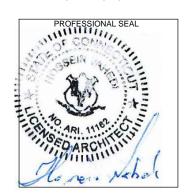

THIS DOCUMENT IS THE DESIGN PROPERTY AND COPYRIGHT OF FORESITE, LLC, AND FOR THE EXCLUSIVE USE BY THE TITLE CLIENT. DUPLICATION OR USE WITHOUT THE EXPRESS WRITTEN CONSENT OF THE CREATOR IS STRICTLY ROHIBITED, DRAWING SCALES ARE INTENDED FOR 11"x17" SIZE PRINTED MEDIA ONLY. ALL OTHER PRINTED SIZES ARE DEEMED "NOT TO SCALE".

DESCRIPTION

KEV	DESCRIPTION	DATE
Α	PRELIMINARY	04/19/21
В	REVISED PER COMMENTS	04/22/21
(

CL&P STRUCTURE #1256 SITE NUMBER: CT11001B SITE NAME: CT11001B-GREENWICH RIVERSIDE SITE ADDRESS: 160 SOUND BEACH AVENUE GREENWICH, CT 0687

SHEET TITLE:

T-1: TITLE SHEET

- 1. THE CONTRACTOR SHALL GIVE ALL NOTICES AND COMPLY WITH ALL LAWS, ORDINANCES, RULES, REGULATIONS AND LAWFUL ORDERS OF ANY PUBLIC AUTHORITY, MUNICIPAL AND UTILITY COMPANY SPECIFICATIONS, AND LOCAL AND STATE JURISDICTIONAL CODES BEARING ON THE PERFORMANCE OF THE WORK. THE WORK PERFORMED ON THE PROJECT AND THE MATERIALS INSTALLED SHALL BE IN STRICT ACCORDANCE WITH ALL APPLICABLE CODES, REGULATIONS, AND ORDINANCES.
- 2. THE ARCHITECT/ENGINEER HAS MADE EVERY EFFORT TO SET FORTH IN THE CONSTRUCTION AND CONTRACT DOCUMENTS THE COMPLETE SCOPE OF WORK. THE CONTRACTOR BIDDING THE JOB IS NEVERTHELESS CAUTIONED THAT MINOR OMISSIONS OR ERRORS IN THE DRAWINGS AND OR SPECIFICATIONS SHALL NOT EXCUSE SAID CONTRACTOR FROM COMPLETING THE PROJECT AND IMPROVEMENTS IN ACCORDANCE WITH THE INTENT OF THESE DOCUMENTS.
- 3. THE CONTRACTOR OR BIDDER SHALL BEAR THE RESPONSIBILITY OF NOTIFYING (IN WRITING) THE CLIENT'S REPRESENTATIVE OF ANY CONFLICTS, ERRORS, OR OMISSIONS PRIOR TO THE SUBMISSION OF CONTRACTOR'S PROPOSAL OR PERFORMANCE OF WORK.
- 5. THE CONTRACTOR SHALL VISIT THE JOB SITE PRIOR TO THE SUBMISSION OF BIDS OR PERFORMING WORK TO FAMILIARIZE HIMSELF WITH THE FIELD CONDITIONS AND TO VERIFY THAT THE PROJECT CAN BE CONSTRUCTED IN ACCORDANCE WITH THE CONSTRUCTION DOCUMENTS.
- 6. THE CONTRACTOR SHALL INSTALL ALL EQUIPMENT AND MATERIALS ACCORDING TO THE MANUFACTURER'S / VENDOR'S SPECIFICATIONS UNLESS NOTED OTHERWISE OR WHERE LOCAL CODES OR ORDINANCES TAKE PRECEDENCE.
- 7. THE CONTRACTOR SHALL MAKE NECESSARY PROVISIONS TO PROTECT EXISTING IMPROVEMENTS DURING CONSTRUCTION
- 8. THE CONTRACTOR SHALL COMPLY WITH ALL PERTINENT SECTIONS OF THE BASIC STATE BUILDING CODE, LATEST EDITION. AND ALL OSHA REQUIREMENTS AS THEY APPLY TO THIS PROJEC
- 9. THE CONTRACTOR SHALL NOTIFY THE CLIENT'S REPRESENTATIVE IN WRITING WHERE A CONFLICT OCCURS ON ANY OF THE CONTRACT DOCUMENTS. THE CONTRACTOR IS NOT TO ORDER MATERIAL OR CONSTRUCT ANY PORTION OF THE WORK THAT IS IN CONFLICT UNTIL CONFLICT IS RESOLVED BY THE CLIENT'S REPRESENTATIVE.
- 10. THE WORK SHALL CONFORM TO THE CODES AND STANDARDS OF THE FOLLOWING AGENCIES AS FURTHER CITED HEREIN:
- A. ASTM: AMERICAN SOCIETY FOR TESTING AND MATERIALS, AS PUBLISHED IN "COMPILATION OF ASTM STANDARDS BUILDING CODES" OR LATEST EDITION
- B. AWS: AMERICAN WELDING SOCIETY INC. AS PUBLISHED IN "STANDARD D1.1-08, STRUCTURAL WELDING CODE" OR LATEST EDITION.
- C. AISC: AMERICAN INSTITUTE FOR STEEL CONSTRUCTION AS PUBLISHED IN "CODE FOR STANDARD PRACTICE FOR STEEL BUILDINGS AND BRIDGES"; "SPECIFICATIONS FOR THE DESIGN, FABRICATION AND ERECTION OF STRUCTURAL STEEL FOR BUILDINGS" (LATEST EDITION)
- 11. BOLTING:
- A. BOLTS SHALL BE CONFORMING TO ASTM A325 HIGH STRENGTH, HOT DIP GALVANIZED WITH ASTM A153 HEAVY HEX TYPE NUTS.
- B. BOLTS SHALL BE 3/4" MINIMUM (UNLESS OTHERWISE NOTED)
- C. ALL CONNECTIONS SHALL BE 2 BOLTS MINIMUM.
- 12. FABRICATION:
- A. FABRICATION OF STEEL SHALL CONFORM TO THE AISC AND AWS STANDARDS AND CODES (LATEST EDITION)
- B. ALL STRUCTURAL STEEL SHALL BE HOT-DIP GALVANIZED AFTER FABRICATION IN ACCORDANCE WITH ASTM A123 (LATEST EDITION), UNLESS OTHERWISE NOTED.
- 13. ERECTION OF STEEL:
- A. PROVIDE ALL ERECTION EQUIPMENT, BRACING, PLANKING, FIELD BOLTS, NUTS, WASHERS, DRIFT PINS, AND SIMILAR MATERIALS WHICH DO NOT FORM A PART OF THE COMPLETED CONSTRUCTION BUT ARE NECESSARY FOR ITS PROPER FRECTION
- B. ERECT AND ANCHOR ALL STRUCTURAL STEEL IN ACCORDANCE WITH AISC REFERENCE STANDARDS. ALL WORK SHALL BE ACCURATELY SET TO ESTABLISHED LINES AND ELEVATIONS AND RIGIDLY FASTENED IN PLACE WITH SUITABLE ATTACHMENTS TO THE CONSTRUCTION OF THE BUILDING.
- C. TEMPORARY BRACING, GUYING AND SUPPORT SHALL BE PROVIDED TO KEEP THE STRUCTURE SAFE AND ALIGNED AT ALL TIMES DURING CONSTRUCTION, AND TO PREVENT DANGER TO PERSONS AND PROPERTY. CHECK ALL TEMPORARY LOADS AND STAY WITHIN SAFE CAPACITY OF ALL BUILDING COMPONENTS.
- 14. ANTENNA INSTALLATION:
- A. INSTALL ANTENNAS AS INDICATED ON DRAWINGS AND CLIENT'S REPRESENTATIVE SPECIFICATIONS.

- B. INSTALL GALVANIZED STEEL ANTENNA MOUNTS AS INDICATED ON DRAWINGS.
- C. INSTALL COAXIAL / FIBER CABLES AND TERMINATIONS BETWEEN ANTENNAS AND EQUIPMENT PER MANUFACTURER'S RECOMMENDATIONS. WEATHERPROOF ALL CONNECTORS BETWEEN THE ANTENNA AND EQUIPMENT PER MANUFACTURER'S REQUIREMENTS.
- 15. ANTENNA AND COAXIAL / FIBER CABLE GROUNDING:
- A. ALL EXTERIOR #6 GREEN GROUND WIRE "DAISY CHAIN" CONNECTIONS ARE TO BE WEATHER SEALED WITH ANDREWS CONNECTOR/SPLICE WEATHERPROOFING KIT TYPE #221213 OR EQUAL.
- ALL COAXIAL / FIBER CABLE GROUNDING KITS ARE TO BE INSTALLED ON STRAIGHT RUNS OF COAXIAL / FIBER CABLE (NOT WITHIN BENDS)
- 16. RELATED WORK, FURNISH THE FOLLOWING WORK AS SPECIFIED UNDER CONSTRUCTION DOCUMENTS, BUT COORDINATE WITH OTHER TRADES PRIOR TO BID:
- A. FLASHING OF OPENING INTO OUTSIDE WALLS
- B. SEALING AND CAULKING ALL OPENINGS
- C. PAINTING
- D. CUTTING AND PATCHING
- 17. REQUIREMENTS OF REGULATORY AGENCIES:
- A. FURNISH U.L. LISTED EQUIPMENT WHERE SUCH LABEL IS AVAILABLE. INSTALL IN CONFORMANCE WITH U.L. STANDARDS WHERE APPLICABLE.
- B. INSTALL ANTENNA, ANTENNA CABLES, GROUNDING SYSTEM IN ACCORDANCE WITH DRAWINGS AND SPECIFICATION IN EFFECT AT PROJECT LOCATION AND RECOMMENDATIONS OF STATE AND LOCAL BUILDING CODES, AND SPECIAL CODES HAVING JURISDICTION OVER SPECIFIC PORTIONS OF WORK. THIS WORK INCLUDES BUT IS NOT LIMITED TO THE FOLLOWING:
- C. TIA-EIA 222 (LATEST EDITION). STRUCTURAL STANDARDS FOR STEEL ANTENNA TOWERS AND ANTENNA SUPPORTING STRUCTURES.
- D. FAA FEDERAL AVIATION ADMINISTRATION ADVISORY CIRCULAR AC 70/7460-IH, OBSTRUCTION MARKING AND LIGHTING.
- E. FCC FEDERAL COMMUNICATIONS COMMISSION RULES AND REGULATIONS FORM 715, OBSTRUCTION MARKING AND LIGHTING SPECIFICATION FOR ANTENNA STRUCTURES AND FORM 715A, HIGH INTENSITY OBSTRUCTION LIGHTING SPECIFICATIONS FOR ANTENNA STRUCTURES.
- F. AISC AMERICAN INSTITUTE OF STEEL CONSTRUCTION SPECIFICATION FOR STRUCTURAL JOINTS USING ASTM A325 BOLTS (LATEST EDITION).
- G. NEC NATIONAL ELECTRICAL CODE ON TOWER LIGHTING KITS.
- H. UL UNDERWRITER'S LABORATORIES APPROVED ELECTRICAL PRODUCTS.
- I. IN ALL CASES, PART 77 OF THE FAA RULES AND PARTS 17 AND 22 OF THE FCC RULES ARE APPLICABLE AND IN THE EVENT OF CONFLICT, SUPERSEDE ANY OTHER STANDARDS OR SPECIFICATIONS.
- J. 2018 LIFE SAFETY CODE NFPA 101.

APPLICANT:

35 GRIFFIN ROAD SOUTH BLOOMFIELD, CT 06002 860-692-7100

PROJECT MANAGER




420 MAIN STREET, BLDG 4 STURBRIDGE, MA 01566 203-275-6669

CONSULTANT:



462 WALNUT STREET NEWTON, MA 02460 617-212-3123

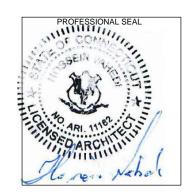

THIS DOCUMENT IS THE DESIGN PROPERTY AND COPYRIGHT OF FORESITE, LLC. AND FOR THE EXCLUSIVE USE BY THE TITLE CLIENT.


DUPLICATION OR USE WITHOUT THE EXPRESS WRITTEN CONSENT OF THE CREATOR IS STRICTLY PROHIBITED. DRAWING SCALES ARE INTENDED FOR 11"X17" SIZE PRINTED MEDIA ONLY. ALL OTHER PRINTED SIZES ARE DEEMED "NOT TO SCALE".


REV	DESCRIPTION	DATE
Α	PRELIMINARY	04/19/21
В	REVISED PER COMMENTS	04/22/21


CL&P STRUCTURE #1256 SITE NUMBER: CT11001B SITE NAME: CT11001B-GREENWICH RIVERSIDE SITE ADDRESS: 160 SOUND BEACH AVENUE GREENWICH, CT 06870

SHEET TITLE:

N-1: GENERAL NOTES

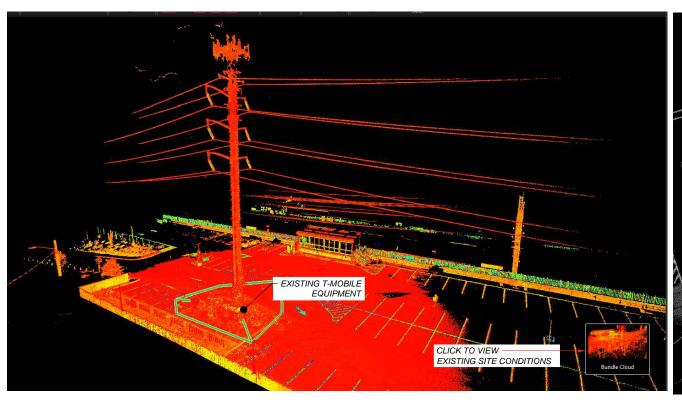

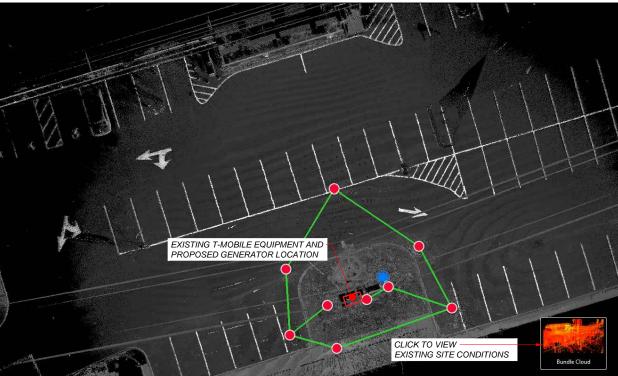

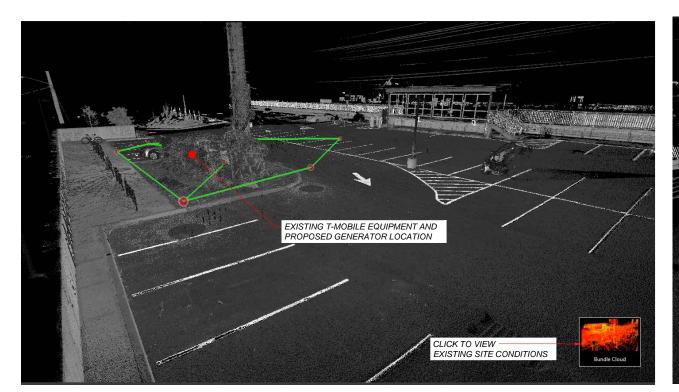



SITE POINT CLOUD



APPLICANT: T • • Mobile • T-MOBILE NORTHEAST LLC

35 GRIFFIN ROAD SOUTH BLOOMFIELD, CT 06002 860-692-7100

PROJECT MANAGER



420 MAIN STREET, BLDG 4 STURBRIDGE, MA 01566 203-275-6669

CONSULTANT:



462 WALNUT STREET NEWTON, MA 02460 617-212-3123



THIS DOCUMENT IS THE DESIGN PROPERTY AND COPYRIGHT OF FORESITE, LLC. AND FOR THE EXCLUSIVE USE BY THE TITLE CLIENT.


DUPLICATION OR USE WITHOUT THE EXPRESS WRITTEN CONSENT OF THE CREATOR IS STRICTLY PROHIBITED. DRAWING SCALES ARE INTENDED FOR 11"x17" SIZE PRINTED MEDIA ONLY. ALL OTHER PRINTED SIZES ARE DEEMED "NOT TO SCALE".

١	REV	DESCRIPTION	DATE
l	Α	PRELIMINARY	04/19/21
l	В	REVISED PER COMMENTS	04/22/21
l			
l			
l			
l			
l			
l			
l			
l			
۱	(

CL&P STRUCTURE #1256 SITE NUMBER: CT11001B SITE NAME: CT11001B-GREENWICH RIVERSIDE SITE ADDRESS: 160 SOUND BEACH AVENUE GREENWICH, CT 06870

SHEET TITLE:

A-1: SITE POINT CLOUD

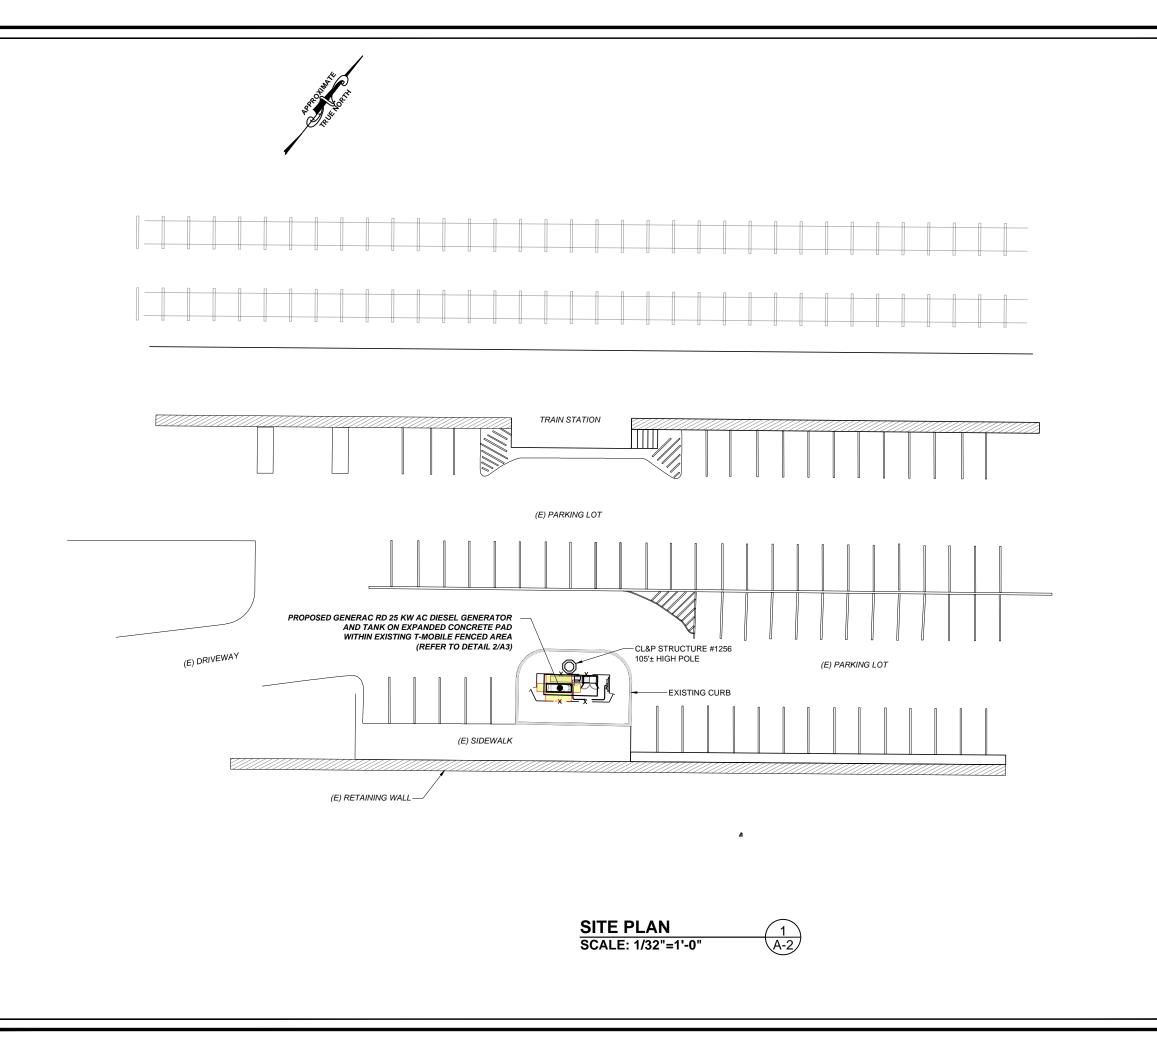

APPLICANT:

T - Mobile - T-Mobile - T-Mobile NORTHEAST LLC

35 GRIFFIN ROAD SOUTH BLOOMFIELD, CT 06002 860-692-7100

PROJECT MANAGER



420 MAIN STREET, BLDG 4 STURBRIDGE, MA 01566 203-275-6669

CONSULTANT:



462 WALNUT STREET NEWTON, MA 02460 617-212-3123



THIS DOCUMENT IS THE DESIGN PROPERTY AND COPYRIGHT OF FORESITE, LLC. AND FOR THE EXCLUSIVE USE BY THE TITLE CLIENT. DUPLICATION OR USE WITHOUT THE EXPRESS WRITTEN CONSENT OF THE CREATOR IS STRICTLY PROHIBITED. DRAWING SCALES ARE INTENDED FOR 11"X17" SIZE PRINTED MEDIA ONLY. ALL OTHER PRINTED SIZES ARE DEEMED "NOT TO SCALE".

	REV	DESCRIPTION	DATE
	Α	PRELIMINARY	04/19/21
	В	REVISED PER COMMENTS	04/22/21


CL&P STRUCTURE #1256 SITE NUMBER: CT11001B SITE NAME: CT11001B-GREENWICH RIVERSIDE SITE ADDRESS: 160 SOUND BEACH AVENUE GREENWICH, CT 06870

SHEET TITLE:


A-2: SITE PLAN



(E) PARKING LOT (E) PARKING LOT

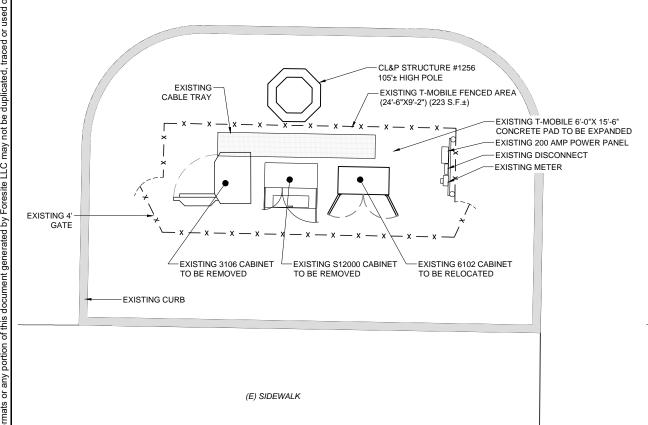

(E) RETAINING WALL -

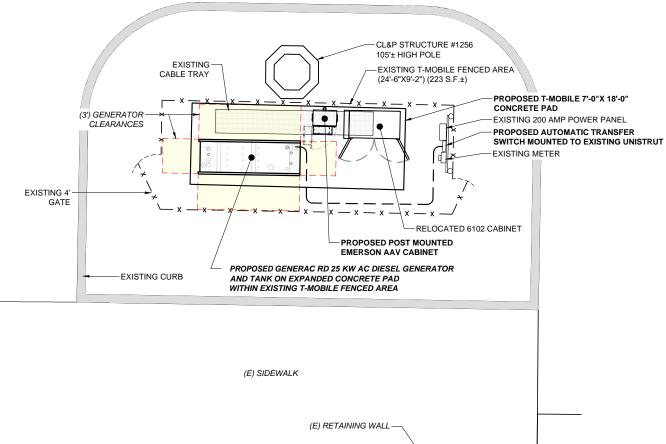

EXISTING EQUIPMENT LAYOUT
SCALE: 1/8"=1'-0"

A-3

PROPOSED EQUIPMENT LAYOUT 2 SCALE: 1/8"=1'-0" A-3 APPLICANT:

T - Mobile - T-mobile -

35 GRIFFIN ROAD SOUTH BLOOMFIELD, CT 06002 860-692-7100

PROJECT MANAGER



420 MAIN STREET, BLDG 4 STURBRIDGE, MA 01566 203-275-6669

CONSULTANT:



462 WALNUT STREET NEWTON, MA 02460 617-212-3123




THIS DOCUMENT IS THE DESIGN PROPERTY AND COPYRIGHT OF FORESITE, LLC. AND FOR THE EXCLUSIVE USE BY THE TITLE CLIENT.
DUPLICATION OR USE WITHOUT THE EXPRESS WRITTEN CONSENT OF THE CREATOR IS STRICTLY PROHIBITED. DRAWING SCALES ARE INTENDED FOR 11"x17" SIZE PRINTED MEDIA ONLY. ALL OTHER PRINTED SIZES ARE DEEMED "NOT TO SCALE".

l	REV	DESCRIPTION	DATE
l	Α	PRELIMINARY	04/19/21
l	В	REVISED PER COMMENTS	04/22/21
l			
l			
l			
l			
ı			

CL&P STRUCTURE #1256 SITE NUMBER: CT11001B SITE NAME: CT11001B-GREENWICH RIVERSIDE SITE ADDRESS: 160 SOUND BEACH AVENUE GREENWICH, CT 06870

SHEET TITLE:

A-3: EQUIPMENT LAYOUT PLAN

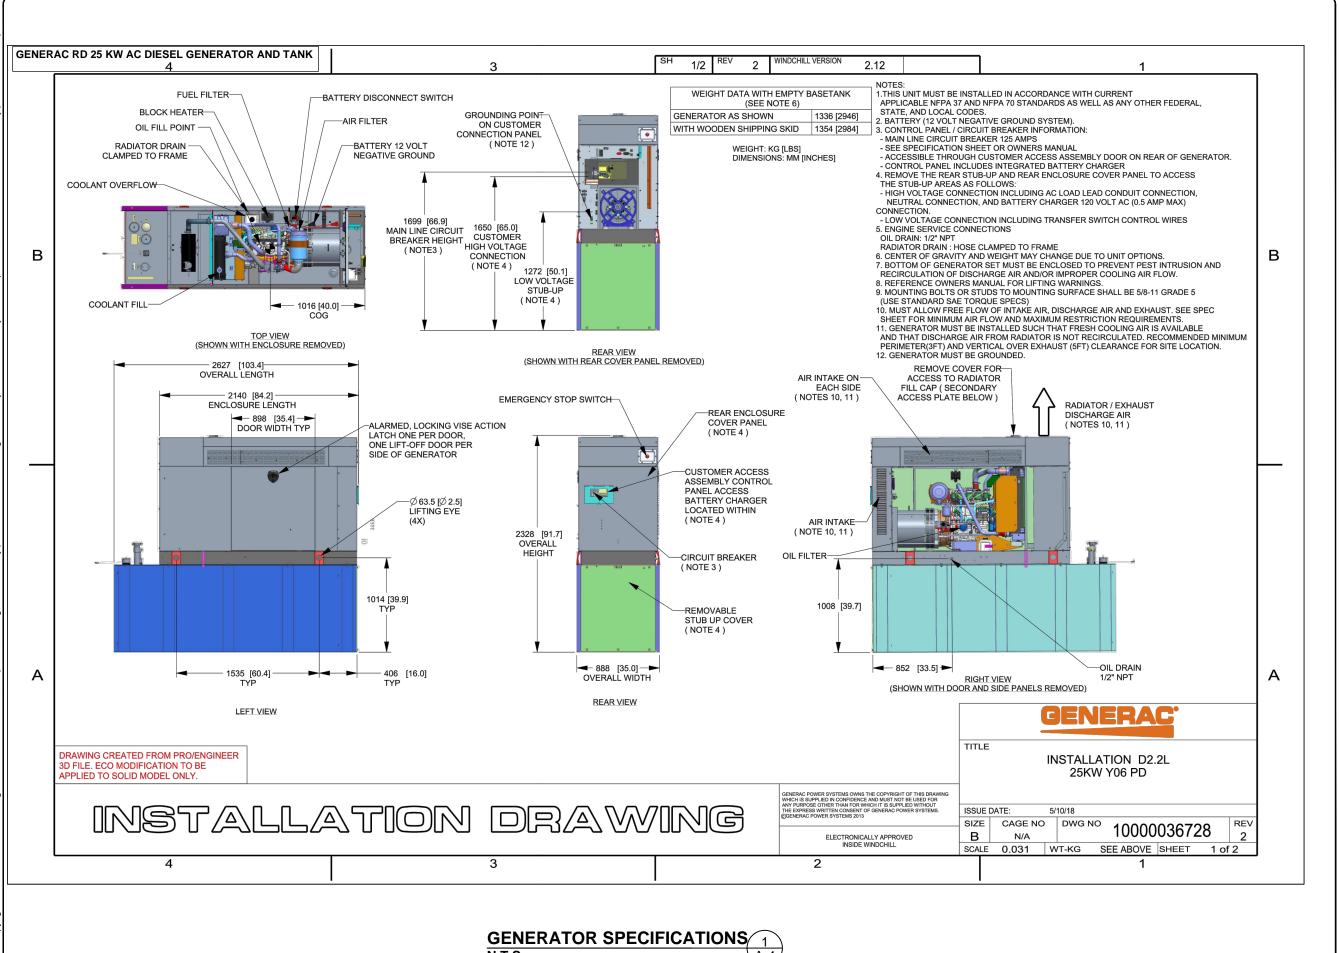

APPLICANT:

T - Mobile - T-Mobile - T-Mobile NORTHEAST LLC

35 GRIFFIN ROAD SOUTH BLOOMFIELD, CT 06002 860-692-7100

PROJECT MANAGER




420 MAIN STREET, BLDG 4 STURBRIDGE, MA 01566 203-275-6669

CONSULTANT:



462 WALNUT STREET NEWTON, MA 02460 617-212-3123

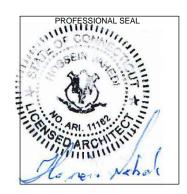

THIS DOCUMENT IS THE DESIGN PROPERTY AND COPYRIGHT OF FORESITE, LLC. AND FOR THE EXCLUSIVE USE BY THE TITLE CLIENT.


DUPLICATION OR USE WITHOUT THE EXPRESS WRITTEN CONSENT OF THE CREATOR IS STRICTLY PROHIBITED. DRAWING SCALES ARE INTENDED FOR 11"x17" SIZE PRINTED MEDIA ONLY. ALL OTHER PRINTED SIZES ARE DEEMED "NOT TO SCALE".

l	REV	DESCRIPTION	DATE
l	Α	PRELIMINARY	04/19/21
l	В	REVISED PER COMMENTS	04/22/21
l			
l			
l			
l			ر ا

CL&P STRUCTURE #1256 SITE NUMBER: CT11001B SITE NAME: CT11001B-GREENWICH RIVERSIDE SITE ADDRESS: 160 SOUND BEACH AVENUE GREENWICH, CT 06870

SHEET TITLE:


A-4: GENERATOR SPECIFICATIONS

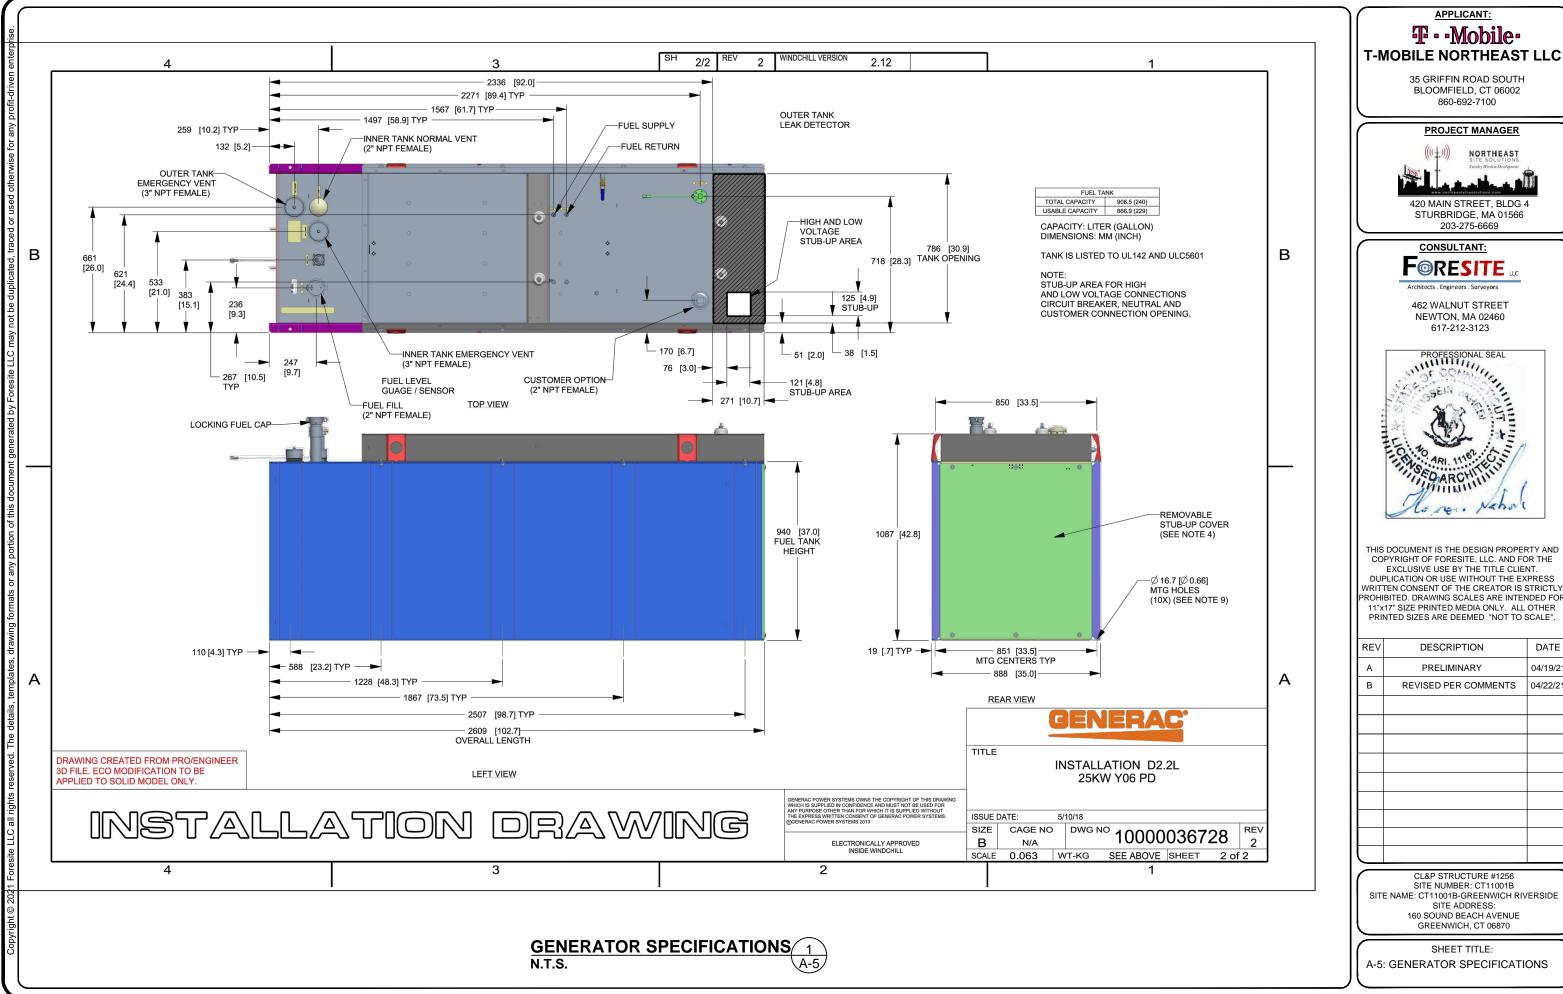

T · · Mobile ·

BLOOMFIELD, CT 06002




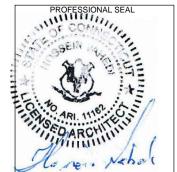

THIS DOCUMENT IS THE DESIGN PROPERTY AND COPYRIGHT OF FORESITE, LLC. AND FOR THE EXCLUSIVE USE BY THE TITLE CLIENT. DUPLICATION OR USE WITHOUT THE EXPRESS WRITTEN CONSENT OF THE CREATOR IS STRICTLY PROHIBITED, DRAWING SCALES ARE INTENDED FOR 11"x17" SIZE PRINTED MEDIA ONLY. ALL OTHER

l	REV	DESCRIPTION	DATE
l	Α	PRELIMINARY	04/19/21
l	В	REVISED PER COMMENTS	04/22/21
l			
l			
l			
l			
ı			

SITE NAME: CT11001B-GREENWICH RIVERSIDE 160 SOUND BEACH AVENUE

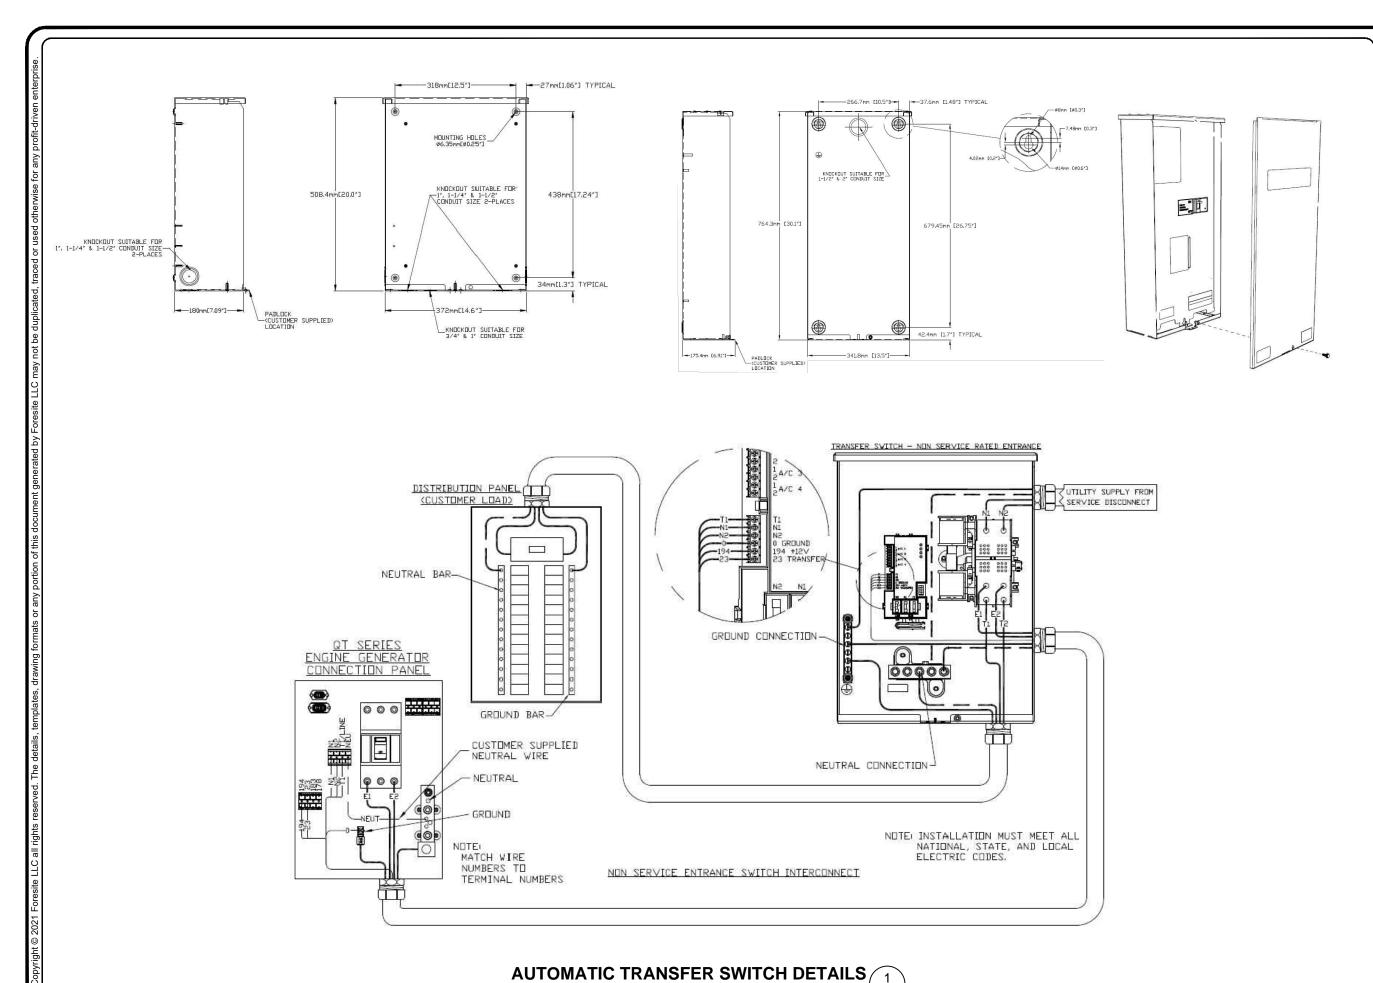

(A-6)

SCALE: N.T.S.

T - Mobile

APPLICANT:

T-MOBILE NORTHEAST LLC

PROJECT MANAGER

35 GRIFFIN ROAD SOUTH BLOOMFIELD, CT 06002 860-692-7100




420 MAIN STREET, BLDG 4 STURBRIDGE, MA 01566 203-275-6669

CONSULTANT:



462 WALNUT STREET NEWTON, MA 02460 617-212-3123

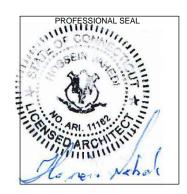


THIS DOCUMENT IS THE DESIGN PROPERTY AND COPYRIGHT OF FORESITE, LLC. AND FOR THE EXCLUSIVE USE BY THE TITLE CLIENT. DUPLICATION OR USE WITHOUT THE EXPRESS WRITTEN CONSENT OF THE CREATOR IS STRICTLY PROHIBITED. DRAWING SCALES ARE INTENDED FOR 11"x17" SIZE PRINTED MEDIA ONLY. ALL OTHER PRINTED SIZES ARE DEEMED "NOT TO SCALE".

l	REV	DESCRIPTION	DATE
l	Α	PRELIMINARY	04/19/21
l	В	REVISED PER COMMENTS	04/22/21
l			
l			
l			
l			
l			
l			
l			
l			
l	l		


CL&P STRUCTURE #1256 SITE NUMBER: CT11001B SITE NAME: CT11001B-GREENWICH RIVERSIDE SITE ADDRESS: 160 SOUND BEACH AVENUE GREENWICH, CT 06870


SHEET TITLE:

A-6: AUTOMATIC TRANSFER SWITCH DETAILS AND SPECIFICATIONS

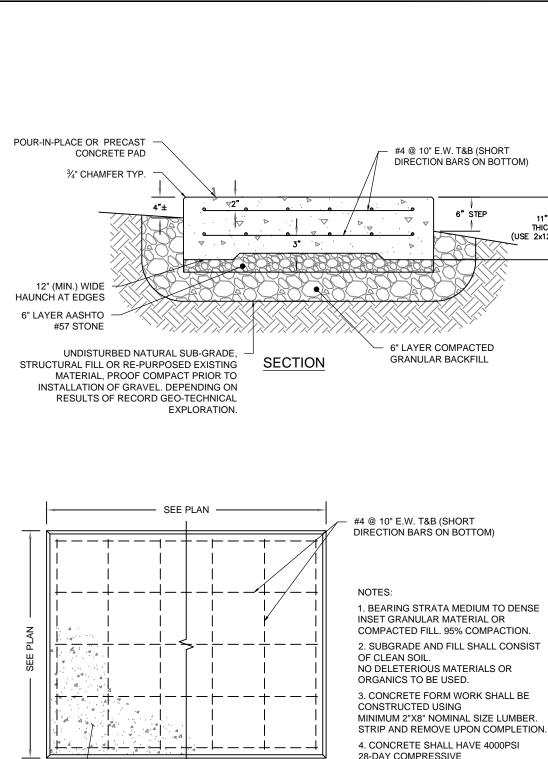

MATCH EXISTING REPLACE GEOFABRIC SURFACE MATERIAL AND STONE AS REQUIRED AND FINISH GRADE · UNDISTURBED SOIL - COMPACTED BACKFILL UTILITY WARNING TAPE BACKFILL (SAND OR NATIVE SOIL) (1) 2" PVC SCHEDULE 80 CONDUIT (1) 1" PVC SCHEDULE 80 CONDUIT W/ CAT-6 CABLE 6" MIN. FROM PIPE TRENCH FACE NOTES: - CONTRACTOR TO HAND DIG ALL NEW 2" MIN. TO ELECTRIC TRENCHES INSIDE THE COMPOUND. - SEPARATION DIMENSIONS TO BE VERIFIED WITH LOCAL UTILITY COMPANY REQUIREMENTS.

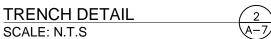


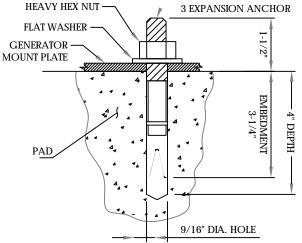


- 1. BOLTS CAN BE INSTALLED 2 DAYS AFTER POURING CONCRETE PROVIDED THE KWIK BOLTS ARE ONLY TIGHTENED TO A SNUG TIGHT CONDITION
- 2. APPLY "HILTI" HIT-RE 500-SD EPOXY TO ALL GAPS TO PREVENT WATER/MOISTURE BUILD-UP.
- INSTALLATION DRAWINGS) ANCHOR BOLTS PER SIDE

ANCHORAGE DETAILS SCALE: N.T.S.



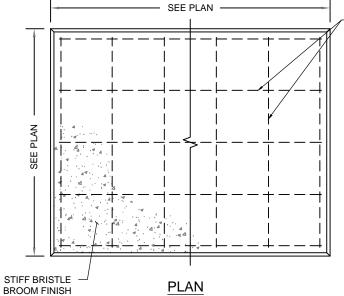

- 1. BEARING STRATA MEDIUM TO DENSE INSET GRANULAR MATERIAL OR COMPACTED FILL. 95% COMPACTION.
- 2. SUBGRADE AND FILL SHALL CONSIST NO DELETERIOUS MATERIALS OR
- 3. CONCRETE FORM WORK SHALL BE MINIMUM 2"X8" NOMINAL SIZE LUMBER.
- 28-DAY COMPRESSIVE STRENGTH WITH 5(±1)% AIR ENTRAINMENT, 4(±1)"SLUMP AND BRISTLE BROOM FINISH.

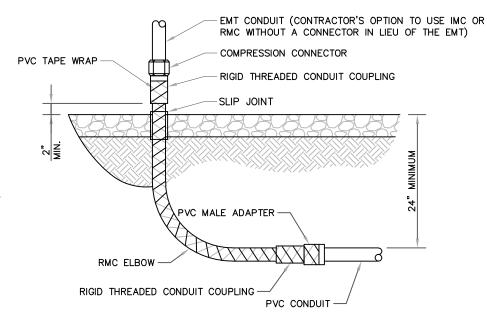

UNDERGROUND CONDUIT STUB UP SCALE: N.T.S

CONTACT WITH THE EARTH SHALL BE CONSIDERED TO BE INSTALLED IN A SEVERELY CORROSIVE ENVIRONMENT AND IS REQUIRED TO HAVE SUPPLEMENTAL PROTECTION AGAINST CORROSION (NEC ARTICLE 342.10(B) & 344.10(B)(1)). THIS PROTECTION SHALL EITHER BE AN APPROVED MANUFACTURER INSTALLED PROTECTIVE COATING ON THE CONDUIT OR SHALL BE (2) LAYERS OF 10 MIL PVC PIPE WRAP TAPE INSTALLED USING OPPOSING SPIRAL WRAPS. ON VERTICAL PIPE THE OUTSIDE LAYER OF TAPE SHALL BE WRAPPED SO AS TO PROVIDE SHEDDING OF WATER (i.e. TAPE SHOULD WRAP IN AN UPWARD DIRECTION WITH LOWER WRAP BEING BENEATH THE WRAP ABOVE). SPIRAL WRAPS SHALL HAVE A MINIMUM OF 1/4" OVERLAP WITH THE PRECEDING TAPE WRAP. ANY OTHER METHODS OF CORROSION PROTECTION SHALL REQUIRE APPROVAL BY THE ENGINEER OF RECORD PRIOR TO BEING USED.

ALL METAL CONDUIT INSTALLED IN DIRECT

NOTES:

3. PROVIDE 6 (SEE MANUFACTURERS



THIS DOCUMENT IS THE DESIGN PROPERTY AND COPYRIGHT OF FORESITE, LLC, AND FOR THE EXCLUSIVE USE BY THE TITLE CLIENT DUPLICATION OR USE WITHOUT THE EXPRESS WRITTEN CONSENT OF THE CREATOR IS STRICTLY PROHIBITED, DRAWING SCALES ARE INTENDED FOR 11"x17" SIZE PRINTED MEDIA ONLY. ALL OTHER PRINTED SIZES ARE DEEMED "NOT TO SCALE".

APPLICANT: T · · Mobile · T-MOBILE NORTHEAST LLC

> 35 GRIFFIN ROAD SOUTH BLOOMFIELD, CT 06002

> > 860-692-7100

PROJECT MANAGER

420 MAIN STREET, BLDG 4

STURBRIDGE, MA 01566

203-275-6669

CONSULTANT:

Architects . Engineers . Surveyors

FORESITE LLC

462 WALNUT STREET

NEWTON, MA 02460

617-212-3123

NORTHEAST

П	REV	DESCRIPTION	DATE
П	Α	PRELIMINARY	04/19/21
П	В	REVISED PER COMMENTS	04/22/21
П			
П			
П			
П			
l			
l			
l			
l			
ľ			

CL&P STRUCTURE #1256 SITE NUMBER: CT11001B SITE NAME: CT11001B-GREENWICH RIVERSIDE SITE ADDRESS: 160 SOUND BEACH AVENUE GREENWICH, CT 06870

SHEET TITLE: A-7: CONCRETE PAD AND UNDERGROUND CONDUIT DETAILS

CONCRETE PAD DETAILS SCALE: N.T.S.

11" MIN

(USE 2x12 TO FORM)

NFPA - NATIONAL FIRE PROTECTION ASSOCIATION

UL - UNDERWRITERS LABORATORIES

NEC - 2017 NATIONAL ELECTRICAL CODE NEMA - NATIONAL ELECTRIC

MANUFACTURERS ASSOCIATION

OSHA - OCCUPATIONAL SAFETY AND HEALTH ACT IBC - 2015 INTERNATIONAL BUILDING CODE

- 2. ALL ELECTRICAL ITEMS SHALL BE U.L. APPROVED OR LISTED AND PRODUCED PER SPECIFICATION REQUIREMENTS.
- 3. THE ELECTRICAL WORK INCLUDES ALL LABOR AND MATERIAL DESCRIBED BY DRAWINGS AND SPECIFICATION INCLUDING INCIDENTAL WORK TO PROVIDE COMPLETE OPERATING AND APPROVED ELECTRICAL SYSTEM.
- 4. GENERAL CONTRACTOR SHALL PAY FEES FOR PERMITS, AND RESPONSIBLE FOR OBTAINING SAID PERMITS AND COORDINATION OF INSPECTIONS.
- 5. ELECTRICAL AND TELCO WIRING OUTSIDE A BUILDING AND EXPOSED TO WEATHER SHALL BE IN WATER TIGHT GALVANIZED RIGID STEEL CONDUITS OR SCHEDULE 80 PVC (AS PERMITTED BY CODE) ND WHERE REQUIRED IN LIQUID TIGHT FLEXIBLE METAL OR NONMETALLIC CONDUITS.
- 6. RIGID STEEL CONDUITS SHALL BE GROUNDED AT BOTH ENDS.
- 7. ELECTRICAL WIRING SHALL BE COPPER WITH TYPE XHHW, THWN, OR THIN INSULATION.
- 8. ALL EQUIPMENT LOCATED OUTSIDE SHALL HAVE NAME 3R ENCLOSURE.
- 9. GROUNDING SHALL COMPLY WITH NEC ART. 250.
- 10. GROUNDING COAX CABLE SHIELDS MINIMUM AT BOTH ENDS USING MANUFACTURES COAX CABLE GROUNDING KITS SUPPLIED BY PROJECT OWNER.
- 11. USE #6 COPPER STRANDED WIRE WITH GREEN COLOR INSTALLATION FOR ABOVE GRADE GROUNDING (UNLESS OTHERWISE SPECIFIED) AND #2 SOLID TINNED BARE COPPER WIRE FOR BELOW GRADE GROUNDING AS INDICATED ON THE GROUND.
- 12. ALL GROUND CONNECTION TO BE BURNDY HYGROUND COMPRESSION TYPE CONNECTORS OR CADWELD EXOTHERMIC WELD. DO NOT ALLOW BARE COPPER WIRE TO BE IN CONTACT WITH GALVANIZED STEEL.
- 13. ROUTE GROUNDING CONDUCTORS ALONG THE SHORTEST AND STRAIGHTEST PATH POSSIBLE, EXCEPT AS OTHERWISE INDICATED. GROUNDING LEADS SHOULD NEVER BE BENT AS RIGHT ANGLE. ALWAYS MAKE AT LEAST 12" RADIUS BENDS. #6 WIRE CAN BE BENT AT 6" RADIUS WHEN NECESSARY BOND ANY METER OBJECTS WITHIN 7 FEET OF PROPOSED EQUIPMENT OR CABINET TO MASTER GROUND BAR.
- 14. CONNECTIONS TO MGB SHALL BE ARRANGED IN THREE MAIN GROUPS: SURGE PROCEDURES (COAXIAL CABLE GROUND KITS, TELCO AND POWER PANEL GROUND); (GROUNDING ELECTRODE RING OR BUILDING STEEL); NON-SURGING OBJECTS (EGB GROUND IN RBS UNIT).
- 15. CONNECTIONS TO GROUND BARS SHALL BE MADE WITH TWO HOLE COMPRESSION TYPE COPPER LUGS. APPLY OXIDE INHIBITING COMPOUND TO ALL LOCATIONS.
- 16. APPLY OXIDE INHIBITING COMPOUND TO ALL COMPRESSION TYPE GROUND CONNECTION.
- 17. TEST COMPLETED GROUND SYSTEM AND RECORD RESULTS FOR PROJECT CLOSE-OUT DOCUMENTATION.
- 18. BOND ANY METAL OBJECTS WITHIN 7 FEET OF PROPOSED EQUIPMENT OR CABINET TO MASTER GROUND BAR.
- 19. VERIFY PROPOSED SERVICE UPGRADE WITH LOCAL UTILITY COMPANY PRIOR TO CONSTRUCTION.
- 20. EXISTING UNDERGROUND UTILITY LOCATIONS ARE UNKNOWN. GENERAL CONTRACTOR SHALL HAND-EXCAVATE TO REQUIRED SUB-GRADE DEPTH, SUFFICIENT TEST HOLES OR AS DIRECTED / REQUIRED BY CONSTRUCTION MANAGER. ALL PROPOSED UNDERGROUND UTILITY TRENCHES SHALL BE HAND-EXCAVATE AS REQUIRED. GENERAL CONTRACTOR IS RESPONSIBLE FOR ANY REQUIRED SPECIAL TEMPORARY PROTECTION OF, PHYSICAL DAMAGE TO, OR REPAIR OF EXISTING UNDERGROUND CONDUIT INCLUDING RESTORATION OF SERVICE.
- 21. PROVIDE SLIP JOINS WHERE CONDUITS TRANSITION FROM UNDERGROUND TO ABOVE GROUND.

NOTES:


DIAGRAM AS SHOWN, IS A GENERIC ROUTING SCHEMATIC BASED ON AVAILABLE INFORMATION AND MAY NOT REPRESENT ACTUAL FIELD CONDITIONS. CONTRACTOR SHOULD INSTALL THE GENERATOR, EQUIPMENT AND CONNECTIONS BASED ON VERIFIED ELECTRICAL AUDITS AND PER MANUFACTURER'S INSTALLATION GUIDELINES AS WELL AS ALL APPLICABLE LOCAL AND NATIONAL CODES AND REQUIREMENTS.

GROUNDING NOTES:

- 1. GROUNDING SHALL COMPLY WITH NEC ART. 250 AND MANUFACTURER'S RECOMMENDATIONS. TIE INTO THE EXISTING GROUNDING SYSTEM.
- 2. CONTRACTOR SHALL INSTALL GROUND RODS ON ALL UNDERGROUND GROUNDING RUNS LONGER THAN 10'. GROUND RODS WILL BE INSTALLED ON 20' CENTERS MAXIMUM.
- 3. ALL DOWN CONDUCTORS MUST GO DOWN PER NFPA 780.
- 4. CONTRACTOR SHALL NOTIFY THE CONSTRUCTION MANAGER WHEN THE GROUNDING SYSTEM IS COMPLETE. THE CONSTRUCTION MANAGER SHALL INSPECT THE GROUNDING SYSTEM PRIOR TO BACKFILLING.
- 5. CONTRACTOR MY USE EXISTING CONDUITS AND CONDUCTORS PROVIDED THEY ARE IN GOOD CONDITION AND ARE SUFFICIENTLY RATED.

(3) #1/0 & (1) #6G (CU THHN) IN 2"C -(P) ON-BOARD 125A CIRCUIT BREAKER (HEIGHT 66.9")(SEE SHEET A-3) (GENERATOR DISCONNECTING MEANS SHALL COMPLY WITH NEC 445.18 (B)) (P) T-MOBILE 200A - FUSED 120/240 V SINGLE PHASE DISCONNECT (P) GENERAC 25 KW AC DIESEL GENERATOR 120/240-1φ-3W (P) (2) 1/2" CONDUIT WITH (3) 3/0 & (1) #4 GND (P) GENERAC 200A, 240V **AUTOMATIC TRANSFER SWITCH** (P) 1/2" CONDUIT WITH (ALL EXTERIOR ELECTRICAL (4) #12 & (2) #12 GND (P) 1" CONDUIT WITH PULL STRING **EQUIPMENT TO HAVE NEMA 3R** TO POWER PANEL FROM GENERATOR TO ATS **ENCLOSURES. SEE NOTE 8)** FOR CONTROL AND ALARM WIRING MTS | A 0-(E) 200A GENERATOR RECEPTACLE (E) POWER PANEL (E) PPC

TO (E) EQUIPMENT

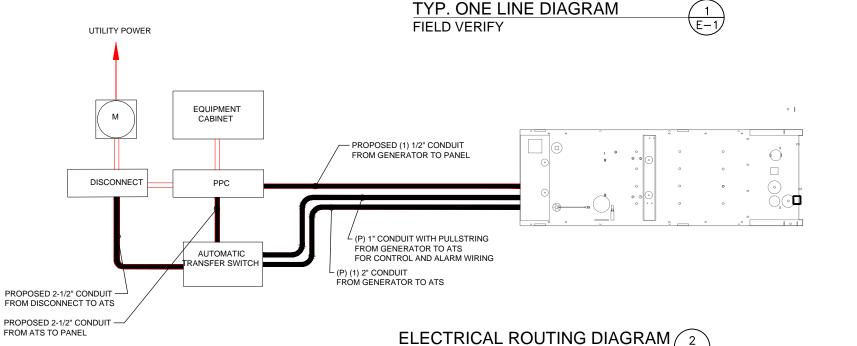

SCALE: N.T.S

APPLICANT:

T • • Mobile • I T-Mobile • I T-MOBILE NORTHEAST LLC

35 GRIFFIN ROAD SOUTH BLOOMFIELD, CT 06002 860-692-7100

PROJECT MANAGER



420 MAIN STREET, BLDG 4 STURBRIDGE, MA 01566 203-275-6669

CONSULTANT:



462 WALNUT STREET NEWTON, MA 02460 617-212-3123




THIS DOCUMENT IS THE DESIGN PROPERTY AND COPYRIGHT OF FORESITE, LLC. AND FOR THE EXCLUSIVE USE BY THE TITLE CLIENT.
DUPLICATION OR USE WITHOUT THE EXPRESS WRITTEN CONSENT OF THE CREATOR IS STRICTLY PROHIBITED. DRAWING SCALES ARE INTENDED FOR 11"x17" SIZE PRINTED MEDIA ONLY. ALL OTHER PRINTED SIZES ARE DEEMED "NOT TO SCALE".


REV	DESCRIPTION	DATE
Α	PRELIMINARY	04/19/21
В	REVISED PER COMMENTS	04/22/21

CL&P STRUCTURE #1256 SITE NUMBER: CT11001B SITE NAME: CT11001B-GREENWICH RIVERSIDE SITE ADDRESS: 160 SOUND BEACH AVENUE GREENWICH, CT 06870

SHEET TITLE:

E-1: ELECTRICAL DETAILS

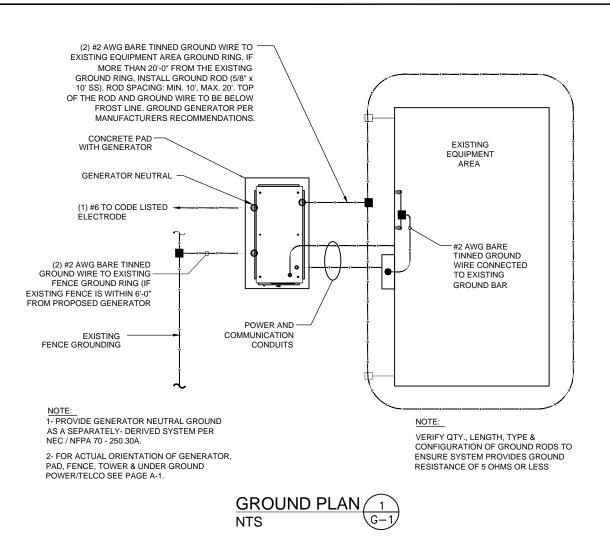

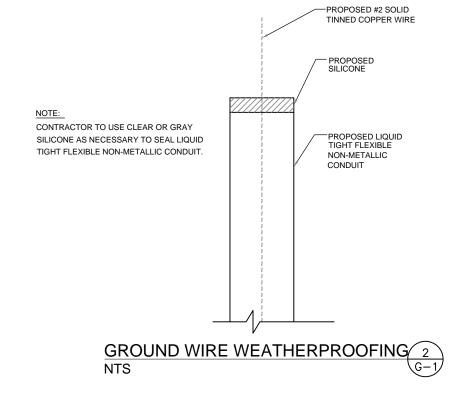

APPLICANT: T • • Mobile • T-MOBILE NORTHEAST LLC

35 GRIFFIN ROAD SOUTH BLOOMFIELD, CT 06002 860-692-7100

PROJECT MANAGER




420 MAIN STREET, BLDG 4 STURBRIDGE, MA 01566 203-275-6669

CONSULTANT:



462 WALNUT STREET NEWTON, MA 02460 617-212-3123

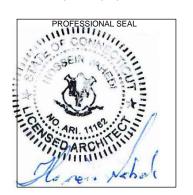

THIS DOCUMENT IS THE DESIGN PROPERTY AND COPYRIGHT OF FORESITE, LLC. AND FOR THE EXCLUSIVE USE BY THE TITLE CLIENT.
DUPLICATION OR USE WITHOUT THE EXPRESS WRITTEN CONSENT OF THE CREATOR IS STRICTLY PROHIBITED. DRAWING SCALES ARE INTENDED FOR 11"x17" SIZE PRINTED MEDIA ONLY. ALL OTHER PRINTED SIZES ARE DEEMED "NOT TO SCALE".

П	REV	DESCRIPTION	DATE
	Α	PRELIMINARY	04/19/21
l	В	REVISED PER COMMENTS	04/22/21
l			
l			
l			

CL&P STRUCTURE #1256 SITE NUMBER: CT11001B SITE NAME: CT11001B-GREENWICH RIVERSIDE SITE ADDRESS: 160 SOUND BEACH AVENUE GREENWICH, CT 06870

SHEET TITLE:


G-1: GROUNDING DETAILS

Exhibit D

T··Mobile· Engineering & Operations

Generac RD025 Design Document

Diesel, AC, 25kW External Fill Tank Model#7192-0 SKU#33651

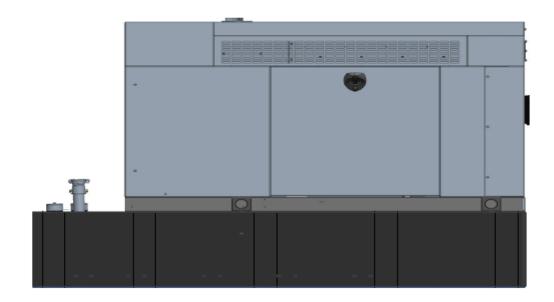

The following are responsible for this project document:

Kevin Smith SR. Engineer (770) 256-3594

Project Design Spec Revision	1.0	Last Date:08/23/2018	5/14/2018
Final doc URL (~Dnnnnn):			
Location	Use the InfoRouter Search (Advanced) putting the Document ID (nnnnnn without the D) to find the location of the master document.		
Template URL:	http://docs.eng.t-mobile.com/InfoRouter/docs/~D423750 Slightly updated 1/2011		



Table of Contents

1	Introduction / Project Summary	3
1.1	Purpose of Project	3
1.2	Feature Description	3
1.3	Dimensions	3
2	Fuel Tanks	4
3	RXSC200A3 ATS/ Controller	4
3.1	Hardware	4
4	Architecture/Alarms	7
4.1	Interfaces and Alarming	7
5	Regulatory Requirements	9
6	Configuration/Diagrams	9
7	Maintenance	14

Rev. 1.0 5/14/2018



1 Introduction / Project Summary

1.1 Purpose of Project


T-Mobile's nationwide cell site hardening plan is providing a refuellable backup power system capable of powering a site for a minimum of 48 hours before refueling is required. The purpose of this project is to give T-Mobile customers reliable service during power outages and provide a sufficient layer of coverage. This design document is for Generac's RD025 model#7192-0, which is a Diesel AC generator with a capacity of 25kW.

1.2 Feature Description

The Generac RD025 is a 25kW AC, diesel generator is one of the generators selected as part of the T-Mobile RFP in support of the nationwide cell site hardening plan. The RD025 has a Level 2 acoustic enclosure, 3 phase sensing, and +-0.25% digital voltage regulation. It is equipped with RS232, RS485 and canbus remote ports and Evolution control panel. It is also equipped with a automatic transfer switch, the RXSC200A3 (Automatic Transfer Switch) Controls the process of transferring commercial AC power and generator power. The RXSC200A3 is a 200Amp, switch that is programmed to perform engine test runs and also has adjustable engine run time capabilities. For RXSC200A3 Owners Manual and full feature descriptions LINK.

1.3 Dimensions

The dimensions of a level 2 Acoustic Enclosure L \times W \times H in inches 103.4 \times 35 \times 91.7. T-Mobile requires a 36-inch radius around the generator that will cover the 18" door swing on the generator.

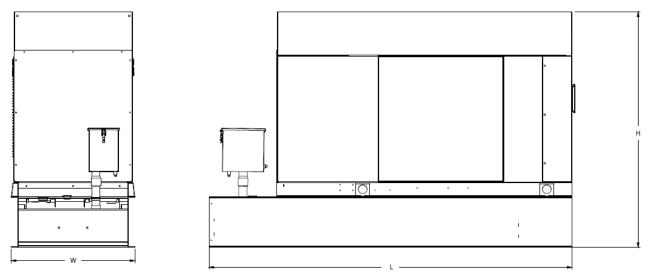

Weights and Dimensions


	Unit Weight - Ibs	Unit Weight with Skid - Ibs	Dimensions (L x W x H) - in
ſ	2,123	2,161	103.4 x 35.0 x 73.8

Rev. 1.0 5/14/2018



2 Fuel Tanks

The RD025 has a 102.7" 240 Gallon Double-Wall UL142 Base tank to provide 98 hours of backup power at full load deployed on site. Below is the Install drawing for the 240-gallon tank for the RD025kW.

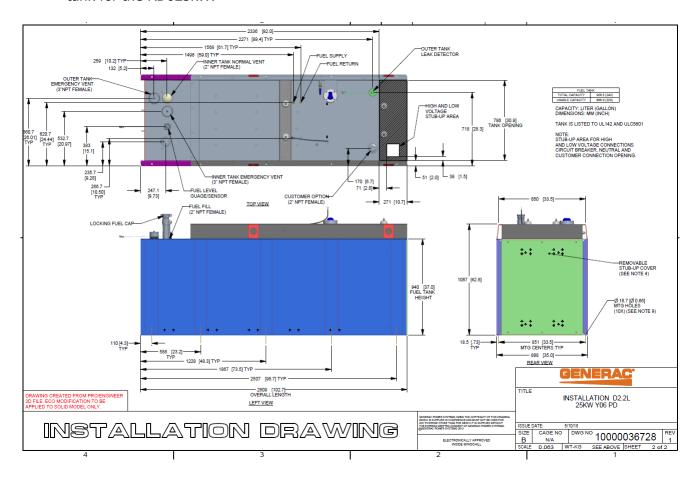

3 RXSC200A3 ATS/ Controller

3.1 Hardware

The RD025 will come with a RXSC200A3 and an Evollution controller. The sites considered for the RD025 should not have a DC power consumption above 20kW




RXSC200A3 Link

RXSC200A3 install drawing Link

Evollution controller spec sheet Link

RD025 installation drawings and supporting documentation Link

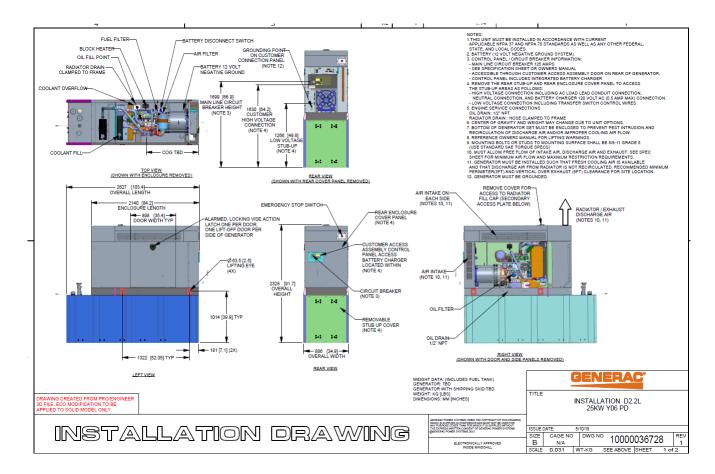

3.2 RXSC200A3 Automatic Transfer Switch


The RXSC200A3 (Automatic Transfer Switch) is equiped with the following functions. Utility voltage drop-out <65%. Timer to Generator start: 10 second factory set, adjustable between 2-1500 seconds. Engine Warm up delay: 5 seconds. Standby Voltage Sensor: 65% for 5 seconds. Utility Voltage Pickup >80%. Re-Transfer Time Delay: 15 seconds. Engine Cool-Down Timer: 60 seconds. Exerciser: 5 or 12 minute adjustable weekly/by-weekly/monthly. The transfer switch can also be operated manually without power applied


Rev. 1.0 5/14/2018



RXSC200A3 Dimensions

Model		RXSC200A3
Height	HI	17.24/437.9
(in./mm)	H2	20/508
Width	WI	12.5/317.5
(in./mm)	W2	14.6/370.8
Depth (in./mm)		7.09/180.1
Weight (lbs./kilos)		20/9.07

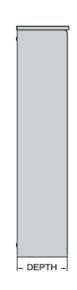

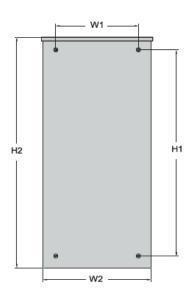



4 Architecture/Alarms

4.1 Interfaces and Alarming

The generator will be monitored by external alarms, conduit and cat five cables have to be installed from the Evolution Controllers Low Voltage Box located in the Generac generator to the appropriate cell site equipment. Nokia FSEB or FSEE and in Ericsson the SAU.

At a Nokia site, this connection is at the FSEB or an FSEE module. For the wiring diagram and instructions for the FSEB click the <u>Link</u>. (The FSEE is the Nokia module that will be replacing the FSEB. For details on the FSEE contact: HQNokiaCellsiteDesigns@T-Moblie.com)

Ericsson sites will connect to the SAU module via OVP Expansion Kit for 8 External Alarms. Product number: UTOVP-ALM8EXP. For the wiring diagram and instructions for this click the link.

The RXSC200A3 has auxiliary contacts that will facilitate the *ATS in Emergency position* alarm and will be a Normally Closed contact. Below is the wiring schematic for this contact and it can be found in the RXSC200A3 owners manual.

Auxiliary Contact

See *Figure 3-4*. If desired, there is one normally-closed Auxiliary Contact (A) on the transfer switch to operate customer accessories, remote advisory lights, or remote annunciator devices. A suitable power source must be connected to the common terminal. If needed, an extra auxiliary contact can be added.

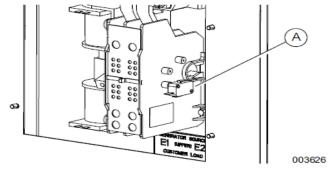


Figure 3-4. Auxiliary Contact

The auxiliary contact is normally closed when the transfer switch is in utility mode. The contacts will open when the transfer switch is in the standby power mode.

NOTE: Auxiliary Contact is rated 10 amps at 125 or 250 volts AC, and 0.6 amps at 125 volts DC.

ACAUTION


Equipment damage. Exceeding rated voltage and current will damage the auxiliary contacts. Verify that voltage and current are within specification before energizing this equipment. (000134a)

Rev. 1.0 5/14/2018



T-Mobile has four relays available from the Generac controller that are user-defined. T-Mobile can have four-alarm categories and a limitless number of subcategories. T- Mobile will utilize Normally Closed (NC) dry contacts for alarms in Low Voltage Connection box in the spare outputs section. Ericsson cabinets need to be equipped with the alarm expansion kit (UTOVP-ALM8EXP) to handle external alarms.

Customer Connections Inside the RD025

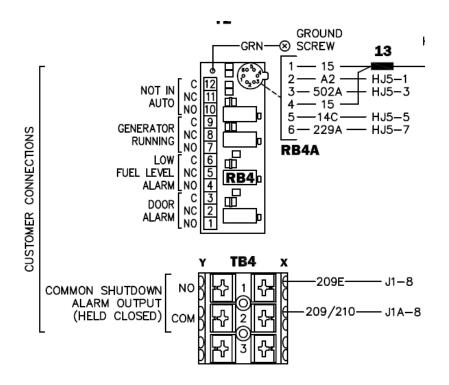

Ericsson UTOVP- ALM8EXP





Evolution Controller Customer		
Connections	Nokia FSEB Alarm Connections 13-24	T-Mobile Standard Alarms
NC#8-Gen Running	NC 4110 grd 4111 pin 13	Generator Running
NC#11-Not In Auto	NC 4110 grd 4111 pin 14	Generator Alarm Critical
NC#2-Door Alarm	NC 4110 grd 4111 pin 15	Generator Alarm NSI
NC#5-Low Fuel	NC 4110 grd 4111 pin 16	Low Fuel
RXSC200A3-Auxiliary Contacts	NC 4110 grd 4111 pin 17	ATS in Emergency Position

Evolution Controller Customer		
Connections	Ericsson Alarm 8expConnections	T-Mobile Standard Alarms
NC#8- Gen. Running	NC - A5	Generator Running
NC#11-Not In Auto	NC - A6	Generator Alarm Critical
NC#2-Door Alarm	NC - A7	Generator Alarm NSI
NC#5-Low Fuel	NC - A8	Low Fuel
RXSC200A3-Auxiliary Contacts	NC - A9	ATS in Emergency Position

5 Regulatory Requirements

Level 2 Acoustic Enclosure provides a noise level of 67.5dBA. It is EPA certified and meets NFPA 99 and 110 requirements(NFPA National Fire Protection Association). The RD025 generator engines is a tier 4 engine and meets the EPA final standards.

6 Configuration/Diagrams

The physical configuration of the Generator and the RXSC200A3 is, ATS before the PPC to ensure overcurrent protection when commercial power is restored. The RD025 and the RXSC200A3 has to be wired to Commercial AC power.


Rev. 1.0 5/14/2018




Commercial Power Connection Points On The RXSC200A3

Rev. 1.0 5/14/2018



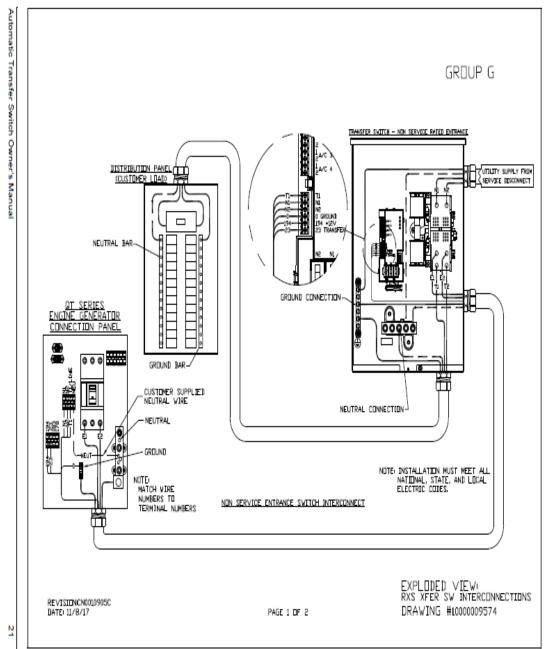




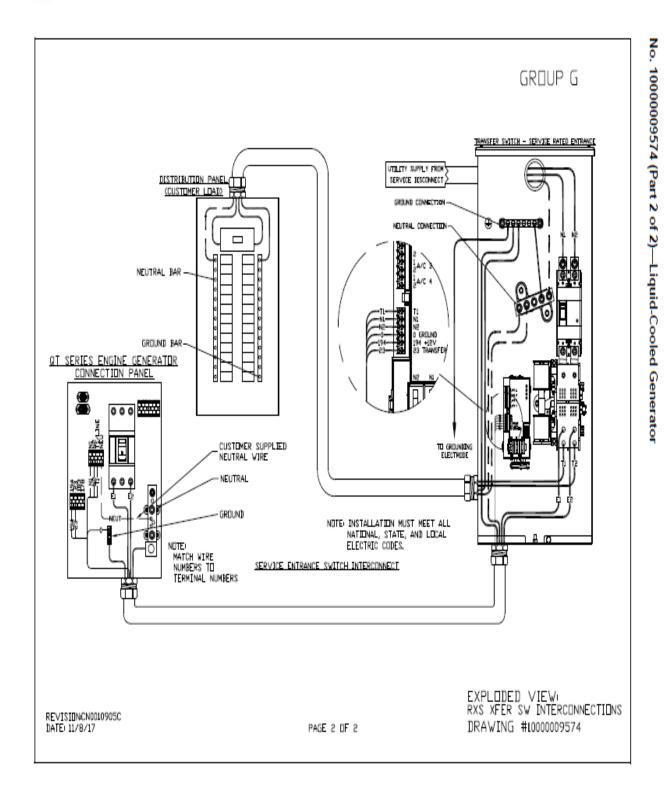

Rev. 1.0 5/14/2018



Compound Diagram:

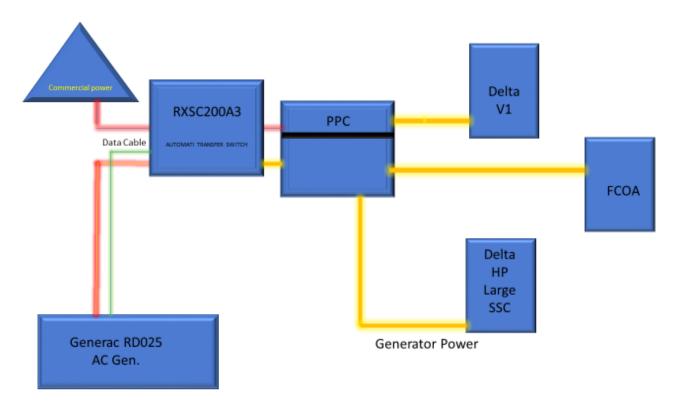

Rev. 1.0 5/14/2018



7 Maintenance

T-Mobile is recommending preventive maintenance to be performed every 250 hours of runtime or every 12 months, whichever comes first.

T-Mobile requires this minimum service checklist for the generator engine:

- Check engine mounts and support. Tighten fasteners.
- Check all the engine hoses and clamps for proper fit, and any signs of cracking and fatigue from wear.
- Inspect all belts for signs of cracking and fatigue from wear and adjust for proper tension.
- Inspect the exhaust system for leaks, burns and wet stacking. Drain exhaust line and tighten any clamps and flange bolts.
- Inspect silencer and plumbing for leaks, cracks or any other signs of wear.
- Inspect the system for fuel, oil and coolant leaks and signs of corrosion.
- Replace water separator.
- Replace water filter/ conditioner.
- Check Anti-Freeze (Spector-Analysis).
- Check coolant level and add, if needed.
- Inspect radiator mounting for signs or wear and cracking.
- Inspect/ clean air filter and change per manufacturer specifications.
- Inspect air intakes and outlets and tighten clamps and brackets, if applicable.

Rev. 1.0 5/14/2018

- Replace fuel filter.
- Inspect the carburetor fuel injection system, fuel injection pump and choke, if equipped. Adjust to manufacturers specifications.
- Change engine oil, oil filter and record the date on the filter casing.
- Check engine heater operation, if equipped.
- Check and adjust the battery charger operations, and charge rate within the manufacturer's recommended operating specifications.




- Inspect the battery housing, hardware connections, and cables for corrosion and wear.
- Check the battery electrolyte levels and specific gravity levels.
- Load test generator battery.
- Check, adjust and record generator output voltage, as necessary.
- Check and record the alternator charge rate.
- During inspection run the generator for 30 minutes under load. During this time, and after the
 engine is at full operational speed and has reached engine operating temperature; determine
 and record the condition of all inspection points: oil pressure, water/ coolant temperature,
 Fuel pressure, generator gauge, indicator operations, generator battery.
- Check the engine timing and adjust to manufacturers specifications, if necessary.

Rev. 1.0 5/14/2018

- Inspect, adjust and record governor and frequency, if necessary.
- Verify that the low fuel alarm is operational and configured correctly to trigger when the fuel tank reaches 50% of fuel tank capacity.

Check fuel level and refuel the generator during the preventive/ corrective maintenance visit.

Exhibit E

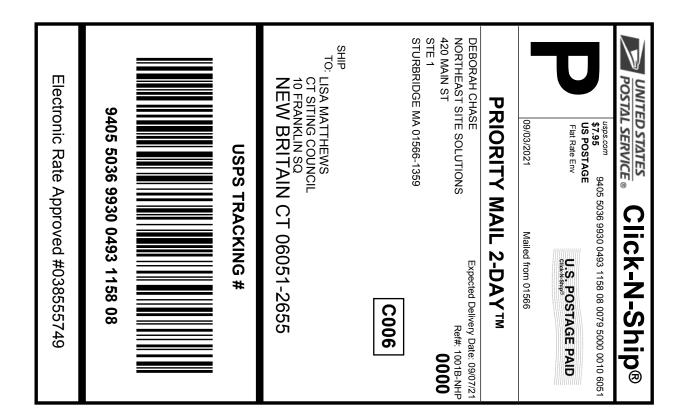



Instructions

- 1. Each Click-N-Ship® label is unique. Labels are to be used as printed and used only once. DO NOT PHOTO **COPY OR ALTER LABEL.**
- 2. Place your label so it does not wrap around the edge of the package.
- 3. Adhere your label to the package. A self-adhesive label is recommended. If tape or glue is used, DO NOT TAPE OVER BARCODE. Be sure all edges are secure.
- 4. To mail your package with PC Postage®, you may schedule a Package Pickup online, hand to your letter carrier, take to a Post Office™, or drop in a USPS collection box.
- 5. Mail your package on the "Ship Date" you selected when creating this label.

Click-N-Ship® Label Record

USPS TRACKING #: 9405 5036 9930 0493 1158 08

542704895 09/02/2021 Trans. #: Print Date: Ship Date: 09/03/2021 09/07/2021 Delivery Date:

Priority Mail® Postage: Total:

\$7.95 \$7.95

Ref#: 1001B-NHP

From: DEBORAH CHASE

NORTHEAST SITE SOLUTIONS

420 MAIN ST

STE 1


STURBRIDGE MA 01566-1359

LISA MATTHEWS

CT SITING COUNCIL 10 FRANKLIN SQ

NEW BRITAIN CT 06051-2655

Exhibit F

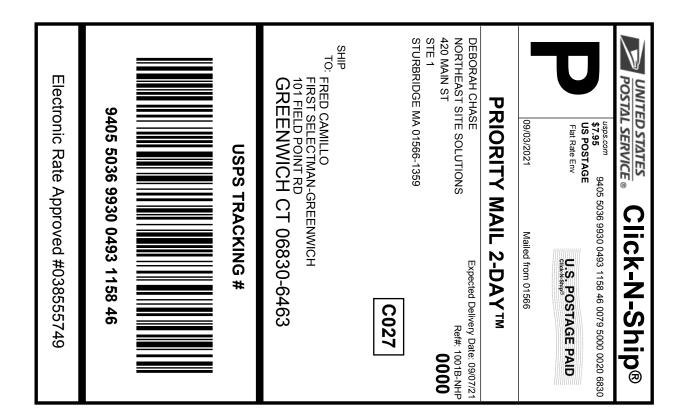



Instructions

- 1. Each Click-N-Ship® label is unique. Labels are to be used as printed and used only once. DO NOT PHOTO **COPY OR ALTER LABEL.**
- 2. Place your label so it does not wrap around the edge of the package.
- 3. Adhere your label to the package. A self-adhesive label is recommended. If tape or glue is used, DO NOT TAPE OVER BARCODE. Be sure all edges are secure.
- 4. To mail your package with PC Postage®, you may schedule a Package Pickup online, hand to your letter carrier, take to a Post Office™, or drop in a USPS collection box.
- 5. Mail your package on the "Ship Date" you selected when creating this label.

Click-N-Ship® Label Record

USPS TRACKING #: 9405 5036 9930 0493 1158 46

542704895 09/02/2021 Trans. #: Print Date: Ship Date: 09/03/2021 09/07/2021 Delivery Date:

Priority Mail® Postage: Total:

\$7.95 \$7.95

Ref#: 1001B-NHP

From: DEBORAH CHASE

NORTHEAST SITE SOLUTIONS

420 MAIN ST


STE 1

STURBRIDGE MA 01566-1359

FRED CAMILLO

FIRST SELECTMAN-GREENWICH

101 FIELD POINT RD GREENWICH CT 06830-6463

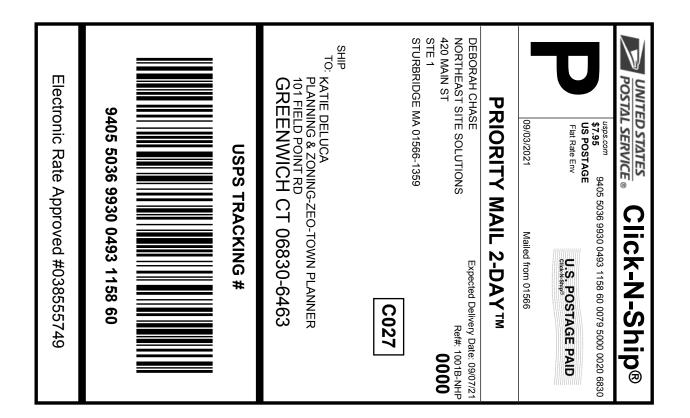



Instructions

- 1. Each Click-N-Ship® label is unique. Labels are to be used as printed and used only once. DO NOT PHOTO **COPY OR ALTER LABEL.**
- 2. Place your label so it does not wrap around the edge of the package.
- 3. Adhere your label to the package. A self-adhesive label is recommended. If tape or glue is used, DO NOT TAPE OVER BARCODE. Be sure all edges are secure.
- 4. To mail your package with PC Postage®, you may schedule a Package Pickup online, hand to your letter carrier, take to a Post Office™, or drop in a USPS collection box.
- 5. Mail your package on the "Ship Date" you selected when creating this label.

Click-N-Ship® Label Record

USPS TRACKING #: 9405 5036 9930 0493 1158 60

542704895 09/02/2021 Trans. #: Print Date: Ship Date: 09/03/2021 09/07/2021 Delivery Date:

Priority Mail® Postage: \$7.95 Total:

\$7.95

Ref#: 1001B-NHP

From: DEBORAH CHASE

NORTHEAST SITE SOLUTIONS

420 MAIN ST


STE 1

STURBRIDGE MA 01566-1359

KATIE DELUCA

PLANNING & ZONING-ZEO-TOWN PLANNER

101 FIELD POINT RD GREENWICH CT 06830-6463

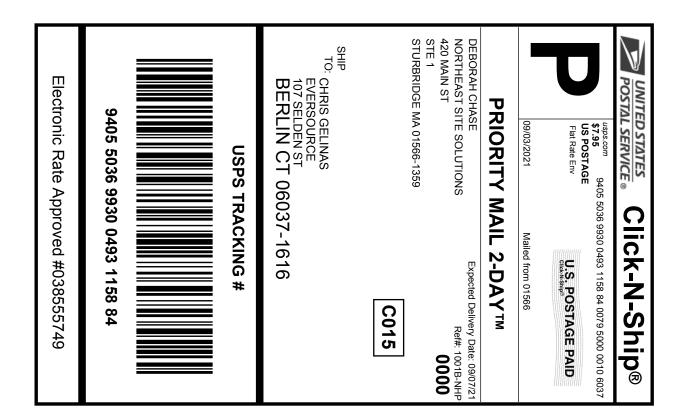



Instructions

- 1. Each Click-N-Ship® label is unique. Labels are to be used as printed and used only once. DO NOT PHOTO **COPY OR ALTER LABEL.**
- 2. Place your label so it does not wrap around the edge of the package.
- 3. Adhere your label to the package. A self-adhesive label is recommended. If tape or glue is used, DO NOT TAPE OVER BARCODE. Be sure all edges are secure.
- 4. To mail your package with PC Postage®, you may schedule a Package Pickup online, hand to your letter carrier, take to a Post Office™, or drop in a USPS collection box.
- 5. Mail your package on the "Ship Date" you selected when creating this label.

Click-N-Ship® Label Record

USPS TRACKING #: 9405 5036 9930 0493 1158 84

542704895 09/02/2021 Trans. #: Print Date: Ship Date: 09/03/2021 09/07/2021 Delivery Date:

Priority Mail® Postage: \$7.95 \$7.95 Total:

From: DEBORAH CHASE Ref#: 1001B-NHP

NORTHEAST SITE SOLUTIONS


420 MAIN ST

STE 1

STURBRIDGE MA 01566-1359

CHRIS GELINAS

EVERSOURCE 107 SELDEN ST BERLIN CT 06037-1616

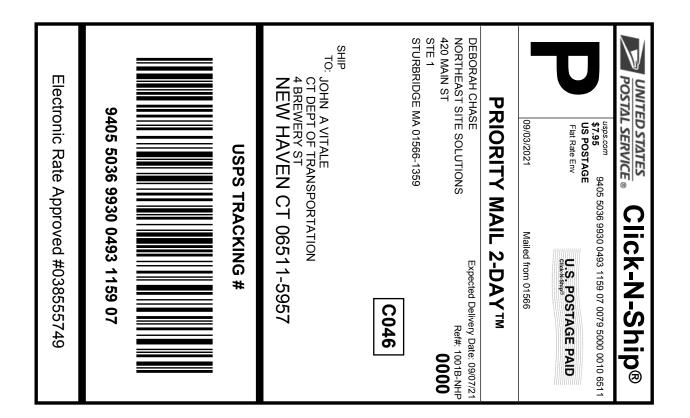



Instructions

- 1. Each Click-N-Ship® label is unique. Labels are to be used as printed and used only once. DO NOT PHOTO **COPY OR ALTER LABEL.**
- 2. Place your label so it does not wrap around the edge of the package.
- 3. Adhere your label to the package. A self-adhesive label is recommended. If tape or glue is used, DO NOT TAPE OVER BARCODE. Be sure all edges are secure.
- 4. To mail your package with PC Postage®, you may schedule a Package Pickup online, hand to your letter carrier, take to a Post Office™, or drop in a USPS collection box.
- 5. Mail your package on the "Ship Date" you selected when creating this label.

Click-N-Ship® Label Record

USPS TRACKING #: 9405 5036 9930 0493 1159 07

542704895 09/02/2021 Trans. #: Print Date: Ship Date: 09/03/2021 09/07/2021 Delivery Date:

Priority Mail® Postage: \$7.95 \$7.95 Total:

From: DEBORAH CHASE Ref#: 1001B-NHP

NORTHEAST SITE SOLUTIONS

420 MAIN ST

STE 1

STURBRIDGE MA 01566-1359

JOHN A VITALE

CT DEPT OF TRANSPORTATION

4 BREWERY ST

NEW HAVEN CT 06511-5957

1001B-NHP



FISKDALE 458 MAIN ST FISKDALE, MA 01518-9998 (800)275-8777

09/10/2021 (800)275-8777	10:55 AM
THE REAL PROPERTY AND THE WAS NOT THE WOOD THE WAS THE WAS NOT THE WOOD THE	Prico
Prepaid Mail 1 Berlin, CT 06037 Weight: 0 lb 8.30 oz Acceptance Date: Fri 09/10/2021 Tracking #: 9405 5036 9930 0493 1158	\$0.00
Prepaid Mail 1 Greenwich, CT 06830 Weight: 0 lb 8.10 oz Acceptance Date: Fri 09/10/2021 Tracking #: 9405 5036 9930 0493 1158	\$0.00
Prepaid Mail 1 New Haven, CT 06511 Weight: 0 lb 8.10 oz Acceptance Date: Fri 09/10/2021 Tracking #: 9405 5036 9930 0493 1159	\$0.00 07
Prepaid Mail 1 Greenwich, CT 06830 Weight: 0 lb 8.10 oz Acceptance Date: Fri 09/10/2021 Tracking #: 9405 5036 9930 0493 1158	\$0.00
Grand Total:	\$0.00