## EM-SPRINT-054-111205

3009 FEDERAL HILL DRIVE FALLS CHURCH, VIRGINIA 22044 phone 703.533.1006

November 28, 2011

Chairman Robert Stein Connecticut Siting Council 10 Franklin Square New Britain, CT 06051



SUBJECT:

Sprint Spectrum L.P.'s Notice of Intent to Make an Exempt Modification to an

Existing Facility at 2577 Main Street, Glastonbury, CT 06033

(Site # CT43XC822)

Dear Chairman Stein:

Pursuant to R.C.S.A. Sections 16-50j-73 and 16-50j-72(b), Sprint Spectrum L.P. (Sprint), hereby gives notice to the Connecticut Siting Council (Council) and the Town of Glastonbury of its intent to make an exempt modification to an existing telecommunications facility located at 2577 Main Street, Glastonbury, Connecticut.

Sprint plans to install a hydrogen fuel cell at its 2577 Main Street facility to provide emergency backup power in the event of an electric outage. This planned installation does not constitute a modification subject to the Council's review as it falls within those activities provided for in R.C.S.A. Section 16-50j-72(b)(2). Specifically, this installation will not change the height of the existing tower, will not extend the boundaries of the existing compound, will not increase noise levels at the site by six decibels or more, and will not increase the total radio frequency electromagnetic radiation power density at the site to levels above applicable standards.

## PROPOSED INSTALLATION

Sprint plans to install a 5 kW Altergy hydrogen fuel cell generator within the existing fenced equipment compound. The fuel cell will be inside a cabinet measuring 3'6" x 2'2" x 6'0". There will also be a hydrogen cylinder storage cabinet with overall dimensions of 4'8" x 4'8" x 6'0".

Please contact me at 703.533.1006 or <u>Hulshart@earthlink.net</u> should you have any questions about this planned modification.

Sincerely,

Mark Hulshart

Principal

cc: Richard Johnson, Town Manager, Town of Glastonbury

St. Paul's Roman Catholic Church (property owner)


## Specifications



~ ~	lom Power™ 5 kW System n FPS Power Cabinet	FPS-524-240	FPS-524-240-400	FPS-548-240	FPS-548-240-405
Physical	Dimensions (w x d x h)	26" x 42" x 72" [66 cm x 107 cm x 183 cm]			
	Weight	515 lb [234 kg]	706 lb [320 kg]	515 lb [234 kg]	706 lb [320 kg]
	Number of FPS Engines		1		
	Number of TPMs	0	1	.0	1
Performance	Rated power		5 k'	W	
	Rated current	2	210 A 105 A		05 A
	Operating voltage (nominal)	24	24 VDC		VDC
	Operating voltage (range)	21 to 29 VDC		42 to	58 VDC
	Standing Input Current (nominal)	1.92 A (	@ 24 VDC	0.96 A	@ 48 VDC
Operation	Ambient temperature <sup>2</sup>	- 4 °F to 104 °F [- 20 °C to +40 °C]			
	Relative humidity, noncondensing	5 to 100%			
	Location	Outdoor only			
	Auxiliary AC in <sup>2</sup>	120 V, 60 Hz, 10 A. single phase			
Storage	Ambient temperature	+ 40 °F to +113 °F [+4 °C to +45 °C]			
	Relative humidity, noncondensing	5 to 100%			
Fuel	Gaseous hydrogen purity	Hydrogen (H <sub>2</sub> ) 99.95% certified Industrial Grade			al Grade
	Supply pressure range	40 to 150 PSIG [2.8 to 10.5 kg/cm²]			
	Typical operating pressure	100 PSIG [7.03 kg/cm²]			
	Consumption	300 g/hour @ 5 kW			
Monitoring /	Standard	Ethernet, USB, Serial, 4 Dry Contacts			
Control	Optional	Wireless Telemetry			
	Rectifier Supply Voltage	n/a	27.0 ± 0.6 VDC	n/a	54.0 ± 0.6 VD0

<sup>&</sup>lt;sup>1</sup>Polarity is determined by customer requirements and ground connections.

<sup>&</sup>lt;sup>2</sup>For operation below +10 °C, the FPS must be connected to the grid and supplied with AC power until a grid failure, at which time the heat generated by the FPS will be sufficient to maintain operation of the FPS at temperatures between -20 °C and +10 °C.

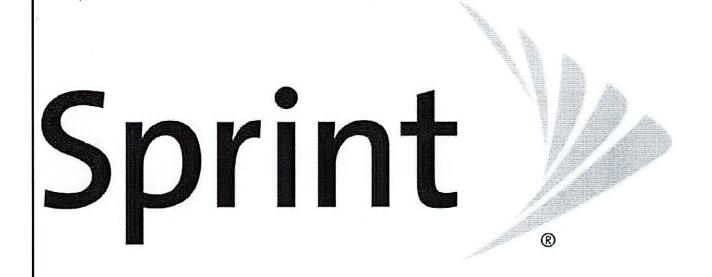

SITE NAME: GLASTONBURY

SITE NUMBER: CT43XC822

SITE ADDRESS: 2577 MAIN STREET

GLASTONBURY, CT 06033

SITE TYPE: EXISTING 130' SELF SUPPORT TOWER

Sprint

6580 SPRINT PARKWAY OVERLAND PARK, KANSAS 66251



10950 GRANDVIEW DRIVE OVERLAND PARK, KANSAS 66210 (913) 458-2000

- 1	DRAWN BY:	DMS
_	CHECKED BY:	МВ

## 0 11/17/11 ISSUED FOR CONSTRUCTION REV DATE DESCRIPTION



IT IS A VIOLATION OF LAW FOR ANY PERSON UNLESS THEY ARE ACTING UNDER THE DIRECTION OF A LICENSED PROFESSIONAL ENGINEER, TO ALTER THIS DOCUMENT.


CT43XC822 GLASTONBURY 2577 MAIN STREET GLASTONBURY, CT 06033 CO-LOCATION


SHEET TITLE

TITLE SHEET & PROJECT DATA

SHEET NUMBER

T-1

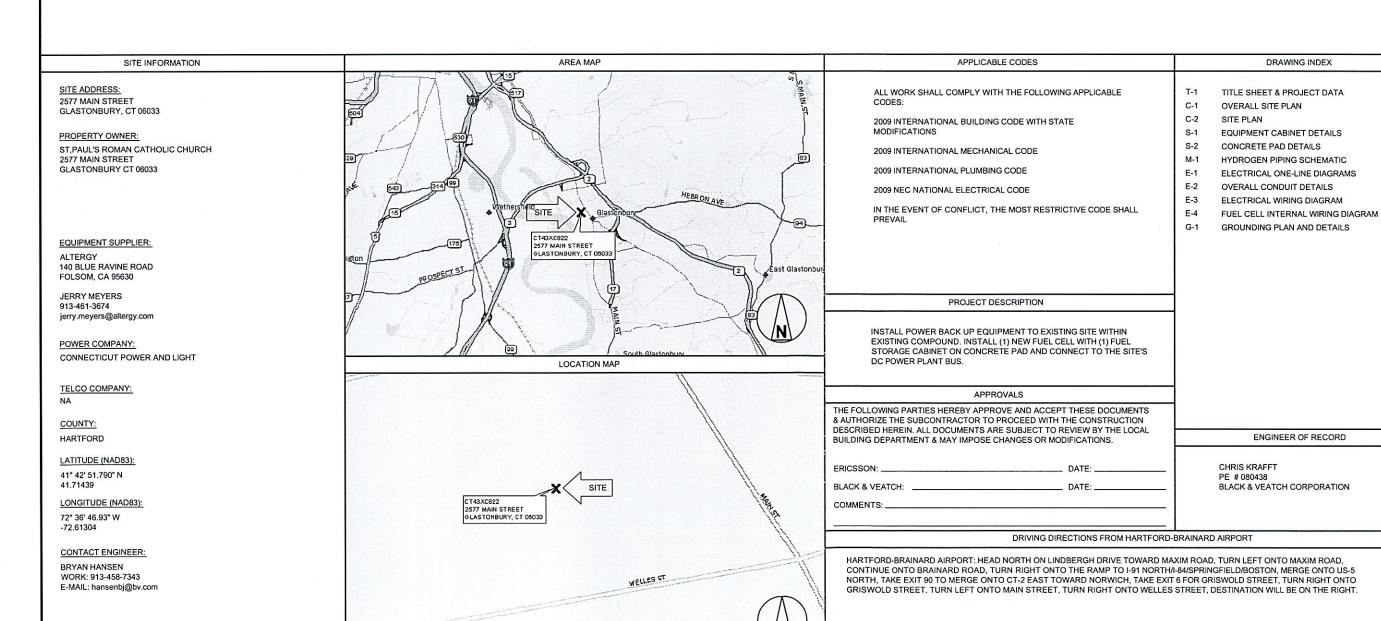

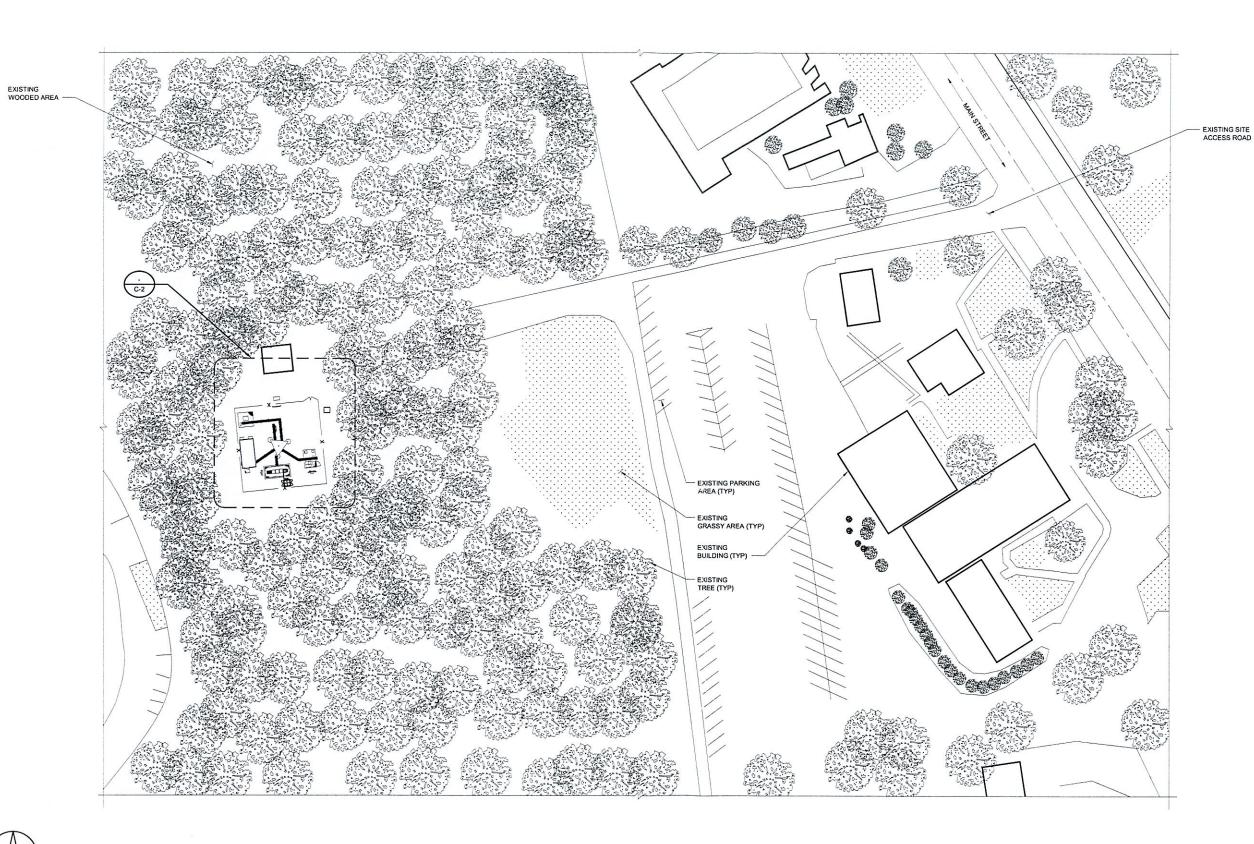



6580 SPRINT PARKWAY OVERLAND PARK, KANSAS 66251




10950 GRANDVIEW DRIVE OVERLAND PARK, KANSAS 66210 (913) 458-2000

168202

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CT43XC822 GLASTONBURY 2577 MAIN STREET GLASTONBURY, CT 06033 CO-LOCATION

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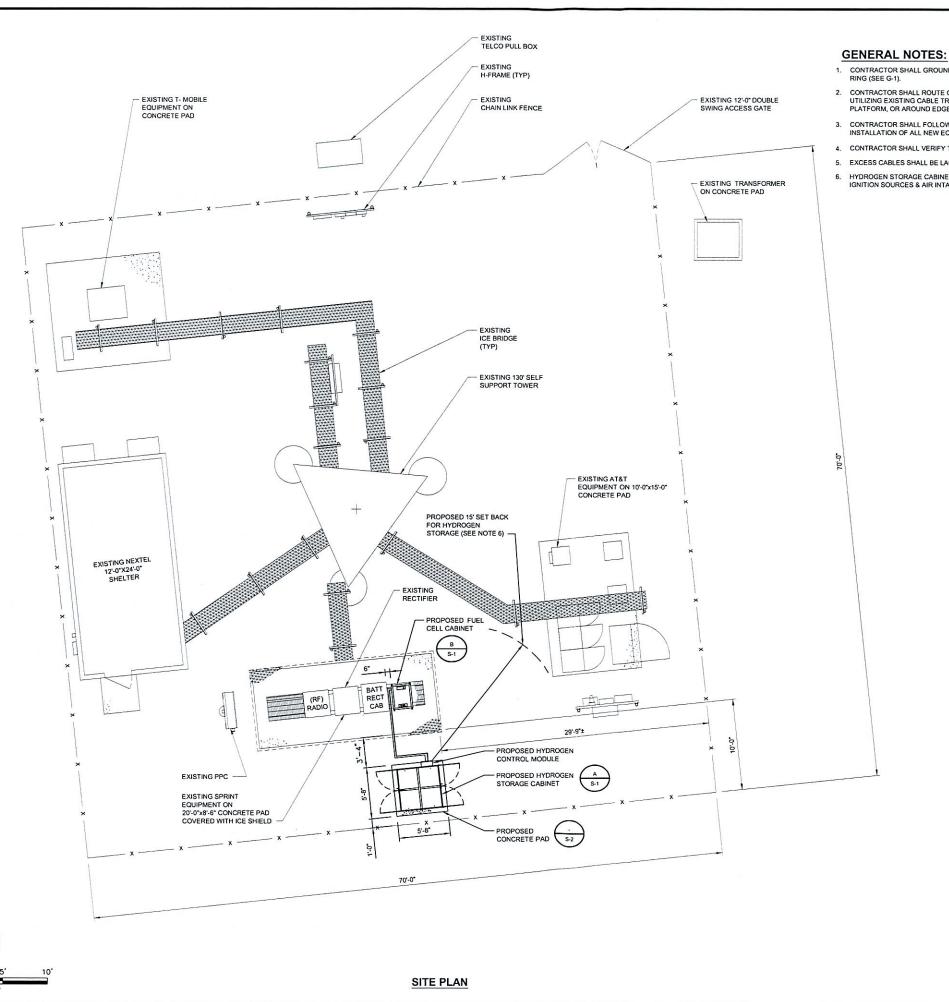
OVERALL SITE PLAN

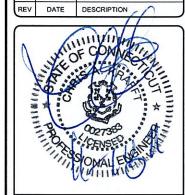SHEET NUMBER

C-1

**OVERALL SITE PLAN** 





3/16"=1'-0"

- CONTRACTOR SHALL GROUND ALL NEW EQUIPMENT TO THE NEAREST GROUND RING (SEE G-1).
- CONTRACTOR SHALL ROUTE CONDUIT TO AVOID TRIP HAZARDS BY EITHER
  UTILIZING EXISTING CABLE TRAY, OVERHEAD ICE BRIDGE, UNDERNEATH RAISED
  PLATFORM, OR AROUND EDGE OF CONCRETE PAD.
- 3. CONTRACTOR SHALL FOLLOW ALL MANUFACTURER'S RECOMMENDATIONS FOR INSTALLATION OF ALL NEW EQUIPMENT.
- 4. CONTRACTOR SHALL VERIFY THE ALARM CABLES ARE OF SUFFICIENT LENGTH.
- 5. EXCESS CABLES SHALL BE LACED IN A NEAT AND ORGANIZED MANNER.
- HYDROGEN STORAGE CABINET HAS A REQUIRED SET BACK OF 15' FROM IGNITION SOURCES & AIR INTAKES.



6580 SPRINT PARKWAY OVERLAND PARK, KANSAS 66251



10950 GRANDVIEW DRIVE OVERLAND PARK, KANSAS 66210 (913) 458-2000

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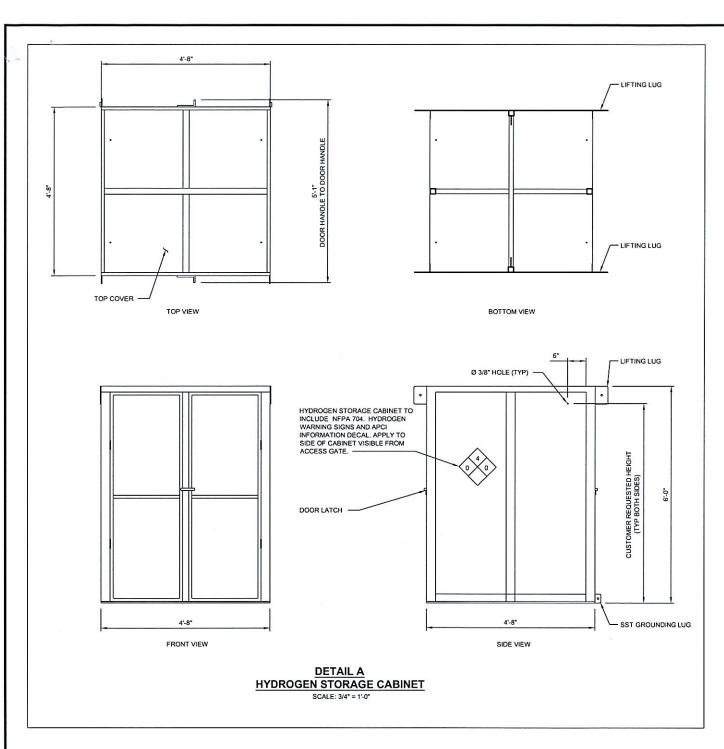
CT43XC822 GLASTONBURY 2577 MAIN STREET GLASTONBURY, CT 06033 CO-LOCATION


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SITE PLAN

SHEET NUMBER

**C-2** 





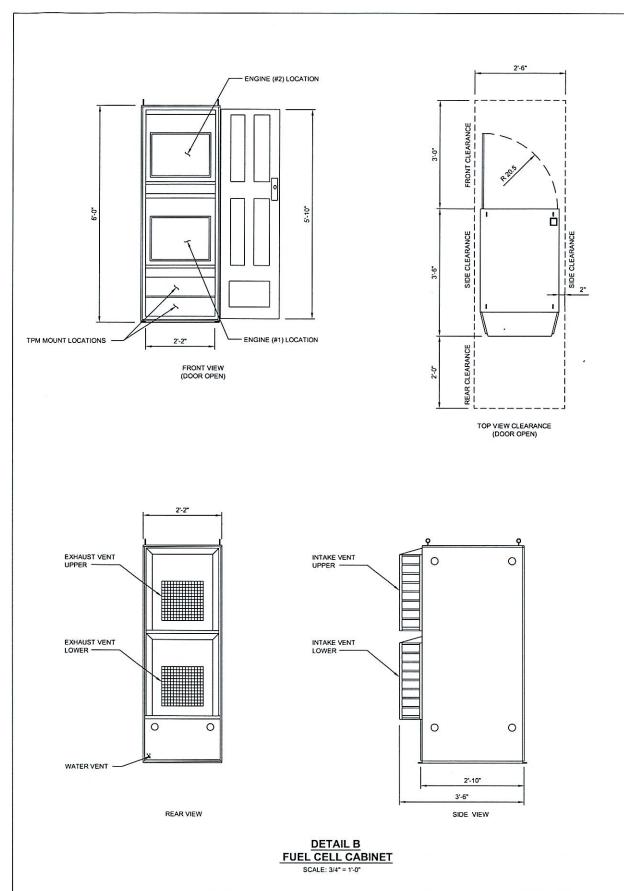

6580 SPRINT PARKWAY ERLAND PARK, KANSAS 66251



10950 GRANDVIEW DRIVE OVERLAND PARK, KANSAS 66210 (913) 458-2000

168202

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CT43XC822 GLASTONBURY 2577 MAIN STREET GLASTONBURY, CT 06033 CO-LOCATION

SHEET TITLE

EQUIPMENT CABINET DETAILS

SHEET NUMBER

S-1