

# STATE OF CONNECTICUT

## CONNECTICUT SITING COUNCIL

Ten Franklin Square, New Britain, CT 06051 Phone: (860) 827-2935 Fax: (860) 827-2950 E-Mail: siting.council@ct.gov www.ct.gov/csc

## VIA ELECTRONIC MAIL

July 30, 2019

Aaron Meyers Site Acquisition Centerline Communications, LLC 750 W. Center Street, Floor 3 West Bridgewater, MA 02379

RE: **EM-CING-054-190711** – New Cingular Wireless PCS, LLC (AT&T) notice of intent to modify an existing telecommunications facility located at 2577 Main Street, Glastonbury, Connecticut.

Dear Mr. Meyers:

The Connecticut Siting Council (Council) is in receipt of your correspondence of July 22, 2019 submitted in response to the Council's July 17, 2019 notification of an incomplete request for exempt modification with regard to the above-referenced matter.

The submission renders the request for exempt modification complete and the Council will process the request in accordance with the Federal Communications Commission 60-day timeframe.

Thank you for your attention and cooperation.

Singerely,

Melanie A. Bachman Executive Director

MAB/IN/emr

c:

David Ford, Centerline Communications

## Robidoux, Evan

From:

David Ford <dford@clinellc.com>

Sent:

Monday, July 22, 2019 9:55 AM

To:

Robidoux, Evan

Cc: Subject: CSC-DL Siting Council; David Ford RE: Council Incomplete Letter for EM-CING-054-190711-MainSt-Glastonbury

Attachments:

CT5273\_LTE\_3C\_4C\_5C\_4TX4RX\_CD\_REV1\_07.19.19.pdf; em-cing-054-190711

\_incompleteltr\_MainSt.pdf

Evan,

In regards to the memo dated 7/11/19, attached please find the revised drawings.

We'll send one hard via UPS as well.

Thanks

From: Robidoux, Evan < Evan.Robidoux@ct.gov >

Sent: Friday, July 19, 2019 9:36 AM

Subject: Council Incomplete Letter for EM-CING-054-190711-MainSt-Glastonbury

Please see the attached correspondence.

Evan Robidoux Clerk Typist Connecticut Siting Council 10 Franklin Square New Britain, CT 06051



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Ten Franklin Square, New Britain, CT 06051 Phone: (860) 827-2935 Fax: (860) 827-2950 E-Mail: siting.council@ct.gov www.ct.gov/csc

July 17, 2019

Aaron Meyers Site Acquisition Centerline Communications, LLC 750 W. Center Street, Floor 3 West Bridgewater, MA 02379

RE: **EM-CING-054-190711** – New Cingular Wireless PCS, LLC (AT&T) notice of intent to modify an existing telecommunications facility located at 2577 Main Street, Glastonbury, Connecticut.

Dear Mr. Meyers:

The Connecticut Siting Council (Council) received a notice of intent to modify the above-referenced facility on July 11, 2015.

According to Section 16-50j-71 of the Regulations of Connecticut State Agencies, "...any modification, as defined in Section 16-50j-2a of the Regulations of Connecticut State Agencies, to an existing tower site, except as specified in Sections 16-50j-72 and 16-50j-88 of the Regulations of Connecticut State Agencies, may have a substantial adverse environmental effect."

Staff has reviewed this exempt modification request for completeness and has identified a deficiency in the Construction Drawings (CD) prepared by Hudson Design Group and last revised May 21, 2019. A structural note on sheet A-1 of the CD references a Mount Analysis dated June 20, 2019 (Rev. 1). This is inconsistent with the Mount Analysis provided with the Submittal which is dated April 17, 2019.

Therefore, the exempt modification request is incomplete at this time. The Council recommends that Centerline Communications provide the Mount Analysis referenced above and if applicable an updated Structural Analysis Report that accounts for the proposed mount modifications, on or before August 16, 2019. If additional time is needed to gather the requested information, please submit a written request for an extension of time prior to August 16, 2019. Please provide an electronic version and one hard copy of the response for the incomplete request to be rendered complete and processed.

This notice of incompletion shall have the effect of tolling the Federal Communications Commission (FCC) 60-day timeframe in accordance with Paragraph 217 of the FCC Wireless Infrastructure Report and Order issued on October 21, 2014 (FCC 14-153).

Thank you for your attention to this matter. Should you have any questions, please feel free to contact me at 860-827-2951.

Sincerely,

Melanie Bachman Executive Director

MAB/IN/emr

c: The Honorable Thomas P. Gullotta, Chairman, Town of Glastonbury Richard J. Johnson, Town Manager, Town of Glastonbury Khara Dodds, Director of Planning and Land Use Services, Town of Glastonbury

## PROJECT INFORMATION

SCOPE OF WORK:

ITEMS TO BE MOUNTED ON EXISTING LATTICE TOWER: • NEW AT&T ANTENNAS (HPA65R-BU6A) @ POS. 3 (TYP. OF 1 PER ALPHA & GAMMA

SECTORS, TOTAL OF 2)

• NEW AT&T ANTENNAS (800-10965) @ POS. 4 (TYP. OF 1 PER ALPHA & GAMMA

SECTORS, TOTAL OF 2). • NEW AT&T ANTENNAS (HPA65R-BU8A) @ POS. 3 (TOTAL OF 1 FOR BETA SECTOR).

• NEW AT&T ANTENNAS (800−10966) ® POS. 4 (TOTAL OF 1 FOR BETA SECTOR). • NEW AT&T RRUS B5/B12 4449 (700/850) (TYP. OF 1 PER SECTOR, TOTAL OF 3). • NEW AT&T RRUS B2/B66A 8843 (AWS/1900) (TYP. OF 1 PER SECTOR, TOTAL OF 3).

• NEW AT&T RRUS 32 (WCS) (TYP. OF 1 PER SECTOR, TOTAL OF 3). • NEW AT&T SURGE ARRESTOR (DC6-48-60-18-8C) (TOTAL OF 2).

• INSTALL (4) DC POWER CABLES & (1) FIBER RUN (TO FOLLOW EXISTING ROUTE).

ITEMS TO BE MOUNTED AT EQUIPMENT LOCATION:

• REMOVE EXISTING DC6 & INSTALL (1) OUTDOOR DC12.

• INSTALL (24) TELCO FLEX IN PROPOSED CONDUITS TO BE RUN BETWEEN DC12 AND EXISTING POWER PLANT, RE-CABLE EXISTING EQUIPMENT TO PROPOSED DC12.

• INSTALL (1) FIBER BOX.

• SWITCH BASEBAND TO 5216. • ADD 2ND XMU.

• ADD 6630 BASEBAND.

• FOLLOW SEC7 OR PD FOR BASEBAND CONFIGURATION.

•(6) ANTENNAS, (6) TMA'S, (1) SURGE ARRESTOR, (12) 1-5/8" COAX,

(2) DC POWER & (1) FIBER.

2577 MAIN STREET SITE ADDRESS: GLASTONBURY, CT 06033

LATITUDE:

41.714191 N, 41° 42′ 51.09″ N

72.613298 W, 72° 36' 47.87" W LONGITUDE: TYPE OF SITE: LATTICE TOWER / OUTDOOR EQUIPMENT

STRUCTURE HEIGHT: 130'-0"±

RAD CENTER: 110'-0"± CURRENT USE: TELECOMMUNICATIONS FACILITY

PROPOSED USE: TELECOMMUNICATIONS FACILITY

## DRAWING INDEX

	DIAWING INDEX							
SHEET NO.	DESCRIPTION	REV.						
T-1	TITLE SHEET	1						
GN-1	GENERAL NOTES	1						
A-1	COMPOUND & EQUIPMENT PLANS	1						
A-2	ANTENNA LAYOUTS & ELEVATION	1						
A-3	DETAILS	1						
G-1	GROUNDING DETAILS	1						
RF-1	RF PLUMBING DIAGRAM	1						



**SITE NUMBER: CT5273** 

SITE NAME: GLASTONBURY NW

**FA CODE: 10071041** 

PACE ID: MRCTB033594, MRCTB033648, MRCTB033736, MRCTB033797

PROJECT: LTE 3C\_4C\_5C\_4TX4RX 2019 UPGRADE

#### VICINITY MAP

#### DIRECTIONS TO SITE:

HEAD NORTHEAST ON ENTERPRISE DR TOWARD CAPITAL BLVD, TURN LEFT ONTO CAPITAL BLVD, TURN LEFT ONTO WEST ST, TURN LEFT TO MERGE ONTO I-91 N TOWARD HARTFORD, MERGE ONTO CT-3 N VIG EXIT 25 TOWARD GLASTONBURY, TAKE THE EXIT TOWARD MAIN ST/GLASTONBURY, TURN LEFT ONTO GLASTONBURY BLVD, TURN RIGHT ONTO MAIN ST, 2577 MAIN ST IS ON THE RIGHT



## **GENERAL NOTES**

- THIS DOCUMENT IS THE CREATION, DESIGN, PROPERTY AND COPYRIGHTED WORK OF AT&T. ANY DUPLICATION OR USE WITHOUT EXPRESS WRITTEN CONSENT IS STRICTLY PROHIBITED. DUPLICATION AND USE BY GOVERNMENT AGENCIES FOR THE PURPOSES OF CONDUCTING THEIR LAWFULLY AUTHORIZED REGULATORY AND ADMINISTRATIVE FUNCTIONS IS SPECIFICALLY ALLOWED.
- 2. THE FACILITY IS AN UNMANNED PRIVATE AND SECURED EQUIPMENT INSTALLATION. IT IS ONLY ACCESSED BY TRAINED TECHNICIANS FOR PERIODIC ROUTINE MAINTENANCE AND THEREFORE DOES NOT REQUIRE ANY WATER OR SANITARY SEWER SERVICE. THE FACILITY IS NOT GOVERNED BY REGULATIONS REQUIRING PUBLIC ACCESS PER ADA REQUIREMENTS.
- CONTRACTOR SHALL VERIFY ALL PLANS AND EXISTING DIMENSIONS AND CONDITIONS ON THE JOB SITE AND SHALL IMMEDIATELY NOTIFY THE AT&T MOBILITY REPRESENTATIVE IN WRITING OF DISCREPANCIES BEFORE PROCEEDING WITH THE WORK OR BE RESPONSIBLE FOR SAME.
- CONSTRUCTION DRAWINGS ARE VALID FOR SIX MONTHS AFTER ENGINEER OF RECORD'S STAMPED AND SIGNED SUBMITTAL DATE LISTED HEREIN.

#### **72 HOURS**

BEFORE YOU DIG

CALL TOLL FREE 1 - 800 - 922 - 4455

AT&T

OR CALL 811

## **UNDERGROUND SERVICE ALERT**

HUDSON **Design Group LLC** 

NORTH ANDOVER, MA 01845

SBA SITE #: CT46126

CENTERLINE

750 WEST CENTER STREET., SUITE #301 WEST BRIDGEWATER, MA 02379

**SITE NUMBER: CT5273** SITE NAME: GLASTONBURY NW SBA SITE #: CT46126

2577 MAIN STREET GLASTONBURY, CT 06033 HARTFORD COUNTY



TITLE SHEET 1 07/19/19 ISSUED FOR CONSTRUCTION A 04/01/19 ISSUED FOR REVIEW (LTE 3C\_4C\_5C\_4TX4RX) AM AT DU

#### **GROUNDING NOTES**

- 1. THE SUBCONTRACTOR SHALL REVIEW AND INSPECT THE EXISTING FACILITY GROUNDING SYSTEM AND LIGHTNING PROTECTION SYSTEM (AS DESIGNED AND INSTALLED) FOR STRICT COMPLIANCE WITH THE NEC (AS ADOPTED BY THE AHJ), THE SITE-SPECIFIC (UL, LPI, OR NFPA) LIGHTING PROTECTION CODE, AND GENERAL COMPLIANCE WITH TELCORDIA AND TIA GROUNDING STANDARDS. THE SUBCONTRACTOR SHALL REPORT ANY VIOLATIONS OR ADVERSE FINDINGS TO THE CONTRACTOR FOR RESOLUTION.
- 2. ALL GROUND ELECTRODE SYSTEMS (INCLUDING TELECOMMUNICATION, RADIO, LIGHTNING PROTECTION, AND AC POWER GES'S) SHALL BE BONDED TOGETHER, AT OR BELOW GRADE, BY TWO OR MORE COPPER BONDING CONDUCTORS IN ACCORDANCE WITH THE NEC.
- 3. THE SUBCONTRACTOR SHALL PERFORM IEEE FALL-OF-POTENTIAL RESISTANCE TO EARTH TESTING (PER IEEE 1100 AND 81) FOR NEW GROUND ELECTRODE SYSTEMS. THE SUBCONTRACTOR SHALL FURNISH AND INSTALL SUPPLEMENTAL GROUND ELECTRODES AS NEEDED TO ACHIEVE A TEST RESULT OF 5 OHMS OR LESS.
- 4. METAL RACEWAY SHALL NOT BE USED AS THE NEC REQUIRED EQUIPMENT GROUND CONDUCTOR. STRANDED COPPER CONDUCTORS WITH GREEN INSULATION, SIZED IN ACCORDANCE WITH THE NEC, SHALL BE FURNISHED AND INSTALLED WITH THE POWER CIRCUITS TO BTS EQUIPMENT.
- 5. EACH BTS CABINET FRAME SHALL BE DIRECTLY CONNECTED TO THE MASTER GROUND BAR WITH GREEN INSULATED SUPPLEMENTAL EQUIPMENT GROUND WIRES, #6 AWG STRANDED COPPER OR LARGER FOR INDOOR BTS #2 AWG STRANDED COPPER FOR OUTDOOR BTS.
- 6. EXOTHERMIC WELDS SHALL BE USED FOR ALL GROUNDING CONNECTIONS BELOW GRADE.
- 7. APPROVED ANTIOXIDANT COATINGS (I.E., CONDUCTIVE GEL OR PASTE) SHALL BE USED ON ALL COMPRESSION AND BOLTED GROUND CONNECTIONS.
- 8. ICE BRIDGE BONDING CONDUCTORS SHALL BE EXOTHERMICALLY BONDED OR BOLTED TO GROUND BAR
- 9. ALUMINUM CONDUCTOR OR COPPER CLAD STEEL CONDUCTOR SHALL NOT BE USED FOR GROUNDING CONNECTIONS
- 10. MISCELLANEOUS ELECTRICAL AND NON-ELECTRICAL METAL BOXES. FRAMES AND SUPPORTS SHALL BE BONDED TO THE GROUND RING, IN ACCORDANCE WITH THE NEC.
- 11. METAL CONDUIT SHALL BE MADE ELECTRICALLY CONTINUOUS WITH LISTED BONDING FITTINGS OR BY BONDING ACROSS THE DISCONTINUITY WITH #6 AWG COPPER WIRE UL APPROVED GROUNDING TYPE CONDUIT CLAMPS
- 12. ALL NEW STRUCTURES WITH A FOUNDATION AND/OR FOOTING HAVING 20 FT. OR MORE OF 1/2 IN. OR GREATER ELECTRICALLY CONDUCTIVE REINFORCING STEEL MUST HAVE IT BONDED TO THE GROUND RING USING AN EXOTHERMIC WELD CONNECTION USING #2 AWG SOLID BARE TINNED COPPER GROUND WIRE, PER NEC 250.50

#### **GENERAL NOTES**

1. FOR THE PURPOSE OF CONSTRUCTION DRAWING, THE FOLLOWING DEFINITIONS SHALL APPLY:

CONTRACTOR - CENTERLINE SUBCONTRACTOR - GENERAL CONTRACTOR (CONSTRUCTION) OWNER - AT&T MOBILITY

- 2. PRIOR TO THE SUBMISSION OF BIDS, THE BIDDING SUBCONTRACTOR SHALL VISIT THE CELL SITE TO FAMILIARIZE WITH THE EXISTING CONDITIONS AND TO CONFIRM THAT THE WORK CAN BE ACCOMPLISHED AS SHOWN ON THE CONSTRUCTION DRAWINGS. ANY DISCREPANCY FOUND SHALL BE BROUGHT TO THE ATTENTION OF CONTRACTOR.
- ALL MATERIALS FURNISHED AND INSTALLED SHALL BE IN STRICT ACCORDANCE WITH ALL APPLICABLE CODES, REGULATIONS, AND ORDINANCES. SUBCONTRACTOR SHALL ISSUE ALL APPROPRIATE NOTICES AND COMPLY WITH ALL LAWS, ORDINANCES, RULES, REGULATIONS, AND LAWFUL ORDERS OF ANY PUBLIC AUTHORITY REGARDING THE PERFORMANCE OF THE WORK. ALL WORK CARRIED OUT SHALL COMPLY WITH ALL APPLICABLE MUNICIPAL AND UTILITY COMPANY SPECIFICATIONS AND LOCAL JURISDICTIONAL CODES, ORDINANCES AND APPLICABLE
- 4. DRAWINGS PROVIDED HERE ARE NOT TO BE SCALED AND ARE INTENDED TO SHOW OUTLINE ONLY.
- 5. UNLESS NOTED OTHERWISE. THE WORK SHALL INCLUDE FURNISHING MATERIALS, EQUIPMENT, APPURTENANCES, AND LABOR NECESSARY TO COMPLETE ALL INSTALLATIONS AS INDICATED ON
- "KITTING LIST" SUPPLIED WITH THE BID PACKAGE IDENTIFIES ITEMS THAT WILL BE SUPPLIED BY CONTRACTOR. ITEMS NOT INCLUDED IN THE BILL OF MATERIALS AND KITTING LIST SHALL BE SUPPLIED BY THE SUBCONTRACTOR.
- THE SUBCONTRACTOR SHALL INSTALL ALL EQUIPMENT AND MATERIALS IN ACCORDANCE WITH MANUFACTURER'S RECOMMENDATIONS UNLESS SPECIFICALLY STATED OTHERWISE.
- IF THE SPECIFIED EQUIPMENT CANNOT BE INSTALLED AS SHOWN ON THESE DRAWINGS, THE SUBCONTRACTOR SHALL PROPOSE AN ALTERNATIVE INSTALLATION SPACE FOR APPROVAL BY THE CONTRACTOR
- SUBCONTRACTOR SHALL DETERMINE ACTUAL ROUTING OF CONDUIT, POWER AND T1 CABLES. GROUNDING CARLES AS SHOWN ON THE POWER GROUNDING AND TELCO PLAN DRAWING SUBCONTRACTOR SHALL UTILIZE EXISTING TRAYS AND/OR SHALL ADD NEW TRAYS AS NECESSARY. SUBCONTRACTOR SHALL CONFIRM THE ACTUAL ROUTING WITH THE CONTRACTOR.
- 10. THE SUBCONTRACTOR SHALL PROTECT EXISTING IMPROVEMENTS, PAVEMENTS, CURBS, LANDSCAPING AND STRUCTURES. ANY DAMAGED PART SHALL BE REPAIRED AT SUBCONTRACTOR'S EXPENSE TO THE SATISFACTION OF OWNER.
- 11. SUBCONTRACTOR SHALL LEGALLY AND PROPERLY DISPOSE OF ALL SCRAP MATERIALS SUCH AS COAXIAL CABLES AND OTHER ITEMS REMOVED FROM THE EXISTING FACILITY. ANTENNAS REMOVED SHALL BE RETURNED TO THE OWNER'S DESIGNATED LOCATION.
- 12 SUBCONTRACTOR SHALL LEAVE PREMISES IN CLEAN CONDITION.
- 13. ALL CONCRETE REPAIR WORK SHALL BE DONE IN ACCORDANCE WITH AMERICAN CONCRETE INSTITUTE (ACI) 301.

- 14. ANY NEW CONCRETE NEEDED FOR THE CONSTRUCTION SHALL BE AIR-ENTRAINED AND SHALL HAVE 4000 PSI STRENGTH AT 28 DAYS. ALL CONCRETE WORK SHALL BE DONE IN ACCORDANCE WITH ACI 318 CODE REQUIREMENTS.
- 15. ALL STRUCTURAL STEEL WORK SHALL BE DETAILED, FABRICATED AND ERECTED IN ACCORDANCE WITH AISC SPECIFICATIONS. ALL STRUCTURAL STEEL SHALL BE ASTM A36 (Fy = 36 ksi) UNLESS OTHERWISE NOTED. PIPES SHALL BE ASTM A53 TYPE E (Fy = 36 ksi). ALL STEEL EXPOSED TO WEATHER SHALL BE HOT DIPPED GALVANIZED. TOUCH UP ALL SCRATCHES AND OTHER MARKS IN THE FIELD AFTER STEEL IS ERECTED USING A COMPATIBLE ZINC RICH PAINT.
- 16. CONSTRUCTION SHALL COMPLY WITH SPECIFICATIONS AND "GENERAL CONSTRUCTION SERVICES FOR CONSTRUCTION OF AT&T SITES."
- 17. SUBCONTRACTOR SHALL VERIFY ALL EXISTING DIMENSIONS AND CONDITIONS PRIOR TO COMMENCING ANY WORK. ALL DIMENSIONS OF EXISTING CONSTRUCTION SHOWN ON THE DRAWINGS MUST BE VERIFIED. SUBCONTRACTOR SHALL NOTIFY THE CONTRACTOR OF ANY DISCREPANCIES PRIOR TO ORDERING MATERIAL OR PROCEEDING WITH CONSTRUCTION.
- 18. THE EXISTING CELL SITE IS IN FULL COMMERCIAL OPERATION. ANY CONSTRUCTION WORK BY SUBCONTRACTOR SHALL NOT DISRUPT THE EXISTING NORMAL OPERATION. ANY WORK ON EXISTING EQUIPMENT MUST BE COORDINATED WITH CONTRACTOR. ALSO, WORK SHOULD BE SCHEDULED FOR AN APPROPRIATE MAINTENANCE WINDOW USUALLY IN LOW TRAFFIC PERIODS
- 19. SINCE THE CELL SITE IS ACTIVE, ALL SAFETY PRECAUTIONS MUST BE TAKEN WHEN WORKING AROUND HIGH LEVELS OF ELECTROMAGNETIC RADIATION. EQUIPMENT SHOULD BE SHUTDOWN PRIOR TO PERFORMING ANY WORK THAT COULD EXPOSE THE WORKERS TO DANGER. PERSONAL RF EXPOSURE MONITORS ARE ADVISED TO BE WORN TO ALERT OF ANY DANGEROUS EXPOSURE LEVELS.
- 20. APPLICABLE BUILDING CODES:

SUBCONTRACTOR'S WORK SHALL COMPLY WITH ALL APPLICABLE NATIONAL, STATE, AND LOCAL CODES AS ADOPTED BY THE LOCAL AUTHORITY HAVING JURISDICTION (AHJ) FOR THE LOCATION. THE EDITION OF THE AHJ ADOPTED CODES AND STANDARDS IN EFFECT ON THE DATE OF CONTRACT AWARD SHALL GOVERN THE DESIGN.

BUILDING CODE: IBC 2015 WITH 2018 CT STATE BUILDING CODE AMENDMENTS ELECTRICAL CODE: 2017 NATIONAL ELECTRICAL CODE (NFPA 70-2017)

SUBCONTRACTOR'S WORK SHALL COMPLY WITH THE LATEST EDITION OF THE FOLLOWING STANDARDS.

AMERICAN CONCRETE INSTITUTE (ACI) 318; BUILDING CODE REQUIREMENTS FOR STRUCTURAL CONCRETE:

AMERICAN INSTITUTE OF STEEL CONSTRUCTION (AISC) MANUAL OF STEEL CONSTRUCTION, ASD. FOURTEENTH EDITION:

TELECOMMUNICATIONS INDUSTRY ASSOCIATION (TIA) 222-G, STRUCTURAL STANDARDS FOR STEEL

FOR ANY CONFLICTS BETWEEN SECTIONS OF LISTED CODES AND STANDARDS REGARDING MATERIAL, METHODS OF CONSTRUCTION, OR OTHER REQUIREMENTS, THE MOST RESTRICTIVE REQUIREMENT SHALL GOVERN. WHERE THERE IS CONFLICT BETWEEN A GENERAL REQUIREMENT AND A SPECIFIC REQUIREMENT, THE SPECIFIC REQUIREMENT SHALL GOVERN.

#### **ABBREVIATIONS** ABOVE GRADE LEVEL **EQUAL** REQUIRED AGI EQ RADIO FREQUENCY AWG AMERICAN WIRE GAUGE GENERAL CONTRACTOR RF BBU BATTERY BACKUP UNIT GALVANIZED RIGID CONDUIT TBD TO BE DETERMINED BARE TINNED SOLID BTCW MGB MASTER GROUND BAR TBR TO BE REMOVED COPPER WIRE TO BE REMOVED AND **BGR** BURIED GROUND RING MIN MINIMUM TRRR REPLACED RTS BASE TRANSCEIVER STATION PROPOSED TYP TYPICAL NOTI ITO /SCALE **EXISTING** UG UNDER GROUND RADIATION GENTER LINE RAD EQUIPMENT GROUND BAR VERIFY IN FIELD **EGB** (ANTENNA) FGR FOUIPMENT GROUND RING



NORTH ANDOVER, MA 01845

TEL: (978) 557-5553 FAX: (978) 336-5586



750 WEST CENTER STREET., SUITE #301


WEST BRIDGEWATER, MA 02379

SITE NUMBER: CT5273 SITE NAME: GLASTONBURY NW SBA SITE #: CT46126


> 2577 MAIN STREET GLASTONBURY, CT 06033 HARTFORD COUNTY





ROCKY HILL, CT 06067

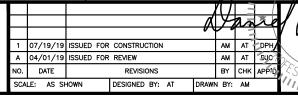


AT&T **GENERAL NOTES** (LTF 3C 4C 5C 4TX4RX) DRAWING NUMBER CT5273 GN-1

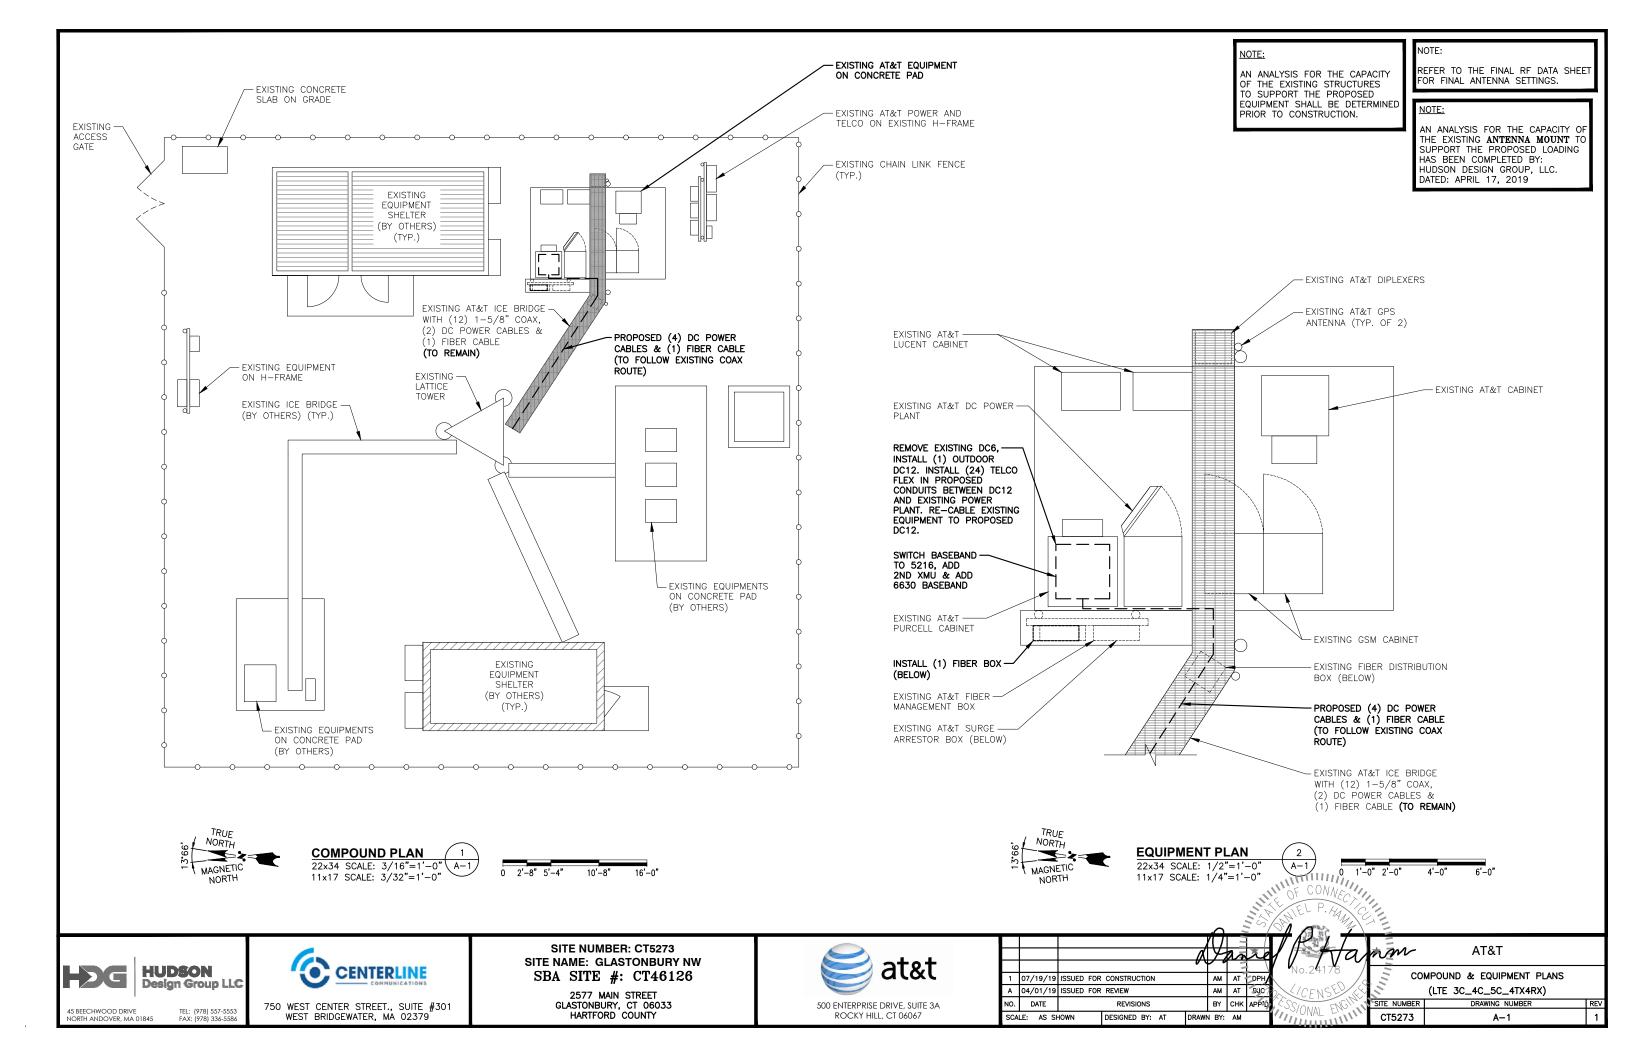


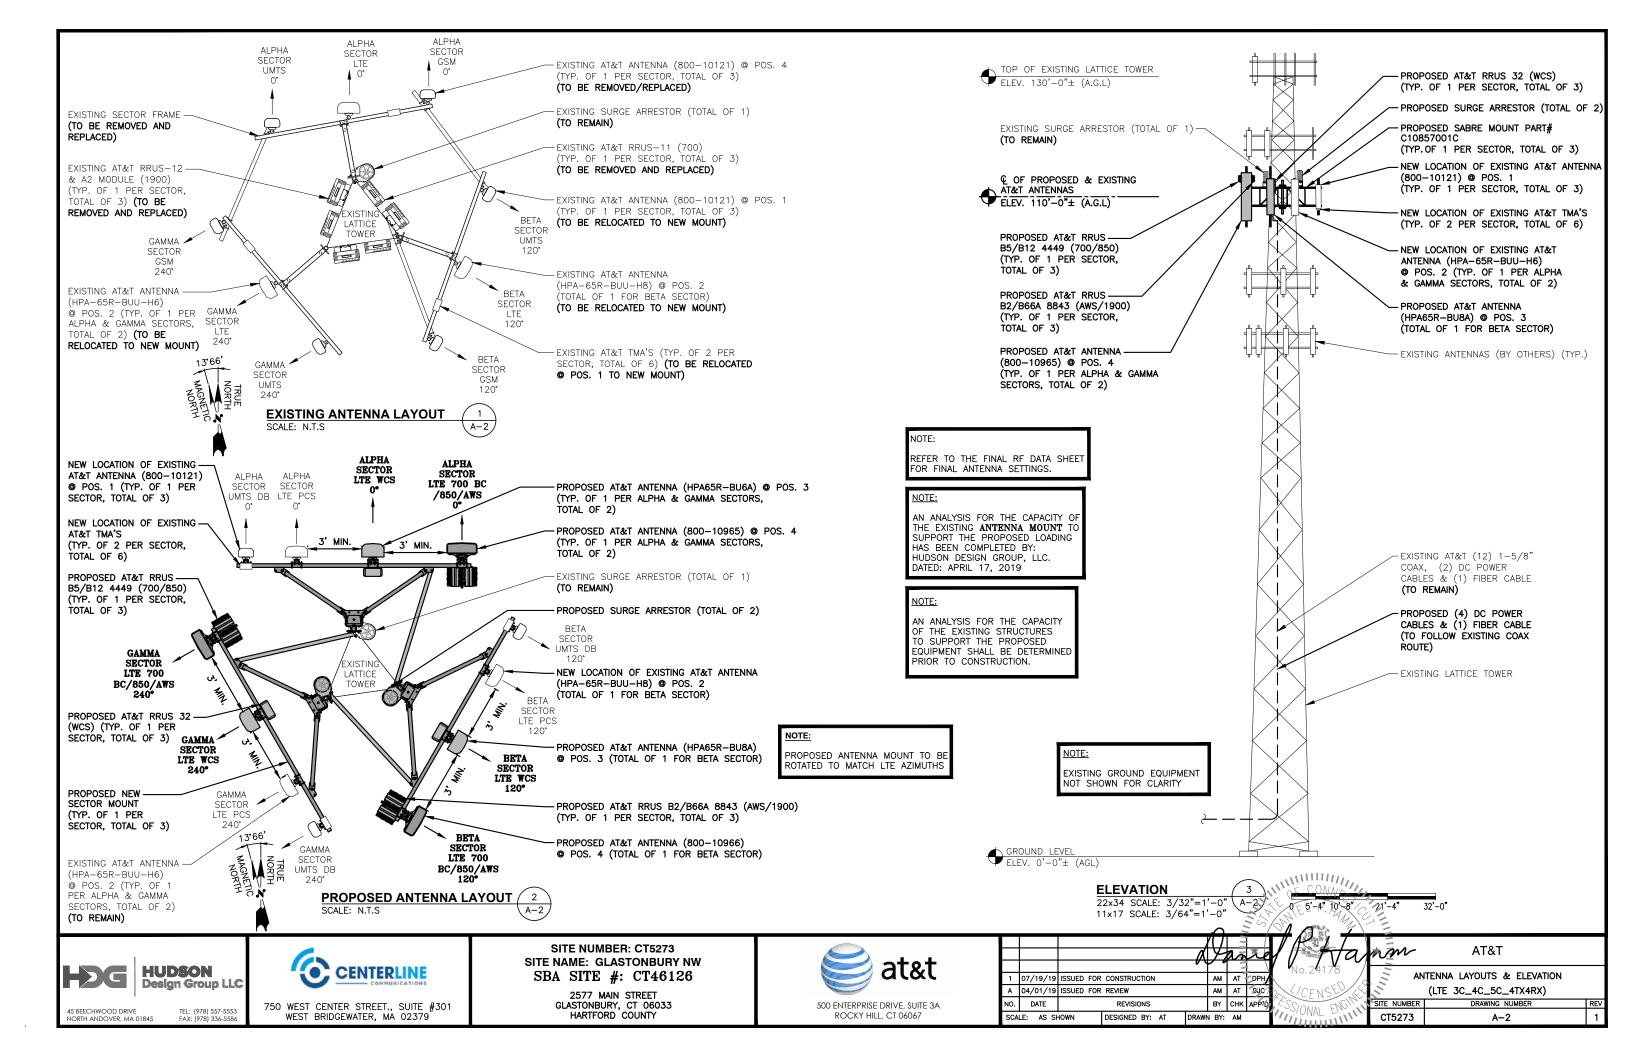

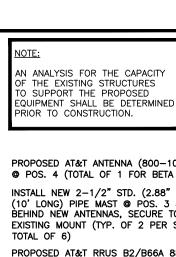


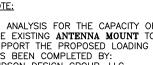

AN ANALYSIS FOR THE CAPACITY OF THE EXISTING **ANTENNA MOUNT** TO SUPPORT THE PROPOSED LOADING HAS BEEN COMPLETED BY: HUDSON DESIGN GROUP, LLC. DATED: APRIL 17, 2019

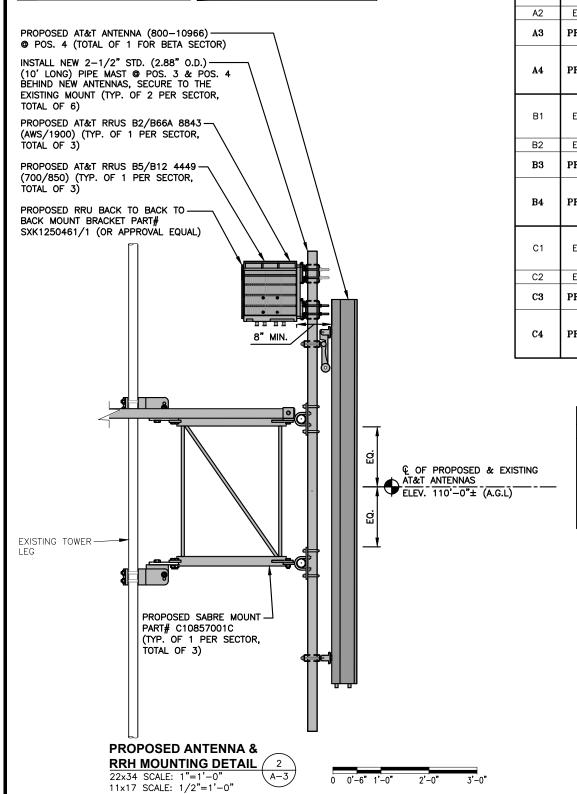

					ANTE	ENNA SC	HEDULE				
SECTOR	EXISTING/ PROPOSED	BAND	ANTENNA	SIZE (INCHES) (L x W x D)	ANTENNA © HEIGHT	AZIMUTH	TMA/ DIPLEXER	RRU	SIZE (INCHES) (L x W x D)	FEEDER	RAYCAP
A1	EXISTING	UMTS DB	800-10121	54.5X10.3X5.9	110'±	0*	(E)(2) POWERWAVE LGP21401 (E)(2)(G) POWERWAVE LGP21901	-	-	(2) 1-5/8" COAX (LENGTH 160'±)	RAYCAP 60-18-8C
A2	EXISTING	LTE PCS	HPA-65R-BUU-H6	72X14.8X9	110'±	0°	-	ı	1	ı	] {c
A3	PROPOSED	LTE WCS	HPA65R-BU6A	71.2X11.7X8.4	110'±	0°	(E)(2)(G) POWERWAVE LGP21901	(P)(1) RRUS-32 (WCS)	27.2X12.1X7.0	(2) 1-5/8" COAX (LENGTH 160'±)	(1) R/ -8-60
A4	PROPOSED	LTE 700 BC/850/AWS	800-10965	78.7X20X6.9	110'±	0°	_	(P)(1) B5/B12 4449 (700/850)	14.9X13.2X10.4	_	(E)(1) DC6-48-(
AT	1 KOI OSED	DIE 100 Be/ 000/ AWS	000-10903	10.172.070.9	110 1		_	(P)(1) B2/B66A 8843 (1900/AWS)	14.9X13.2X10.9	_	
B1	EXISTING	UMTS DB	800-10121	54.5X10.3X5.9	110'±	120°	(E)(2) POWERWAVE LGP21401 (E)(2)(G) POWERWAVE LGP21901	-	-	(2) 1-5/8" COAX (LENGTH 160'±)	RAYCAP -60-18-8C
B2	EXISTING	LTE PCS	HPA-65R-BUU-H8	92.4X14.8X7.4	110'±	120°	-	_	-	-	7 27 1
В3	PROPOSED	LTE WCS	HPA65R-BU8A	96X11.7X7.6	110'±	120°	(E)(2)(G) POWERWAVE LGP21901	(P)(1) RRUS-32 (WCS)	27.2X12.1X7.0	(2) 1-5/8" COAX (LENGTH 160'±)	1) R4 8-60
B4	PROPOSED	LTE 700 BC/850/AWS	800-10966	90X20X6.9	110'±	120°	-	(P)(1) B5/B12 4449 (700/850) (P)(1) B2/B66A 8843 (1900/AWS)	14.9X13.2X10.4 14.9X13.2X10.9	-	(P)(1) DC6-48-(
C1	EXISTING	UMTS DB	800-10121	54.5X10.3X5.9	110'±	240°	(E)(2) POWERWAVE LGP21401 (E)(2)(G) POWERWAVE LGP21901	-	-	(2) 1-5/8" COAX (LENGTH 160'±)	RAYCAP -60-18-8C
C2	EXISTING	LTE PCS	HPA-65R-BUU-H6	72X14.8X9	110'±	240°	_	1	1	ı	] 57
С3	PROPOSED	LTE WCS	HPA65R-BU6A	71.2X11.7X8.4	110'±	240°	(E)(2)(G) POWERWAVE LGP21901	(P)(1) RRUS-32 (WCS)	27.2X12.1X7.0	(2) 1-5/8" COAX (LENGTH 160'±)	1) R/18-60
C4	PROPOSED	LTE 700 BC/850/AWS	800-10965	78.7X20X6.9	110'±	240°	-	(P)(1) B5/B12 4449 (700/850) (P)(1) B2/B66A 8843 (1900/AWS)	14.9X13.2X10.4 14.9X13.2X10.9	-	(P)(1) DC6-48-(

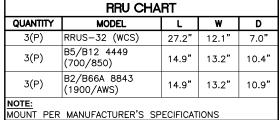


NOTE: SEE RFDS FOR RRH FREQUENCY AND MODEL NUMBER PROPOSED RRU REFER TO THE -FINAL RFDS AND CHART FOR QUANTITY, MODEL AND DIMENSIONS

MOUNT PER MANUFACTURER'S SPECIFICATIONS.

**PROPOSED RRUS DETAIL** SCALE: N.T.S


FINAL ANTENNA SCHEDULE SCALE: N.T.S

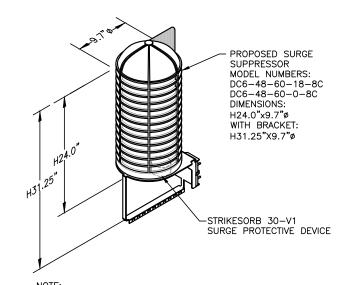

MOUNT PER MANUFACTURER'S SPECIFICATIONS.

DC SURGE SUPPRESSOR DETAIL

REFER TO THE FINAL RF DATA SHEET FOR FINAL ANTENNA SETTINGS.

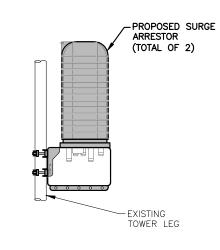

**SURGE SUPPRESSOR MOUNTING DETAIL** SCALE: N.T.S

HUDSON **Design Group LLC** 

45 BEECHWOOD DRIVE NORTH ANDOVER, MA 01845

TEL: (978) 557-5553 FAX: (978) 336-5586

CENTERLINE 750 WEST CENTER STREET., SUITE #301 WEST BRIDGEWATER, MA 02379


**SITE NUMBER: CT5273** SITE NAME: GLASTONBURY NW SBA SITE #: CT46126

2577 MAIN STREET GLASTONBURY, CT 06033 HARTFORD COUNTY




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AT&T DETAILS (LTE 3C\_4C\_5C\_4TX4RX) DRAWING NUMBER CT5273 A-5

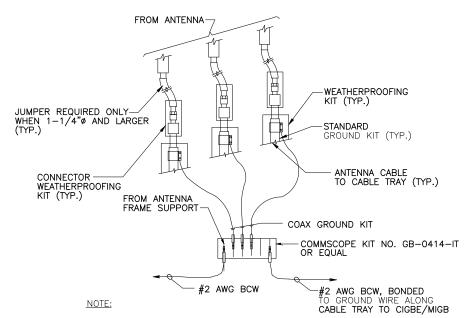


1. DO NOT INSTALL CABLE GROUND KIT AT A BEND AND ALWAYS DIRECT GROUND WIRE DOWN TO CIGBE.



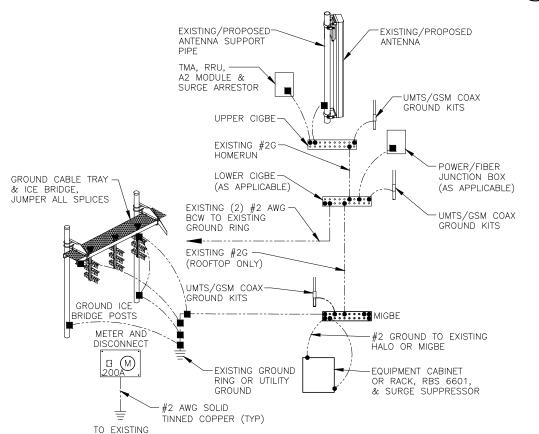

**GROUNDING RISER DIAGRAM** 2

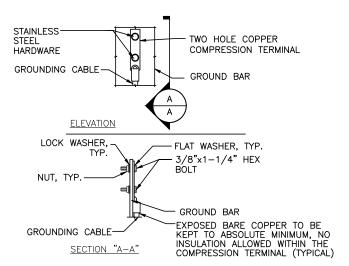

- 1. "DOUBLING UP" OR "STACKING" OF CONNECTION IS NOT PERMITTED.
- 2. OXIDE INHIBITING COMPOUND TO BE USED AT ALL LOCATION.
  3. CADWELD DOWNLEADS FROM UPPER EGB, LOWER EGB, AND MGB

## TYPICAL GROUND BAR CONNECTION DETAIL SCALE: N.T.S


EACH GROUND CONDUCTOR TERMINATING ON ANY GROUND BAR SHALL HAVE AN IDENTIFICATION TAG ATTACHED AT EACH END THAT WILL IDENTIFY ITS ORIGIN AND DESTINATION.

#### SECTION "P" - SURGE PRODUCERS

CABLE ENTRY PORTS (HATCH PLATES) (#2 AWG) GENERATOR FRAMEWORK (IF AVAILABLE) "(#2 AWG) COMMERCIAL POWER COMMON NEUTRAL/GROUND BOND (#2 AWG) +24V POWER SUPPLY RETURN BAR (#2 AWG) -48V POWER SUPPLY RETURN BAR (#2 AWG) RECTIFIER FRAMES.

### SECTION "A" - SURGE ABSORBERS

INTERIOR GROUND RING (#2 AWG)
EXTERNAL EARTH GROUND FIELD (BURIED GROUND RING) (#2 AWG)
METALLIC COLD WATER PIPE (IF AVAILABLE) (#2 AWG) BUILDING STEEL (IF AVAILABLE) (#2 AWG)

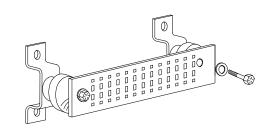





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SERVICE GROUND


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> 2577 MAIN STREET GLASTONBURY, CT 06033 HARTFORD COUNTY



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NOTE:

1. CONTRACTOR TO CONFIRM ALL PARTS.
2. INSTALL ALL EQUIPMENT TO
MANUFACTURER'S RECOMMENDATIONS

MANUFACTURER S RECOMMENDATIONS

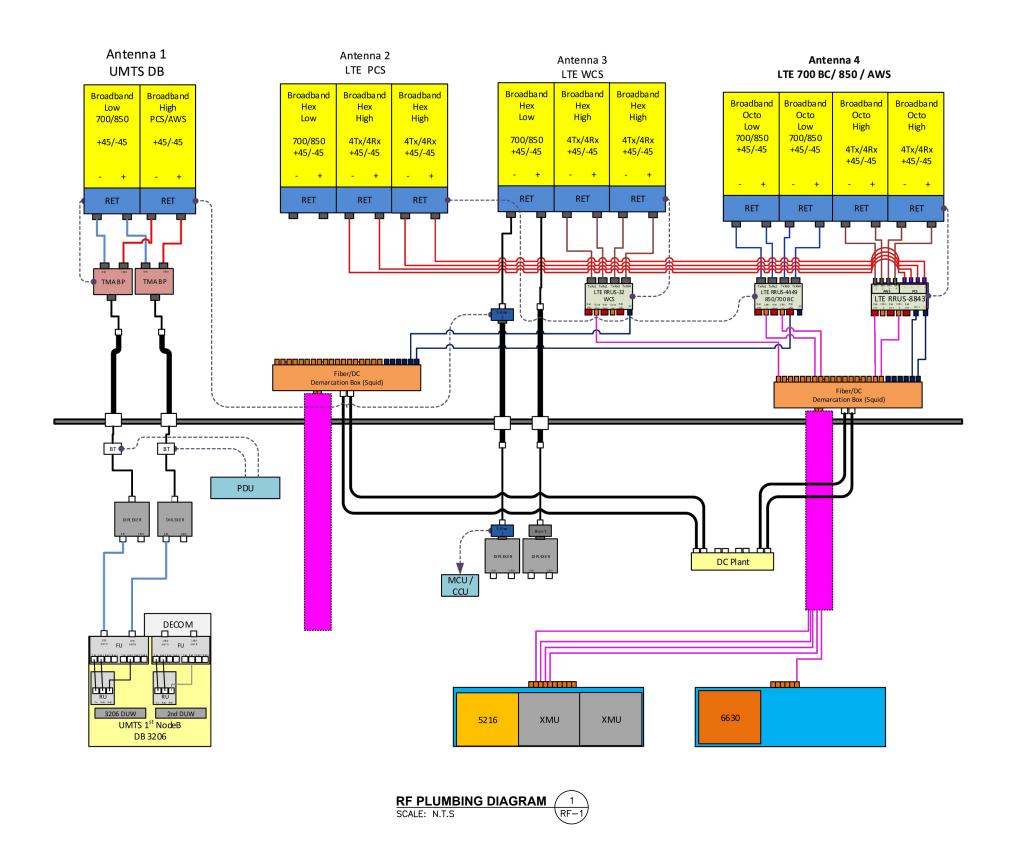NOTE:

REFER TO THE FINAL RF DATA SHEET FOR FINAL ANTENNA SETTINGS.

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RF PLUMBING DIAGRAM
(LTE 3C\_4C\_5C\_4TX4RX)

SITE NUMBER DRAWING NUMBER REV

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