



Filed by:
Kri Pelletier, Property Specialist - SBA Communications
134 Flanders Rd., Suite 125, Westborough, MA 01581
508.251.0720 x 3804 - kpelletier@sbsite.com

March 20, 2018

Melanie A. Bachman
Acting Executive Director
Connecticut Siting Council
Ten Franklin Square
New Britain, CT 06051

Notice of Exempt Modification
1 Westerberg Drive, Farmington, CT
41 43 49.8 N
-72 50 7.8 W
Sprint #: CT33XC579

Dear Ms. Bachman:

Sprint currently maintains antennas at the 150-foot level of the existing 155-foot Monopole Tower at 1 Westerberg Drive in Farmington, CT. The tower is owned by SBA 2012 TC Assets, LLC. The property is owned by the Town of Farmington. Sprint now intends to replace (3) existing cell antennas with (3) newer technology cell antennas at the 150-foot level of the tower. The proposed full scope of work is as follows:

Remove: N/A

Remove and Replace:

- Remove (3) RFS - APXVSP18-C-A20 – Panel Antennas and replace with (3) Commscope DHHTT65B-3XR – Panel Antennas

Install:

- (3) RFS KIT-FD9R6004/1C-DL – Diplexers
- (3) CCI DPO-7126Y-0-T1 – Diplexers
- (3) 3/8" RET lines

At ground level (no change to existing compound size or area – all work within leased area of compound):

- (3) 2.5 GHz RRHs mounted on H-Frame
- (3) 800 MHz RRHs mounted on H-Frame

Existing Equipment to Remain (Including entitlements):

- (4) RFS - ACU-A20-N – RETs
- (1) Concealed 27" Canister
- (12) 1-5/8" lines



This facility was originally approved by the Council on June 9th, 2004 under Docket 282. The tower was:

- to be designed as a flagpole
- to be constructed no taller than 156 feet above ground level
- to provide the proposed telecommunications services to both public and private entities
- to include a D&M plan
- to have RF updates when changes warranted
- to allow public/private shared space for fair consideration
- to provide space for municipal use for no compensation
- to have obsolete antennas removed within 60 days

This modification complies with all conditions.

Please accept this letter as notification pursuant to Regulations of Connecticut State Agencies §16-50j-73, for construction that constitutes an exempt modification pursuant to R.C.S.A. §16.50j-72(b)(2). In accordance with R.C.S.A. § 16.50j-73, a copy of this letter is being sent to the Town of Farmington's Council Chair, Nancy Nickerson, as elected official, Town Manager, Kathleen A. Eagen as representative for the Town as landowner, and Zoning Enforcement Officer, Bruce Cyr. (Separate notice is not being sent to tower owner, as it belongs to SBA.)

The planned modifications to the facility fall squarely within those activities explicitly provided for in R.C.S.A. §16.50j-72(b)(2).

1. The proposed modifications will not result in an increase in the height of the existing structure.
2. The proposed modification will not require the extension of the site boundary.
3. The proposed modifications will not increase noise levels at the facility by six decibels or more, or to levels that exceed state and local criteria.
4. The operation of the replacement antennas will not increase radio frequency emissions at the facility to a level at or above the Federal Communications Commission safety standard.
5. The proposed modification will not cause a change or alteration in the physical or environmental characteristics of the site.
6. The existing structure and its foundation can support the proposed loading.

For the foregoing reasons, Sprint respectfully submits that the proposed modifications to the above-referenced telecommunication facility constitute an exempt modifications under R.C.S.A. § 16-50j-72(b)(2).

Sincerely,

Kri Pelletier
Property Specialist
SBA COMMUNICATIONS CORPORATION
134 Flanders Rd., Suite 125
Westborough, MA 01581
508.251.0720 x3804 + T
508.366.2610 + F
203.446.7700 + C
kpelletier@sbsite.com

Attachments



cc: Nancy Nickerson, Council Chair / with attachments
Town of Farmington, 45 Farmington Ridge Drive, Farmington, CT 06032

Kathleen A. Eagen, Town Manager / with attachments
Town of Farmington, Town Manager's Office, 1 Monteith Drive, Farmington, CT 06032

Bruce Cyr, Zoning Enforcement Officer / with attachments
Town of Farmington, Office of Planning & Zoning, 1 Monteith Drive, Farmington, CT 06032



POWER DENSITY

SPRINT Site Inventory and Power Data by Antenna

Sector:	A	Sector:	B	Sector:	C
Antenna #:	1	Antenna #:	1	Antenna #:	1
Make / Model:	Commscope DHHTT65B-3XR	Make / Model:	Commscope DHHTT65B-3XR	Make / Model:	Commscope DHHTT65B-3XR
Gain:	13.35 / 15.25/15.05 dBd	Gain:	13.35 / 15.25 / 15.05 dBd	Gain:	13.35 / 15.25 / 15.05 dBd
Height (AGL):	150 feet	Height (AGL):	150 feet	Height (AGL):	150 feet
Frequency Bands	850 MHz / 1900 MHz (PCS) / 2500 MHz (BRS)	Frequency Bands	850 MHz / 1900 MHz (PCS) / 2500 MHz (BRS)	Frequency Bands	850 MHz / 1900 MHz (PCS) / 2500 MHz (BRS)
Channel Count	18	Channel Count	18	Channel Count	18
Total TX Power(W):	380 Watts	Total TX Power(W):	380 Watts	Total TX Power(W):	380 Watts
ERP (W):	11,775.31	ERP (W):	11,775.31	ERP (W):	11,775.31
Antenna A1 MPE%	2.21 %	Antenna B1 MPE%	2.21 %	Antenna C1 MPE%	2.21 %

Site Composite MPE%	
Carrier	MPE%
SPRINT – Max per sector	2.21 %
Nextel	0.59 %
T-Mobile	0.29 %
AT&T	3.24 %
Verizon Wireless	1.11 %
Site Total MPE %:	7.44 %

SPRINT Sector A Total:	2.21 %
SPRINT Sector B Total:	2.21 %
SPRINT Sector C Total:	2.21 %
Site Total:	7.44 %

SPRINT Frequency Band / Technology Power Values (Per Sector)	# Channels	Watts ERP (Per Channel)	Height (feet)	Total Power Density (μ W/cm ²)	Frequency (MHz)	Allowable MPE (μ W/cm ²)	Calculated % MPE
Sprint 850 MHz CDMA	1	432.54	150	0.75	850 MHz	567	0.13%
Sprint 850 MHz LTE	2	432.54	150	1.50	850 MHz	567	0.26%
Sprint 1900 MHz (PCS) CDMA	5	535.94	150	4.65	1900 MHz (PCS)	1000	0.46%
Sprint 1900 MHz (PCS) LTE	2	1,339.86	150	4.65	1900 MHz (PCS)	1000	0.46%
Sprint 2500 MHz (BRS) LTE	8	639.78	150	8.87	2500 MHz (BRS)	1000	0.89%
Total*:						2.21%	

*NOTE: Totals may vary by 0.01% due to summing of remainders


ORIGIN ID:BBFA (508) 251-0720
KRI PELLETIER
SBA COMMUNICATIONS CORPORATION
134 FLANDERS RD
SUITE 125
WESTBOROUGH MA 01581
UNITED STATES US

SHIP DATE: 20MAR18
ACTWGT: 1.00 LB
CAD: 105843304/INLET3980
BILL SENDER

TO **NANCY NICKERSON, COUNCIL CHAIR**
TOWN OF FARMINGTON
45 FARMINGTON RIDGE DRIVE

FARMINGTON CT 06032
(508) 251-0720 REF: 10-56-92009-6089
NV: DEPT:
PO:

552J1107F5/DCA5

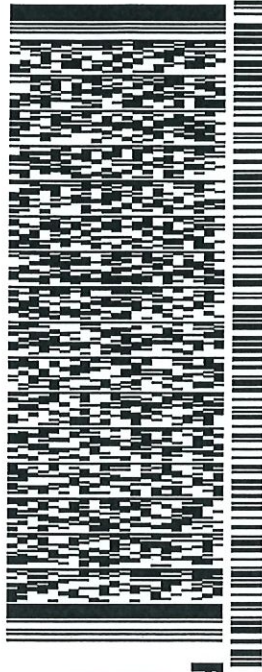

J181118012601uv

TRK# 7717 8557 4359
0201
WED - 21 MAR 10:30A
PRIORITY OVERNIGHT

EB MPEA
06032
CT-US BDL


After printing this label:

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Warning: Use only the printed original label for shipping. Using a photocopy of this label for shipping purposes is fraudulent and could result in additional billing charges, along with the cancellation of your FedEx account number. Use of this system constitutes your agreement to the service conditions in the current FedEx Service Guide, available on fedex.com. FedEx will not be responsible for any claim in excess of \$100 per package, whether the result of loss, damage, delay, non-delivery, misdelivery, or misinformation, unless you declare a higher value, pay an additional charge, document your actual loss and file a timely claim. Limitations found in the current FedEx Service Guide apply. Your right to recover from FedEx for any loss, including intrinsic value of the package, loss of sales, income interest, profit, attorney's fees, costs, and other forms of damage whether direct, incidental, consequential, or special is limited to the greater of \$100 or the authorized declared value. Recovery cannot exceed actual documented loss. Maximum for items of extraordinary value is \$1,000, e.g. jewelry, precious metals, negotiable instruments and other items listed in our Service Guide. Written claims must be filed within strict time limits, see current FedEx Service Guide.

ORIGIN ID:BBFA (508) 251-0720
KRI PELLETIER
SBA COMMUNICATIONS CORPORATION
134 FLANDERS RD
SUITE 125
WESTBOROUGH, MA 01581
UNITED STATES US


SHIP DATE: 20MAR18
ACTWTG: 1.00 LB
CAD: 105843304/NET3980

BILL SENDER

TO **KATHLEEN A. EAGEN, TOWN MANAGER**
TOWN OF FARMINGTON
1 MONTEITH DRIVE

FARMINGTON CT 06032
(508) 251-0720 REF: 10-56-92009-6089
INV: DEPT:

552J1.07F5/DCA5

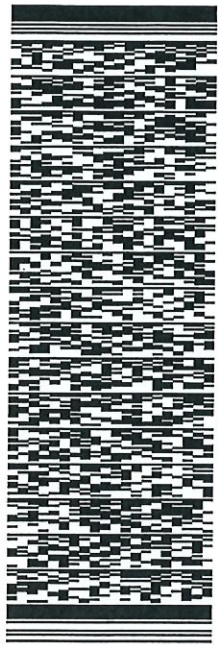

J18118012601uy

TRK# 77117 8561 0590
0201

WED - 21 MAR 10:30A
PRIORITY OVERNIGHT

EB MPEA
06032
CT-US BDL



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KRI PELLETIER
SBA COMMUNICATIONS CORPORATION
134 FLANDERS RD
SUITE 125
WESTBOROUGH, MA 01581
UNITED STATES US

SHIP DATE: 20MAR18
ACTWGT: 1.00 LB
CAD: 105843304/NET13980


BILL SENDER

TO **BRUCE CYR, ZONING OFFICER**
TOWN OF FARMINGTON
1 MONTEITH DRIVE

FARMINGTON CT 06032

(508) 251-0720 REF: 10-56-92009-6089

INV: DEPT:

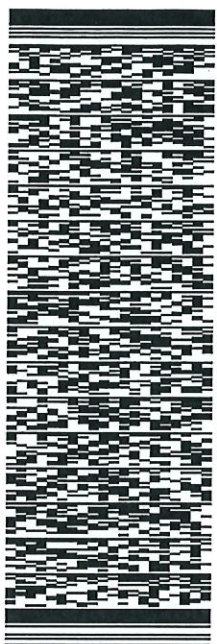

J18118012601UV

TRK# 7717 8565 0376
0201

WED - 21 MAR 10:30A
PRIORITY OVERNIGHT

EB MPEA
06032
CT-US BDL



552J107F5/DCA5


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The Assessor's office is responsible for the maintenance of records on the ownership of properties. Assessments are computed at 70% of the estimated market value of real property at the time of the last revaluation which was 2012.



Information on the Property Records for the Municipality of Farmington was last updated on 3/15/2018.

Property Summary Information

Parcel Data And Values Building ▾ Outbuildings Sales Google Map

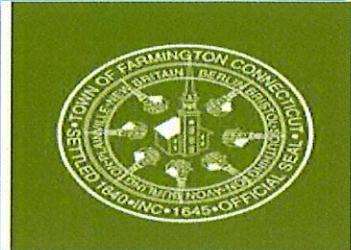Parcel Information

Location:	1 WESTERBERG DR	Property Use:	Special Purpose	Primary Use:	Sewage Treatment Plant
Unique ID:	21350001	Map Block Lot:	0078 38	Acres:	28.00
490 Acres:	0.00	Zone:	CR	Volume / Page:	0148/0503
Developers Map / Lot:		Census:	4602-01		

Value Information

	Appraised Value	Assessed Value
Land	4,200,000	2,940,000
Buildings	27,707,914	19,395,540
Detached Outbuildings	0	0
Total	31,907,914	22,335,540

Owner's Information

Owner's Data

FARMINGTON TOWN OF
TREATMENT PLANT
00000

[Back To Search \(JavaScript:window.history.back\(1\);\)](#)

[Print View \(PrintPage.aspx?towncode=052&uniqueid=21350001\)](#)

Information Published With Permission From The Assessor



RADIO FREQUENCY EMISSIONS ANALYSIS REPORT EVALUATION OF HUMAN EXPOSURE POTENTIAL TO NON-IONIZING EMISSIONS

SPRINT Existing Facility

Site ID: CT33XC579

Water Treatment Plant
1 Westerberg Drive
Farmington, CT 06032

March 3, 2018

EBI Project Number: 6218001767

Site Compliance Summary	
Compliance Status:	COMPLIANT
Site total MPE% of FCC general population allowable limit:	7.44 %



March 3, 2018

SPRINT

Attn: RF Engineering Manager
1 International Boulevard, Suite 800
Mahwah, NJ 07495

Emissions Analysis for Site: **CT33XC579 – Water Treatment Plant**

EBI Consulting was directed to analyze the proposed SPRINT facility located at **1 Westerberg Drive, Farmington, CT**, for the purpose of determining whether the emissions from the Proposed SPRINT Antenna Installation located on this property are within specified federal limits.

All information used in this report was analyzed as a percentage of current Maximum Permissible Exposure (% MPE) as listed in the FCC OET Bulletin 65 Edition 97-01 and ANSI/IEEE Std C95.1. The FCC regulates Maximum Permissible Exposure in units of microwatts per square centimeter ($\mu\text{W}/\text{cm}^2$). The number of $\mu\text{W}/\text{cm}^2$ calculated at each sample point is called the power density. The exposure limit for power density varies depending upon the frequencies being utilized. Wireless Carriers and Paging Services use different frequency bands each with different exposure limits, therefore it is necessary to report results and limits in terms of percent MPE rather than power density.

All results were compared to the FCC (Federal Communications Commission) radio frequency exposure rules, 47 CFR 1.1307(b)(1) – (b)(3), to determine compliance with the Maximum Permissible Exposure (MPE) limits for General Population/Uncontrolled environments as defined below.

General population/uncontrolled exposure limits apply to situations in which the general population may be exposed or in which persons who are exposed as a consequence of their employment may not be made fully aware of the potential for exposure or cannot exercise control over their exposure. Therefore, members of the general population would always be considered under this category when exposure is not employment related, for example, in the case of a telecommunications tower that exposes persons in a nearby residential area.

General population exposure to radio frequencies is regulated and enforced in units of microwatts per square centimeter ($\mu\text{W}/\text{cm}^2$). The general population exposure limits for the 850 MHz Band is approximately $567 \mu\text{W}/\text{cm}^2$. The general population exposure limit for the 1900 MHz (PCS) and 2500 MHz (BRS) bands is $1000 \mu\text{W}/\text{cm}^2$. Because each carrier will be using different frequency bands, and each frequency band has different exposure limits, it is necessary to report percent of MPE rather than power density.



Occupational/controlled exposure limits apply to situations in which persons are exposed as a consequence of their employment and in which those persons who are exposed have been made fully aware of the potential for exposure and can exercise control over their exposure. Occupational/controlled exposure limits also apply where exposure is of a transient nature as a result of incidental passage through a location where exposure levels may be above general population/uncontrolled limits (see below), as long as the exposed person has been made fully aware of the potential for exposure and can exercise control over his or her exposure by leaving the area or by some other appropriate means.

Additional details can be found in FCC OET 65.

CALCULATIONS

Calculations were done for the proposed SPRINT Wireless antenna facility located at **1 Westerberg Drive, Farmington, CT**, using the equipment information listed below. All calculations were performed per the specifications under FCC OET 65. Since SPRINT is proposing highly focused directional panel antennas, which project most of the emitted energy out toward the horizon, all calculations were performed assuming a lobe representing the maximum gain of the antenna per the antenna manufactures supplied specifications, minus 10 dB, was focused at the base of the tower. For this report the sample point is the top of a 6-foot person standing at the base of the tower.

For all calculations, all equipment was calculated using the following assumptions:

- 1) 1 CDMA channels (850 MHz) were considered for each sector of the proposed installation. These Channels have a transmit power of 20 Watts per Channel.
- 2) 2 LTE channels (850 MHz) were considered for each sector of the proposed installation. These Channels have a transmit power of 20 Watts per Channel.
- 3) 5 CDMA channels (1900 MHz (PCS)) were considered for each sector of the proposed installation. These Channels have a transmit power of 16 Watts per Channel.
- 4) 2 LTE channels (1900 MHz (PCS)) were considered for each sector of the proposed installation. These Channels have a transmit power of 40 Watts per Channel.
- 5) 8 LTE channels (2500 MHz (BRS)) were considered for each sector of the proposed installation. These Channels have a transmit power of 20 Watts per Channel.



- 6) All radios at the proposed installation were considered to be running at full power and were uncombined in their RF transmissions paths per carrier prescribed configuration. Per FCC OET Bulletin No. 65 - Edition 97-01 recommendations to achieve the maximum anticipated value at each sample point, all power levels emitting from the proposed antenna installation are increased by a factor of 2.56 to account for possible in-phase reflections from the surrounding environment. This is rarely the case, and if so, is never continuous.
- 7) For the following calculations, the sample point was the top of a 6-foot person standing at the base of the tower. The maximum gain of the antenna per the antenna manufactures supplied specifications minus 10 dB was used in this direction. This value is a very conservative estimate as gain reductions for these particular antennas are typically much higher in this direction.
- 8) The antennas used in this modeling are the **Commscope DT465B-2XR** for transmission in the 850 MHz, 1900 MHz (PCS) and 2500 MHz (BRS) frequency bands. This is based on feedback from the carrier with regards to anticipated antenna selection. Maximum gain values for all antennas are listed in the Inventory and Power Data table below. The maximum gain of the antenna per the antenna manufactures supplied specifications, minus 10 dB, was used for all calculations. This value is a very conservative estimate as gain reductions for these particular antennas are typically much higher in this direction.
- 9) The antenna mounting height centerlines of the proposed antennas are **150 feet** above ground level (AGL) for **Sector A**, **150 feet** above ground level (AGL) for **Sector B** and **150 feet** above ground level (AGL) for Sector C.
- 10) Emissions values for additional carriers were taken from the Connecticut Siting Council active database. Values in this database are provided by the individual carriers themselves.

All calculations were done with respect to uncontrolled / general population threshold limits.



SPRINT Site Inventory and Power Data by Antenna

Sector:	A	Sector:	B	Sector:	C
Antenna #:	1	Antenna #:	1	Antenna #:	1
Make / Model:	Commscope DHHTT65B-3XR	Make / Model:	Commscope DHHTT65B-3XR	Make / Model:	Commscope DHHTT65B-3XR
Gain:	13.35 / 15.25/15.05 dBd	Gain:	13.35 / 15.25 / 15.05 dBd	Gain:	13.35 / 15.25 / 15.05 dBd
Height (AGL):	150 feet	Height (AGL):	150 feet	Height (AGL):	150 feet
Frequency Bands	850 MHz / 1900 MHz (PCS) / 2500 MHz (BRS)	Frequency Bands	850 MHz / 1900 MHz (PCS) / 2500 MHz (BRS)	Frequency Bands	850 MHz / 1900 MHz (PCS) / 2500 MHz (BRS)
Channel Count	18	Channel Count	18	Channel Count	18
Total TX Power(W):	380 Watts	Total TX Power(W):	380 Watts	Total TX Power(W):	380 Watts
ERP (W):	11,775.31	ERP (W):	11,775.31	ERP (W):	11,775.31
Antenna A1 MPE%	2.21 %	Antenna B1 MPE%	2.21 %	Antenna C1 MPE%	2.21 %

Site Composite MPE%	
Carrier	MPE%
SPRINT – Max per sector	2.21 %
Nextel	0.59 %
T-Mobile	0.29 %
AT&T	3.24 %
Verizon Wireless	1.11 %
Site Total MPE %:	7.44 %

SPRINT Sector A Total:	2.21 %
SPRINT Sector B Total:	2.21 %
SPRINT Sector C Total:	2.21 %
Site Total:	7.44 %

SPRINT _ Frequency Band / Technology Power Values (Per Sector)	# Channels	Watts ERP (Per Channel)	Height (feet)	Total Power Density ($\mu\text{W}/\text{cm}^2$)	Frequency (MHz)	Allowable MPE ($\mu\text{W}/\text{cm}^2$)	Calculated % MPE
Sprint 850 MHz CDMA	1	432.54	150	0.75	850 MHz	567	0.13%
Sprint 850 MHz LTE	2	432.54	150	1.50	850 MHz	567	0.26%
Sprint 1900 MHz (PCS) CDMA	5	535.94	150	4.65	1900 MHz (PCS)	1000	0.46%
Sprint 1900 MHz (PCS) LTE	2	1,339.86	150	4.65	1900 MHz (PCS)	1000	0.46%
Sprint 2500 MHz (BRS) LTE	8	639.78	150	8.87	2500 MHz (BRS)	1000	0.89%
						Total*:	2.21%

*NOTE: Totals may vary by 0.01% due to summing of remainders



Summary

All calculations performed for this analysis yielded results that were **within** the allowable limits for general population exposure to RF Emissions.

The anticipated maximum composite contributions from the SPRINT facility as well as the site composite emissions value with regards to compliance with FCC's allowable limits for general population exposure to RF Emissions are shown here:

SPRINT Sector	Power Density Value (%)
Sector A:	2.21 %
Sector B:	2.21 %
Sector C:	2.21 %
SPRINT Maximum Total (per sector):	2.21 %
Site Total:	7.44 %
Site Compliance Status:	COMPLIANT

The anticipated composite MPE value for this site assuming all carriers present is **7.44 %** of the allowable FCC established general population limit sampled at the ground level. This is based upon values listed in the Connecticut Siting Council database for existing carrier emissions.

FCC guidelines state that if a site is found to be out of compliance (over allowable thresholds), that carriers over a 5% contribution to the composite value will require measures to bring the site into compliance. For this facility, the composite values calculated were well within the allowable 100% threshold standard per the federal government.



Tower Engineering Solutions

Phone (972) 483-0607, Fax (972) 975-9615
8445 Freeport Parkway, Suite 375, Irving, Texas 75063

Structural Analysis Report

Existing 155 ft SABRE Monopole

Customer Name: SBA Communications Corp

Customer Site Number: CT46141-A

Customer Site Name: Water Treatment Plant 2, CT

Carrier Name: Sprint Nextel

Carrier Site ID / Name: CT33XC579 / Water Treatment Plant

Site Location: 1 Westerberg Drive

FARMINGTON, Connecticut

HARTFORD County

Latitude: 41.730499

Longitude: -72.835500

Analysis Result:

Max Structural Usage: 78.5% [Pass]

Max Foundation Usage: 33.0% [Pass]

Additional Usage Caused by New Mount/Mount Modification: n/a

Report Prepared By: Mariana Franco



Introduction

The purpose of this report is to summarize the analysis results on the 155 ft SABRE Monopole to support the proposed antennas and transmission lines in addition to those currently installed. Any modification listed under Sources of Information was assumed completed and was included in this analysis.

Sources of Information

Tower Drawings	Tower Drawing prepared by Sabre, Job #05-07054 Rev B dated 9/2/04 Canister Drawing prepared by Stealth, Title #CUST-CELL-4C-80-40 Rev A dated 9/23/04
Foundation Drawing	Foundation Drawing prepared by Sabre, Job #05-07054 Rev B dated 9/2/04
Geotechnical Report	Geotechnical Report prepared by Clarence Welti Assoc, dated 6/18/04
Modification Drawings	Modification Drawing prepared by Stealth, Job #AT12-00957W-05R1 dated 9/18/12

Analysis Criteria

The rigorous analysis was performed in accordance with the requirements and stipulations of the ANSI/TIA/EIA 222-G. In accordance with this standard, the structure was analyzed using **TESPoles**, a proprietary analysis software. The program considers the structure as an elastic 3-D model with second-order effects and temperature effects incorporated in the analysis. The analysis was performed using multiple wind directions.

Wind Speed Used in the Analysis:	Ultimate Design Wind Speed $V_{ult} = 125.0$ mph (3-Sec. Gust)/ Nominal Design Wind Speed $V_{asd} = 97.0$ mph (3-Sec. Gust)
Wind Speed with Ice:	50 mph (3-Sec. Gust) with 1" radial ice concurrent
Operational Wind Speed:	60 mph + 0" Radial ice
Standard/Codes:	ANSI/TIA/EIA 222-G / 2012 IBC / 2016 Connecticut State Building Code
Exposure Category:	C
Structure Class:	II
Topographic Category:	1
Crest Height:	0 ft
Seismic Parameters:	$S_5 = 0.183g$, $S_1 = 0.064g$

This structural analysis is based upon the tower being classified as a Structure Class II; however, if a different classification is required subsequent to the date hereof, the tower classification will be changed to meet such requirement and a new structural analysis will be run.

Existing Antennas, Mounts and Transmission Lines

The table below summarizes the antennas, mounts and transmission lines that were considered in the analysis as existing on the tower.

Items	Elevation (ft)	Qty.	Antenna Descriptions	Mount Type & Qty.	Transmission Lines	Owner
-	150.0	3	RFS - APXVSP18-C-A20 - Panel	Concealed (27" Canister)	(12) 1 5/8"	Sprint
-		4	RFS - ACU-A20-N - RET			
5	139.0	3	CCI - TPA-65R-LCUUUU-H8 - Panel	Concealed (36" Canister)	(6) 1 5/8"	AT&T
6		6	CCI - DTMABP0723VG12A - TMA/TTA			
7		6	Kaelus - DBC0062F3V52-1 - Diplexer			
8	129.0	3	RFS - APX18-206517S-C-A20 - Panel	Concealed (29" Canister)	(6) 1 5/8"	T-Mobile
9	127.0	6	RFS - CBC721-DF - Diplexers	Concealed (30" Canister)	(12) 1 5/8"	Verizon
10	122.0	3	Commscope - SBNHH-1D6565A - Panel			

Proposed Carrier’s Final Configuration of Antennas, Mounts and Transmission Lines

Information pertaining to the proposed carrier’s final configuration of antennas and transmission lines was provided by SBA Communications Corp. The proposed antennas and lines are listed below.

Items	Elevation (ft)	Qty.	Antenna Descriptions	Mount Type & Qty.	Transmission Lines	Owner
1	150.0	3	Commscope DHHTT65B-3XR - Panel	Concealed (27" Canister)	(12) 1 5/8" (3) 3/8" RET Line	Sprint Nextel
2		3	RFS KIT-FD9R6004/1C-DL - Diplexers			
3		3	CCI DPO-7126Y-0-T1 - Diplexers			
4		4	RFS ACU-A20-N - RETs			

All transmission lines are considered running inside of the pole shafts.

Analysis Results

The results of the structural analysis, performed for the wind and ice loading and antenna equipment as defined above, are summarized as the following:

	Pole shafts	Anchor Bolts	Base Plate	Flange
Max. Usage:	78.5%	67.9%	60.5%	66.1%
Pass/Fail	Pass	Pass	Pass	Pass

Foundations

	Moment (Kip-Ft)	Shear (Kips)
Original Design Reactions	1230.0	13.2
Analysis Reactions	1395.5	16.3
Factored Reactions*	1660.5	17.8
% of Design Reactions	84.0%	91.3%

* Per section 15.5.1 of the TIA-222-G standard, factored reactions were obtained by multiplying a 1.35 factor to the original design reactions.

The foundation has been investigated using the supplied documents and soils report and was found adequate. Therefore, no modification to the foundation will be required.

Operational Condition (Rigidity):

Operational characteristics of the tower are found to be within the limits prescribed by ANSI/TIA/EIA 222-G for the installed antennas. The maximum twist/sway at the elevation of the proposed equipment is 2.2194 degrees under the operational wind speed as specified in the Analysis Criteria.

Conclusions

Based on the analysis results, the existing structure and its foundation were found to be adequate to safely support the existing and proposed equipment and meet the minimum requirements per the ANSI/TIA/EIA 222-G Standard under the design basic wind speed as specified in the Analysis Criteria.

Standard Conditions

1. This analysis was performed based on the information supplied to **(TES) Tower Engineering Solutions, LLC**. Verification of the information provided was not included in the Scope of Work for **TES**. The accuracy of the analysis is dependent on the accuracy of the information provided.
2. The analysis is based on the presumption that the tower members and components along with any existing reinforcement items have been correctly and properly designed, manufactured, installed and maintained.
3. All the existing structural members were assumed to be in good condition with no physical damage or deterioration associated with corrosion.
4. An initial tension of 10% of the break strength on all the existing guy wires was assumed in all the structural analyses of guyed towers unless different values were provided by the client. **TES** cannot take responsibility for the deviations in the analysis results because of differences in the initial tension forces of the existing guy wires.
5. Secondary component or connection secondary components, welds and bolts are assumed to be able to carry their intended original design loads. **TES** cannot take responsibility for verification of the adequacy on the connections, bolts and welds present in the structure.
6. The analyses will be performed based on the codes as specified by the client or based on the best knowledge of the engineering staff of **TES**. In the absence of information to the contrary, all work will be performed in accordance with the latest relevant revision of ANSI/TIA-222. If wind speed and/or ice loads are different from the minimum values recommended by the EIA/TIA-222 standard or other codes, **TES** should be notified in writing and the applicable minimum values provided by the client.
7. The configuration of the existing mounts, antennas, coax and other appurtenances were supplied by the customer for the current structural analysis. **TES** has not visited the tower site to verify the adequacy of the information provided. If there is any discrepancy found in the report regarding the existing conditions, **TES** should be notified immediately to evaluate the effect of the discrepancy on the analysis results.
8. The client will assume responsibility for rework associated with the differences in initially provided information, including tower and foundation information, existing and/or proposed equipment and transmission lines.
9. If a feasibility analysis was performed, final acceptance of changed conditions shall be based upon a rigorous structural analysis.

Usage Diagram - Max Ratio 78.46% at 0.0ft

Structure: CT46141-A-SBA
Site Name: Water Treatment Plant 2, CT
Height: 155.00 (ft)
Base Elev: 0.000 (ft)

Code: EIA/TIA-222-G
Exposure: C
Gh: 1.1


2/16/2018



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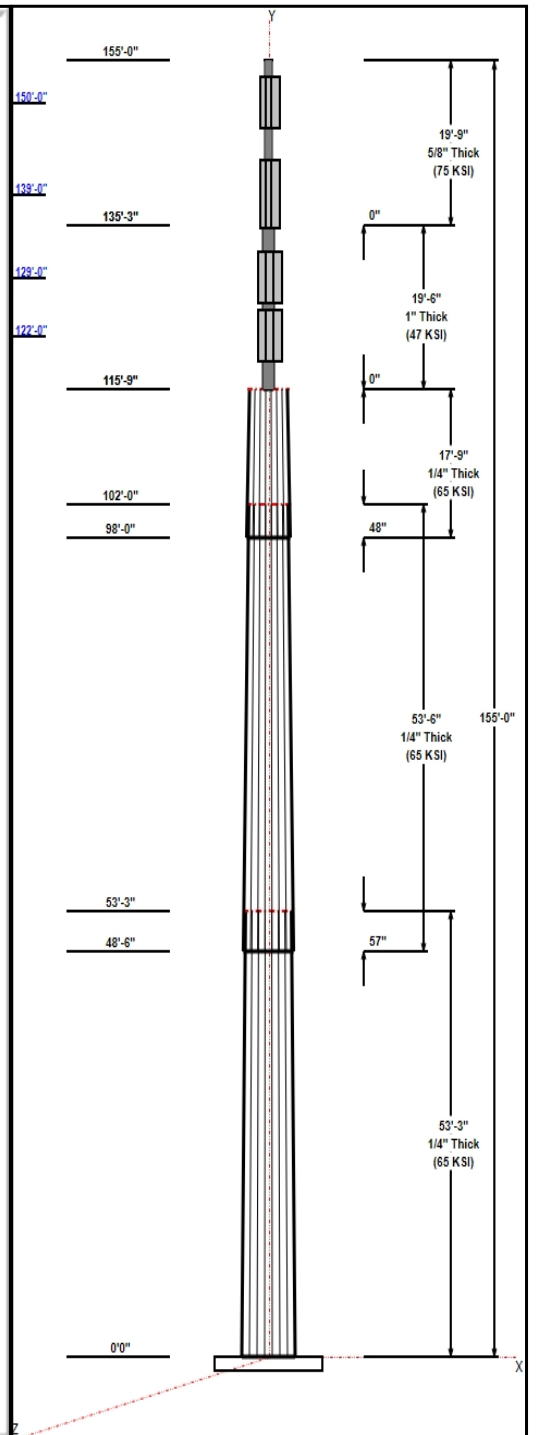
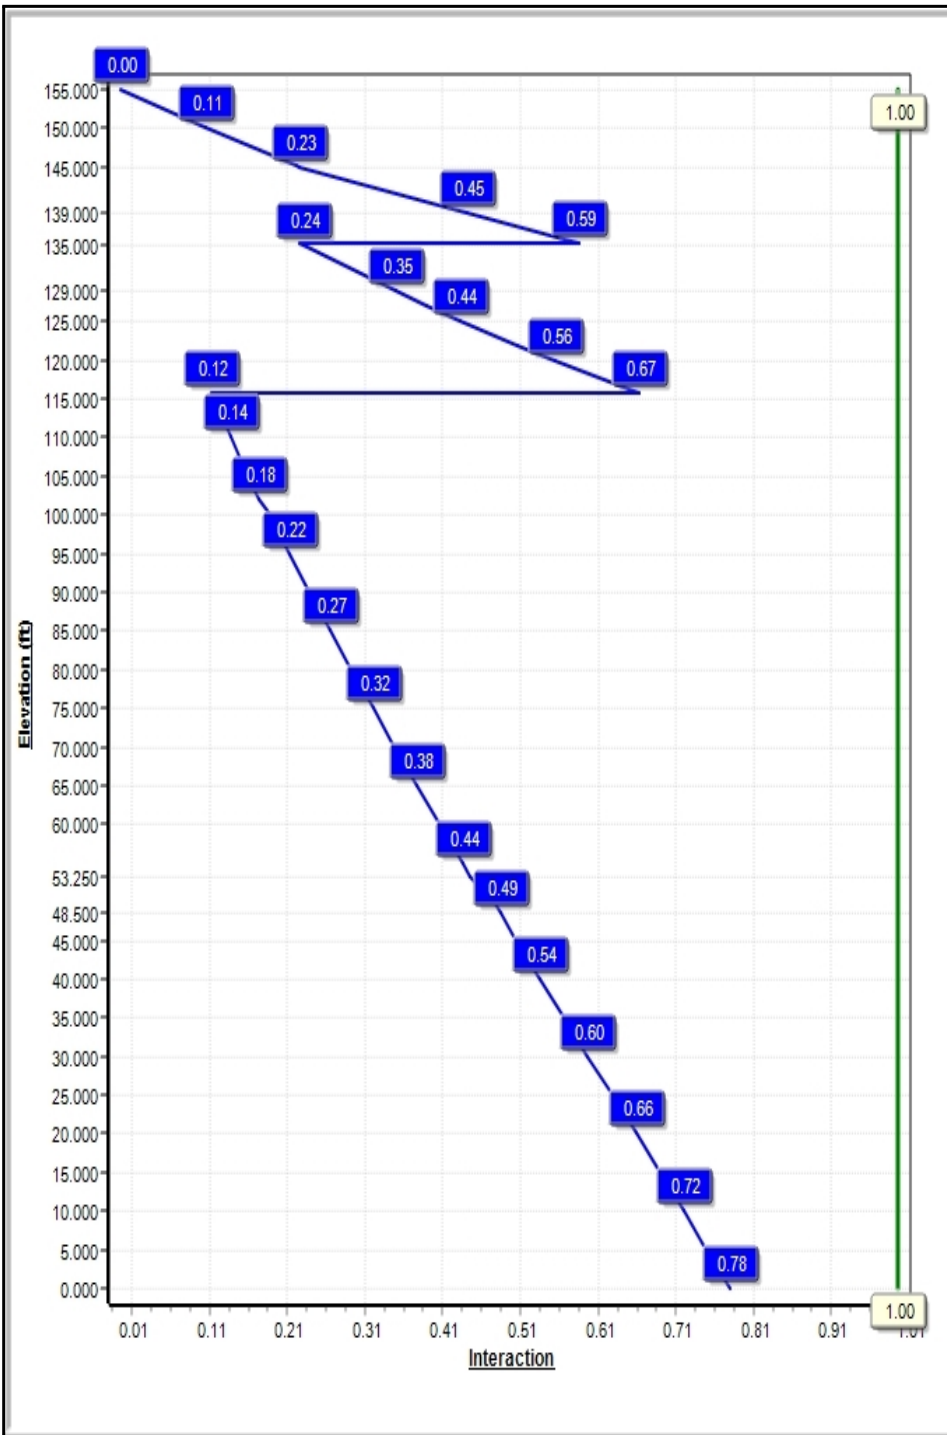
Dead Load Factor: 1.20
Wind Load Factor: 1.60

Load Case : 1.2D + 1.6W 97 mph Wind

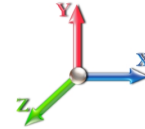

Iterations: 31

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Structure: CT46141-A-SBA

Type: Custom
Site Name: Water Treatment Plant 2, CT
Height: 155.00 (ft)
Base Elev: 0.00 (ft)

Base Shape: 16 Sided
Taper: 0.00000

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Shaft Properties

Seq	Length (ft)	Top (in)	Bottom (in)	Thick (in)	Joint Type	Taper	Grade (ksi)
1	53.25	36.92	43.67	0.250		0.12674	65
2	53.50	31.24	38.02	0.250	Slip	0.12674	65
3	17.75	30.00	32.25	0.250	Slip	0.12674	65
4	19.50	8.00	8.00	1.000	Butt	0.00000	47
5	19.75	5.00	5.00	0.625	Butt	0.00000	75

Discrete Appurtenances

Attach Elev (ft)	Force Elev (ft)	Qty	Description	Carrier
155.00	155.00	1	27" Canister	
155.00	155.00	1	Flag (20"x30")	
155.00	155.00	1	Truck Ball	
150.00	150.00	3	Commscope	Sprint Nextel
150.00	150.00	3	RFS	Sprint Nextel
150.00	150.00	3	CCI DPO-7126Y-0-T1	Sprint Nextel
150.00	150.00	4	RFS ACU-A20-N	Sprint Nextel
145.12	145.12	1	27" Canister & 36"	
139.00	139.00	3	TPA-65R-LCUUUU-H8	AT&T
139.00	139.00	6	DTMABP0723VG12A	AT&T
139.00	139.00	6	DBC0062F3V52-1	AT&T
135.25	135.25	1	36" Canister & 29"	
129.00	129.00	3	APX18-206517S-C-A20	T-Mobile
127.00	127.00	6	CBC721-DF	Verizon
125.50	125.50	1	29" Canister & 30"	
122.00	122.00	3	SBNHH-1D6565A	Verizon
115.75	115.75	1	30" Canister	

Linear Appurtenances

Elev From (ft)	Elev To (ft)	Placement	Description	Carrier
0.00	150.00	Inside	1 5/8" Coax	Sprint Nextel
0.00	150.00	Inside	3/8" RET	Sprint Nextel
0.00	139.00	Inside	1 5/8" Coax	AT&T
0.00	129.00	Inside	1 5/8" Coax	T-Mobile
0.00	122.00	Inside	1 5/8" Coax	Verizon

Anchor Bolts


Qty	Specifications	Grade (ksi)	Arrangement
8	2.25" 18J	75.0	Cluster

Base Plate

Thickness (in)	Specifications (in)	Grade (ksi)	Geometry
2.2500	47.0	60.0	Clipped

Reactions

Load Case	Moment (FT-Kips)	Shear (Kips)	Axial (Kips)
1.2D + 1.6W 97 mph Wind	1395.5	16.3	25.0
0.9D + 1.6W 97 mph Wind	1378.9	16.3	18.7
1.2D + 1.0Di + 1.0Wi 50 mph Wind	490.2	5.3	40.5
1.2D + 1.0E	37.6	0.4	25.0
0.9D + 1.0E	37.1	0.4	18.8

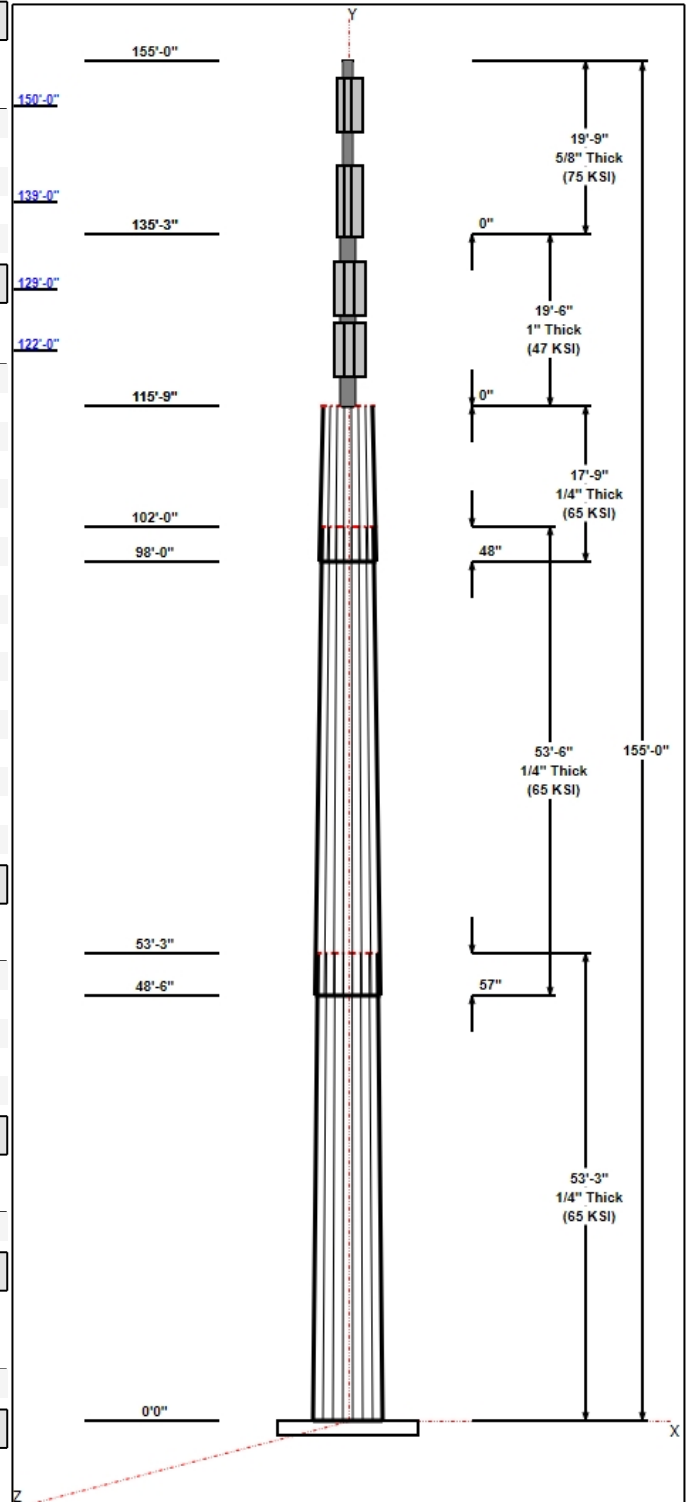

Structure: CT46141-A-SBA

Type: Custom
Site Name: Water Treatment Plant 2, CT
Height: 155.00 (ft)
Base Elev: 0.00 (ft)

Base Shape: 16 Sided
Taper: 0.00000

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1.0D + 1.0W 60 mph Wind 343.0 4.0 20.8


Structure: CT46141-A-SBA - Coax Line Placement

Type: Stealth
Site Name: Water Treatment Plant 2, CT
Height: 155.00 (ft)

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Shaft Properties

Structure: CT46141-A-SBA	Code: EIA/TIA-222-G	2/16/2018
Site Name: Water Treatment Plant 2, CT	Exposure: C	
Height: 155.00 (ft)	Crest Height: 0.00	
Base Elev: 0.000 (ft)	Site Class: B - Competent Rock	
Gh: 1.1	Topography: 1	Struct Class: II

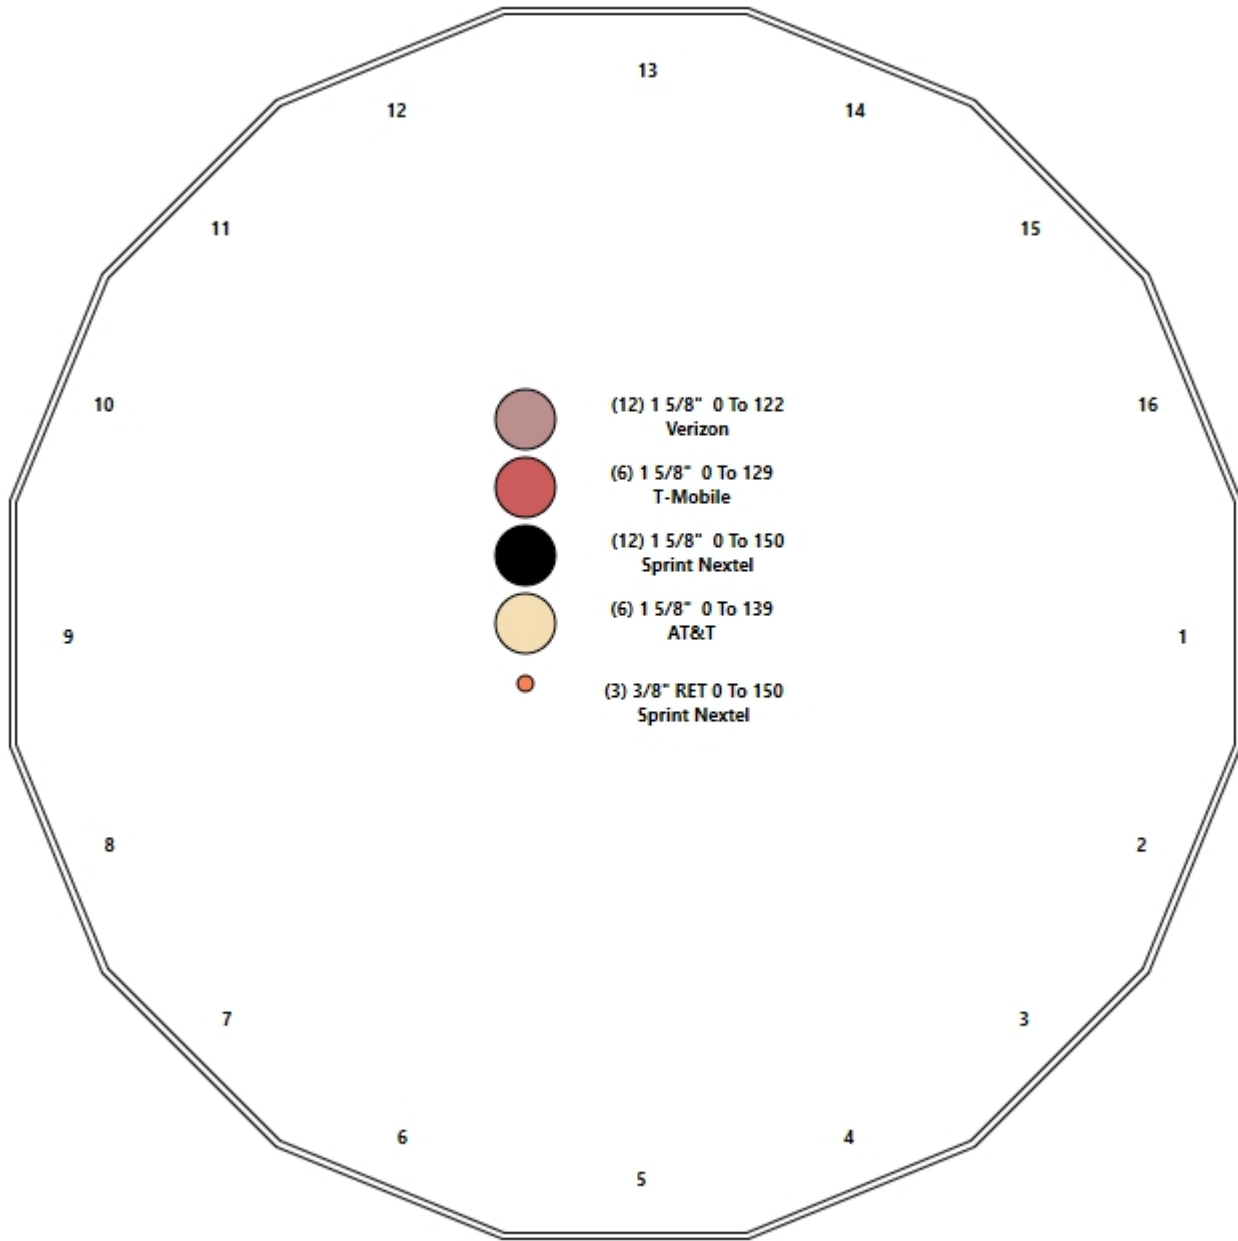

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Sec. No.	Shape	Length (ft)	Thick (in)	Fy (ksi)	Joint Type	Overlap (in)	Weight (lb)
1	16	53.250	0.2500	65		0.00	5,787
2	16	53.500	0.2500	65	Slip	57.00	4,992
3	16	17.750	0.2500	65	Slip	48.00	1,487
4	R	19.500	1.0000	47	Flange	0.00	1,459
5	R	19.750	0.6250	75	Flange	0.00	577
Total Shaft Weight:							14,302

Bottom

Top

Sec. No.	Dia (in)	Elev (ft)	Area (sqin)	Ix (in^4)	W/t Ratio	D/t Ratio	Dia (in)	Elev (ft)	Area (sqin)	Ix (in^4)	W/t Ratio	D/t Ratio	Taper
1	43.67	0.00	34.63	8247.35	33.15	174.68	36.92	53.25	29.25	4968.43	27.79	147.6	0.126739
2	38.02	48.50	30.12	5429.95	28.66	152.09	31.24	102.00	24.72	2999.31	23.27	124.9	0.126739
3	32.25	98.00	25.52	3301.26	24.07	129.00	30.00	115.75	23.73	2652.81	22.28	120.0	0.126739
4	8.00	115.7	21.99	134.80	0.00	8.00	8.00	135.25	21.99	134.80	0.00	8.00	0.000000
5	5.00	135.2	8.59	20.57	0.00	8.00	5.00	155.00	8.59	20.57	0.00	8.00	0.000000

Load Summary

Structure: CT46141-A-SBA	Code: EIA/TIA-222-G	2/16/2018
Site Name: Water Treatment Plant 2, CT	Exposure: C	
Height: 155.00 (ft)	Crest Height: 0.00	
Base Elev: 0.000 (ft)	Site Class: B - Competent Rock	
Gh: 1.1	Topography: 1	Struct Class: II



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Discrete Appurtenances

No.	Elev (ft)	Description	Qty	No Ice			Ice			Hor. Ecc. (ft)	Vert Ecc (ft)
				Weight (lb)	CaAa (sf)	CaAa Factor	Weight (lb)	CaAa (sf)	CaAa Factor		
1	155.00	27" Canister	1	50.00	5.07	1.00	54.67	5.543	1.00	0.00	0.00
2	155.00	Flag (20'x30')	1	200.00	14.56	1.00	218.68	15.920	1.00	0.00	0.00
3	155.00	Truck Ball	1	50.00	3.77	1.00	54.67	4.122	1.00	0.00	0.00
4	150.00	Commscope DHHTT65B-3XR	3	45.40	0.00	1.00	49.63	0.000	1.00	0.00	0.00
5	150.00	RFS KIT-FD9R6004/1C-DL	3	6.50	0.00	1.00	22.73	0.000	1.00	0.00	0.00
6	150.00	CCI DPO-7126Y-0-T1	3	7.30	0.00	1.00	7.98	0.000	1.00	0.00	0.00
7	150.00	RFS ACU-A20-N	4	1.00	0.00	1.00	6.73	0.000	1.00	0.00	0.00
8	145.12	27" Canister & 36" Canister	1	100.00	12.37	1.00	109.28	13.518	1.00	0.00	0.00
9	139.00	TPA-65R-LCUIUUU-H8	3	75.00	0.00	1.00	509.48	15.522	1.00	0.00	0.00
10	139.00	DTMABP0723VG12A	6	19.20	0.00	1.00	52.97	0.000	1.00	0.00	0.00
11	139.00	DBC0062F3V52-1	6	6.60	0.00	1.00	24.71	0.000	1.00	0.00	0.00
12	135.25	36" Canister & 29" Canister	1	100.00	12.55	1.00	109.21	13.706	1.00	0.00	0.00
13	129.00	APX18-206517S-C-A20	3	24.20	0.00	1.00	144.92	0.000	1.00	0.00	0.00
14	127.00	CBC721-DF	6	4.40	0.00	1.00	16.92	0.000	1.00	0.00	0.00
15	125.50	29" Canister & 30" Canister	1	100.00	10.75	1.00	109.14	11.733	1.00	0.00	0.00
16	122.00	SBNHH-1D6565A	3	47.40	0.00	1.00	328.78	9.909	1.00	0.00	0.00
17	115.75	30" Canister	1	50.00	5.50	1.00	54.53	5.999	1.00	0.00	0.00
Totals:			47	1,452.60			4,495.24				

Linear Appurtenances

Bottom Elev. (ft)	Top Elev. (ft)	Description	Exposed Width	Exposed
0.00	150.00	(12) 1 5/8" Coax	0.00	Inside
0.00	150.00	(3) 3/8" RET	0.00	Inside
0.00	139.00	(6) 1 5/8" Coax	0.00	Inside
0.00	129.00	(6) 1 5/8" Coax	0.00	Inside
0.00	122.00	(12) 1 5/8" Coax	0.00	Inside

Shaft Section Properties

Structure: CT46141-A-SBA	Code: EIA/TIA-222-G	2/16/2018
Site Name: Water Treatment Plant 2, CT	Exposure: C	
Height: 155.00 (ft)	Crest Height: 0.00	
Base Elev: 0.000 (ft)	Site Class: B - Competent Rock	
Gh: 1.1	Topography: 1	Struct Class: II



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Increment Length: 5 (ft)

Elev (ft)	Description	Thick (in)	Dia (in)	Area (in ²)	Ix (in ⁴)	W/t Ratio	D/t Ratio	Fpy (ksi)	S (in ³)	Weight (lb)
0.00		0.2500	43.670	34.627	8247.4	33.15	174.68	65.1	370.5	0.0
5.00		0.2500	43.036	34.122	7891.5	32.65	172.15	65.6	359.7	584.8
10.00		0.2500	42.403	33.617	7546.0	32.15	169.61	66.2	349.1	576.3
15.00		0.2500	41.769	33.111	7210.8	31.64	167.08	66.8	338.6	567.7
20.00		0.2500	41.135	32.606	6885.6	31.14	164.54	67.3	328.3	559.1
25.00		0.2500	40.502	32.101	6570.4	30.63	162.01	67.9	318.2	550.5
30.00		0.2500	39.868	31.595	6264.9	30.13	159.47	68.5	308.2	541.9
35.00		0.2500	39.234	31.090	5969.1	29.63	156.94	69.1	298.4	533.3
40.00		0.2500	38.600	30.584	5682.7	29.12	154.40	69.6	288.8	524.7
45.00		0.2500	37.967	30.079	5405.7	28.62	151.87	70.2	279.3	516.1
48.50	Bot - Section 2	0.2500	37.523	29.725	5217.2	28.26	150.09	70.6	272.7	356.1
50.00		0.2500	37.333	29.574	5137.7	28.11	149.33	70.8	269.9	304.7
53.25	Top - Section 1	0.2500	37.421	29.644	5174.4	28.18	149.68	0.0	0.0	654.9
55.00		0.2500	37.199	29.467	5082.4	28.01	148.80	70.9	268.0	176.0
60.00		0.2500	36.566	28.962	4825.3	27.50	146.26	71.5	258.9	497.1
65.00		0.2500	35.932	28.456	4577.1	27.00	143.73	72.0	249.9	488.5
70.00		0.2500	35.298	27.951	4337.6	26.49	141.19	72.6	241.0	479.9
75.00		0.2500	34.665	27.446	4106.5	25.99	138.66	73.2	232.4	471.3
80.00		0.2500	34.031	26.940	3883.8	25.49	136.12	73.7	223.9	462.7
85.00		0.2500	33.397	26.435	3669.3	24.98	133.59	74.3	215.5	454.1
90.00		0.2500	32.764	25.930	3462.9	24.48	131.05	74.9	207.3	445.5
95.00		0.2500	32.130	25.424	3264.3	23.97	128.52	75.4	199.3	436.9
98.00	Bot - Section 3	0.2500	31.750	25.121	3148.9	23.67	127.00	75.8	194.5	258.0
100.00		0.2500	31.496	24.919	3073.5	23.47	125.98	76.0	191.4	343.3
102.00	Top - Section 2	0.2500	31.743	25.115	3146.8	23.66	126.97	0.0	0.0	340.5
105.00		0.2500	31.362	24.812	3034.2	23.36	125.45	76.1	189.8	254.8
110.00		0.2500	30.729	24.307	2852.6	22.86	122.91	76.7	182.1	417.9
115.00		0.2500	30.095	23.801	2678.3	22.35	120.38	77.3	174.6	409.3
115.75	Top - Section 3	0.2500	30.000	23.726	2652.8	22.28	120.00	77.4	173.5	60.6
115.75	Bot - Section 4	1.0000	8.000	21.991	134.8	5.57	30.00	47.0	33.7	
120.00		1.0000	8.000	21.991	134.8	0.00	8.00	47.0	33.7	318.0
122.00		1.0000	8.000	21.991	134.8	0.00	8.00	47.0	33.7	149.7
125.00		1.0000	8.000	21.991	134.8	0.00	8.00	47.0	33.7	224.5
125.50		1.0000	8.000	21.991	134.8	0.00	8.00	47.0	33.7	37.4
127.00		1.0000	8.000	21.991	134.8	0.00	8.00	47.0	33.7	112.2
129.00		1.0000	8.000	21.991	134.8	0.00	8.00	47.0	33.7	149.7
130.00		1.0000	8.000	21.991	134.8	0.00	8.00	47.0	33.7	74.8
135.00		1.0000	8.000	21.991	134.8	0.00	8.00	47.0	33.7	374.2
135.25	Top - Section 4	1.0000	8.000	21.991	134.8	0.00	8.00	47.0	33.7	18.7
135.25	Bot - Section 5	0.6250	5.000	8.590	20.6	0.00	12.80	75.0	8.2	
139.00		0.6250	5.000	8.590	20.6	0.00	8.00	75.0	8.2	109.6
140.00		0.6250	5.000	8.590	20.6	0.00	8.00	75.0	8.2	29.2
145.00		0.6250	5.000	8.590	20.6	0.00	8.00	75.0	8.2	146.2
145.12		0.6250	5.000	8.590	20.6	0.00	8.00	75.0	8.2	3.5
150.00		0.6250	5.000	8.590	20.6	0.00	8.00	75.0	8.2	142.6
155.00		0.6250	5.000	8.590	20.6	0.00	8.00	75.0	8.2	146.2

14302.3

Wind Loading - Shaft

Structure: CT46141-A-SBA	Code: EIA/TIA-222-G	2/16/2018
Site Name: Water Treatment Plant 2, CT	Exposure: C	
Height: 155.00 (ft)	Crest Height: 0.00	
Base Elev: 0.000 (ft)	Site Class: B - Competent Rock	
Gh: 1.1	Topography: 1	Struct Class: II



Load Case: 1.2D + 1.6W 97 mph Wind

Dead Load Factor 1.20
Wind Load Factor 1.60



Iterations 31

Elev (ft)	Description	Kzt	Kz	qz (psf)	qzGh (psf)	C (mph-ft)	Cf	Ice Thick (in)	Tributary (ft)	Aa (sf)	CfAa (sf)	Wind Force X (lb)	Dead Load Ice (lb)	Tot Dead Load (lb)
0.00		1.00	0.85	19.450	21.40	331.83	0.750	0.000	0.00	0.000	0.00	0.0	0.0	0.0
5.00		1.00	0.85	19.450	21.40	327.01	0.750	0.000	5.00	18.418	13.81	472.9	0.0	701.8
10.00		1.00	0.85	19.450	21.40	322.19	0.750	0.000	5.00	18.148	13.61	466.0	0.0	691.5
15.00		1.00	0.85	19.450	21.40	317.38	0.750	0.000	5.00	17.879	13.41	459.0	0.0	681.2
20.00		1.00	0.90	20.638	22.70	321.96	0.750	0.000	5.00	17.610	13.21	479.7	0.0	670.9
25.00		1.00	0.95	21.630	23.79	324.54	0.750	0.000	5.00	17.341	13.01	495.1	0.0	660.5
30.00		1.00	0.98	22.477	24.72	325.65	0.750	0.000	5.00	17.072	12.80	506.5	0.0	650.2
35.00		1.00	1.01	23.218	25.54	325.72	0.750	0.000	5.00	16.802	12.60	515.0	0.0	639.9
40.00		1.00	1.04	23.880	26.27	324.99	0.750	0.000	5.00	16.533	12.40	521.2	0.0	629.6
45.00		1.00	1.07	24.479	26.93	323.64	0.750	0.000	5.00	16.264	12.20	525.5	0.0	619.3
48.50	Bot - Section 2	1.00	1.09	24.869	27.36	322.39	0.750	0.000	3.50	11.225	8.42	368.5	0.0	427.4
50.00		1.00	1.09	25.029	27.53	321.79	0.750	0.000	1.50	4.834	3.63	159.7	0.0	365.6
53.25	Top - Section 1	1.00	1.11	25.363	27.90	320.36	0.750	0.000	3.25	10.390	7.79	347.9	0.0	785.9
55.00		1.00	1.12	25.536	28.09	323.87	0.750	0.000	1.75	5.548	4.16	187.0	0.0	211.2
60.00		1.00	1.14	26.008	28.61	321.28	0.750	0.000	5.00	15.669	11.75	537.9	0.0	596.5
65.00		1.00	1.16	26.450	29.09	318.39	0.750	0.000	5.00	15.400	11.55	537.7	0.0	586.1
70.00		1.00	1.17	26.866	29.55	315.22	0.750	0.000	5.00	15.130	11.35	536.6	0.0	575.8
75.00		1.00	1.19	27.259	29.98	311.82	0.750	0.000	5.00	14.861	11.15	534.7	0.0	565.5
80.00		1.00	1.21	27.632	30.39	308.21	0.750	0.000	5.00	14.592	10.94	532.2	0.0	555.2
85.00		1.00	1.22	27.987	30.79	304.40	0.750	0.000	5.00	14.323	10.74	529.1	0.0	544.9
90.00		1.00	1.24	28.325	31.16	300.43	0.750	0.000	5.00	14.054	10.54	525.5	0.0	534.6
95.00		1.00	1.25	28.650	31.51	296.30	0.750	0.000	5.00	13.784	10.34	521.3	0.0	524.2
98.00	Bot - Section 3	1.00	1.26	28.838	31.72	293.75	0.750	0.000	3.00	8.141	6.11	309.9	0.0	309.6
100.00		1.00	1.27	28.961	31.86	292.03	0.750	0.000	2.00	5.459	4.09	208.7	0.0	411.9
102.00	Top - Section 2	1.00	1.27	29.082	31.99	290.28	0.750	0.000	2.00	5.416	4.06	207.9	0.0	408.6
105.00		1.00	1.28	29.260	32.19	292.29	0.750	0.000	3.00	8.043	6.03	310.6	0.0	305.8
110.00		1.00	1.29	29.548	32.50	287.79	0.750	0.000	5.00	13.189	9.89	514.4	0.0	501.4
115.00		1.00	1.30	29.826	32.81	283.17	0.750	0.000	5.00	12.920	9.69	508.7	0.0	491.1
115.75	Top - Section 3	1.00	1.31	29.866	32.85	282.47	0.750	0.000	0.75	1.915	1.44	75.5	0.0	72.8
120.00		1.00	1.32	30.094	33.10	74.16	0.600	0.000	4.25	2.833	1.70	90.0	0.0	381.6
122.00	Appurtenance(s)	1.00	1.32	30.199	33.22	74.29	0.600	0.000	2.00	1.333	0.80	42.5	0.0	179.6
125.00		1.00	1.33	30.354	33.39	74.48	0.600	0.000	3.00	2.000	1.20	64.1	0.0	269.4
125.50	Appurtenance(s)	1.00	1.33	30.379	33.42	74.51	0.600	0.000	0.50	0.333	0.20	10.7	0.0	44.9
127.00	Appurtenance(s)	1.00	1.33	30.455	33.50	74.60	0.600	0.000	1.50	1.000	0.60	32.2	0.0	134.7
129.00	Appurtenance(s)	1.00	1.34	30.556	33.61	74.73	0.600	0.000	2.00	1.333	0.80	43.0	0.0	179.6
130.00		1.00	1.34	30.605	33.67	74.79	0.600	0.000	1.00	0.667	0.40	21.5	0.0	89.8
135.00		1.00	1.35	30.850	33.93	75.08	0.600	0.000	5.00	3.333	2.00	108.6	0.0	449.0
135.25	Top - Section 4	1.00	1.35	30.862	33.95	75.10	0.600	0.000	0.25	0.167	0.10	5.4	0.0	22.4
139.00	Appurtenance(s)	1.00	1.36	31.040	34.14	47.07	0.816	0.000	3.75	1.563	1.27	69.6	0.0	131.5
140.00		1.00	1.36	31.087	34.20	47.11	0.815	0.000	1.00	0.417	0.34	18.6	0.0	35.1
145.00		1.00	1.37	31.317	34.45	47.28	0.812	0.000	5.00	2.083	1.69	93.3	0.0	175.4
145.12	Appurtenance(s)	1.00	1.37	31.323	34.45	47.29	0.812	0.000	0.12	0.050	0.04	2.2	0.0	4.2
150.00	Appurtenance(s)	1.00	1.38	31.541	34.70	47.45	0.809	0.000	4.88	2.033	1.65	91.3	0.0	171.2
155.00	Appurtenance(s)	1.00	1.39	31.760	34.94	47.62	0.806	0.000	5.00	2.083	1.68	93.9	0.0	175.4
Totals:								155.00			12,681.6	17,162.8		


Discrete Appurtenance Forces

Structure: CT46141-A-SBA	Code: EIA/TIA-222-G	2/16/2018
Site Name: Water Treatment Plant 2, CT	Exposure: C	
Height: 155.00 (ft)	Crest Height: 0.00	
Base Elev: 0.000 (ft)	Site Class: B - Competent Rock	
Gh: 1.1	Topography: 1	Struct Class: II



Load Case: 1.2D + 1.6W 97 mph Wind

Dead Load Factor 1.20
Wind Load Factor 1.60

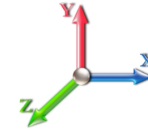

Iterations 31

No.	Elev (ft)	Description	Qty	qz (psf)	qzGh (psf)	CaAa x Ka	Ka	Total CaAa (sf)	Dead Load (lb)	Horiz Ecc (ft)	Vert Ecc (ft)	Wind FX (lb)	Mom Y (lb-ft)	Mom Z (lb-ft)
1	155.00	Truck Ball	1	31.760	34.936	1.00	1.00	3.77	60.00	0.000	0.000	210.73	0.00	0.00
2	155.00	Flag (20'x30')	1	31.760	34.936	1.00	1.00	14.56	240.00	0.000	0.000	813.87	0.00	0.00
3	155.00	27" Canister	1	31.760	34.936	1.00	1.00	5.07	60.00	0.000	0.000	283.40	0.00	0.00
4	150.00	RFS ACU-A20-N	4	31.541	34.696	1.00	1.00	0.00	4.80	0.000	0.000	0.00	0.00	0.00
5	150.00	CCI DPO-7126Y-0-T1	3	31.541	34.696	1.00	1.00	0.00	26.28	0.000	0.000	0.00	0.00	0.00
6	150.00	RFS	3	31.541	34.696	1.00	1.00	0.00	23.40	0.000	0.000	0.00	0.00	0.00
7	150.00	Commscope	3	31.541	34.696	1.00	1.00	0.00	163.44	0.000	0.000	0.00	0.00	0.00
8	145.12	27" Canister & 36"	1	31.323	34.455	1.00	1.00	12.37	120.00	0.000	0.000	681.93	0.00	0.00
9	139.00	DBC0062F3V52-1	6	31.040	34.144	1.00	1.00	0.00	47.52	0.000	0.000	0.00	0.00	0.00
10	139.00	DTMABP0723VG12A	6	31.040	34.144	1.00	1.00	0.00	138.24	0.000	0.000	0.00	0.00	0.00
11	139.00	TPA-65R-LCUUUU-H8	3	31.040	34.144	1.00	1.00	0.00	270.00	0.000	0.000	0.00	0.00	0.00
12	135.25	36" Canister & 29"	1	30.862	33.948	1.00	1.00	12.55	120.00	0.000	0.000	681.67	0.00	0.00
13	129.00	APX18-206517S-C-A20	3	30.556	33.611	1.00	1.00	0.00	87.12	0.000	0.000	0.00	0.00	0.00
14	127.00	CBC721-DF	6	30.455	33.501	1.00	1.00	0.00	31.68	0.000	0.000	0.00	0.00	0.00
15	125.50	29" Canister & 30"	1	30.379	33.417	1.00	1.00	10.75	120.00	0.000	0.000	574.78	0.00	0.00
16	122.00	SBNHH-1D6565A	3	30.199	33.219	1.00	1.00	0.00	170.64	0.000	0.000	0.00	0.00	0.00
17	115.75	30" Canister	1	29.866	32.853	1.00	1.00	5.50	60.00	0.000	0.000	289.11	0.00	0.00
Totals:									1,743.12			3,535.48		

Total Applied Force Summary


Structure: CT46141-A-SBA	Code: EIA/TIA-222-G	2/16/2018
Site Name: Water Treatment Plant 2, CT	Exposure: C	
Height: 155.00 (ft)	Crest Height: 0.00	
Base Elev: 0.000 (ft)	Site Class: B - Competent Rock	
Gh: 1.1	Topography: 1	Struct Class: II



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Load Case: 1.2D + 1.6W 97 mph Wind

Dead Load Factor 1.20
Wind Load Factor 1.60

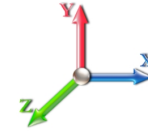

Iterations 31

Elev (ft)	Description	Lateral FX (-) (lb)	Axial FY (-) (lb)	Torsion MY (lb-ft)	Moment MZ (lb-ft)
0.00		0.00	0.00	0.00	0.00
5.00		472.86	927.54	0.00	0.00
10.00		465.95	917.22	0.00	0.00
15.00		459.04	906.90	0.00	0.00
20.00		479.73	896.58	0.00	0.00
25.00		495.11	886.27	0.00	0.00
30.00		506.50	875.95	0.00	0.00
35.00		514.96	865.63	0.00	0.00
40.00		521.15	855.31	0.00	0.00
45.00		525.54	844.99	0.00	0.00
48.50		368.46	585.36	0.00	0.00
50.00		159.70	433.37	0.00	0.00
53.25		347.85	932.59	0.00	0.00
55.00		187.00	290.20	0.00	0.00
60.00		537.92	822.18	0.00	0.00
65.00		537.66	811.86	0.00	0.00
70.00		536.57	801.55	0.00	0.00
75.00		534.73	791.23	0.00	0.00
80.00		532.22	780.91	0.00	0.00
85.00		529.12	770.59	0.00	0.00
90.00		525.46	760.27	0.00	0.00
95.00		521.29	749.96	0.00	0.00
98.00		309.91	445.02	0.00	0.00
100.00		208.68	502.20	0.00	0.00
102.00		207.89	498.90	0.00	0.00
105.00		310.63	441.24	0.00	0.00
110.00		514.41	727.14	0.00	0.00
115.00		508.65	716.82	0.00	0.00
115.75	(1) attachments	364.59	166.63	0.00	0.00
120.00		90.04	573.50	0.00	0.00
122.00	(3) attachments	42.52	440.52	0.00	0.00
125.00		64.11	359.90	0.00	0.00
125.50	(1) attachments	585.47	179.98	0.00	0.00
127.00	(6) attachments	32.16	211.63	0.00	0.00
129.00	(3) attachments	43.02	327.05	0.00	0.00
130.00		21.55	112.48	0.00	0.00
135.00		108.59	562.39	0.00	0.00
135.25	(1) attachments	687.10	148.12	0.00	0.00
139.00	(15) attachments	69.63	672.35	0.00	0.00
140.00		18.58	50.27	0.00	0.00
145.00		93.26	251.35	0.00	0.00
145.12	(1) attachments	684.17	126.03	0.00	0.00
150.00	(13) attachments	91.35	463.23	0.00	0.00
155.00	(3) attachments	1401.92	535.39	0.00	0.00
	Totals:	16,217.04	25,018.59	0.00	0.00

Calculated Forces

Structure: CT46141-A-SBA	Code: EIA/TIA-222-G	2/16/2018
Site Name: Water Treatment Plant 2, CT	Exposure: C	
Height: 155.00 (ft)	Crest Height: 0.00	
Base Elev: 0.000 (ft)	Site Class: B - Competent Rock	
Gh: 1.1	Topography: 1	Struct Class: II




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Load Case: 1.2D + 1.6W 97 mph Wind

Iterations 31

Dead Load Factor 1.20
Wind Load Factor 1.60

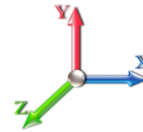

Seg Elev (ft)	Pu FY (-) (kips)	Vu FX (-) (kips)	Tu MY (-) (ft-kips)	Mu MZ (ft-kips)	Mu MX (ft-kips)	Resultant Moment (ft-kips)	phi Pn (kips)	phi Vn (kips)	phi Tn (ft-kips)	phi Mn (ft-kips)	Total Deflect (in)	Rotation Sway (deg)	Rotation Twist (deg)	Stress Ratio
0.00	-24.98	-16.27	0.00	-1395.4	0.00	1395.46	2027.49	1013.74	3641.02	1807.56	0.00	0.000	0.000	0.785
5.00	-23.99	-15.89	0.00	-1314.1	0.00	1314.12	2015.42	1007.71	3566.22	1770.42	0.13	-0.234	0.000	0.754
10.00	-23.02	-15.51	0.00	-1234.6	0.00	1234.66	2002.83	1001.41	3491.15	1733.15	0.49	-0.463	0.000	0.724
15.00	-22.06	-15.13	0.00	-1157.1	0.00	1157.11	1989.72	994.86	3415.85	1695.77	1.10	-0.689	0.000	0.694
20.00	-21.11	-14.72	0.00	-1081.4	0.00	1081.47	1976.09	988.05	3340.37	1658.30	1.94	-0.910	0.000	0.663
25.00	-20.18	-14.28	0.00	-1007.8	0.00	1007.88	1961.94	980.97	3264.74	1620.75	3.01	-1.125	0.000	0.632
30.00	-19.27	-13.83	0.00	-936.48	0.00	936.48	1947.28	973.64	3189.01	1583.16	4.30	-1.336	0.000	0.602
35.00	-18.37	-13.35	0.00	-867.35	0.00	867.35	1932.09	966.05	3113.21	1545.53	5.81	-1.541	0.000	0.571
40.00	-17.48	-12.87	0.00	-800.57	0.00	800.57	1916.39	958.20	3037.39	1507.89	7.53	-1.739	0.000	0.540
45.00	-16.62	-12.36	0.00	-736.23	0.00	736.23	1900.17	950.08	2961.59	1470.26	9.46	-1.932	0.000	0.510
48.50	-16.03	-12.00	0.00	-692.96	0.00	692.96	1888.50	944.25	2908.57	1443.94	10.92	-2.063	0.000	0.489
50.00	-15.58	-11.85	0.00	-674.96	0.00	674.96	1883.43	941.71	2885.86	1432.66	11.58	-2.119	0.000	0.480
53.25	-14.65	-11.49	0.00	-636.45	0.00	636.45	1885.78	942.89	2896.38	1437.89	13.06	-2.237	0.000	0.451
55.00	-14.34	-11.32	0.00	-616.35	0.00	616.35	1879.83	939.91	2869.89	1424.73	13.89	-2.300	0.000	0.440
60.00	-13.51	-10.79	0.00	-559.75	0.00	559.75	1862.46	931.23	2794.28	1387.20	16.39	-2.465	0.000	0.411
65.00	-12.70	-10.25	0.00	-505.82	0.00	505.82	1844.57	922.28	2718.82	1349.74	19.06	-2.622	0.000	0.382
70.00	-11.90	-9.70	0.00	-454.59	0.00	454.59	1826.16	913.08	2643.55	1312.37	21.88	-2.771	0.000	0.353
75.00	-11.11	-9.16	0.00	-406.08	0.00	406.08	1807.23	903.62	2568.52	1275.12	24.86	-2.912	0.000	0.325
80.00	-10.34	-8.61	0.00	-360.30	0.00	360.30	1787.79	893.89	2493.75	1238.00	27.98	-3.045	0.000	0.297
85.00	-9.58	-8.06	0.00	-317.26	0.00	317.26	1767.82	883.91	2419.31	1201.05	31.23	-3.169	0.000	0.270
90.00	-8.84	-7.51	0.00	-276.98	0.00	276.98	1747.34	873.67	2345.22	1164.27	34.61	-3.284	0.000	0.243
95.00	-8.11	-6.95	0.00	-239.44	0.00	239.44	1726.34	863.17	2271.53	1127.68	38.11	-3.390	0.000	0.217
98.00	-7.68	-6.62	0.00	-218.58	0.00	218.58	1713.49	856.74	2227.52	1105.83	40.26	-3.450	0.000	0.202
100.00	-7.19	-6.39	0.00	-205.33	0.00	205.33	1704.82	852.41	2198.27	1091.31	41.71	-3.488	0.000	0.192
102.00	-6.70	-6.16	0.00	-192.55	0.00	192.55	1713.25	856.63	2226.72	1105.44	43.18	-3.525	0.000	0.178
105.00	-6.27	-5.83	0.00	-174.08	0.00	174.08	1700.21	850.10	2182.88	1083.67	45.41	-3.577	0.000	0.164
110.00	-5.57	-5.28	0.00	-144.94	0.00	144.94	1678.06	839.03	2110.21	1047.60	49.20	-3.652	0.000	0.142
115.00	-4.88	-4.72	0.00	-118.56	0.00	118.56	1655.39	827.70	2038.07	1011.78	53.05	-3.718	0.000	0.120
115.75	-4.74	-4.35	0.00	-115.02	0.00	115.02	1651.95	825.97	2027.30	1006.43	53.64	-3.727	0.000	0.117
115.75	-4.74	-4.35	0.00	-115.02	0.00	115.02	930.23	465.11	237.26	173.90	53.64	-3.727	0.000	0.667
120.00	-4.16	-4.24	0.00	-96.52	0.00	96.52	930.23	465.11	237.26	173.90	56.98	-3.775	0.000	0.560
122.00	-3.69	-4.20	0.00	-88.03	0.00	88.03	930.23	465.11	237.26	173.90	58.64	-4.165	0.000	0.510
125.00	-3.31	-4.12	0.00	-75.44	0.00	75.44	930.23	465.11	237.26	173.90	61.42	-4.683	0.000	0.437
125.50	-3.17	-3.53	0.00	-73.38	0.00	73.38	930.23	465.11	237.26	173.90	61.92	-4.761	0.000	0.425
127.00	-2.95	-3.50	0.00	-68.08	0.00	68.08	930.23	465.11	237.26	173.90	63.45	-4.985	0.000	0.395
129.00	-2.61	-3.43	0.00	-61.09	0.00	61.09	930.23	465.11	237.26	173.90	65.59	-5.258	0.000	0.354
130.00	-2.48	-3.42	0.00	-57.65	0.00	57.65	930.23	465.11	237.26	173.90	66.70	-5.383	0.000	0.334
135.00	-1.92	-3.26	0.00	-40.57	0.00	40.57	930.23	465.11	237.26	173.90	72.62	-5.901	0.000	0.235
135.25	-1.84	-2.57	0.00	-39.76	0.00	39.76	930.23	465.11	237.26	173.90	72.93	-5.922	0.000	0.231
135.25	-1.84	-2.57	0.00	-39.76	0.00	39.76	579.84	289.92	92.43	67.75	72.93	-5.922	0.000	0.590
139.00	-1.16	-2.43	0.00	-30.13	0.00	30.13	579.84	289.92	92.43	67.75	77.68	-6.199	0.000	0.447
140.00	-1.07	-2.43	0.00	-27.70	0.00	27.70	579.84	289.92	92.43	67.75	79.02	-6.599	0.000	0.411
145.00	-0.81	-2.31	0.00	-15.55	0.00	15.55	579.84	289.92	92.43	67.75	86.77	-8.094	0.000	0.231
145.12	-0.77	-1.63	0.00	-15.27	0.00	15.27	579.84	289.92	92.43	67.75	86.97	-8.120	0.000	0.227
150.00	-0.31	-1.47	0.00	-7.34	0.00	7.34	579.84	289.92	92.43	67.75	95.67	-8.883	0.000	0.109
155.00	0.00	-1.40	0.00	0.00	0.00	0.00	579.84	289.92	92.43	67.75	105.11	-9.137	0.000	0.000


Wind Loading - Shaft

Structure: CT46141-A-SBA	Code: EIA/TIA-222-G	2/16/2018
Site Name: Water Treatment Plant 2, CT	Exposure: C	
Height: 155.00 (ft)	Crest Height: 0.00	
Base Elev: 0.000 (ft)	Site Class: B - Competent Rock	
Gh: 1.1	Topography: 1	Struct Class: II



Load Case: 0.9D + 1.6W 97 mph Wind

Dead Load Factor 0.90
Wind Load Factor 1.60

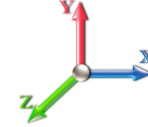

Iterations 31

Elev (ft)	Description	Kzt	Kz	qz (psf)	qzGh (psf)	C (mph-ft)	Cf	Ice Thick (in)	Tributary (ft)	Aa (sf)	CfAa (sf)	Wind Force X (lb)	Dead Load Ice (lb)	Tot Dead Load (lb)
0.00		1.00	0.85	19.450	21.40	331.83	0.750	0.000	0.00	0.000	0.00	0.0	0.0	0.0
5.00		1.00	0.85	19.450	21.40	327.01	0.750	0.000	5.00	18.418	13.81	472.9	0.0	526.4
10.00		1.00	0.85	19.450	21.40	322.19	0.750	0.000	5.00	18.148	13.61	466.0	0.0	518.6
15.00		1.00	0.85	19.450	21.40	317.38	0.750	0.000	5.00	17.879	13.41	459.0	0.0	510.9
20.00		1.00	0.90	20.638	22.70	321.96	0.750	0.000	5.00	17.610	13.21	479.7	0.0	503.1
25.00		1.00	0.95	21.630	23.79	324.54	0.750	0.000	5.00	17.341	13.01	495.1	0.0	495.4
30.00		1.00	0.98	22.477	24.72	325.65	0.750	0.000	5.00	17.072	12.80	506.5	0.0	487.7
35.00		1.00	1.01	23.218	25.54	325.72	0.750	0.000	5.00	16.802	12.60	515.0	0.0	479.9
40.00		1.00	1.04	23.880	26.27	324.99	0.750	0.000	5.00	16.533	12.40	521.2	0.0	472.2
45.00		1.00	1.07	24.479	26.93	323.64	0.750	0.000	5.00	16.264	12.20	525.5	0.0	464.5
48.50	Bot - Section 2	1.00	1.09	24.869	27.36	322.39	0.750	0.000	3.50	11.225	8.42	368.5	0.0	320.5
50.00		1.00	1.09	25.029	27.53	321.79	0.750	0.000	1.50	4.834	3.63	159.7	0.0	274.2
53.25	Top - Section 1	1.00	1.11	25.363	27.90	320.36	0.750	0.000	3.25	10.390	7.79	347.9	0.0	589.4
55.00		1.00	1.12	25.536	28.09	323.87	0.750	0.000	1.75	5.548	4.16	187.0	0.0	158.4
60.00		1.00	1.14	26.008	28.61	321.28	0.750	0.000	5.00	15.669	11.75	537.9	0.0	447.3
65.00		1.00	1.16	26.450	29.09	318.39	0.750	0.000	5.00	15.400	11.55	537.7	0.0	439.6
70.00		1.00	1.17	26.866	29.55	315.22	0.750	0.000	5.00	15.130	11.35	536.6	0.0	431.9
75.00		1.00	1.19	27.259	29.98	311.82	0.750	0.000	5.00	14.861	11.15	534.7	0.0	424.1
80.00		1.00	1.21	27.632	30.39	308.21	0.750	0.000	5.00	14.592	10.94	532.2	0.0	416.4
85.00		1.00	1.22	27.987	30.79	304.40	0.750	0.000	5.00	14.323	10.74	529.1	0.0	408.7
90.00		1.00	1.24	28.325	31.16	300.43	0.750	0.000	5.00	14.054	10.54	525.5	0.0	400.9
95.00		1.00	1.25	28.650	31.51	296.30	0.750	0.000	5.00	13.784	10.34	521.3	0.0	393.2
98.00	Bot - Section 3	1.00	1.26	28.838	31.72	293.75	0.750	0.000	3.00	8.141	6.11	309.9	0.0	232.2
100.00		1.00	1.27	28.961	31.86	292.03	0.750	0.000	2.00	5.459	4.09	208.7	0.0	308.9
102.00	Top - Section 2	1.00	1.27	29.082	31.99	290.28	0.750	0.000	2.00	5.416	4.06	207.9	0.0	306.5
105.00		1.00	1.28	29.260	32.19	292.29	0.750	0.000	3.00	8.043	6.03	310.6	0.0	229.4
110.00		1.00	1.29	29.548	32.50	287.79	0.750	0.000	5.00	13.189	9.89	514.4	0.0	376.1
115.00		1.00	1.30	29.826	32.81	283.17	0.750	0.000	5.00	12.920	9.69	508.7	0.0	368.3
115.75	Top - Section 3	1.00	1.31	29.866	32.85	282.47	0.750	0.000	0.75	1.915	1.44	75.5	0.0	54.6
120.00		1.00	1.32	30.094	33.10	274.16	0.600	0.000	4.25	2.833	1.70	90.0	0.0	286.2
122.00	Appurtenance(s)	1.00	1.32	30.199	33.22	74.29	0.600	0.000	2.00	1.333	0.80	42.5	0.0	134.7
125.00		1.00	1.33	30.354	33.39	74.48	0.600	0.000	3.00	2.000	1.20	64.1	0.0	202.0
125.50	Appurtenance(s)	1.00	1.33	30.379	33.42	74.51	0.600	0.000	0.50	0.333	0.20	10.7	0.0	33.7
127.00	Appurtenance(s)	1.00	1.33	30.455	33.50	74.60	0.600	0.000	1.50	1.000	0.60	32.2	0.0	101.0
129.00	Appurtenance(s)	1.00	1.34	30.556	33.61	74.73	0.600	0.000	2.00	1.333	0.80	43.0	0.0	134.7
130.00		1.00	1.34	30.605	33.67	74.79	0.600	0.000	1.00	0.667	0.40	21.5	0.0	67.3
135.00		1.00	1.35	30.850	33.93	75.08	0.600	0.000	5.00	3.333	2.00	108.6	0.0	336.7
135.25	Top - Section 4	1.00	1.35	30.862	33.95	75.10	0.600	0.000	0.25	0.167	0.10	5.4	0.0	16.8
139.00	Appurtenance(s)	1.00	1.36	31.040	34.14	47.07	0.816	0.000	3.75	1.563	1.27	69.6	0.0	98.7
140.00		1.00	1.36	31.087	34.20	47.11	0.815	0.000	1.00	0.417	0.34	18.6	0.0	26.3
145.00		1.00	1.37	31.317	34.45	47.28	0.812	0.000	5.00	2.083	1.69	93.3	0.0	131.5
145.12	Appurtenance(s)	1.00	1.37	31.323	34.45	47.29	0.812	0.000	0.12	0.050	0.04	2.2	0.0	3.2
150.00	Appurtenance(s)	1.00	1.38	31.541	34.70	47.45	0.809	0.000	4.88	2.033	1.65	91.3	0.0	128.4
155.00	Appurtenance(s)	1.00	1.39	31.760	34.94	47.62	0.806	0.000	5.00	2.083	1.68	93.9	0.0	131.5
Totals:								155.00			12,681.6	12,872.1		

Discrete Appurtenance Forces


Structure: CT46141-A-SBA	Code: EIA/TIA-222-G	2/16/2018
Site Name: Water Treatment Plant 2, CT	Exposure: C	
Height: 155.00 (ft)	Crest Height: 0.00	
Base Elev: 0.000 (ft)	Site Class: B - Competent Rock	
Gh: 1.1	Topography: 1	Struct Class: II



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Load Case: 0.9D + 1.6W 97 mph Wind

Dead Load Factor 0.90
Wind Load Factor 1.60

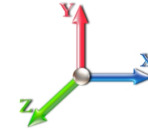

Iterations 31

No.	Elev (ft)	Description	Qty	qz (psf)	qzGh (psf)	CaAa x Ka	Ka	Total CaAa (sf)	Dead Load (lb)	Horiz Ecc (ft)	Vert Ecc (ft)	Wind FX (lb)	Mom Y (lb-ft)	Mom Z (lb-ft)
1	155.00	Truck Ball	1	31.760	34.936	1.00	1.00	3.77	45.00	0.000	0.000	210.73	0.00	0.00
2	155.00	Flag (20'x30')	1	31.760	34.936	1.00	1.00	14.56	180.00	0.000	0.000	813.87	0.00	0.00
3	155.00	27" Canister	1	31.760	34.936	1.00	1.00	5.07	45.00	0.000	0.000	283.40	0.00	0.00
4	150.00	RFS ACU-A20-N	4	31.541	34.696	1.00	1.00	0.00	3.60	0.000	0.000	0.00	0.00	0.00
5	150.00	CCI DPO-7126Y-0-T1	3	31.541	34.696	1.00	1.00	0.00	19.71	0.000	0.000	0.00	0.00	0.00
6	150.00	RFS	3	31.541	34.696	1.00	1.00	0.00	17.55	0.000	0.000	0.00	0.00	0.00
7	150.00	Commscope	3	31.541	34.696	1.00	1.00	0.00	122.58	0.000	0.000	0.00	0.00	0.00
8	145.12	27" Canister & 36"	1	31.323	34.455	1.00	1.00	12.37	90.00	0.000	0.000	681.93	0.00	0.00
9	139.00	DBC0062F3V52-1	6	31.040	34.144	1.00	1.00	0.00	35.64	0.000	0.000	0.00	0.00	0.00
10	139.00	DTMABP0723VG12A	6	31.040	34.144	1.00	1.00	0.00	103.68	0.000	0.000	0.00	0.00	0.00
11	139.00	TPA-65R-LCUUUU-H8	3	31.040	34.144	1.00	1.00	0.00	202.50	0.000	0.000	0.00	0.00	0.00
12	135.25	36" Canister & 29"	1	30.862	33.948	1.00	1.00	12.55	90.00	0.000	0.000	681.67	0.00	0.00
13	129.00	APX18-206517S-C-A20	3	30.556	33.611	1.00	1.00	0.00	65.34	0.000	0.000	0.00	0.00	0.00
14	127.00	CBC721-DF	6	30.455	33.501	1.00	1.00	0.00	23.76	0.000	0.000	0.00	0.00	0.00
15	125.50	29" Canister & 30"	1	30.379	33.417	1.00	1.00	10.75	90.00	0.000	0.000	574.78	0.00	0.00
16	122.00	SBNHH-1D6565A	3	30.199	33.219	1.00	1.00	0.00	127.98	0.000	0.000	0.00	0.00	0.00
17	115.75	30" Canister	1	29.866	32.853	1.00	1.00	5.50	45.00	0.000	0.000	289.11	0.00	0.00
Totals:									1,307.34			3,535.48		

Total Applied Force Summary

Structure: CT46141-A-SBA	Code: EIA/TIA-222-G	2/16/2018
Site Name: Water Treatment Plant 2, CT	Exposure: C	
Height: 155.00 (ft)	Crest Height: 0.00	
Base Elev: 0.000 (ft)	Site Class: B - Competent Rock	
Gh: 1.1	Topography: 1	Struct Class: II




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Load Case: 0.9D + 1.6W 97 mph Wind

Dead Load Factor 0.90

Wind Load Factor 1.60

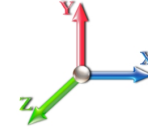

Iterations 31

Elev (ft)	Description	Lateral FX (-) (lb)	Axial FY (-) (lb)	Torsion MY (lb-ft)	Moment MZ (lb-ft)
0.00		0.00	0.00	0.00	0.00
5.00		472.86	695.65	0.00	0.00
10.00		465.95	687.92	0.00	0.00
15.00		459.04	680.18	0.00	0.00
20.00		479.73	672.44	0.00	0.00
25.00		495.11	664.70	0.00	0.00
30.00		506.50	656.96	0.00	0.00
35.00		514.96	649.22	0.00	0.00
40.00		521.15	641.48	0.00	0.00
45.00		525.54	633.75	0.00	0.00
48.50		368.46	439.02	0.00	0.00
50.00		159.70	325.02	0.00	0.00
53.25		347.85	699.44	0.00	0.00
55.00		187.00	217.65	0.00	0.00
60.00		537.92	616.64	0.00	0.00
65.00		537.66	608.90	0.00	0.00
70.00		536.57	601.16	0.00	0.00
75.00		534.73	593.42	0.00	0.00
80.00		532.22	585.68	0.00	0.00
85.00		529.12	577.94	0.00	0.00
90.00		525.46	570.21	0.00	0.00
95.00		521.29	562.47	0.00	0.00
98.00		309.91	333.77	0.00	0.00
100.00		208.68	376.65	0.00	0.00
102.00		207.89	374.18	0.00	0.00
105.00		310.63	330.93	0.00	0.00
110.00		514.41	545.36	0.00	0.00
115.00		508.65	537.62	0.00	0.00
115.75	(1) attachments	364.59	124.98	0.00	0.00
120.00		90.04	430.13	0.00	0.00
122.00	(3) attachments	42.52	330.39	0.00	0.00
125.00		64.11	269.92	0.00	0.00
125.50	(1) attachments	585.47	134.99	0.00	0.00
127.00	(6) attachments	32.16	158.72	0.00	0.00
129.00	(3) attachments	43.02	245.29	0.00	0.00
130.00		21.55	84.36	0.00	0.00
135.00		108.59	421.79	0.00	0.00
135.25	(1) attachments	687.10	111.09	0.00	0.00
139.00	(15) attachments	69.63	504.26	0.00	0.00
140.00		18.58	37.70	0.00	0.00
145.00		93.26	188.51	0.00	0.00
145.12	(1) attachments	684.17	94.52	0.00	0.00
150.00	(13) attachments	91.35	347.42	0.00	0.00
155.00	(3) attachments	1401.92	401.54	0.00	0.00
	Totals:	16,217.04	18,763.94	0.00	0.00

Calculated Forces

Structure: CT46141-A-SBA	Code: EIA/TIA-222-G	2/16/2018
Site Name: Water Treatment Plant 2, CT	Exposure: C	
Height: 155.00 (ft)	Crest Height: 0.00	
Base Elev: 0.000 (ft)	Site Class: B - Competent Rock	
Gh: 1.1	Topography: 1	Struct Class: II



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Load Case: 0.9D + 1.6W 97 mph Wind

Dead Load Factor 0.90
Wind Load Factor 1.60



Iterations 31

Seg Elev (ft)	Pu FY (-) (kips)	Vu FX (-) (kips)	Tu MY (-) (ft-kips)	Mu MZ (ft-kips)	Mu MX (ft-kips)	Resultant Moment (ft-kips)	phi Pn (kips)	phi Vn (kips)	phi Tn (ft-kips)	phi Mn (ft-kips)	Total Deflect (in)	Rotation Sway (deg)	Rotation Twist (deg)	Stress Ratio
0.00	-18.73	-16.26	0.00	-1378.9	0.00	1378.91	2027.49	1013.74	3641.02	1807.56	0.00	0.000	0.000	0.772
5.00	-17.97	-15.85	0.00	-1297.6	0.00	1297.63	2015.42	1007.71	3566.22	1770.42	0.12	-0.231	0.000	0.742
10.00	-17.23	-15.45	0.00	-1218.3	0.00	1218.37	2002.83	1001.41	3491.15	1733.15	0.49	-0.458	0.000	0.712
15.00	-16.49	-15.05	0.00	-1141.1	0.00	1141.12	1989.72	994.86	3415.85	1695.77	1.09	-0.680	0.000	0.681
20.00	-15.77	-14.62	0.00	-1065.8	0.00	1065.88	1976.09	988.05	3340.37	1658.30	1.92	-0.898	0.000	0.651
25.00	-15.07	-14.17	0.00	-992.79	0.00	992.79	1961.94	980.97	3264.74	1620.75	2.97	-1.110	0.000	0.620
30.00	-14.37	-13.70	0.00	-921.95	0.00	921.95	1947.28	973.64	3189.01	1583.16	4.24	-1.318	0.000	0.590
35.00	-13.69	-13.21	0.00	-853.46	0.00	853.46	1932.09	966.05	3113.21	1545.53	5.73	-1.519	0.000	0.559
40.00	-13.02	-12.72	0.00	-787.39	0.00	787.39	1916.39	958.20	3037.39	1507.89	7.43	-1.715	0.000	0.529
45.00	-12.37	-12.21	0.00	-723.80	0.00	723.80	1900.17	950.08	2961.59	1470.26	9.33	-1.904	0.000	0.499
48.50	-11.92	-11.84	0.00	-681.07	0.00	681.07	1888.50	944.25	2908.57	1443.94	10.77	-2.033	0.000	0.478
50.00	-11.59	-11.69	0.00	-663.30	0.00	663.30	1883.43	941.71	2885.86	1432.66	11.42	-2.088	0.000	0.469
53.25	-10.88	-11.33	0.00	-625.31	0.00	625.31	1885.78	942.89	2896.38	1437.89	12.88	-2.204	0.000	0.441
55.00	-10.65	-11.16	0.00	-605.48	0.00	605.48	1879.83	939.91	2869.89	1424.73	13.70	-2.266	0.000	0.431
60.00	-10.03	-10.62	0.00	-549.68	0.00	549.68	1862.46	931.23	2794.28	1387.20	16.16	-2.427	0.000	0.402
65.00	-9.42	-10.08	0.00	-496.57	0.00	496.57	1844.57	922.28	2718.82	1349.74	18.78	-2.582	0.000	0.373
70.00	-8.82	-9.54	0.00	-446.14	0.00	446.14	1826.16	913.08	2643.55	1312.37	21.57	-2.728	0.000	0.345
75.00	-8.23	-9.00	0.00	-398.43	0.00	398.43	1807.23	903.62	2568.52	1275.12	24.50	-2.867	0.000	0.317
80.00	-7.65	-8.45	0.00	-353.43	0.00	353.43	1787.79	893.89	2493.75	1238.00	27.57	-2.997	0.000	0.290
85.00	-7.09	-7.91	0.00	-311.16	0.00	311.16	1767.82	883.91	2419.31	1201.05	30.77	-3.119	0.000	0.263
90.00	-6.54	-7.37	0.00	-271.62	0.00	271.62	1747.34	873.67	2345.22	1164.27	34.10	-3.232	0.000	0.237
95.00	-5.99	-6.82	0.00	-234.79	0.00	234.79	1726.34	863.17	2271.53	1127.68	37.54	-3.336	0.000	0.212
98.00	-5.67	-6.50	0.00	-214.32	0.00	214.32	1713.49	856.74	2227.52	1105.83	39.65	-3.394	0.000	0.197
100.00	-5.31	-6.27	0.00	-201.33	0.00	201.33	1704.82	852.41	2198.27	1091.31	41.08	-3.432	0.000	0.188
102.00	-4.94	-6.04	0.00	-188.79	0.00	188.79	1713.25	856.63	2226.72	1105.44	42.53	-3.468	0.000	0.174
105.00	-4.62	-5.72	0.00	-170.66	0.00	170.66	1700.21	850.10	2182.88	1083.67	44.72	-3.519	0.000	0.160
110.00	-4.10	-5.18	0.00	-142.06	0.00	142.06	1678.06	839.03	2110.21	1047.60	48.44	-3.592	0.000	0.138
115.00	-3.60	-4.64	0.00	-116.18	0.00	116.18	1655.39	827.70	2038.07	1011.78	52.24	-3.657	0.000	0.117
115.75	-3.49	-4.27	0.00	-112.70	0.00	112.70	1651.95	825.97	2027.30	1006.43	52.81	-3.666	0.000	0.114
115.75	-3.49	-4.27	0.00	-112.70	0.00	112.70	930.23	465.11	237.26	173.90	52.81	-3.666	0.000	0.652
120.00	-3.05	-4.16	0.00	-94.57	0.00	94.57	930.23	465.11	237.26	173.90	56.10	-3.713	0.000	0.547
122.00	-2.70	-4.12	0.00	-86.25	0.00	86.25	930.23	465.11	237.26	173.90	57.73	-4.095	0.000	0.499
125.00	-2.41	-4.04	0.00	-73.90	0.00	73.90	930.23	465.11	237.26	173.90	60.47	-4.602	0.000	0.428
125.50	-2.31	-3.46	0.00	-71.87	0.00	71.87	930.23	465.11	237.26	173.90	60.95	-4.679	0.000	0.416
127.00	-2.14	-3.42	0.00	-66.69	0.00	66.69	930.23	465.11	237.26	173.90	62.45	-4.898	0.000	0.386
129.00	-1.89	-3.36	0.00	-59.85	0.00	59.85	930.23	465.11	237.26	173.90	64.56	-5.165	0.000	0.346
130.00	-1.79	-3.34	0.00	-56.49	0.00	56.49	930.23	465.11	237.26	173.90	65.65	-5.288	0.000	0.327
135.00	-1.37	-3.20	0.00	-39.77	0.00	39.77	930.23	465.11	237.26	173.90	71.46	-5.796	0.000	0.230
135.25	-1.32	-2.51	0.00	-38.97	0.00	38.97	930.23	465.11	237.26	173.90	71.77	-5.817	0.000	0.226
135.25	-1.32	-2.51	0.00	-38.97	0.00	38.97	579.84	289.92	92.43	67.75	71.77	-5.817	0.000	0.578
139.00	-0.81	-2.39	0.00	-29.56	0.00	29.56	579.84	289.92	92.43	67.75	76.44	-6.088	0.000	0.438
140.00	-0.74	-2.38	0.00	-27.17	0.00	27.17	579.84	289.92	92.43	67.75	77.75	-6.480	0.000	0.402
145.00	-0.53	-2.27	0.00	-15.25	0.00	15.25	579.84	289.92	92.43	67.75	85.36	-7.947	0.000	0.226
145.12	-0.52	-1.59	0.00	-14.98	0.00	14.98	579.84	289.92	92.43	67.75	85.56	-7.972	0.000	0.222
150.00	-0.18	-1.45	0.00	-7.24	0.00	7.24	579.84	289.92	92.43	67.75	94.10	-8.722	0.000	0.107
155.00	0.00	-1.40	0.00	0.00	0.00	0.00	579.84	289.92	92.43	67.75	103.38	-8.972	0.000	0.000

Wind Loading - Shaft


Structure: CT46141-A-SBA	Code: EIA/TIA-222-G	2/16/2018
Site Name: Water Treatment Plant 2, CT	Exposure: C	
Height: 155.00 (ft)	Crest Height: 0.00	
Base Elev: 0.000 (ft)	Site Class: B - Competent Rock	
Gh: 1.1	Topography: 1	Struct Class: II



Load Case: 1.2D + 1.0Di + 1.0Wi 50 mph Wind

Iterations 30

Dead Load Factor 1.20
Wind Load Factor 1.00

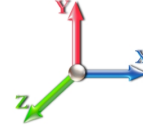

Elev (ft)	Description	Kzt	Kz	qz (psf)	qzGh (psf)	C (mph-ft)	Cf	Ice Thick (in)	Tributary (ft)	Aa (sf)	CfAa (sf)	Wind Force X (lb)	Dead Load Ice (lb)	Tot Dead Load (lb)
0.00		1.00	0.85	5.168	5.68	0.00	1.200	0.000	0.00	0.000	0.00	0.0	0.0	0.0
5.00		1.00	0.85	5.168	5.68	0.00	1.200	1.656	5.00	19.798	23.76	135.1	460.7	1162.5
10.00		1.00	0.85	5.168	5.68	0.00	1.200	1.775	5.00	19.628	23.55	133.9	488.0	1179.5
15.00		1.00	0.85	5.168	5.68	0.00	1.200	1.848	5.00	19.420	23.30	132.5	501.7	1182.9
20.00		1.00	0.90	5.483	6.03	0.00	1.200	1.902	5.00	19.195	23.03	138.9	509.5	1180.3
25.00		1.00	0.95	5.747	6.32	0.00	1.200	1.945	5.00	18.962	22.75	143.9	513.8	1174.4
30.00		1.00	0.98	5.972	6.57	0.00	1.200	1.981	5.00	18.723	22.47	147.6	515.9	1166.1
35.00		1.00	1.01	6.169	6.79	0.00	1.200	2.012	5.00	18.479	22.17	150.5	516.3	1156.2
40.00		1.00	1.04	6.345	6.98	0.00	1.200	2.039	5.00	18.232	21.88	152.7	515.6	1145.2
45.00		1.00	1.07	6.504	7.15	0.00	1.200	2.063	5.00	17.983	21.58	154.4	513.8	1133.1
48.50	Bot - Section 2	1.00	1.09	6.608	7.27	0.00	1.200	2.079	3.50	12.437	14.92	108.5	358.5	785.9
50.00		1.00	1.09	6.650	7.32	0.00	1.200	2.085	1.50	5.355	6.43	47.0	155.3	521.0
53.25	Top - Section 1	1.00	1.11	6.739	7.41	0.00	1.200	2.098	3.25	11.527	13.83	102.5	335.3	1121.2
55.00		1.00	1.12	6.785	7.46	0.00	1.200	2.105	1.75	6.162	7.39	55.2	180.2	391.4
60.00		1.00	1.14	6.910	7.60	0.00	1.200	2.123	5.00	17.438	20.93	159.1	511.1	1107.5
65.00		1.00	1.16	7.028	7.73	0.00	1.200	2.140	5.00	17.183	20.62	159.4	507.0	1093.1
70.00		1.00	1.17	7.138	7.85	0.00	1.200	2.156	5.00	16.927	20.31	159.5	502.4	1078.3
75.00		1.00	1.19	7.243	7.97	0.00	1.200	2.171	5.00	16.670	20.00	159.4	497.5	1063.1
80.00		1.00	1.21	7.342	8.08	0.00	1.200	2.185	5.00	16.413	19.70	159.1	492.3	1047.5
85.00		1.00	1.22	7.436	8.18	0.00	1.200	2.198	5.00	16.155	19.39	158.6	486.8	1031.7
90.00		1.00	1.24	7.526	8.28	0.00	1.200	2.211	5.00	15.896	19.08	157.9	481.1	1015.6
95.00		1.00	1.25	7.612	8.37	0.00	1.200	2.223	5.00	15.637	18.76	157.1	475.1	999.3
98.00	Bot - Section 3	1.00	1.26	7.662	8.43	0.00	1.200	2.230	3.00	9.256	11.11	93.6	282.8	592.4
100.00		1.00	1.27	7.695	8.46	0.00	1.200	2.234	2.00	6.204	7.44	63.0	190.3	602.2
102.00	Top - Section 2	1.00	1.27	7.727	8.50	0.00	1.200	2.239	2.00	6.162	7.39	62.9	189.3	597.9
105.00		1.00	1.28	7.774	8.55	0.00	1.200	2.245	3.00	9.165	11.00	94.1	281.6	587.5
110.00		1.00	1.29	7.851	8.64	0.00	1.200	2.256	5.00	15.069	18.08	156.2	462.8	964.3
115.00		1.00	1.30	7.925	8.72	0.00	1.200	2.266	5.00	14.808	17.77	154.9	456.1	947.2
115.75	Top - Section 3	1.00	1.31	7.936	8.73	0.00	1.200	2.267	0.75	2.198	2.64	23.0	68.3	141.0
120.00		1.00	1.32	7.996	8.80	0.00	1.200	2.276	4.25	4.445	5.33	46.9	121.4	503.1
122.00	Appurtenance(s)	1.00	1.32	8.024	8.83	0.00	1.200	2.279	2.00	2.093	2.51	22.2	57.3	236.8
125.00		1.00	1.33	8.065	8.87	0.00	1.200	2.285	3.00	3.142	3.77	33.5	86.1	355.5
125.50	Appurtenance(s)	1.00	1.33	8.072	8.88	0.00	1.200	2.286	0.50	0.524	0.63	5.6	14.4	59.3
127.00	Appurtenance(s)	1.00	1.33	8.092	8.90	0.00	1.200	2.289	1.50	1.572	1.89	16.8	43.1	177.8
129.00	Appurtenance(s)	1.00	1.34	8.119	8.93	0.00	1.200	2.292	2.00	2.097	2.52	22.5	57.6	237.2
130.00		1.00	1.34	8.132	8.95	0.00	1.200	2.294	1.00	1.049	1.26	11.3	28.8	118.6
135.00		1.00	1.35	8.197	9.02	0.00	1.200	2.303	5.00	5.252	6.30	56.8	144.9	593.9
135.25	Top - Section 4	1.00	1.35	8.200	9.02	0.00	1.200	2.303	0.25	0.263	0.32	2.8	7.2	29.7
139.00	Appurtenance(s)	1.00	1.36	8.247	9.07	24.26	1.200	2.309	3.75	3.006	3.61	32.7	77.3	208.9
140.00		1.00	1.36	8.260	9.09	24.28	1.200	2.311	1.00	0.802	0.96	8.7	20.6	55.7
145.00		1.00	1.37	8.321	9.15	24.37	1.200	2.319	5.00	4.016	4.82	44.1	103.7	279.1
145.12	Appurtenance(s)	1.00	1.37	8.323	9.15	24.37	1.200	2.319	0.12	0.096	0.12	1.1	2.5	6.7
150.00	Appurtenance(s)	1.00	1.38	8.381	9.22	24.46	1.200	2.327	4.88	3.926	4.71	43.4	101.6	272.8
155.00	Appurtenance(s)	1.00	1.39	8.439	9.28	24.54	1.200	2.335	5.00	4.029	4.83	44.9	104.6	280.0
								Totals:	155.00			3,913.5	29,583.4	

Discrete Appurtenance Forces


Structure: CT46141-A-SBA	Code: EIA/TIA-222-G	2/16/2018
Site Name: Water Treatment Plant 2, CT	Exposure: C	
Height: 155.00 (ft)	Crest Height: 0.00	
Base Elev: 0.000 (ft)	Site Class: B - Competent Rock	
Gh: 1.1	Topography: 1	Struct Class: II



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Load Case: 1.2D + 1.0Di + 1.0Wi 50 mph Wind

Dead Load Factor 1.20
Wind Load Factor 1.00

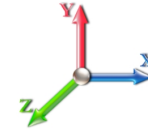

Iterations 30

No.	Elev (ft)	Description	Qty	qz (psf)	qzGh (psf)	CaAa x Ka	Ka	Total CaAa (sf)	Dead Load (lb)	Horiz Ecc (ft)	Vert Ecc (ft)	Wind FX (lb)	Mom Y (lb-ft)	Mom Z (lb-ft)
1	155.00	Truck Ball	1	8.439	9.283	1.00	1.00	4.12	114.67	0.000	0.000	38.26	0.00	0.00
2	155.00	Flag (20'x30')	1	8.439	9.283	1.00	1.00	15.92	240.12	0.000	0.000	147.78	0.00	0.00
3	155.00	27" Canister	1	8.439	9.283	1.00	1.00	5.54	60.00	0.000	0.000	51.46	0.00	0.00
4	150.00	RFS ACU-A20-N	4	8.381	9.219	1.00	1.00	0.00	22.51	0.000	0.000	0.00	0.00	0.00
5	150.00	CCI DPO-7126Y-0-T1	3	8.381	9.219	1.00	1.00	0.00	20.82	0.000	0.000	0.00	0.00	0.00
6	150.00	RFS	3	8.381	9.219	1.00	1.00	0.00	61.90	0.000	0.000	0.00	0.00	0.00
7	150.00	Commscope	3	8.381	9.219	1.00	1.00	0.00	37.52	0.000	0.000	0.00	0.00	0.00
8	145.12	27" Canister & 36"	1	8.323	9.155	1.00	1.00	13.52	229.28	0.000	0.000	123.75	0.00	0.00
9	139.00	DBC0062F3V52-1	6	8.247	9.072	1.00	1.00	0.00	139.36	0.000	0.000	0.00	0.00	0.00
10	139.00	DTMABP0723VG12A	6	8.247	9.072	1.00	1.00	0.00	297.05	0.000	0.000	0.00	0.00	0.00
11	139.00	TPA-65R-LCUUUU-H8	3	8.247	9.072	1.00	1.00	46.57	1573.44	0.000	0.000	422.44	0.00	0.00
12	135.25	36" Canister & 29"	1	8.200	9.020	1.00	1.00	13.71	229.21	0.000	0.000	123.63	0.00	0.00
13	129.00	APX18-206517S-C-A20	3	8.119	8.931	1.00	1.00	0.00	370.09	0.000	0.000	0.00	0.00	0.00
14	127.00	CBC721-DF	6	8.092	8.901	1.00	1.00	0.00	90.62	0.000	0.000	0.00	0.00	0.00
15	125.50	29" Canister & 30"	1	8.072	8.879	1.00	1.00	11.73	229.14	0.000	0.000	104.18	0.00	0.00
16	122.00	SBNHH-1D6565A	3	8.024	8.826	1.00	1.00	29.73	1014.78	0.000	0.000	262.37	0.00	0.00
17	115.75	30" Canister	1	7.936	8.729	1.00	1.00	6.00	114.53	0.000	0.000	52.36	0.00	0.00

Totals: 4,845.04

1,326.23

Total Applied Force Summary


Structure: CT46141-A-SBA	Code: EIA/TIA-222-G	2/16/2018
Site Name: Water Treatment Plant 2, CT	Exposure: C	
Height: 155.00 (ft)	Crest Height: 0.00	
Base Elev: 0.000 (ft)	Site Class: B - Competent Rock	
Gh: 1.1	Topography: 1	Struct Class: II



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Load Case: 1.2D + 1.0Di + 1.0Wi 50 mph Wind

Dead Load Factor 1.20
Wind Load Factor 1.00

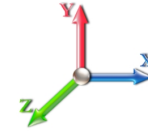

Iterations 30

Elev (ft)	Description	Lateral FX (-) (lb)	Axial FY (-) (lb)	Torsion MY (lb-ft)	Moment MZ (lb-ft)
0.00		0.00	0.00	0.00	0.00
5.00		135.06	1388.19	0.00	0.00
10.00		133.89	1405.22	0.00	0.00
15.00		132.48	1408.63	0.00	0.00
20.00		138.94	1406.07	0.00	0.00
25.00		143.85	1400.08	0.00	0.00
30.00		147.59	1391.83	0.00	0.00
35.00		150.48	1381.96	0.00	0.00
40.00		152.70	1370.88	0.00	0.00
45.00		154.40	1358.83	0.00	0.00
48.50		108.48	943.86	0.00	0.00
50.00		47.01	588.71	0.00	0.00
53.25		102.53	1267.91	0.00	0.00
55.00		55.18	470.36	0.00	0.00
60.00		159.07	1333.27	0.00	0.00
65.00		159.40	1318.83	0.00	0.00
70.00		159.50	1303.98	0.00	0.00
75.00		159.38	1288.77	0.00	0.00
80.00		159.06	1273.24	0.00	0.00
85.00		158.57	1257.42	0.00	0.00
90.00		157.92	1241.33	0.00	0.00
95.00		157.12	1225.01	0.00	0.00
98.00		93.62	727.83	0.00	0.00
100.00		63.01	692.52	0.00	0.00
102.00		62.85	688.21	0.00	0.00
105.00		94.06	722.88	0.00	0.00
110.00		156.16	1189.98	0.00	0.00
115.00		154.90	1172.92	0.00	0.00
115.75	(1) attachments	75.39	289.43	0.00	0.00
120.00		46.92	694.91	0.00	0.00
122.00	(3) attachments	284.54	1341.92	0.00	0.00
125.00		33.45	446.03	0.00	0.00
125.50	(1) attachments	109.76	303.49	0.00	0.00
127.00	(6) attachments	16.79	313.71	0.00	0.00
129.00	(3) attachments	22.48	667.66	0.00	0.00
130.00		11.26	141.33	0.00	0.00
135.00		56.83	707.30	0.00	0.00
135.25	(1) attachments	126.47	264.58	0.00	0.00
139.00	(15) attachments	455.17	2303.77	0.00	0.00
140.00		8.74	70.91	0.00	0.00
145.00		44.11	355.03	0.00	0.00
145.12	(1) attachments	124.81	237.80	0.00	0.00
150.00	(13) attachments	43.43	489.71	0.00	0.00
155.00	(3) attachments	282.37	694.78	0.00	0.00
	Totals:	5,239.74	40,541.07	0.00	0.00

Calculated Forces

Structure: CT46141-A-SBA	Code: EIA/TIA-222-G	2/16/2018
Site Name: Water Treatment Plant 2, CT	Exposure: C	
Height: 155.00 (ft)	Crest Height: 0.00	
Base Elev: 0.000 (ft)	Site Class: B - Competent Rock	
Gh: 1.1	Topography: 1	Struct Class: II




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Load Case: 1.2D + 1.0Di + 1.0Wi 50 mph Wind

Iterations 30

Dead Load Factor 1.20

Wind Load Factor 1.00

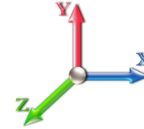

Seg Elev (ft)	Pu FY (-) (kips)	Vu FX (-) (kips)	Tu MY (-) (ft-kips)	Mu MZ (ft-kips)	Mu MX (ft-kips)	Resultant Moment (ft-kips)	phi Pn (kips)	phi Vn (kips)	phi Tn (ft-kips)	phi Mn (ft-kips)	Total Deflect (in)	Rotation Sway (deg)	Rotation Twist (deg)	Stress Ratio
0.00	-40.54	-5.27	0.00	-490.15	0.00	490.15	2027.49	1013.74	3641.02	1807.56	0.00	0.000	0.000	0.291
5.00	-39.14	-5.19	0.00	-463.81	0.00	463.81	2015.42	1007.71	3566.22	1770.42	0.04	-0.082	0.000	0.281
10.00	-37.73	-5.10	0.00	-437.87	0.00	437.87	2002.83	1001.41	3491.15	1733.15	0.17	-0.164	0.000	0.272
15.00	-36.31	-5.02	0.00	-412.34	0.00	412.34	1989.72	994.86	3415.85	1695.77	0.39	-0.244	0.000	0.261
20.00	-34.90	-4.92	0.00	-387.25	0.00	387.25	1976.09	988.05	3340.37	1658.30	0.69	-0.323	0.000	0.251
25.00	-33.50	-4.81	0.00	-362.66	0.00	362.66	1961.94	980.97	3264.74	1620.75	1.06	-0.400	0.000	0.241
30.00	-32.10	-4.70	0.00	-338.60	0.00	338.60	1947.28	973.64	3189.01	1583.16	1.52	-0.476	0.000	0.230
35.00	-30.71	-4.57	0.00	-315.12	0.00	315.12	1932.09	966.05	3113.21	1545.53	2.06	-0.550	0.000	0.220
40.00	-29.34	-4.44	0.00	-292.27	0.00	292.27	1916.39	958.20	3037.39	1507.89	2.68	-0.623	0.000	0.209
45.00	-27.98	-4.30	0.00	-270.06	0.00	270.06	1900.17	950.08	2961.59	1470.26	3.37	-0.693	0.000	0.198
48.50	-27.03	-4.20	0.00	-255.01	0.00	255.01	1888.50	944.25	2908.57	1443.94	3.89	-0.741	0.000	0.191
50.00	-26.44	-4.16	0.00	-248.71	0.00	248.71	1883.43	941.71	2885.86	1432.66	4.13	-0.762	0.000	0.188
53.25	-25.17	-4.05	0.00	-235.20	0.00	235.20	1885.78	942.89	2896.38	1437.89	4.66	-0.805	0.000	0.177
55.00	-24.70	-4.01	0.00	-228.11	0.00	228.11	1879.83	939.91	2869.89	1424.73	4.96	-0.829	0.000	0.173
60.00	-23.37	-3.85	0.00	-208.07	0.00	208.07	1862.46	931.23	2794.28	1387.20	5.86	-0.890	0.000	0.163
65.00	-22.05	-3.69	0.00	-188.81	0.00	188.81	1844.57	922.28	2718.82	1349.74	6.83	-0.948	0.000	0.152
70.00	-20.74	-3.53	0.00	-170.34	0.00	170.34	1826.16	913.08	2643.55	1312.37	7.85	-1.004	0.000	0.141
75.00	-19.45	-3.37	0.00	-152.68	0.00	152.68	1807.23	903.62	2568.52	1275.12	8.93	-1.057	0.000	0.131
80.00	-18.18	-3.20	0.00	-135.84	0.00	135.84	1787.79	893.89	2493.75	1238.00	10.06	-1.107	0.000	0.120
85.00	-16.92	-3.03	0.00	-119.84	0.00	119.84	1767.82	883.91	2419.31	1201.05	11.25	-1.154	0.000	0.109
90.00	-15.68	-2.86	0.00	-104.69	0.00	104.69	1747.34	873.67	2345.22	1164.27	12.48	-1.197	0.000	0.099
95.00	-14.46	-2.68	0.00	-90.40	0.00	90.40	1726.34	863.17	2271.53	1127.68	13.76	-1.237	0.000	0.089
98.00	-13.74	-2.58	0.00	-82.36	0.00	82.36	1713.49	856.74	2227.52	1105.83	14.54	-1.260	0.000	0.082
100.00	-13.04	-2.50	0.00	-77.20	0.00	77.20	1704.82	852.41	2198.27	1091.31	15.07	-1.274	0.000	0.078
102.00	-12.36	-2.43	0.00	-72.20	0.00	72.20	1713.25	856.63	2226.72	1105.44	15.61	-1.288	0.000	0.073
105.00	-11.63	-2.32	0.00	-64.91	0.00	64.91	1700.21	850.10	2182.88	1083.67	16.43	-1.308	0.000	0.067
110.00	-10.45	-2.14	0.00	-53.30	0.00	53.30	1678.06	839.03	2110.21	1047.60	17.81	-1.335	0.000	0.057
115.00	-9.28	-1.96	0.00	-42.59	0.00	42.59	1655.39	827.70	2038.07	1011.78	19.22	-1.359	0.000	0.048
115.75	-8.99	-1.88	0.00	-41.11	0.00	41.11	1651.95	825.97	2027.30	1006.43	19.44	-1.363	0.000	0.046
115.75	-8.99	-1.88	0.00	-41.11	0.00	41.11	930.23	465.11	237.26	173.90	19.44	-1.363	0.000	0.246
120.00	-8.29	-1.83	0.00	-33.11	0.00	33.11	930.23	465.11	237.26	173.90	20.66	-1.380	0.000	0.199
122.00	-6.96	-1.53	0.00	-29.45	0.00	29.45	930.23	465.11	237.26	173.90	21.26	-1.512	0.000	0.177
125.00	-6.51	-1.50	0.00	-24.86	0.00	24.86	930.23	465.11	237.26	173.90	22.27	-1.684	0.000	0.150
125.50	-6.21	-1.38	0.00	-24.12	0.00	24.12	930.23	465.11	237.26	173.90	22.45	-1.709	0.000	0.145
127.00	-5.89	-1.36	0.00	-22.04	0.00	22.04	930.23	465.11	237.26	173.90	22.99	-1.782	0.000	0.133
129.00	-5.22	-1.33	0.00	-19.31	0.00	19.31	930.23	465.11	237.26	173.90	23.76	-1.870	0.000	0.117
130.00	-5.08	-1.32	0.00	-17.99	0.00	17.99	930.23	465.11	237.26	173.90	24.15	-1.909	0.000	0.109
135.00	-4.37	-1.24	0.00	-11.39	0.00	11.39	930.23	465.11	237.26	173.90	26.24	-2.064	0.000	0.070
135.25	-4.11	-1.11	0.00	-11.08	0.00	11.08	930.23	465.11	237.26	173.90	26.35	-2.070	0.000	0.068
135.25	-4.11	-1.11	0.00	-11.08	0.00	11.08	579.84	289.92	92.43	67.75	26.35	-2.070	0.000	0.171
139.00	-1.83	-0.57	0.00	-6.92	0.00	6.92	579.84	289.92	92.43	67.75	28.00	-2.141	0.000	0.105
140.00	-1.75	-0.57	0.00	-6.34	0.00	6.34	579.84	289.92	92.43	67.75	28.46	-2.233	0.000	0.097
145.00	-1.40	-0.51	0.00	-3.50	0.00	3.50	579.84	289.92	92.43	67.75	31.00	-2.573	0.000	0.054
145.12	-1.17	-0.38	0.00	-3.44	0.00	3.44	579.84	289.92	92.43	67.75	31.06	-2.579	0.000	0.053
150.00	-0.68	-0.32	0.00	-1.58	0.00	1.58	579.84	289.92	92.43	67.75	33.79	-2.748	0.000	0.024
155.00	0.00	-0.28	0.00	0.00	0.00	0.00	579.84	289.92	92.43	67.75	36.71	-2.803	0.000	0.000


Seismic Segment Forces (Factored)

Structure: CT46141-A-SBA	Code: EIA/TIA-222-G	2/16/2018
Site Name: Water Treatment Plant 2, CT	Exposure: C	
Height: 155.00 (ft)	Crest Height: 0.00	
Base Elev: 0.000 (ft)	Site Class: B - Competent Rock	
Gh: 1.1	Topography: 1	Struct Class: II



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Load Case: 1.2D + 1.0E				Iterations 26
Gust Response Factor	1.10	Sds	0.12	Ss 0.18
Dead Load Factor	1.20	Seismic Load Factor	1.00	S1 0.06
Wind Load Factor	0.00	Structure Frequency	0.34	SA 0.01
				Seismic Importance Factor 1.00

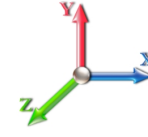

Top Elev (ft)	Description	Wz (lb)	a	b	c	Lateral Fs (lb)	R: 1.50
0.00		0.00	0.00	0.00	0.00	0.00	
5.00		584.85	0.00	0.03	0.02	8.55	
10.00		576.25	0.01	0.05	0.03	11.60	
15.00		567.65	0.02	0.06	0.04	12.89	
20.00		559.05	0.03	0.07	0.04	13.42	
25.00		550.46	0.05	0.07	0.04	13.63	
30.00		541.86	0.07	0.07	0.04	13.74	
35.00		533.26	0.10	0.07	0.04	13.86	
40.00		524.66	0.13	0.07	0.03	13.99	
45.00		516.06	0.16	0.07	0.03	14.10	
48.50	Bot - Section 2	356.13	0.19	0.06	0.03	9.84	
50.00		304.71	0.20	0.06	0.02	8.44	
53.25	Top - Section 1	654.89	0.22	0.06	0.02	18.11	
55.00		176.00	0.24	0.06	0.02	4.83	
60.00		497.05	0.28	0.05	0.01	12.88	
65.00		488.45	0.33	0.04	0.01	10.89	
70.00		479.85	0.39	0.02	0.01	7.55	
75.00		471.26	0.44	0.00	0.01	2.80	
80.00		462.66	0.50	-0.02	0.01	-2.72	
85.00		454.06	0.57	-0.04	0.01	-7.81	
90.00		445.46	0.64	-0.07	0.02	-11.45	
95.00		436.86	0.71	-0.09	0.03	-13.33	
98.00	Bot - Section 3	257.99	0.76	-0.10	0.04	-8.16	
100.00		343.26	0.79	-0.11	0.05	-10.88	
102.00	Top - Section 2	340.51	0.82	-0.12	0.06	-10.64	
105.00		254.84	0.87	-0.12	0.08	-7.55	
110.00		417.85	0.95	-0.12	0.11	-10.25	
115.00		409.25	1.04	-0.10	0.15	-6.79	
115.75	Top - Section 3	110.65	1.05	-0.09	0.16	-1.68	
120.00		318.03	1.13	-0.05	0.21	-1.87	
122.00	Appurtenance(s)	291.86	1.17	-0.02	0.23	-0.23	
125.00		224.49	1.23	0.03	0.28	1.72	
125.50	Appurtenance(s)	137.42	1.24	0.04	0.28	1.26	
127.00	Appurtenance(s)	138.65	1.27	0.08	0.31	1.93	
129.00	Appurtenance(s)	222.26	1.31	0.13	0.34	4.57	
130.00		74.83	1.33	0.16	0.36	1.80	
135.00		374.15	1.43	0.35	0.47	16.25	
135.25	Top - Section 4	118.71	1.44	0.36	0.47	5.28	
139.00	Appurtenance(s)	489.42	1.52	0.55	0.57	29.90	
140.00		29.23	1.54	0.61	0.59	1.92	
145.00		146.15	1.65	0.96	0.75	13.34	
145.12	Appurtenance(s)	103.51	1.66	0.96	0.75	9.52	
150.00	Appurtenance(s)	324.25	1.77	1.41	0.93	38.89	
155.00	Appurtenance(s)	446.15	1.89	1.98	1.14	67.77	
Totals:		15,754.9				292.0	Total Wind: 16,217.0

Seismic Base Shear is Less Than 50% of Wind Force - An Analysis is NOT Required


Calculated Forces

Structure: CT46141-A-SBA	Code: EIA/TIA-222-G	2/16/2018
Site Name: Water Treatment Plant 2, CT	Exposure: C	
Height: 155.00 (ft)	Crest Height: 0.00	
Base Elev: 0.000 (ft)	Site Class: B - Competent Rock	
Gh: 1.1	Topography: 1	Struct Class: II



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Load Case: 1.2D + 1.0E										Iterations 26
Gust Response Factor 1.10						Sds 0.12				Ss 0.18
Dead Load Factor 1.20		Seismic Load Factor 1.00				Sd1 0.04				S1 0.06
Wind Load Factor 0.00		Structure Frequency 0.34				SA 0.01		Seismic Importance Factor 1.00		

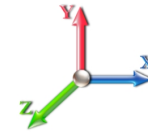

Seg Elev (ft)	Pu FY (-) (kips)	Vu FX (-) (kips)	Tu MY (-) (ft-kips)	Mu MZ (ft-kips)	Mu MX (ft-kips)	Resultant Moment (ft-kips)	phi Pn (kips)	phi Vn (kips)	phi Tn (ft-kips)	phi Mn (ft-kips)	Total Deflect (in)	Rotation Sway (deg)	Rotation Twist (deg)	Stress Ratio
0.00	-25.02	-0.39	0.00	-37.62	0.00	37.62	2027.49	1013.74	3641.02	1807.56	0.00	0.00	0.00	0.033
5.00	-24.09	-0.38	0.00	-35.70	0.00	35.70	2015.42	1007.71	3566.22	1770.42	0.00	-0.01	0.032	
10.00	-23.17	-0.37	0.00	-33.80	0.00	33.80	2002.83	1001.41	3491.15	1733.15	0.01	-0.01	0.031	
15.00	-22.27	-0.36	0.00	-31.95	0.00	31.95	1989.72	994.86	3415.85	1695.77	0.03	-0.02	0.030	
20.00	-21.37	-0.35	0.00	-30.15	0.00	30.15	1976.09	988.05	3340.37	1658.30	0.05	-0.02	0.029	
25.00	-20.48	-0.34	0.00	-28.41	0.00	28.41	1961.94	980.97	3264.74	1620.75	0.08	-0.03	0.028	
30.00	-19.61	-0.32	0.00	-26.73	0.00	26.73	1947.28	973.64	3189.01	1583.16	0.12	-0.04	0.027	
35.00	-18.74	-0.31	0.00	-25.11	0.00	25.11	1932.09	966.05	3113.21	1545.53	0.16	-0.04	0.026	
40.00	-17.89	-0.30	0.00	-23.56	0.00	23.56	1916.39	958.20	3037.39	1507.89	0.21	-0.05	0.025	
45.00	-17.04	-0.28	0.00	-22.07	0.00	22.07	1900.17	950.08	2961.59	1470.26	0.26	-0.05	0.024	
48.50	-16.46	-0.28	0.00	-21.07	0.00	21.07	1888.50	944.25	2908.57	1443.94	0.30	-0.06	0.023	
50.00	-16.02	-0.27	0.00	-20.66	0.00	20.66	1883.43	941.71	2885.86	1432.66	0.32	-0.06	0.023	
53.25	-15.09	-0.25	0.00	-19.79	0.00	19.79	1885.78	942.89	2896.38	1437.89	0.36	-0.06	0.022	
55.00	-14.80	-0.24	0.00	-19.35	0.00	19.35	1879.83	939.91	2869.89	1424.73	0.39	-0.07	0.021	
60.00	-13.98	-0.23	0.00	-18.13	0.00	18.13	1862.46	931.23	2794.28	1387.20	0.46	-0.07	0.021	
65.00	-13.17	-0.22	0.00	-16.97	0.00	16.97	1844.57	922.28	2718.82	1349.74	0.54	-0.08	0.020	
70.00	-12.36	-0.21	0.00	-15.86	0.00	15.86	1826.16	913.08	2643.55	1312.37	0.62	-0.08	0.019	
75.00	-11.57	-0.21	0.00	-14.79	0.00	14.79	1807.23	903.62	2568.52	1275.12	0.71	-0.09	0.018	
80.00	-10.79	-0.21	0.00	-13.74	0.00	13.74	1787.79	893.89	2493.75	1238.00	0.80	-0.09	0.017	
85.00	-10.02	-0.21	0.00	-12.68	0.00	12.68	1767.82	883.91	2419.31	1201.05	0.90	-0.10	0.016	
90.00	-9.26	-0.21	0.00	-11.63	0.00	11.63	1747.34	873.67	2345.22	1164.27	1.00	-0.10	0.015	
95.00	-8.51	-0.21	0.00	-10.59	0.00	10.59	1726.34	863.17	2271.53	1127.68	1.11	-0.11	0.014	
98.00	-8.07	-0.21	0.00	-9.96	0.00	9.96	1713.49	856.74	2227.52	1105.83	1.17	-0.11	0.014	
100.00	-7.56	-0.21	0.00	-9.54	0.00	9.54	1704.82	852.41	2198.27	1091.31	1.22	-0.11	0.013	
102.00	-7.07	-0.21	0.00	-9.13	0.00	9.13	1713.25	856.63	2226.72	1105.44	1.27	-0.11	0.012	
105.00	-6.62	-0.21	0.00	-8.51	0.00	8.51	1700.21	850.10	2182.88	1083.67	1.34	-0.11	0.012	
110.00	-5.90	-0.21	0.00	-7.47	0.00	7.47	1678.06	839.03	2110.21	1047.60	1.46	-0.12	0.011	
115.00	-5.18	-0.20	0.00	-6.45	0.00	6.45	1655.39	827.70	2038.07	1011.78	1.58	-0.12	0.009	
115.75	-5.01	-0.20	0.00	-6.29	0.00	6.29	1651.95	825.97	2027.30	1006.43	1.60	-0.12	0.009	
115.75	-5.01	-0.20	0.00	-6.29	0.00	6.29	930.23	465.11	237.26	173.90	1.60	-0.12	0.042	
120.00	-4.44	-0.20	0.00	-5.42	0.00	5.42	930.23	465.11	237.26	173.90	1.71	-0.12	0.036	
122.00	-4.00	-0.20	0.00	-5.02	0.00	5.02	930.23	465.11	237.26	173.90	1.77	-0.15	0.033	
125.00	-3.64	-0.20	0.00	-4.40	0.00	4.40	930.23	465.11	237.26	173.90	1.87	-0.18	0.029	
125.50	-3.46	-0.20	0.00	-4.30	0.00	4.30	930.23	465.11	237.26	173.90	1.89	-0.18	0.028	
127.00	-3.25	-0.20	0.00	-4.00	0.00	4.00	930.23	465.11	237.26	173.90	1.95	-0.19	0.026	
129.00	-2.92	-0.20	0.00	-3.60	0.00	3.60	930.23	465.11	237.26	173.90	2.03	-0.21	0.024	
130.00	-2.81	-0.19	0.00	-3.40	0.00	3.40	930.23	465.11	237.26	173.90	2.08	-0.22	0.023	
135.00	-2.25	-0.18	0.00	-2.43	0.00	2.43	930.23	465.11	237.26	173.90	2.32	-0.25	0.016	
135.25	-2.10	-0.17	0.00	-2.39	0.00	2.39	930.23	465.11	237.26	173.90	2.33	-0.25	0.016	
135.25	-2.10	-0.17	0.00	-2.39	0.00	2.39	579.84	289.92	92.43	67.75	2.33	-0.25	0.039	
139.00	-1.43	-0.14	0.00	-1.75	0.00	1.75	579.84	289.92	92.43	67.75	2.54	-0.27	0.028	
140.00	-1.38	-0.14	0.00	-1.61	0.00	1.61	579.84	289.92	92.43	67.75	2.60	-0.29	0.026	
145.00	-1.12	-0.12	0.00	-0.93	0.00	0.93	579.84	289.92	92.43	67.75	2.95	-0.38	0.016	
145.12	-1.00	-0.11	0.00	-0.91	0.00	0.91	579.84	289.92	92.43	67.75	2.96	-0.38	0.015	
150.00	-0.53	-0.07	0.00	-0.36	0.00	0.36	579.84	289.92	92.43	67.75	3.37	-0.42	0.006	
155.00	0.00	-0.07	0.00	0.00	0.00	0.00	579.84	289.92	92.43	67.75	3.82	-0.43	0.000	

Calculated Forces

Structure: CT46141-A-SBA	Code: EIA/TIA-222-G	2/16/2018
Site Name: Water Treatment Plant 2, CT	Exposure: C	
Height: 155.00 (ft)	Crest Height: 0.00	
Base Elev: 0.000 (ft)	Site Class: B - Competent Rock	
Gh: 1.1	Topography: 1	Struct Class: II



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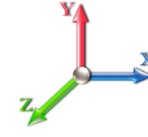
Seismic Segment Forces (Factored)

Structure: CT46141-A-SBA	Code: EIA/TIA-222-G	2/16/2018
Site Name: Water Treatment Plant 2, CT	Exposure: C	
Height: 155.00 (ft)	Crest Height: 0.00	
Base Elev: 0.000 (ft)	Site Class: B - Competent Rock	
Gh: 1.1	Topography: 1	Struct Class: II



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Load Case: 0.9D + 1.0E				Iterations 26
Gust Response Factor	1.10	Sds	0.12	Ss 0.18
Dead Load Factor	0.90	Seismic Load Factor	1.00	S1 0.06
Wind Load Factor	0.00	Structure Frequency	0.34	SA 0.01
				Seismic Importance Factor 1.00



Top Elev (ft)	Description	Wz (lb)	a	b	c	Lateral Fs (lb)	R: 1.50
0.00		0.00	0.00	0.00	0.00	0.00	
5.00		584.85	0.00	0.03	0.02	8.55	
10.00		576.25	0.01	0.05	0.03	11.60	
15.00		567.65	0.02	0.06	0.04	12.89	
20.00		559.05	0.03	0.07	0.04	13.42	
25.00		550.46	0.05	0.07	0.04	13.63	
30.00		541.86	0.07	0.07	0.04	13.74	
35.00		533.26	0.10	0.07	0.04	13.86	
40.00		524.66	0.13	0.07	0.03	13.99	
45.00		516.06	0.16	0.07	0.03	14.10	
48.50	Bot - Section 2	356.13	0.19	0.06	0.03	9.84	
50.00		304.71	0.20	0.06	0.02	8.44	
53.25	Top - Section 1	654.89	0.22	0.06	0.02	18.11	
55.00		176.00	0.24	0.06	0.02	4.83	
60.00		497.05	0.28	0.05	0.01	12.88	
65.00		488.45	0.33	0.04	0.01	10.89	
70.00		479.85	0.39	0.02	0.01	7.55	
75.00		471.26	0.44	0.00	0.01	2.80	
80.00		462.66	0.50	-0.02	0.01	-2.72	
85.00		454.06	0.57	-0.04	0.01	-7.81	
90.00		445.46	0.64	-0.07	0.02	-11.45	
95.00		436.86	0.71	-0.09	0.03	-13.33	
98.00	Bot - Section 3	257.99	0.76	-0.10	0.04	-8.16	
100.00		343.26	0.79	-0.11	0.05	-10.88	
102.00	Top - Section 2	340.51	0.82	-0.12	0.06	-10.64	
105.00		254.84	0.87	-0.12	0.08	-7.55	
110.00		417.85	0.95	-0.12	0.11	-10.25	
115.00		409.25	1.04	-0.10	0.15	-6.79	
115.75	Top - Section 3	110.65	1.05	-0.09	0.16	-1.68	
120.00		318.03	1.13	-0.05	0.21	-1.87	
122.00	Appurtenance(s)	291.86	1.17	-0.02	0.23	-0.23	
125.00		224.49	1.23	0.03	0.28	1.72	
125.50	Appurtenance(s)	137.42	1.24	0.04	0.28	1.26	
127.00	Appurtenance(s)	138.65	1.27	0.08	0.31	1.93	
129.00	Appurtenance(s)	222.26	1.31	0.13	0.34	4.57	
130.00		74.83	1.33	0.16	0.36	1.80	
135.00		374.15	1.43	0.35	0.47	16.25	
135.25	Top - Section 4	118.71	1.44	0.36	0.47	5.28	
139.00	Appurtenance(s)	489.42	1.52	0.55	0.57	29.90	
140.00		29.23	1.54	0.61	0.59	1.92	
145.00		146.15	1.65	0.96	0.75	13.34	
145.12	Appurtenance(s)	103.51	1.66	0.96	0.75	9.52	
150.00	Appurtenance(s)	324.25	1.77	1.41	0.93	38.89	
155.00	Appurtenance(s)	446.15	1.89	1.98	1.14	67.77	
Totals:		15,754.9				292.0	Total Wind: 16,217.0

Seismic Base Shear is Less Than 50% of Wind Force - An Analysis is NOT Required


Calculated Forces

Structure: CT46141-A-SBA	Code: EIA/TIA-222-G	2/16/2018
Site Name: Water Treatment Plant 2, CT	Exposure: C	
Height: 155.00 (ft)	Crest Height: 0.00	
Base Elev: 0.000 (ft)	Site Class: B - Competent Rock	
Gh: 1.1	Topography: 1	Struct Class: II



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Load Case: 0.9D + 1.0E						Iterations 26
Gust Response Factor	1.10		Sds	0.12		Ss 0.18
Dead Load Factor	0.90	Seismic Load Factor	1.00	Sd1	0.04	S1 0.06
Wind Load Factor	0.00	Structure Frequency	0.34	SA	0.01	Seismic Importance Factor 1.00

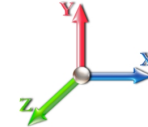

Seg Elev (ft)	Pu FY (-) (kips)	Vu FX (-) (kips)	Tu MY (-) (ft-kips)	Mu MZ (ft-kips)	Mu MX (ft-kips)	Resultant Moment (ft-kips)	phi Pn (kips)	phi Vn (kips)	phi Tn (ft-kips)	phi Mn (ft-kips)	Total Deflect (in)	Rotation Sway (deg)	Rotation Twist (deg)	Stress Ratio
0.00	-18.76	-0.39	0.00	-37.12	0.00	37.12	2027.49	1013.74	3641.02	1807.56	0.00	0.00	0.00	0.030
5.00	-18.07	-0.38	0.00	-35.20	0.00	35.20	2015.42	1007.71	3566.22	1770.42	0.00	-0.01	0.029	
10.00	-17.38	-0.37	0.00	-33.31	0.00	33.31	2002.83	1001.41	3491.15	1733.15	0.01	-0.01	0.028	
15.00	-16.70	-0.36	0.00	-31.46	0.00	31.46	1989.72	994.86	3415.85	1695.77	0.03	-0.02	0.027	
20.00	-16.03	-0.35	0.00	-29.68	0.00	29.68	1976.09	988.05	3340.37	1658.30	0.05	-0.02	0.026	
25.00	-15.36	-0.33	0.00	-27.95	0.00	27.95	1961.94	980.97	3264.74	1620.75	0.08	-0.03	0.025	
30.00	-14.71	-0.32	0.00	-26.28	0.00	26.28	1947.28	973.64	3189.01	1583.16	0.12	-0.04	0.024	
35.00	-14.06	-0.31	0.00	-24.68	0.00	24.68	1932.09	966.05	3113.21	1545.53	0.16	-0.04	0.023	
40.00	-13.42	-0.29	0.00	-23.15	0.00	23.15	1916.39	958.20	3037.39	1507.89	0.20	-0.05	0.022	
45.00	-12.78	-0.28	0.00	-21.67	0.00	21.67	1900.17	950.08	2961.59	1470.26	0.26	-0.05	0.021	
48.50	-12.34	-0.27	0.00	-20.69	0.00	20.69	1888.50	944.25	2908.57	1443.94	0.30	-0.06	0.021	
50.00	-12.02	-0.26	0.00	-20.29	0.00	20.29	1883.43	941.71	2885.86	1432.66	0.32	-0.06	0.021	
53.25	-11.32	-0.24	0.00	-19.43	0.00	19.43	1885.78	942.89	2896.38	1437.89	0.36	-0.06	0.020	
55.00	-11.10	-0.24	0.00	-19.00	0.00	19.00	1879.83	939.91	2869.89	1424.73	0.38	-0.06	0.019	
60.00	-10.48	-0.23	0.00	-17.80	0.00	17.80	1862.46	931.23	2794.28	1387.20	0.45	-0.07	0.018	
65.00	-9.87	-0.22	0.00	-16.67	0.00	16.67	1844.57	922.28	2718.82	1349.74	0.53	-0.07	0.018	
70.00	-9.27	-0.21	0.00	-15.58	0.00	15.58	1826.16	913.08	2643.55	1312.37	0.61	-0.08	0.017	
75.00	-8.68	-0.21	0.00	-14.54	0.00	14.54	1807.23	903.62	2568.52	1275.12	0.69	-0.08	0.016	
80.00	-8.09	-0.21	0.00	-13.51	0.00	13.51	1787.79	893.89	2493.75	1238.00	0.79	-0.09	0.015	
85.00	-7.52	-0.21	0.00	-12.48	0.00	12.48	1767.82	883.91	2419.31	1201.05	0.88	-0.09	0.015	
90.00	-6.95	-0.21	0.00	-11.45	0.00	11.45	1747.34	873.67	2345.22	1164.27	0.98	-0.10	0.014	
95.00	-6.38	-0.20	0.00	-10.42	0.00	10.42	1726.34	863.17	2271.53	1127.68	1.09	-0.10	0.013	
98.00	-6.05	-0.20	0.00	-9.81	0.00	9.81	1713.49	856.74	2227.52	1105.83	1.16	-0.11	0.012	
100.00	-5.67	-0.20	0.00	-9.40	0.00	9.40	1704.82	852.41	2198.27	1091.31	1.20	-0.11	0.012	
102.00	-5.30	-0.20	0.00	-8.99	0.00	8.99	1713.25	856.63	2226.72	1105.44	1.25	-0.11	0.011	
105.00	-4.97	-0.20	0.00	-8.38	0.00	8.38	1700.21	850.10	2182.88	1083.67	1.32	-0.11	0.011	
110.00	-4.42	-0.20	0.00	-7.36	0.00	7.36	1678.06	839.03	2110.21	1047.60	1.43	-0.12	0.010	
115.00	-3.89	-0.20	0.00	-6.35	0.00	6.35	1655.39	827.70	2038.07	1011.78	1.56	-0.12	0.009	
115.75	-3.76	-0.20	0.00	-6.20	0.00	6.20	1651.95	825.97	2027.30	1006.43	1.58	-0.12	0.008	
115.75	-3.76	-0.20	0.00	-6.20	0.00	6.20	930.23	465.11	237.26	173.90	1.58	-0.12	0.040	
120.00	-3.33	-0.20	0.00	-5.34	0.00	5.34	930.23	465.11	237.26	173.90	1.68	-0.12	0.034	
122.00	-3.00	-0.20	0.00	-4.94	0.00	4.94	930.23	465.11	237.26	173.90	1.74	-0.14	0.032	
125.00	-2.73	-0.20	0.00	-4.34	0.00	4.34	930.23	465.11	237.26	173.90	1.84	-0.17	0.028	
125.50	-2.59	-0.20	0.00	-4.24	0.00	4.24	930.23	465.11	237.26	173.90	1.86	-0.18	0.027	
127.00	-2.44	-0.20	0.00	-3.94	0.00	3.94	930.23	465.11	237.26	173.90	1.92	-0.19	0.025	
129.00	-2.19	-0.19	0.00	-3.54	0.00	3.54	930.23	465.11	237.26	173.90	2.00	-0.21	0.023	
130.00	-2.11	-0.19	0.00	-3.35	0.00	3.35	930.23	465.11	237.26	173.90	2.04	-0.21	0.022	
135.00	-1.68	-0.17	0.00	-2.40	0.00	2.40	930.23	465.11	237.26	173.90	2.28	-0.24	0.016	
135.25	-1.57	-0.17	0.00	-2.35	0.00	2.35	930.23	465.11	237.26	173.90	2.30	-0.25	0.015	
135.25	-1.57	-0.17	0.00	-2.35	0.00	2.35	579.84	289.92	92.43	67.75	2.30	-0.25	0.037	
139.00	-1.07	-0.14	0.00	-1.73	0.00	1.73	579.84	289.92	92.43	67.75	2.50	-0.26	0.027	
140.00	-1.03	-0.14	0.00	-1.59	0.00	1.59	579.84	289.92	92.43	67.75	2.55	-0.28	0.025	
145.00	-0.84	-0.12	0.00	-0.91	0.00	0.91	579.84	289.92	92.43	67.75	2.90	-0.37	0.015	
145.12	-0.75	-0.11	0.00	-0.90	0.00	0.90	579.84	289.92	92.43	67.75	2.91	-0.37	0.015	
150.00	-0.40	-0.07	0.00	-0.35	0.00	0.35	579.84	289.92	92.43	67.75	3.32	-0.41	0.006	
155.00	0.00	-0.07	0.00	0.00	0.00	0.00	579.84	289.92	92.43	67.75	3.76	-0.43	0.000	

Calculated Forces

Structure: CT46141-A-SBA	Code: EIA/TIA-222-G	2/16/2018
Site Name: Water Treatment Plant 2, CT	Exposure: C	
Height: 155.00 (ft)	Crest Height: 0.00	
Base Elev: 0.000 (ft)	Site Class: B - Competent Rock	
Gh: 1.1	Topography: 1	Struct Class: II



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Wind Loading - Shaft

Structure: CT46141-A-SBA	Code: EIA/TIA-222-G	2/16/2018
Site Name: Water Treatment Plant 2, CT	Exposure: C	
Height: 155.00 (ft)	Crest Height: 0.00	
Base Elev: 0.000 (ft)	Site Class: B - Competent Rock	
Gh: 1.1	Topography: 1	Struct Class: II



Load Case: 1.0D + 1.0W 60 mph Wind

Dead Load Factor 1.00
Wind Load Factor 1.00



Iterations 29

Elev (ft)	Description	Kzt	Kz	qz (psf)	qzGh (psf)	C (mph-ft)	Cf	Ice Thick (in)	Tributary (ft)	Aa (sf)	CfAa (sf)	Wind Force X (lb)	Dead Load Ice (lb)	Tot Dead Load (lb)
0.00		1.00	0.85	7.442	8.19	205.25	0.750	0.000	0.00	0.000	0.00	0.0	0.0	0.0
5.00		1.00	0.85	7.442	8.19	202.27	0.750	0.000	5.00	18.418	13.81	113.1	0.0	584.8
10.00		1.00	0.85	7.442	8.19	199.30	0.750	0.000	5.00	18.148	13.61	111.4	0.0	576.3
15.00		1.00	0.85	7.442	8.19	196.32	0.750	0.000	5.00	17.879	13.41	109.8	0.0	567.7
20.00		1.00	0.90	7.896	8.69	199.15	0.750	0.000	5.00	17.610	13.21	114.7	0.0	559.1
25.00		1.00	0.95	8.276	9.10	200.74	0.750	0.000	5.00	17.341	13.01	118.4	0.0	550.5
30.00		1.00	0.98	8.600	9.46	201.43	0.750	0.000	5.00	17.072	12.80	121.1	0.0	541.9
35.00		1.00	1.01	8.883	9.77	201.47	0.750	0.000	5.00	16.802	12.60	123.1	0.0	533.3
40.00		1.00	1.04	9.137	10.05	201.03	0.750	0.000	5.00	16.533	12.40	124.6	0.0	524.7
45.00		1.00	1.07	9.366	10.30	200.19	0.750	0.000	5.00	16.264	12.20	125.7	0.0	516.1
48.50	Bot - Section 2	1.00	1.09	9.515	10.47	199.42	0.750	0.000	3.50	11.225	8.42	88.1	0.0	356.1
50.00		1.00	1.09	9.576	10.53	199.05	0.750	0.000	1.50	4.834	3.63	38.2	0.0	304.7
53.25	Top - Section 1	1.00	1.11	9.704	10.67	198.16	0.750	0.000	3.25	10.390	7.79	83.2	0.0	654.9
55.00		1.00	1.12	9.770	10.75	200.33	0.750	0.000	1.75	5.548	4.16	44.7	0.0	176.0
60.00		1.00	1.14	9.951	10.95	198.73	0.750	0.000	5.00	15.669	11.75	128.6	0.0	497.1
65.00		1.00	1.16	10.120	11.13	196.94	0.750	0.000	5.00	15.400	11.55	128.6	0.0	488.5
70.00		1.00	1.17	10.279	11.31	194.98	0.750	0.000	5.00	15.130	11.35	128.3	0.0	479.9
75.00		1.00	1.19	10.430	11.47	192.88	0.750	0.000	5.00	14.861	11.15	127.9	0.0	471.3
80.00		1.00	1.21	10.572	11.63	190.64	0.750	0.000	5.00	14.592	10.94	127.3	0.0	462.7
85.00		1.00	1.22	10.708	11.78	188.29	0.750	0.000	5.00	14.323	10.74	126.5	0.0	454.1
90.00		1.00	1.24	10.838	11.92	185.83	0.750	0.000	5.00	14.054	10.54	125.7	0.0	445.5
95.00		1.00	1.25	10.962	12.06	183.28	0.750	0.000	5.00	13.784	10.34	124.7	0.0	436.9
98.00	Bot - Section 3	1.00	1.26	11.034	12.14	181.70	0.750	0.000	3.00	8.141	6.11	74.1	0.0	258.0
100.00		1.00	1.27	11.081	12.19	180.64	0.750	0.000	2.00	5.459	4.09	49.9	0.0	343.3
102.00	Top - Section 2	1.00	1.27	11.127	12.24	179.56	0.750	0.000	2.00	5.416	4.06	49.7	0.0	340.5
105.00		1.00	1.28	11.195	12.31	180.80	0.750	0.000	3.00	8.043	6.03	74.3	0.0	254.8
110.00		1.00	1.29	11.305	12.44	178.01	0.750	0.000	5.00	13.189	9.89	123.0	0.0	417.9
115.00		1.00	1.30	11.412	12.55	175.16	0.750	0.000	5.00	12.920	9.69	121.6	0.0	409.3
115.75	Top - Section 3	1.00	1.31	11.427	12.57	174.73	0.750	0.000	0.75	1.915	1.44	18.1	0.0	60.6
120.00		1.00	1.32	11.514	12.67	45.87	0.837	0.000	4.25	2.833	2.37	30.0	0.0	318.0
122.00	Appurtenance(s)	1.00	1.32	11.554	12.71	45.95	0.836	0.000	2.00	1.333	1.11	14.2	0.0	149.7
125.00		1.00	1.33	11.614	12.78	46.07	0.834	0.000	3.00	2.000	1.67	21.3	0.0	224.5
125.50	Appurtenance(s)	1.00	1.33	11.623	12.79	46.09	0.833	0.000	0.50	0.333	0.28	3.6	0.0	37.4
127.00	Appurtenance(s)	1.00	1.33	11.653	12.82	46.15	0.832	0.000	1.50	1.000	0.83	10.7	0.0	112.2
129.00	Appurtenance(s)	1.00	1.34	11.691	12.86	46.22	0.831	0.000	2.00	1.333	1.11	14.2	0.0	149.7
130.00		1.00	1.34	11.710	12.88	46.26	0.830	0.000	1.00	0.667	0.55	7.1	0.0	74.8
135.00		1.00	1.35	11.803	12.98	46.44	0.827	0.000	5.00	3.333	2.76	35.8	0.0	374.2
135.25	Top - Section 4	1.00	1.35	11.808	12.99	46.45	0.827	0.000	0.25	0.167	0.14	1.8	0.0	18.7
139.00	Appurtenance(s)	1.00	1.36	11.876	13.06	29.12	1.200	0.000	3.75	1.563	1.88	24.5	0.0	109.6
140.00		1.00	1.36	11.894	13.08	29.14	1.200	0.000	1.00	0.417	0.50	6.5	0.0	29.2
145.00		1.00	1.37	11.982	13.18	29.25	1.200	0.000	5.00	2.083	2.50	33.0	0.0	146.2
145.12	Appurtenance(s)	1.00	1.37	11.984	13.18	29.25	1.200	0.000	0.12	0.050	0.06	0.8	0.0	3.5
150.00	Appurtenance(s)	1.00	1.38	12.068	13.27	29.35	1.200	0.000	4.88	2.033	2.44	32.4	0.0	142.6
155.00	Appurtenance(s)	1.00	1.39	12.152	13.37	29.45	1.200	0.000	5.00	2.083	2.50	33.4	0.0	146.2
Totals:								155.00			3,113.6	14,302.3		

Discrete Appurtenance Forces


Structure: CT46141-A-SBA	Code: EIA/TIA-222-G	2/16/2018
Site Name: Water Treatment Plant 2, CT	Exposure: C	
Height: 155.00 (ft)	Crest Height: 0.00	
Base Elev: 0.000 (ft)	Site Class: B - Competent Rock	
Gh: 1.1	Topography: 1	Struct Class: II



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Load Case: 1.0D + 1.0W 60 mph Wind

Dead Load Factor 1.00
Wind Load Factor 1.00

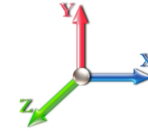

Iterations 29

No.	Elev (ft)	Description	Qty	qz (psf)	qzGh (psf)	CaAa x Ka	Ka	Total CaAa (sf)	Dead Load (lb)	Horiz Ecc (ft)	Vert Ecc (ft)	Wind FX (lb)	Mom Y (lb-ft)	Mom Z (lb-ft)
1	155.00	Truck Ball	1	12.152	13.367	1.00	1.00	3.77	50.00	0.000	0.000	50.39	0.00	0.00
2	155.00	Flag (20'x30')	1	12.152	13.367	1.00	1.00	14.56	200.00	0.000	0.000	194.62	0.00	0.00
3	155.00	27" Canister	1	12.152	13.367	1.00	1.00	5.07	50.00	0.000	0.000	67.77	0.00	0.00
4	150.00	RFS ACU-A20-N	4	12.068	13.275	1.00	1.00	0.00	4.00	0.000	0.000	0.00	0.00	0.00
5	150.00	CCI DPO-7126Y-0-T1	3	12.068	13.275	1.00	1.00	0.00	21.90	0.000	0.000	0.00	0.00	0.00
6	150.00	RFS	3	12.068	13.275	1.00	1.00	0.00	19.50	0.000	0.000	0.00	0.00	0.00
7	150.00	Commscope	3	12.068	13.275	1.00	1.00	0.00	136.20	0.000	0.000	0.00	0.00	0.00
8	145.12	27" Canister & 36"	1	11.984	13.183	1.00	1.00	12.37	100.00	0.000	0.000	163.07	0.00	0.00
9	139.00	DBC0062F3V52-1	6	11.876	13.064	1.00	1.00	0.00	39.60	0.000	0.000	0.00	0.00	0.00
10	139.00	DTMABP0723VG12A	6	11.876	13.064	1.00	1.00	0.00	115.20	0.000	0.000	0.00	0.00	0.00
11	139.00	TPA-65R-LCUUUU-H8	3	11.876	13.064	1.00	1.00	0.00	225.00	0.000	0.000	0.00	0.00	0.00
12	135.25	36" Canister & 29"	1	11.808	12.989	1.00	1.00	12.55	100.00	0.000	0.000	163.01	0.00	0.00
13	129.00	APX18-206517S-C-A20	3	11.691	12.860	1.00	1.00	0.00	72.60	0.000	0.000	0.00	0.00	0.00
14	127.00	CBC721-DF	6	11.653	12.818	1.00	1.00	0.00	26.40	0.000	0.000	0.00	0.00	0.00
15	125.50	29" Canister & 30"	1	11.623	12.786	1.00	1.00	10.75	100.00	0.000	0.000	137.45	0.00	0.00
16	122.00	SBNHH-1D6565A	3	11.554	12.710	1.00	1.00	0.00	142.20	0.000	0.000	0.00	0.00	0.00
17	115.75	30" Canister	1	11.427	12.570	1.00	1.00	5.50	50.00	0.000	0.000	69.13	0.00	0.00

Totals: 1,452.60

845.45

Total Applied Force Summary


Structure: CT46141-A-SBA	Code: EIA/TIA-222-G	2/16/2018
Site Name: Water Treatment Plant 2, CT	Exposure: C	
Height: 155.00 (ft)	Crest Height: 0.00	
Base Elev: 0.000 (ft)	Site Class: B - Competent Rock	
Gh: 1.1	Topography: 1	Struct Class: II



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Load Case: 1.0D + 1.0W 60 mph Wind

Dead Load Factor 1.00
Wind Load Factor 1.00

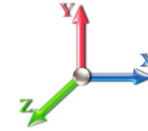

Iterations 29

Elev (ft)	Description	Lateral FX (-) (lb)	Axial FY (-) (lb)	Torsion MY (lb-ft)	Moment MZ (lb-ft)
0.00		0.00	0.00	0.00	0.00
5.00		113.08	772.95	0.00	0.00
10.00		111.42	764.35	0.00	0.00
15.00		109.77	755.75	0.00	0.00
20.00		114.72	747.15	0.00	0.00
25.00		118.40	738.56	0.00	0.00
30.00		121.12	729.96	0.00	0.00
35.00		123.14	721.36	0.00	0.00
40.00		124.62	712.76	0.00	0.00
45.00		125.67	704.16	0.00	0.00
48.50		88.11	487.80	0.00	0.00
50.00		38.19	361.14	0.00	0.00
53.25		83.18	777.16	0.00	0.00
55.00		44.72	241.83	0.00	0.00
60.00		128.63	685.15	0.00	0.00
65.00		128.57	676.55	0.00	0.00
70.00		128.31	667.95	0.00	0.00
75.00		127.87	659.36	0.00	0.00
80.00		127.27	650.76	0.00	0.00
85.00		126.53	642.16	0.00	0.00
90.00		125.65	633.56	0.00	0.00
95.00		124.66	624.96	0.00	0.00
98.00		74.11	370.85	0.00	0.00
100.00		49.90	418.50	0.00	0.00
102.00		49.71	415.75	0.00	0.00
105.00		74.28	367.70	0.00	0.00
110.00		123.01	605.95	0.00	0.00
115.00		121.64	597.35	0.00	0.00
115.75	(1) attachments	87.19	138.86	0.00	0.00
120.00		30.04	477.92	0.00	0.00
122.00	(3) attachments	14.16	367.10	0.00	0.00
125.00		21.30	299.91	0.00	0.00
125.50	(1) attachments	141.00	149.99	0.00	0.00
127.00	(6) attachments	10.67	176.36	0.00	0.00
129.00	(3) attachments	14.24	272.54	0.00	0.00
130.00		7.13	93.73	0.00	0.00
135.00		35.78	468.65	0.00	0.00
135.25	(1) attachments	164.80	123.43	0.00	0.00
139.00	(15) attachments	24.49	560.29	0.00	0.00
140.00		6.54	41.89	0.00	0.00
145.00		32.95	209.45	0.00	0.00
145.12	(1) attachments	163.86	105.03	0.00	0.00
150.00	(13) attachments	32.39	386.03	0.00	0.00
155.00	(3) attachments	346.20	446.15	0.00	0.00
	Totals:	3,959.06	20,848.83	0.00	0.00

Calculated Forces


Structure: CT46141-A-SBA	Code: EIA/TIA-222-G	2/16/2018
Site Name: Water Treatment Plant 2, CT	Exposure: C	
Height: 155.00 (ft)	Crest Height: 0.00	
Base Elev: 0.000 (ft)	Site Class: B - Competent Rock	
Gh: 1.1	Topography: 1	Struct Class: II



Page: 29

Load Case: 1.0D + 1.0W 60 mph Wind

Dead Load Factor 1.00
Wind Load Factor 1.00

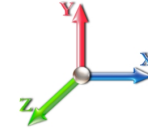

Iterations 29

Seg Elev (ft)	Pu FY (-) (kips)	Vu FX (-) (kips)	Tu MY (-) (ft-kips)	Mu MZ (ft-kips)	Mu MX (ft-kips)	Resultant Moment (ft-kips)	phi Pn (kips)	phi Vn (kips)	phi Tn (ft-kips)	phi Mn (ft-kips)	Total Deflect (in)	Rotation Sway (deg)	Rotation Twist (deg)	Stress Ratio
0.00	-20.85	-3.97	0.00	-343.00	0.00	343.00	2027.49	1013.74	3641.02	1807.56	0.00	0.000	0.000	0.200
5.00	-20.07	-3.88	0.00	-323.16	0.00	323.16	2015.42	1007.71	3566.22	1770.42	0.03	-0.057	0.000	0.193
10.00	-19.30	-3.78	0.00	-303.78	0.00	303.78	2002.83	1001.41	3491.15	1733.15	0.12	-0.114	0.000	0.185
15.00	-18.54	-3.69	0.00	-284.87	0.00	284.87	1989.72	994.86	3415.85	1695.77	0.27	-0.169	0.000	0.177
20.00	-17.79	-3.59	0.00	-266.43	0.00	266.43	1976.09	988.05	3340.37	1658.30	0.48	-0.224	0.000	0.170
25.00	-17.05	-3.48	0.00	-248.50	0.00	248.50	1961.94	980.97	3264.74	1620.75	0.74	-0.277	0.000	0.162
30.00	-16.32	-3.37	0.00	-231.09	0.00	231.09	1947.28	973.64	3189.01	1583.16	1.06	-0.329	0.000	0.154
35.00	-15.60	-3.26	0.00	-214.24	0.00	214.24	1932.09	966.05	3113.21	1545.53	1.43	-0.379	0.000	0.147
40.00	-14.88	-3.14	0.00	-197.95	0.00	197.95	1916.39	958.20	3037.39	1507.89	1.85	-0.429	0.000	0.139
45.00	-14.18	-3.02	0.00	-182.26	0.00	182.26	1900.17	950.08	2961.59	1470.26	2.33	-0.476	0.000	0.131
48.50	-13.69	-2.93	0.00	-171.69	0.00	171.69	1888.50	944.25	2908.57	1443.94	2.69	-0.509	0.000	0.126
50.00	-13.33	-2.90	0.00	-167.29	0.00	167.29	1883.43	941.71	2885.86	1432.66	2.85	-0.523	0.000	0.124
53.25	-12.55	-2.81	0.00	-157.88	0.00	157.88	1885.78	942.89	2896.38	1437.89	3.22	-0.552	0.000	0.116
55.00	-12.31	-2.77	0.00	-152.97	0.00	152.97	1879.83	939.91	2869.89	1424.73	3.42	-0.567	0.000	0.114
60.00	-11.62	-2.64	0.00	-139.12	0.00	139.12	1862.46	931.23	2794.28	1387.20	4.04	-0.608	0.000	0.107
65.00	-10.94	-2.51	0.00	-125.92	0.00	125.92	1844.57	922.28	2718.82	1349.74	4.70	-0.647	0.000	0.099
70.00	-10.28	-2.38	0.00	-113.36	0.00	113.36	1826.16	913.08	2643.55	1312.37	5.40	-0.685	0.000	0.092
75.00	-9.62	-2.25	0.00	-101.44	0.00	101.44	1807.23	903.62	2568.52	1275.12	6.13	-0.720	0.000	0.085
80.00	-8.97	-2.12	0.00	-90.18	0.00	90.18	1787.79	893.89	2493.75	1238.00	6.90	-0.753	0.000	0.078
85.00	-8.32	-1.99	0.00	-79.57	0.00	79.57	1767.82	883.91	2419.31	1201.05	7.71	-0.784	0.000	0.071
90.00	-7.69	-1.86	0.00	-69.61	0.00	69.61	1747.34	873.67	2345.22	1164.27	8.55	-0.813	0.000	0.064
95.00	-7.07	-1.73	0.00	-60.31	0.00	60.31	1726.34	863.17	2271.53	1127.68	9.41	-0.840	0.000	0.058
98.00	-6.70	-1.65	0.00	-55.12	0.00	55.12	1713.49	856.74	2227.52	1105.83	9.94	-0.855	0.000	0.054
100.00	-6.28	-1.60	0.00	-51.82	0.00	51.82	1704.82	852.41	2198.27	1091.31	10.30	-0.864	0.000	0.051
102.00	-5.87	-1.54	0.00	-48.63	0.00	48.63	1713.25	856.63	2226.72	1105.44	10.67	-0.874	0.000	0.047
105.00	-5.50	-1.46	0.00	-44.00	0.00	44.00	1700.21	850.10	2182.88	1083.67	11.22	-0.887	0.000	0.044
110.00	-4.89	-1.33	0.00	-36.69	0.00	36.69	1678.06	839.03	2110.21	1047.60	12.16	-0.906	0.000	0.038
115.00	-4.30	-1.20	0.00	-30.03	0.00	30.03	1655.39	827.70	2038.07	1011.78	13.12	-0.922	0.000	0.032
115.75	-4.16	-1.11	0.00	-29.13	0.00	29.13	1651.95	825.97	2027.30	1006.43	13.26	-0.925	0.000	0.031
115.75	-4.16	-1.11	0.00	-29.13	0.00	29.13	930.23	465.11	237.26	173.90	13.26	-0.925	0.000	0.172
120.00	-3.68	-1.08	0.00	-24.40	0.00	24.40	930.23	465.11	237.26	173.90	14.09	-0.937	0.000	0.144
122.00	-3.31	-1.06	0.00	-22.24	0.00	22.24	930.23	465.11	237.26	173.90	14.51	-1.035	0.000	0.131
125.00	-3.01	-1.04	0.00	-19.05	0.00	19.05	930.23	465.11	237.26	173.90	15.20	-1.166	0.000	0.113
125.50	-2.87	-0.90	0.00	-18.52	0.00	18.52	930.23	465.11	237.26	173.90	15.32	-1.186	0.000	0.110
127.00	-2.69	-0.89	0.00	-17.18	0.00	17.18	930.23	465.11	237.26	173.90	15.70	-1.243	0.000	0.102
129.00	-2.42	-0.87	0.00	-15.40	0.00	15.40	930.23	465.11	237.26	173.90	16.24	-1.311	0.000	0.091
130.00	-2.32	-0.86	0.00	-14.53	0.00	14.53	930.23	465.11	237.26	173.90	16.52	-1.343	0.000	0.086
135.00	-1.85	-0.82	0.00	-10.21	0.00	10.21	930.23	465.11	237.26	173.90	18.00	-1.473	0.000	0.061
135.25	-1.73	-0.65	0.00	-10.00	0.00	10.00	930.23	465.11	237.26	173.90	18.07	-1.479	0.000	0.059
135.25	-1.73	-0.65	0.00	-10.00	0.00	10.00	579.84	289.92	92.43	67.75	18.07	-1.479	0.000	0.151
139.00	-1.17	-0.61	0.00	-7.56	0.00	7.56	579.84	289.92	92.43	67.75	19.26	-1.548	0.000	0.114
140.00	-1.13	-0.61	0.00	-6.94	0.00	6.94	579.84	289.92	92.43	67.75	19.60	-1.649	0.000	0.104
145.00	-0.92	-0.58	0.00	-3.88	0.00	3.88	579.84	289.92	92.43	67.75	21.54	-2.023	0.000	0.059
145.12	-0.82	-0.41	0.00	-3.81	0.00	3.81	579.84	289.92	92.43	67.75	21.59	-2.029	0.000	0.058
150.00	-0.43	-0.36	0.00	-1.82	0.00	1.82	579.84	289.92	92.43	67.75	23.77	-2.219	0.000	0.028
155.00	0.00	-0.35	0.00	0.00	0.00	0.00	579.84	289.92	92.43	67.75	26.14	-2.282	0.000	0.000

Final Analysis Summary

Structure: CT46141-A-SBA	Code: EIA/TIA-222-G	2/16/2018
Site Name: Water Treatment Plant 2, CT	Exposure: C	
Height: 155.00 (ft)	Crest Height: 0.00	
Base Elev: 0.000 (ft)	Site Class: B - Competent Rock	
Gh: 1.1	Topography: 1	Struct Class: II



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Reactions

Load Case	Shear FX (kips)	Shear FZ (kips)	Axial FY (kips)	Moment MX (ft-kips)	Moment MY (ft-kips)	Moment MZ (ft-kips)
1.2D + 1.6W 97 mph Wind	16.3	0.00	24.98	0.00	0.00	1395.46
0.9D + 1.6W 97 mph Wind	16.3	0.00	18.73	0.00	0.00	1378.91
1.2D + 1.0Di + 1.0Wi 50 mph Wind	5.3	0.00	40.54	0.00	0.00	490.15
1.2D + 1.0E	0.4	0.00	25.02	0.00	0.00	37.62
0.9D + 1.0E	0.4	0.00	18.76	0.00	0.00	37.12
1.0D + 1.0W 60 mph Wind	4.0	0.00	20.85	0.00	0.00	343.00

Max Stresses

Load Case	Pu FY (-) (kips)	Vu FX (-) (kips)	Tu MY (-) (ft-kips)	Mu MZ (ft-kips)	Mu MX (ft-kips)	Resultant Moment (ft-kips)	phi Pn (kips)	phi Vn (kips)	phi Tn (ft-kips)	phi Mn (ft-kips)	Elev (ft)	Stress Ratio
1.2D + 1.6W 97 mph Wind	-24.98	-16.27	0.00	-1395.4	0.00	-1395.4	2027.49	1013.7	3641.02	1807.56	0.00	0.785
0.9D + 1.6W 97 mph Wind	-18.73	-16.26	0.00	-1378.9	0.00	-1378.9	2027.49	1013.7	3641.02	1807.56	0.00	0.772
1.2D + 1.0Di + 1.0Wi 50 mph Wind	-40.54	-5.27	0.00	-490.15	0.00	-490.15	2027.49	1013.7	3641.02	1807.56	0.00	0.291
1.2D + 1.0E	-5.01	-0.20	0.00	-6.29	0.00	-6.29	1651.95	825.97	2027.30	1006.43	115.75	0.042
0.9D + 1.0E	-3.76	-0.20	0.00	-6.20	0.00	-6.20	1651.95	825.97	2027.30	1006.43	115.75	0.040
1.0D + 1.0W 60 mph Wind	-20.85	-3.97	0.00	-343.00	0.00	-343.00	2027.49	1013.7	3641.02	1807.56	0.00	0.200



Pier Foundation Design For Monopole			Date
			2/16/2018
Customer Name:	Sprint Nextel	EIA/TIA Standard:	EIA-222-G
Site Name:		Structure Height (Ft.):	155
Site Number:	CT46141-A-SBA	Engineer Name:	J. Tibbetts
Engr. Number:	47578	Engineer Login ID:	

Foundation Info Obtained from:

Drawings/Calculations Acceptable overstress () 5.0%

Structure Type:

Monopole

Analysis or Design?

Analysis

Base Reactions (Factored):

Axial Load (Kips):	25.0	Shear Force (Kips):	16.3
Uplift Force (Kips):	0.0	Moment (Kips-ft):	1395.5

Foundation Geometries:


Mods required -Yes/No ?:	No			ft.
Diameter of Pier (ft.):	6.0	Depth of Base B. G. S. :	29.0	ft.
Pier Height A. G. (ft.):	1.00			

Material Properties and Reabr Info:

Concrete Strength (psi):	4000	Steel Elastic Modulus:	29000	ksi
Vertical bar yield (ksi)	60	Tie steel yield strength:	60	ksi
Vertical Rebar Size #:	9	Tie / Stirrup Size #:	4	
Qty. of Vertical Rebars:	32	Tie Spacing:	12.0	in.
Concrete Cover (in.):	3	Concrete unit weight:	150.0	pcf

Soil Design Parameters:

Water Table B.G.S. (ft):	2.0	Unit weight of water:	62.4	psf
Ratio of Uplift/Axial Skin Friction:	1.0	Pullout failure Angle:	30	(°)
Skin Frictions are to be obtained from:	Soil Report			

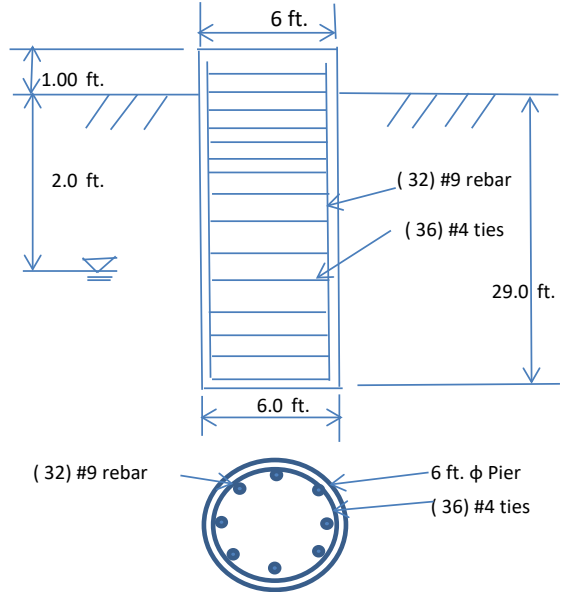

Monopole Pier Foundation

Depth of Layers (ft)		γ_{soil} (pcf)	ϕ (°)	Cohesion (psf)	Ultimate Skin Friction (psf)	Ultimate Bearing (psf)	Soil Types				
Top	Bottom										
0.0	3.0	130	0	0			Sand				
3.0	30.0	130	34	0			Sand				
30.0	35.0	130									

Soil weight Increase Factor for bouyant soils (1.0 to 1.15): 1.1

Foundation Analysis and Design:

Uplift Strength Reduction Factor:	0.75	Soil Bearing Strength Reduction Factor:	0.75
Total Dry Soil Volume from Conical Failure (cu. Ft.):	2224	Dry Soil Weight from Conical Failure:	289 Kips
Total Buoyant Soil Volume from Conical Failure (cu. Ft.):	10837	Buoyant Soil Weight from Conical Failure (Kips):	944 Kips
Total Dry Concrete Volume (cu. Ft.):	85	Total Dry Concrete Weight:	12.7 Kips
Total Buoyant Concrete Volume (cu. Ft.):	763.4	Total Buoyant Concrete Weight:	66.87 Kips
Total Effective Concrete Weight (Kips):	79.6	Total Effective Soil Weight:	1233.0 Kips
Total Effective Vertical Load on Base (Kips):	30.7		

Check Soil Capacities:

Allowable Foundation Overturning Resistance (kips-ft.):	7490.5	>	Design Factored Moment (kips-ft):	1732	Usage	0.23	OK!
Factor of Safety of Passive Soil Resistance against Moment:	4.32	OK!					

Check the capacities of Reinforcing Concrete:

Strength reduction factor (Flexure and axial tension):	0.90	Strength reduction factor (Shear):	0.75
Strength reduction factor (Axial compression):	0.65	Wind Load Factor on Concrete Design:	1.00


Reinforcing Concrete Pier:

Vertical Steel Rebar Area (sq. in./each):	1.00	Tie / Stirrup Area (sq. in./each):	0.20	Usage		
Calculated Moment Capacity (Mn,Kips-Ft):	4465.7	>	Design Factored Moment (Mu, K-Ft):	1463.7	0.33	OK!
Calculated Shear Capacity (Kips):	818.1	>	Design Factored Shear (Kips):	129.6	0.16	OK!
Calculated Tension Capacity (Tn, Kips):	1728.0	>	Design Factored Tension (Tu Kips):	0.0	0.00	OK!
Calculated Compression Capacity (Pn, Kips):	7142	>	Design Factored Axial Load (Pu Kips):	25.0	0.00	OK!
Moment & Axial Strength Combination:	0.33	OK!	Max. Allowable Tie/Stirrup Spacing:	12.00	in.	
Pier Reinforcement Ratio:	0.008	Reinforcement Ratio is satisfied per ACI				



SPECIAL CONSTRUCTION NOTE:
 SPRINT WORK IS CONTINGENT ON THE FOLLOWING:
 * COMPLETION OF A GLOBAL STRUCTURAL STABILITY ANALYSIS.
 * COMPLETION OF AN ANTENNA/RRH MOUNT STRUCTURAL ASSESSMENT.
 * GC SHALL FURNISH, INSTALL AND COMPLETE ALL REQUIRED STRUCTURAL MODIFICATIONS AS INDICATED IN BEFORE-MENTIONED ANALYSIS AND ASSESSMENT.

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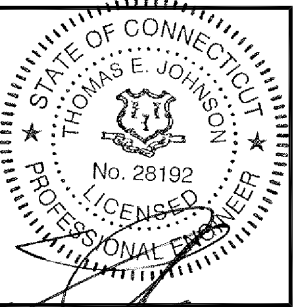
SITE NAME: WATER TREATMENT PLANT
SITE NUMBER: CT33XC579
AUGMENT ID: CT33XC579Q17.1
SITE ADDRESS: 1 WESTERBERG DRIVE
 FARMINGTON, CT 06032
JURISDICTION: TOWN OF FARMINGTON/ CT SITING COUNCIL
SITE TYPE: EXISTING 155' FLAGPOLE
PROGRAM: DO MACRO UPGRADE EQUIPMENT DEPLOYMENT

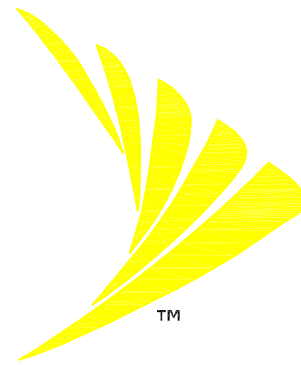1 INTERNATIONAL BLVD, SUITE 800
 MAHWAH, NJ 07495
 TEL: (800) 357-7641

SBA COMMUNICATIONS CORP.
 134 FLANDERS ROAD, SUITE 125
 WESTBOROUGH, MA 01581 TEL: (508) 251-0720

DESIGN GROUP, LLC

4 Bay Road, Building A
 Suite 200
 Hadley, MA 01035 Ph: (413)320-4918



CHECKED BY: 2-14-JMM/TEJ

APPROVED BY: JMM/TEJ

SUBMITTALS			
REV.	DATE	DESCRIPTION	BY
0	02/14/18	ISSUED FOR CONSTRUCTION	JEB

SITE NUMBER:
CT33XC579
 SITE NAME:
WATER TREATMENT PLANT
 SITE ADDRESS:
 1 WESTERBERG DRIVE
 FARMINGTON, CT 06032

SHEET TITLE
 TITLE SHEET

SHEET NUMBER
 T-1

PROJECT INFORMATION

SITE INFORMATION
 LATITUDE: 41° 43' 49.80" N (41.7305°)
 LONGITUDE: 72° 50' 07.80" W (-72.8355°)
 GROUND ELEVATION: 168'± AMSL (PER GOOGLE EARTH)
 STRUCTURE HEIGHT: 155'± AGL (FROM RECORD STRUCTURAL)
 STRUCTURE TYPE: FLAGPOLE
 ZONING JURISDICTION: TOWN OF FARMINGTON/ CT SITING COUNCIL
 ZONING DISTRICT/OCCUPANCY: R40 (RESIDENTIAL)
 COUNTY: HARTFORD

APPLICANT
 SPRINT
 1 INTERNATIONAL BLVD. SUITE 800
 MAHWAH, NJ 07495


PROPERTY OWNER:
 N/F STEPHEN G. & BARBARA L. BORRELLI
 1 WESTERBERG DRIVE
 FARMINGTON, CT 06032

TOWER OWNER:
 SBA 2012 TC ASSETS, LLC
 8051 CONGRESS AVENUE
 BOCA RATON, FL 33487
 (561) 995-7670

SBA SITE ID: CT46141-A
 SBA SITE NAME: WATER TREATMENT PLANT 2, CT

SBA CONTACT:
 STEPHEN ROTH
 (860) 539-4920
 SROth@sbsite.com

LOCATION MAP N.T.S.

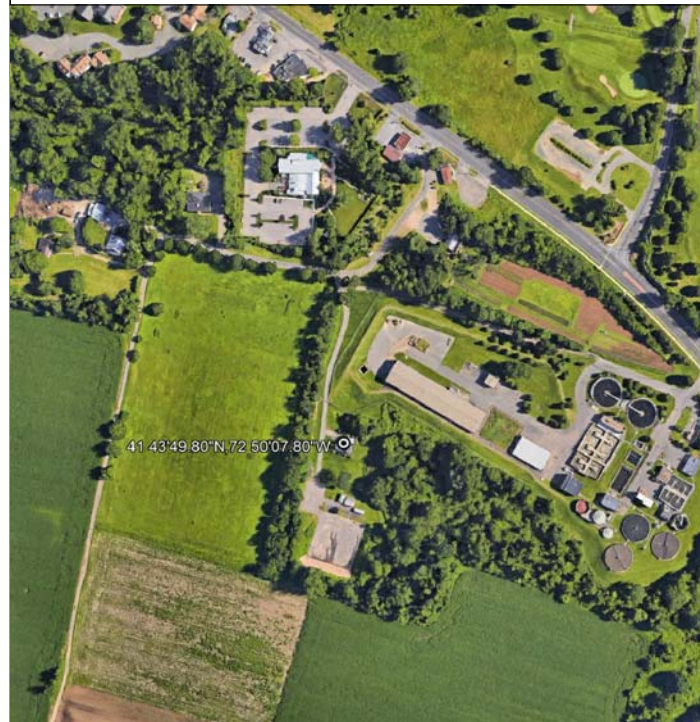

AREA MAP N.T.S.



SCOPE OF WORK

- REMOVE (3) EXISTING SPRINT PANEL ANTENNAS AND REPLACE WITH (3) NEW SPRINT PANEL ANTENNAS.
- INSTALL (3) NEW SPRINT 2500 MHz RRHS.
- INSTALL (6) NEW SPRINT 800 MHz RRHS.

GENERAL NOTES

- THIS IS AN UNMANNED TELECOMMUNICATION FACILITY AND NOT FOR HUMAN HABITATION:
 • ADA COMPLIANCE NOT REQUIRED.
 • POTABLE WATER OR SANITARY SERVICE IS NOT REQUIRED.
 • NO OUTDOOR STORAGE OR ANY SOLID WASTE RECEPTACLES REQUIRED.
- CONTRACTOR SHALL VERIFY ALL PLANS, EXISTING DIMENSIONS, AND CONDITIONS ON JOB SITE. CONTRACTOR SHALL IMMEDIATELY NOTIFY THE ARCHITECT/ENGINEER IN WRITING OF ANY DISCREPANCIES BEFORE PROCEEDING WITH THE WORK. FAILURE TO NOTIFY THE ARCHITECT/ENGINEER PLACE THE RESPONSIBILITY ON THE CONTRACTOR TO CORRECT THE DISCREPANCIES AT THE CONTRACTOR'S EXPENSE.

DRAWING INDEX

SHEET NO.	SHEET DESCRIPTION	REV. NO.
T-1	TITLE SHEET	0
SP-1	OUTLINE SPECIFICATIONS	0
SP-2	OUTLINE SPECIFICATIONS	0
SP-3	OUTLINE SPECIFICATIONS	0
A-1	COMPOUND PLAN	0
A-2	ELEVATION AND ANTENNA PLANS	0
A-3	TOWER EQUIPMENT DETAILS	0
S-1	ANTENNA MOUNTING DETAILS	0
S-2	RRH MOUNTING DETAILS	0
E-1	ELECTRICAL AND GROUNDING DETAILS	0
RF-1	RF DATA SHEET	0
RF-2	PLUMBING DIAGRAM AND RAN WIRING	0

CODE COMPLIANCE

- 2016 CONNECTICUT STATE BUILDING CODE WITH AMENDMENTS.
- 2014 NATIONAL ELECTRICAL CODE WITH AMENDMENTS
- TIA-EIA-222-G

BASED ON INFORMATION PROVIDED BY SPRINT, THIS TELECOMMUNICATIONS EQUIPMENT DEPLOYMENT IS CONSIDERED AN ELIGIBLE FACILITY UNDER THE TAX RELIEF ACT OF 2012, 47 USC 1455(A), AND IS SUBJECT TO AN EXPEDITED ELIGIBLE FACILITIES REQUEST/REVIEW AND ZONING PRE-EMPTION FOR LOCAL DISCRETIONARY PERMITS (VARIANCE, SPECIAL PERMIT, SITE PLAN REVIEW).

APPROVALS



TITLE	SIGNATURE	DATE
PROJECT MANAGER:		
CONSTRUCTION:		
RF ENGINEER:		
ZONING/SITE ACQ:		
OPERATIONS:		
TOWER OWNER:		

THE FOLLOWING PARTIES HEREBY APPROVE AND ACCEPT THESE DOCUMENTS AND AUTHORIZE THE CONTRACTOR TO PROCEED WITH THE CONSTRUCTION DESCRIBED HEREIN. ALL DOCUMENTS ARE SUBJECT TO REVIEW BY THE LOCAL BUILDING DEPARTMENT AND MAY IMPOSE CHANGES OR MODIFICATIONS.

CALL CONNECTICUT ONE CALL
 (800) 922-4455
 CALL 3 WORKING DAYS
 BEFORE YOU DIG!



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 Call before you dig.
 www.call811.com

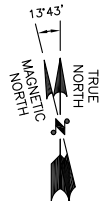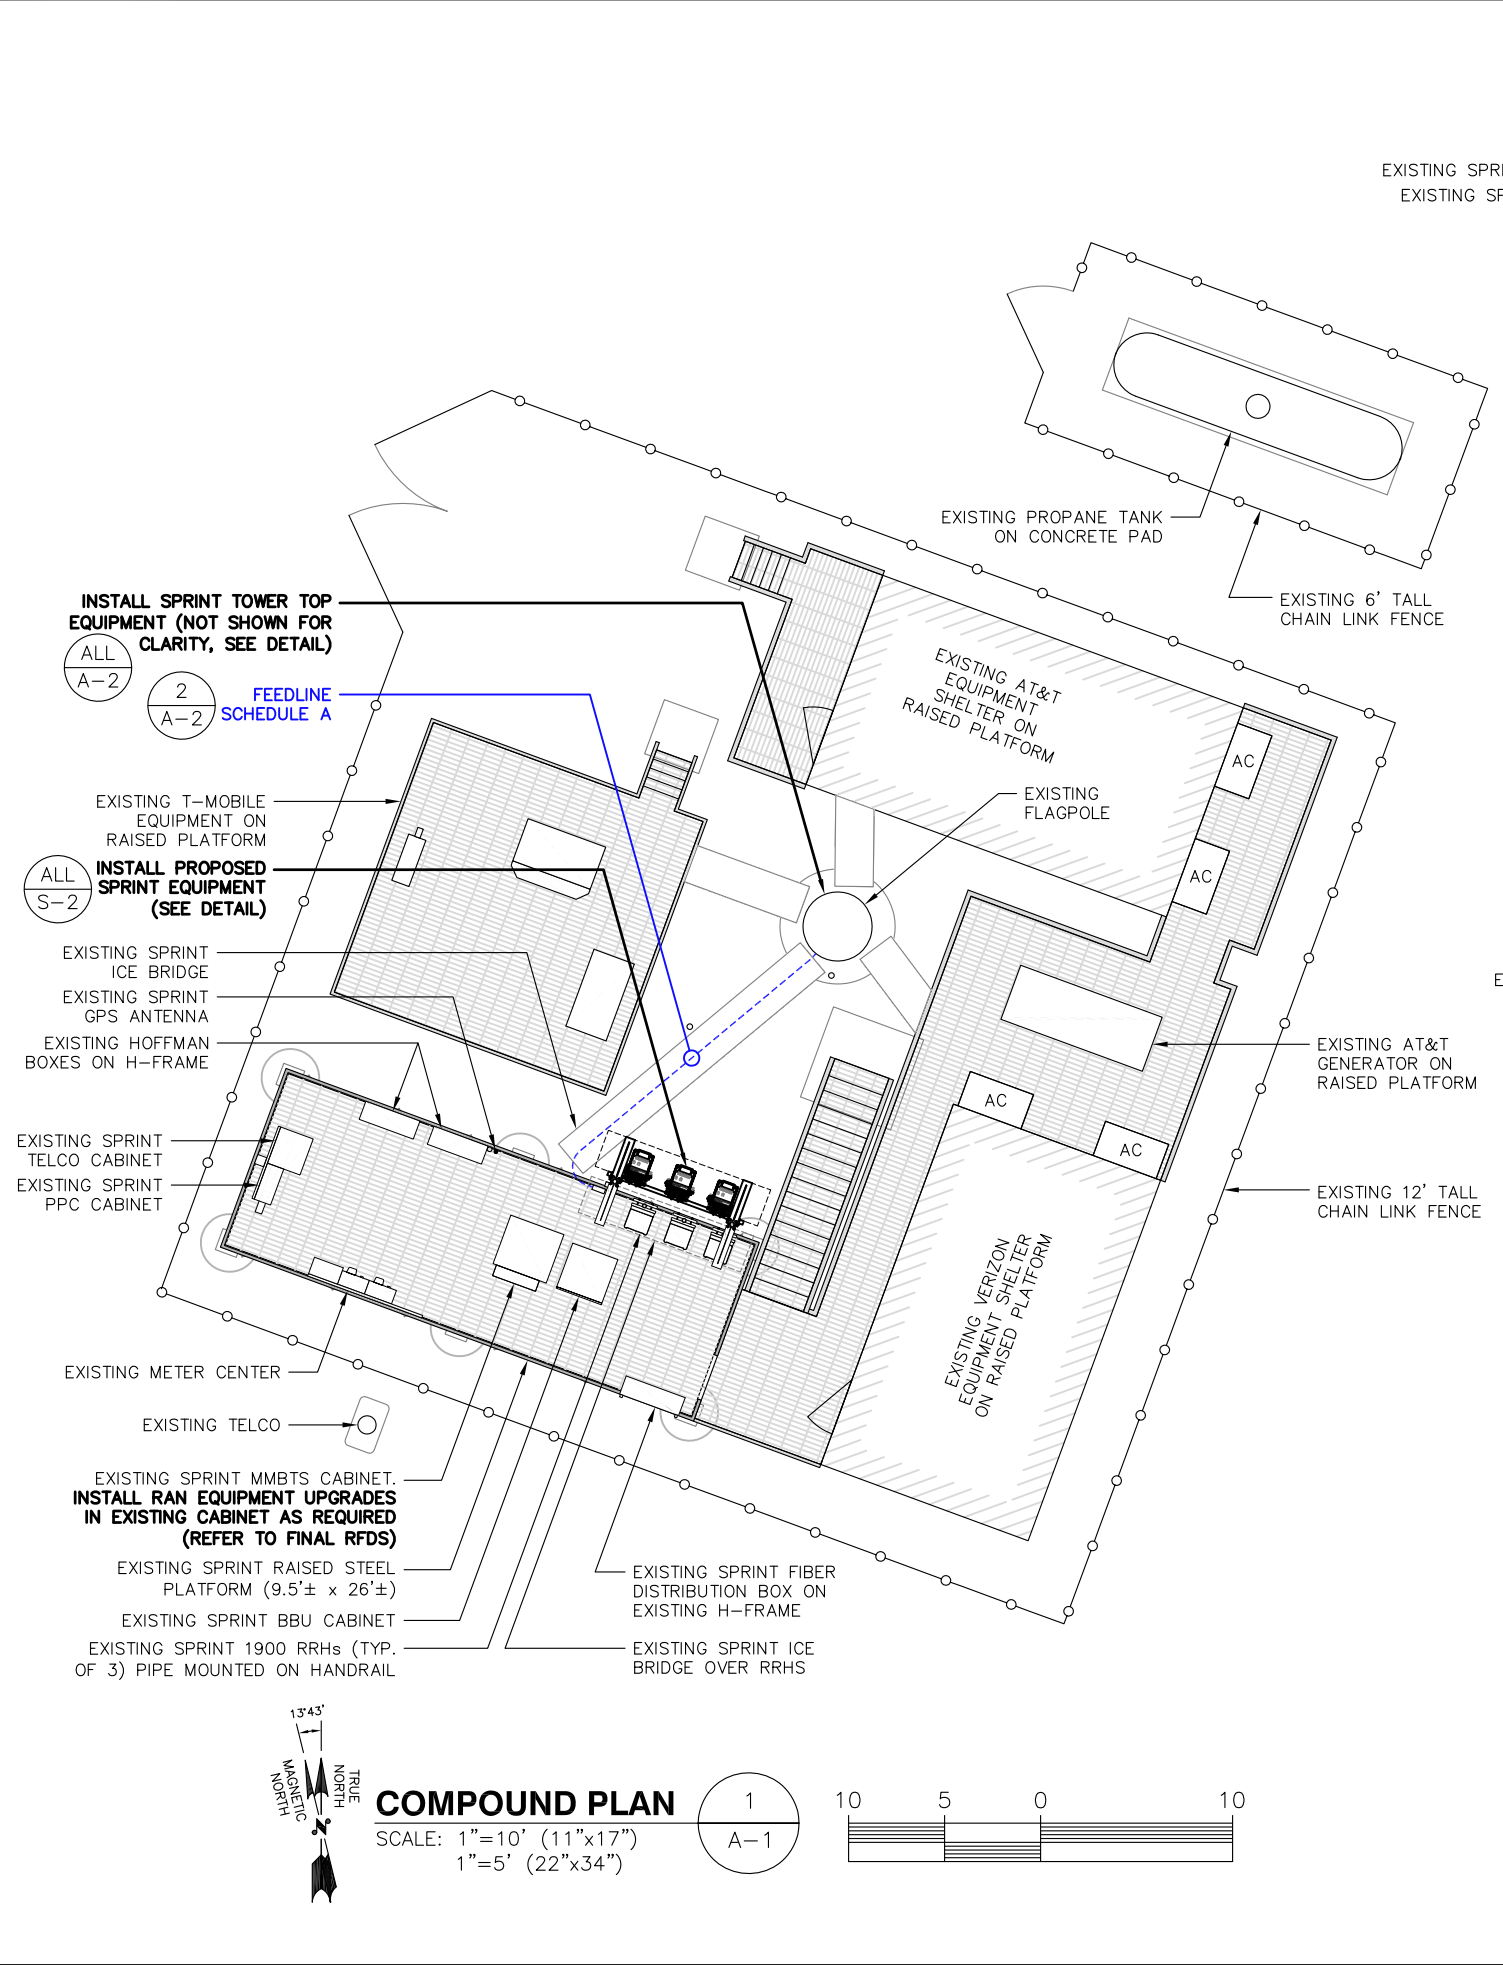

COMPOUND PLAN
 SCALE: 1"=10' (11"x17")
 1"=5' (22"x34")

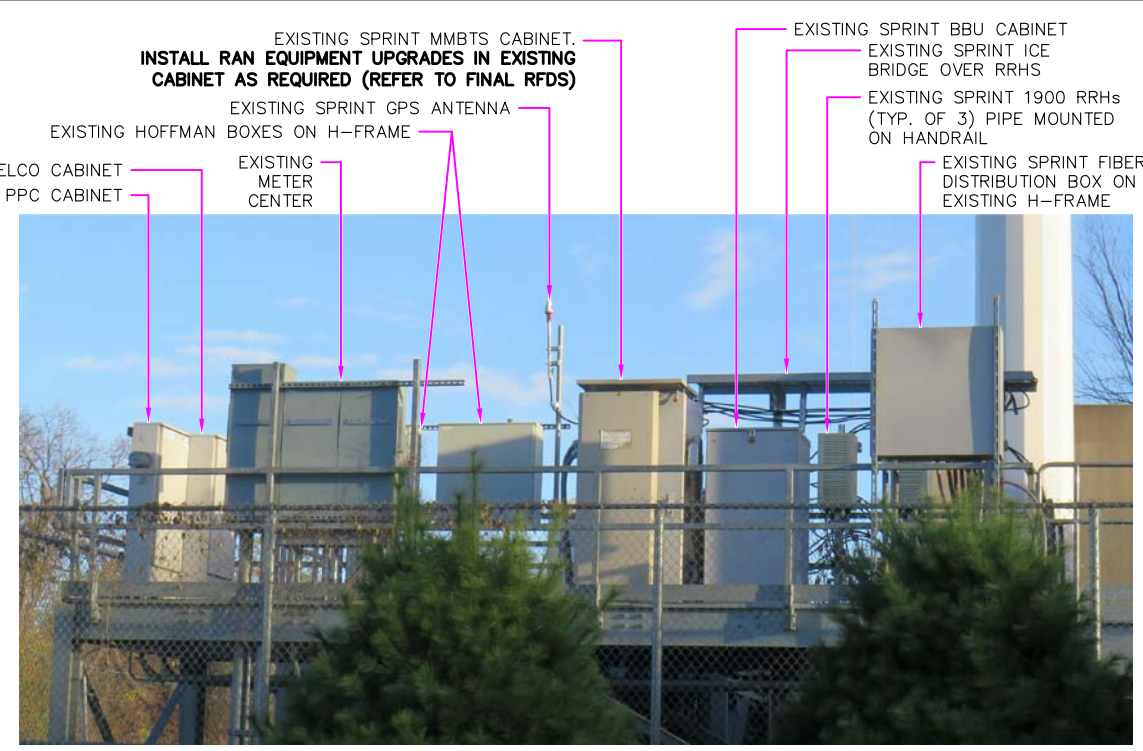
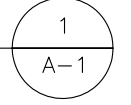


IMAGE SOURCE: PROTERRA 11/07/2017 (VIEW FROM SOUTHWEST)


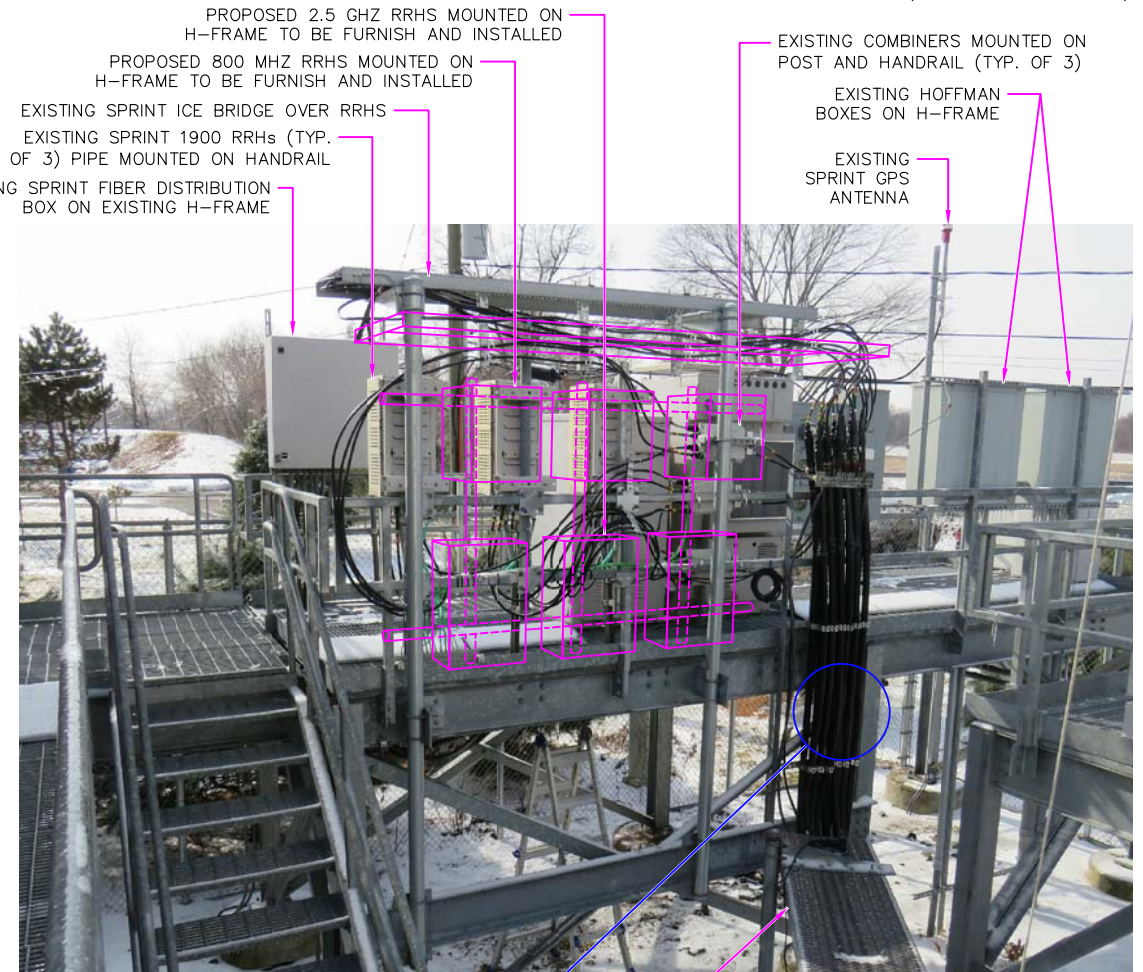


IMAGE SOURCE: PROTERRA 11/07/2017 (VIEW FROM NORTHEAST)



EQUIPMENT PLAN PHOTO DETAIL
 SCALE: N.T.S.

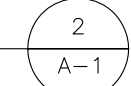

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 1 INTERNATIONAL BLVD, SUITE 800
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 WESTBOROUGH, MA 01581
 TEL: (508) 251-0720

ProTerra
 DESIGN GROUP, LLC
 4 Bay Road, Building A
 Suite 200
 Hadley, MA 01035 Ph: (413)320-4918

STATE OF CONNECTICUT
 THOMAS E. JOHNSON
 No. 28192
 LICENSED PROFESSIONAL ENGINEER

CHECKED BY: 2-14-JMM/TEJ

APPROVED BY: JMM/TEJ

SUBMITTALS			
REV.	DATE	DESCRIPTION	BY
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SITE NUMBER:
CT33XC579
 SITE NAME:
WATER TREATMENT PLANT
 SITE ADDRESS:
 1 WESTERBERG DRIVE
 FARMINGTON, CT 06032

SHEET TITLE
COMPOUND PLAN

SHEET NUMBER
A-1

TOP OF EXISTING FLAGPOLE
ELEV. = 155'± AGL
(SBA DATABASE,
RECORD STRUCTURAL)

CL OF EXISTING
SPRINT ANTENNAS
ELEV. = 150'± AGL
(SBA DATABASE,
RECORD STRUCTURAL)

ALL A-2 ALL A-3

CL OF EXISTING
SPRINT ANTENNAS
ELEV. = 150'± AGL
(SBA DATABASE,
RECORD STRUCTURAL)

ALL A-2 ALL A-3

EXISTING ANTENNAS
BEHIND SHROUD
(BY OTHERS, TYP.)

EXISTING
FLAGPOLE
FEEDLINE
SCHEDULE A

FEEDLINE
SCHEDULE A

NOTE:
GROUND EQUIPMENT NOT
SHOWN FOR CLARITY


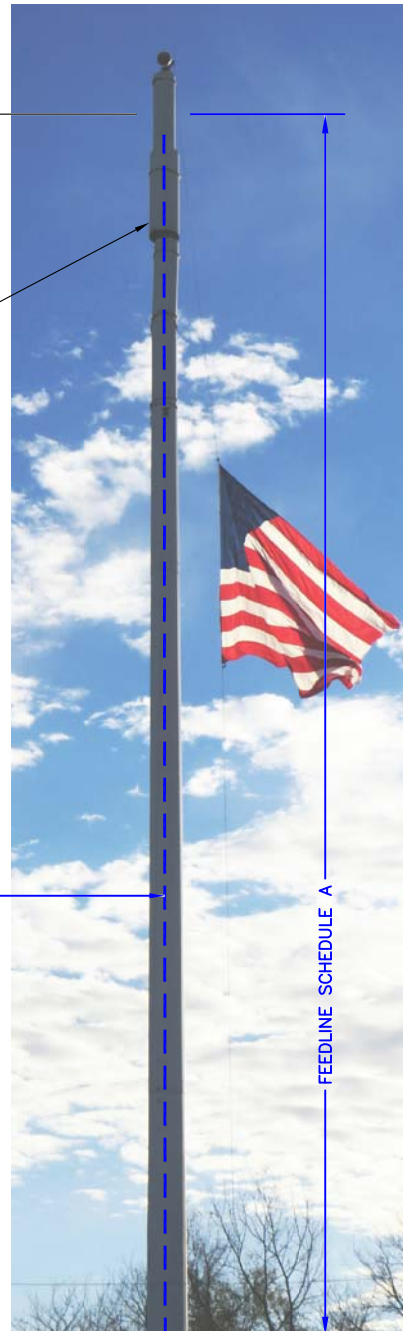


IMAGE SOURCE: PROTERRA 11/07/2017

GROUND ELEVATION
ELEV. = 0.0'± AGL

ELEVATION
SCALE: 1"=20' (11"x17")
1"=10' (22"x34")

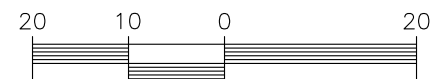

1
A-2

FEEDLINE SCHEDULE	FEEDLINE DESCRIPTION	LOCATION
A	EXISTING TO REMAIN: (12) 1/2" COAX TO 150' RAD, (6 ACTIVE, 6 UNUSED) EXISTING TO REMAIN: (3) 3/8" RET TO 150' RAD	UP INSIDE FLAGPOLE TO RAD

NOTE:
EXISTING SPRINT EQUIPMENT FEEDLINE INVENTORY BASED ON OBSERVED FIELD CONDITIONS.
RFDS AND FEEDLINE LEASING ENTITLEMENTS MAY DIFFER

TOWER ELEVATION PHOTO DETAIL
SCALE: N.T.S.

SPECIAL CONSTRUCTION NOTE:
SPRINT WORK IS CONTINGENT ON THE FOLLOWING:
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* COMPLETION OF AN ANTENNA/RRH MOUNT STRUCTURAL ASSESSMENT.
* GC SHALL FURNISH, INSTALL AND COMPLETE ALL REQUIRED STRUCTURAL MODIFICATIONS AS INDICATED IN BEFORE-MENTIONED ANALYSIS AND ASSESSMENT.

SPECIAL PRE-CONSTRUCTION WORK NOTE (SBA-PROVIDED TOWER STRUCTURAL ANALYSIS SPECIAL EQUIPMENT INSTALLATION REQUIREMENTS):
GENERAL CONTRACTOR SHALL FURNISH AND INSTALL ALL SPECIAL OR SUPPLEMENTAL ADDITIONAL TOWER-MOUNTED EQUIPMENT PER RECOMMENDATIONS FROM SBA-PROVIDED TOWER STRUCTURAL ANALYSIS FOR ANY SPECIAL SHIELDING OF TOWER TOP EQUIPMENT AND FOR ANY SPECIAL FEEDLINE BUNDLING OR RELOCATION.

SPECIAL WORK NOTE (EXISTING SBA-PROVIDED WINDBAND CLAMPS):
GENERAL CONTRACTOR SHALL FOLLOW MANUFACTURER'S INSTALLATION RECOMMENDATIONS AND USER MANUAL FOR UNFASTENING AND REFASTENING EXISTING SBA-PROVIDED WINDBAND CLAMPS. ANY DAMAGED CANISTER SHROUDS OR DAMAGED WINDBAND CLAMPS LOCATED AT THE SPRINT RAD SHALL BE REPLACED AT NO COST TO SBA.


EXISTING 27"± O.D. CANISTER SHROUD (V.I.F.)
EXISTING 5" O.D. MAST PIPE (V.I.F.)

GAMMA SECTOR 270°

ALPHA SECTOR 30°

REMOVE AND REPLACE EXISTING SPRINT ANTENNA (APXVSP18-C-A20), (TYP. OF 1 PER SECTOR, TOTAL OF 3)

EXISTING 5"Ø CABLE PORT IN CANISTER BASE PLATE (V.I.F.), (TYP. OF 6 PORTS)

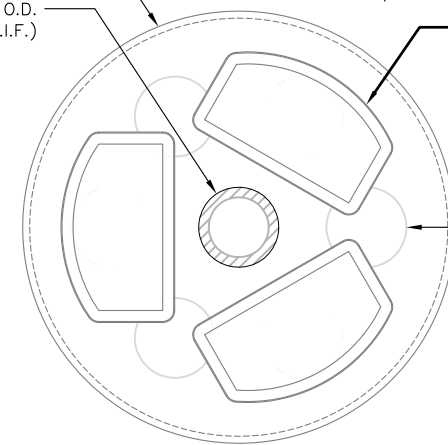

EXISTING ANTENNA PLAN
SCALE: N.T.S.

3
A-2


EXISTING 27"± O.D. CANISTER SHROUD (V.I.F.)
EXISTING 5" O.D. MAST PIPE (V.I.F.)

GAMMA SECTOR 270°

ALPHA SECTOR 30°

REMOVE AND REPLACE EXISTING SPRINT ANTENNA (DHHTT65B-3XR) MOUNTED TO EXISTING MAST PIPE, (TYP. OF 1 PER SECTOR, TOTAL OF 3)

EXISTING 5"Ø CABLE PORT IN CANISTER BASE PLATE (V.I.F.), (TYP. OF 6 PORTS)

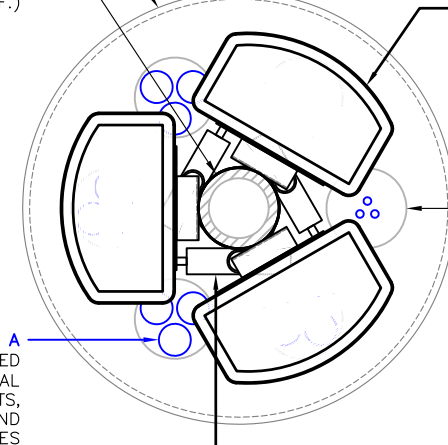

PROPOSED ANTENNA PLAN
SCALE: N.T.S.

4
A-2

FEEDLINE SCHEDULE A (REFER TO SBA PROVIDED STRUCTURAL ANALYSIS FOR SPECIAL CABLE INSTALLATION REQUIREMENTS, BUNDLING, SHIELDING, MOUNTING AND RELOCATION OF EXISTING CABLES)
INSTALL SPRINT DIPLEXERS (RFS FD9R6004) MOUNTED TO EXISTING MAST PIPE BELOW ANTENNAS, (TYP. OF 2 PER SECTOR, TOTAL OF 6)

NOTE:
VERIFY PROPOSED AZIMUTHS WITH RF ENGINEER PRIOR TO INSTALLATION

Sprint
1 INTERNATIONAL BLVD, SUITE 800
MAHWAH, NJ 07495
TEL: (800) 357-7641

SBA
SBA COMMUNICATIONS CORP.
134 FLANDERS ROAD, SUITE 125
WESTBOROUGH, MA 01581
TEL: (508) 251-0720

ProTerra
DESIGN GROUP, LLC
4 Bay Road, Building A
Suite 200
Hadley, MA 01035 Ph: (413)320-4918

STATE OF CONNECTICUT
THOMAS E. JOHNSON
No. 28192
LICENSED PROFESSIONAL ENGINEER

CHECKED BY: 2-14-JMM/TEJ

APPROVED BY: JMM/TEJ


SUBMITTALS

REV.	DATE	DESCRIPTION	BY
0	02/14/18	ISSUED FOR CONSTRUCTION	JEB

SITE NUMBER:
CT33XC579
SITE NAME:
WATER TREATMENT PLANT
SITE ADDRESS:
1 WESTERBERG DRIVE
FARMINGTON, CT 06032

SHEET TITLE
ELEVATION AND ANTENNA PLANS


SHEET NUMBER
A-2

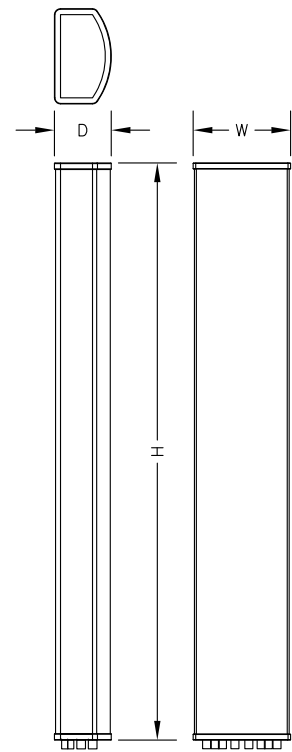

ANTENNA SPECIFICATIONS	
MANUF.	COMMSCOPE
MODEL #	DHHT65B-3XR
HEIGHT	72.1"
WIDTH	11.9"
DEPTH	7.1"
WEIGHT	45.4 ± LBS.

ANTENNA DETAIL
SCALE: N.T.S.


1
A-3

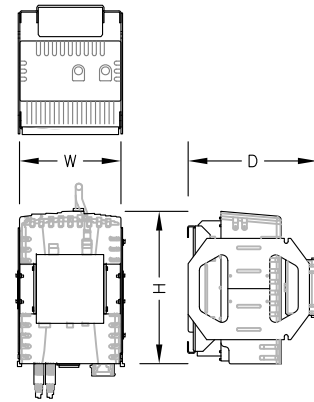

800 MHZ RRH SPECIFICATIONS	
MANUF.	NOKIA (ALU)
MODEL #	800MHZ 2X50W
HEIGHT	19.7"
WIDTH	13"
DEPTH	10.8"
WEIGHT	53± LBS

800 MHz RRH DETAIL
SCALE: N.T.S.


2
A-3

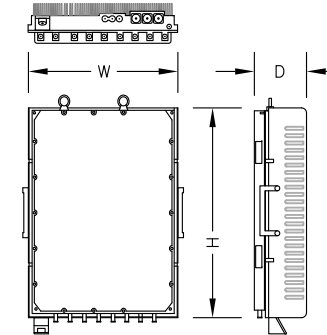

2.5 GHZ RRH SPECIFICATIONS	
MANUF.	NOKIA (ALU)
MODEL #	TD-RRH8X20-25
HEIGHT	26.1"
WIDTH	18.6"
DEPTH	6.7"
WEIGHT	70± LBS

2.5 GHz RRH DETAIL
SCALE: N.T.S.

3
A-3

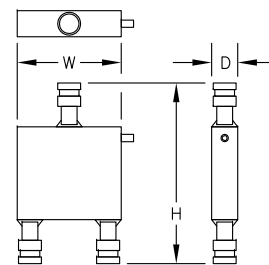

800/1900 MHZ DIPLEXER SPECIFICATIONS	
MANUF.	RFS
MODEL #	FD9R6004/1C-3L
HEIGHT	6.5"
WIDTH	5.8"
DEPTH	1.5"
WEIGHT	2.6 ± LBS

2.5 GHz RRH DETAIL
SCALE: N.T.S.

5
A-3

MAJOR RF EQUIPMENT LIST

(GC SHALL FURNISH AND INSTALL ALL OTHER MATERIALS AND EQUIPMENT NOT SUPPLIED BY SPRINT)

DESCRIPTION	QUANTITY	UNITS	MAKE/MODEL/MATERIAL	PROVIDED BY
ANTENNA	3	EA	COMMSCOPE DHHT65B-3XR	SPRINT
2500 RRH	3	EA	NOKIA (ALU) TD-RRH8x20-25	SPRINT
800 RRH	3	EA	NOKIA (ALU) 800MHZ 2x50W	SPRINT
DIPLEXER	6	EA	RFS FD9R6004/1C-3L	SPRINT

SPRINT-PROVIDED EQUIPMENT SCHEDULE
SCALE: N.T.S.

4
A-3

Sprint
1 INTERNATIONAL BLVD, SUITE 800
MAHWAH, NJ 07495
TEL: (800) 357-7641

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SBA COMMUNICATIONS CORP.
134 FLANDERS ROAD, SUITE 125
WESTBOROUGH, MA 01581
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STATE OF CONNECTICUT
THOMAS E. JOHNSON
No. 28192
LICENSED PROFESSIONAL ENGINEER

CHECKED BY: 2-14-JMM/TEJ


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CT33XC579
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SITE ADDRESS:
1 WESTERBERG DRIVE
FARMINGTON, CT 06032

SHEET TITLE
**TOWER EQUIPMENT
DETAILS**

SHEET NUMBER
A-3




PROPOSED ANTENNA PLAN
SCALE: N.T.S.

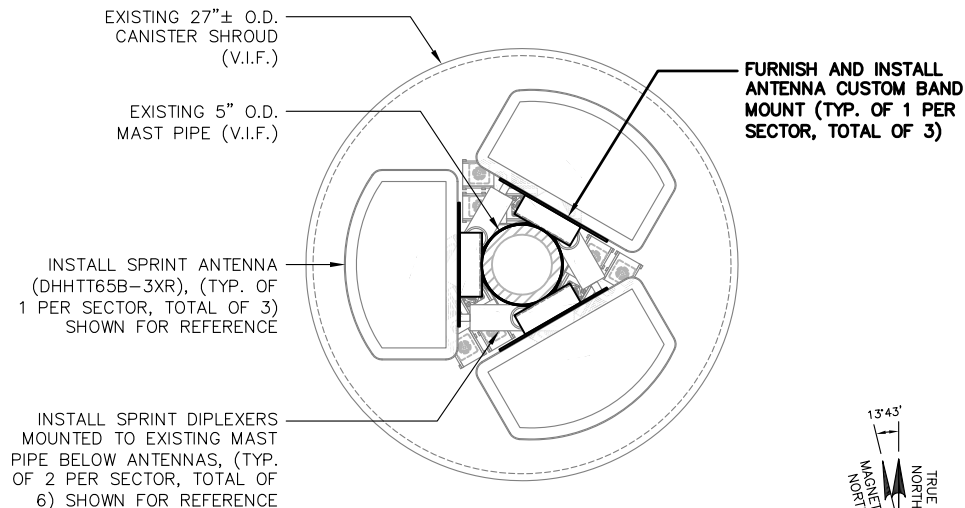
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SPECIAL WORK NOTE (EXISTING SBA-PROVIDED WINDBAND CLAMPS):
GENERAL CONTRACTOR SHALL FOLLOW MANUFACTURER'S INSTALLATION RECOMMENDATIONS AND USER MANUAL FOR UNFASTENING AND REFASTENING EXISTING SBA-PROVIDED WINDBAND CLAMPS. ANY DAMAGED CANISTER SHROUDS OR DAMAGED WINDBAND CLAMPS LOCATED AT THE SPRINT RAD SHALL BE REPLACED AT NO COST TO SBA.




ANTENNA MOUNT PHOTO DETAIL
SCALE: N.T.S.

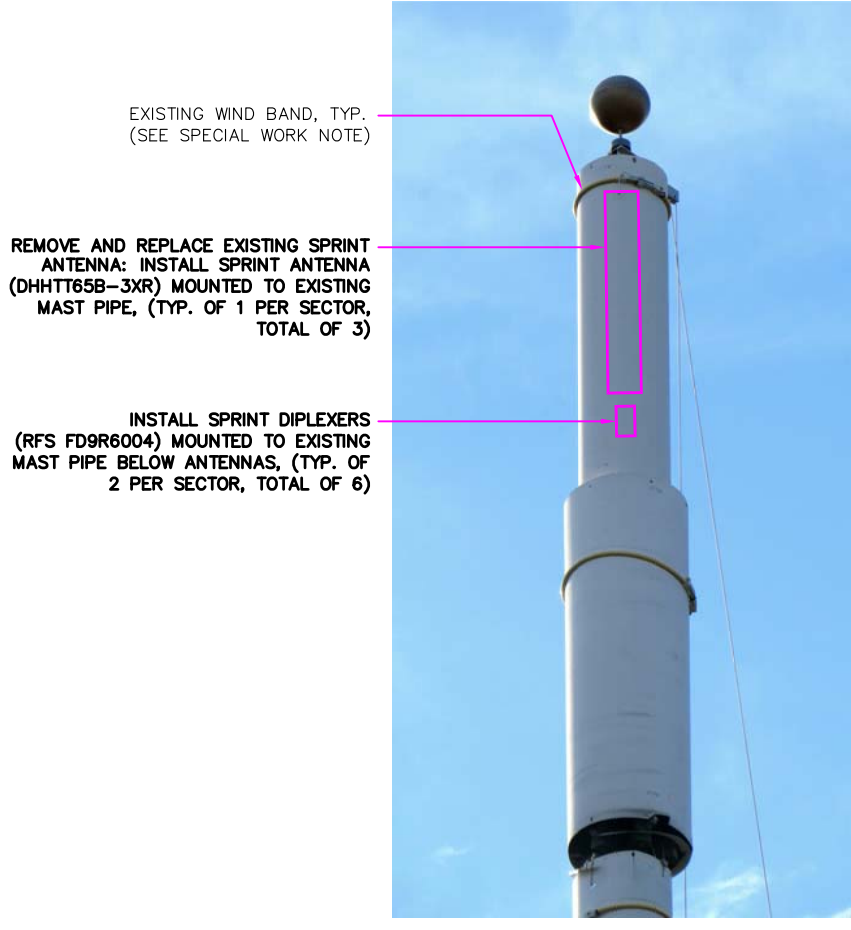


PROPOSED ANTENNA MOUNTING DETAIL
SCALE: N.T.S.

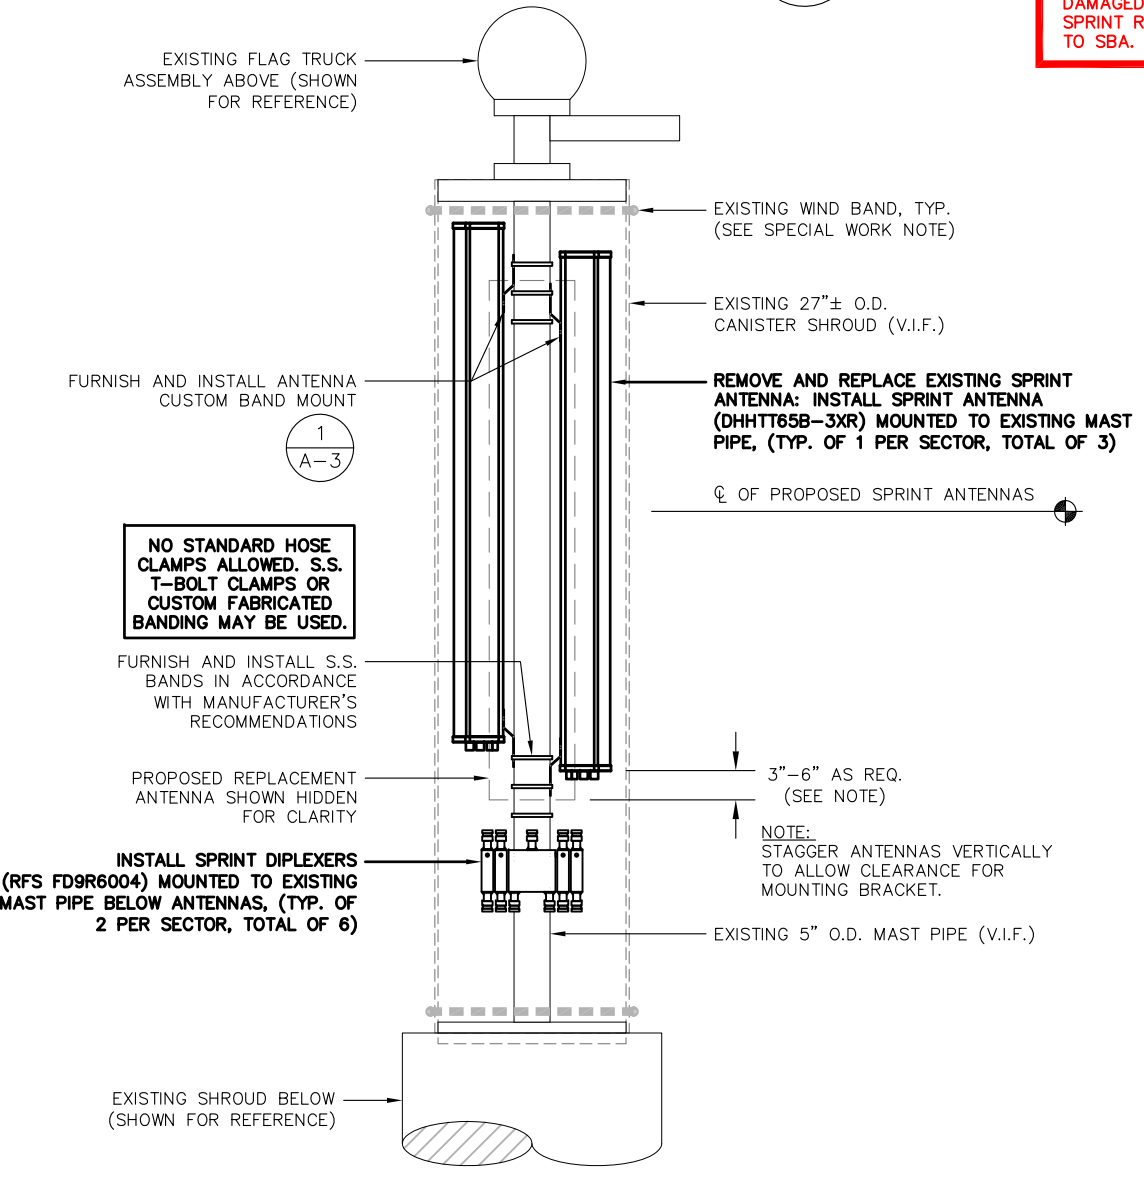NOTE:
CONTRACTOR IS TO V.I.F. DIMENSION OF BOLT SPACING ON BACK OF ANTENNA AND VERIFY OFFSETS REQUIRED. NOTIFY ENGINEER OF ANY DISCREPANCIES PRIOR TO INSTALLATION. ADJUST ANTENNA BANDING MOUNT AS REQUIRED PRIOR TO FABRICATION.

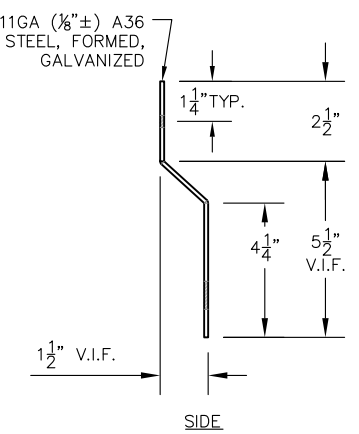

ANTENNA BANDING MOUNT
SCALE: N.T.S.

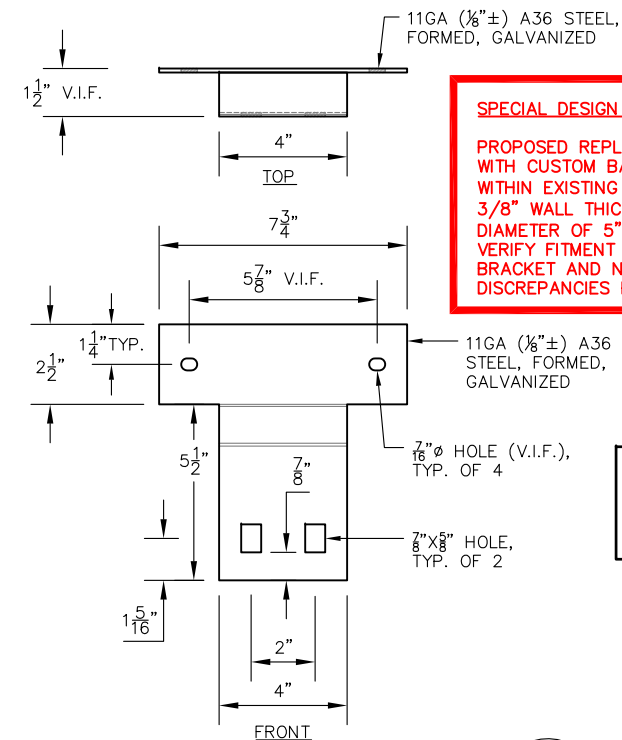

SPECIAL DESIGN NOTE:
PROPOSED REPLACEMENT ANTENNAS INSTALLED WITH CUSTOM BAND MOUNT DESIGNED TO FIT WITHIN EXISTING 27" O.D. SHROUD (WITH MAX. 3/8" WALL THICKNESS, V.I.F.) FOR PIPE MAST DIAMETER OF 5" O.D. CONTRACTOR SHALL VERIFY FITMENT OF ANTENNAS UTILIZING THIS BRACKET AND NOTIFY ENGINEER OF ANY DISCREPANCIES PRIOR TO INSTALLATION.

NO STANDARD HOSE CLAMPS ALLOWED. S.S. T-BOLT CLAMPS OR CUSTOM FABRICATED BANDING MAY BE USED.

Sprint
1 INTERNATIONAL BLVD, SUITE 800
MAHWAH, NJ 07495
TEL: (800) 357-7641

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SBA COMMUNICATIONS CORP.
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WESTBOROUGH, MA 01581
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STATE OF CONNECTICUT
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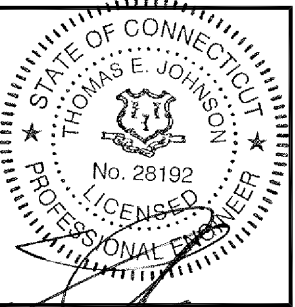
CHECKED BY: 2-14-JMM/TEJ
APPROVED BY: JMM/TEJ

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1 WESTERBERG DRIVE
FARMINGTON, CT 06032

SHEET TITLE
ANTENNA MOUNTING DETAILS

SHEET NUMBER
S-1



CHECKED BY: 2-14-JMM/TEJ

APPROVED BY: JMM/TEJ

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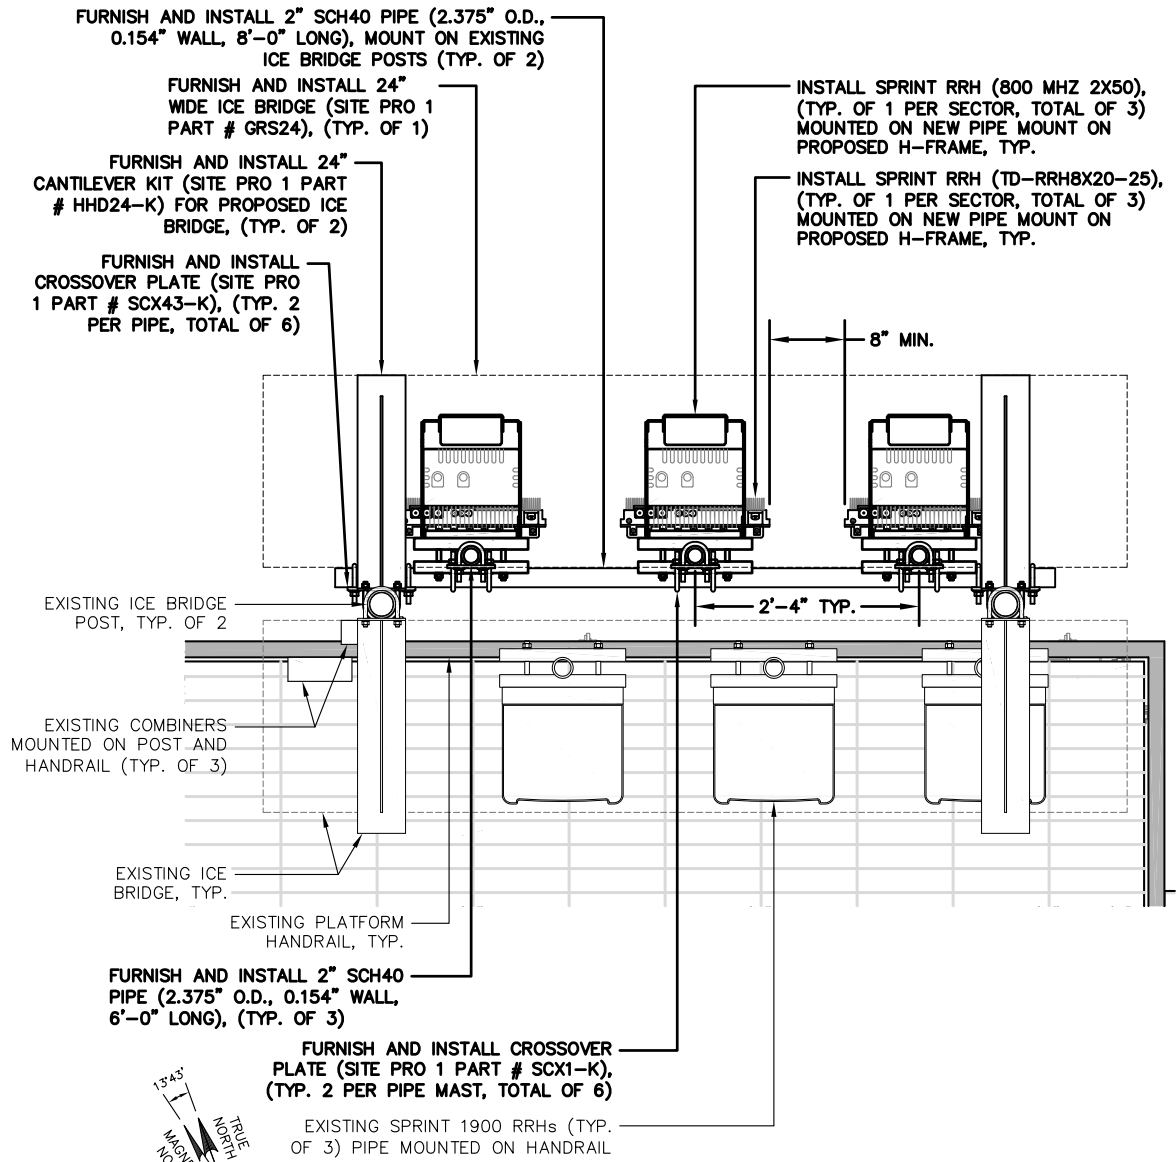
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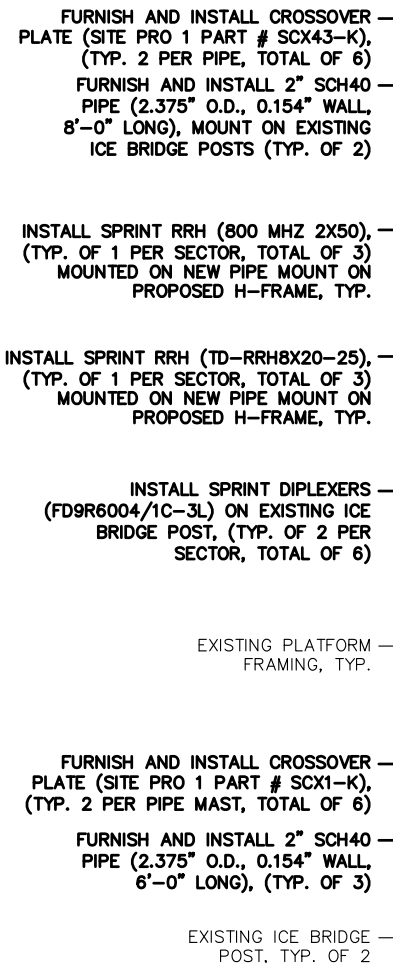
SHEET TITLE
RRH MOUNTING DETAILS

SHEET NUMBER
S-2

ALL STRUCTURAL AND MISC. STEEL SHALL BE ASTM A36 UNLESS NOTED. STEEL PIPE SHALL BE ASTM A53 GRADE B (35 KSI). ALL STEEL AND HARDWARE TO BE GALVANIZED.




OUTDOOR RRU RACK LOCATION DETAIL 1
SCALE: N.T.S. S-2





MINIMUM REQUIRED CLEARANCES BETWEEN RRHs
TOP: 16"
SIDES: 8"
FRONT: 36"

OUTDOOR RRU RACK 2
SCALE: N.T.S. S-2

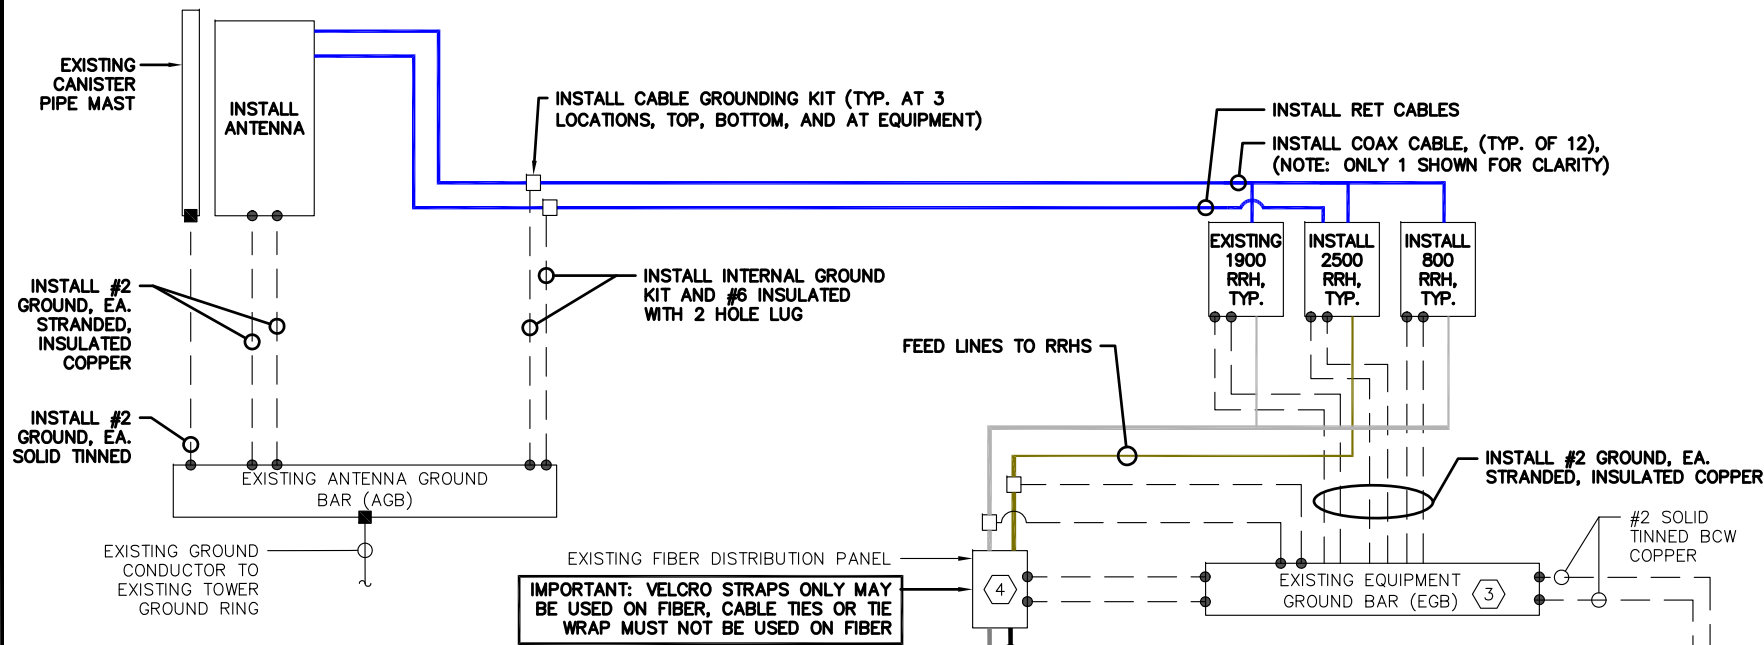


- SPECIAL WORK NOTE:**
- G.C. TO FURNISH AND INSTALL ALL COMPONENTS TO UPGRADE EXISTING ELECTRICAL SERVICE, CONDUIT, CONDUCTOR, PPC AND MCB IN ACCORDANCE WITH SPRINT CONSTRUCTION STANDARDS NV 2.5 ADDENDUM "ENGINEERING NOTICE 2013-002 (POWER UPGRADES) REV.0" (OR CURRENT VERSION)
 - G.C. TO FURNISH AND INSTALL UPGRADE THE EXISTING MMBTS BREAKER, CONDUCTOR, AND CONDUIT TO A MINIMUM NEC RATING. FOR NEW OR REPAIRED GROUNDING EQUIPMENT, REFER TO SPRINT GROUNDING STANDARDS AND FOLLOWING (SUPPLEMENTS):
-ANTI-THEFT UPDATE TO SPRINT GROUNDING DATED 08-24-12 (OR CURRENT VERSION)
-SPRINT ENGINEERING LETTER EL-0504 DATED 04-20-12 (OR CURRENT VERSION)
 - USE SPARE DC CABLES COILED UP AT TOWER TOP NV ARRAY TO POWER UP 2.5 RRH. INSIDE EXISTING FIBER DISTRIBUTION BOX, TIE SPARE DC CONDUCTORS INTO EXISTING DC BREAKER PANEL PER APPROVED DC WIRING CONNECTIVITY OPTION (BASED ON NV HYBRIFLEX CABLE LENGTH). CONSULT WITH SPRINT CM TO DETERMINE APPROPRIATE DC CONNECTIVITY OPTION, PLUMBING DIAGRAM AND DC BREAKER SIZE.

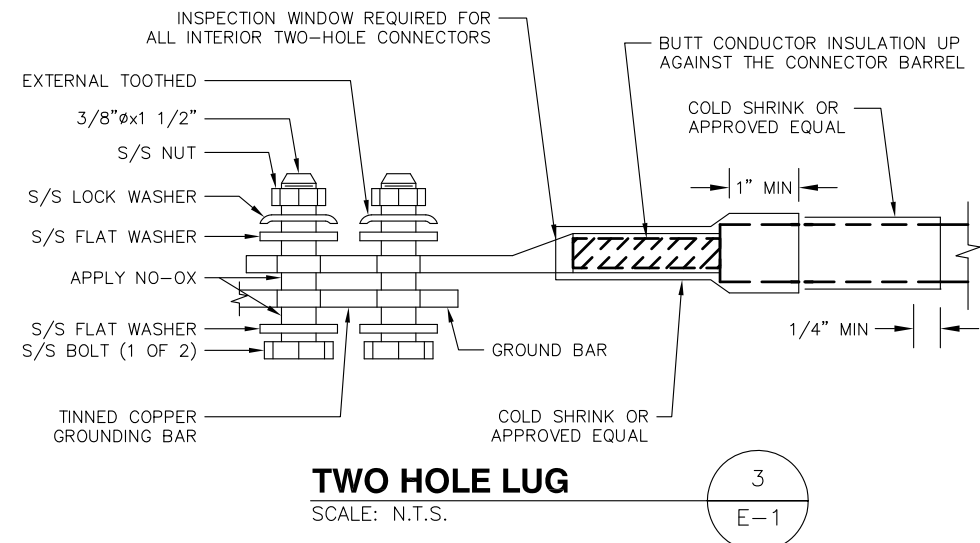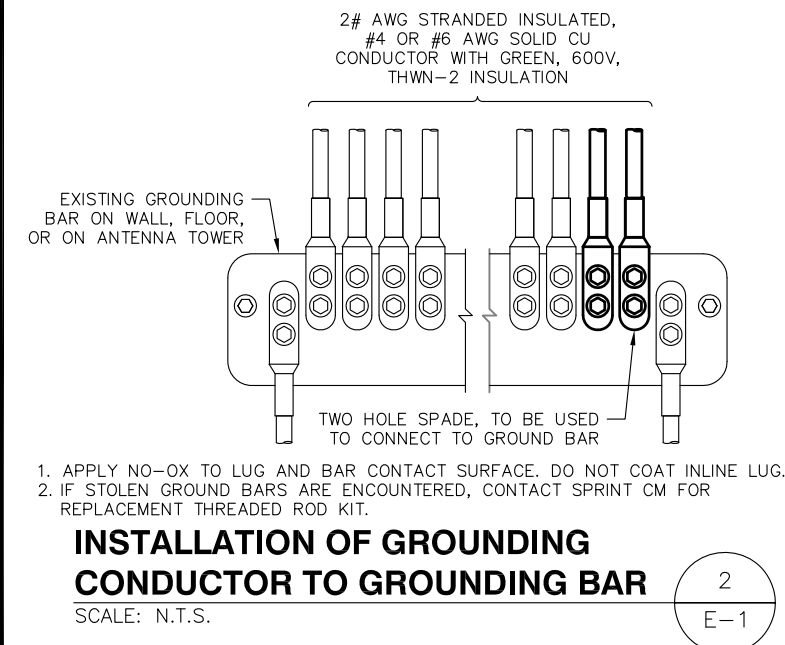

- ELECTRICAL NOTES**
- ALL ELECTRICAL WORK SHALL CONFORM TO THE REQUIREMENTS OF THE NATIONAL ELECTRICAL CODE (NEC) AS WELL AS APPLICABLE STATE AND LOCAL CODES.
 - THE ELECTRICAL CONTRACTOR SHALL COORDINATE ALL CONDUIT ROUTING WITH LOCAL UTILITY COMPANIES AND SPRINT CONSTRUCTION MANAGER.
 - ALL CONDUITS ROUTED BELOW GRADE SHALL TRANSITION TO RIGID GALVANIZED ELBOWS WITH RIGID GALVANIZED STEEL CONDUIT ABOVE GRADE.
 - ALL METAL CONDUITS SHALL BE PROVIDED WITH GROUNDING BUSHINGS.
 - GENERAL CONTRACTOR SHALL PROVIDE ALL DIRECT BURIED CONDUITS WITH PLASTIC WARNING TAPE IDENTIFYING CONTENTS. TAPE COLORS SHALL BE ORANGE FOR TELEPHONE AND RED FOR ELECTRIC.
 - ALL ELECTRICAL ITEMS SHALL BE U.L. APPROVED OR LISTED AND PROCURED PER SPECIFICATION REQUIREMENTS.
 - THE ELECTRICAL WORK INCLUDES ALL LABOR AND MATERIALS DESCRIBED BY DRAWINGS AND SPECIFICATIONS INCLUDING INCIDENTAL WORK TO PROVIDE COMPLETE OPERATING AND APPROVED ELECTRICAL SYSTEM.
 - GENERAL CONTRACTOR SHALL PAY FEES FOR PERMITS, AND IS RESPONSIBLE FOR OBTAINING SAID PERMITS AND COORDINATION OF INSPECTIONS.
 - ELECTRICAL AND TELCO WIRING OUTSIDE A BUILDING AND EXPOSED TO WEATHER SHALL BE IN WATER TIGHT GALVANIZED RIGID STEEL CONDUITS OR SCHEDULE 80 PVC (AS PERMITTED BY CODE) AND WHERE REQUIRED IN LIQUID TIGHT FLEXIBLE METAL OR NONMETALLIC CONDUITS.
 - BURIED CONDUIT SHALL BE SCHEDULE 40 PVC.
 - ELECTRICAL WIRING SHALL BE COPPER WITH TYPE XHHW, THWN, OR THIN INSULATION.
 - RUN ELECTRICAL CONDUIT OR CABLE BETWEEN ELECTRICAL UTILITY DEMARCATION POINT AND PROJECT OWNER CELL SITE PPC AS INDICATED ON THIS DRAWING. PROVIDE FULL LENGTH PULL ROPE. COORDINATE INSTALLATION WITH UTILITY COMPANY.
 - RUN TELCO CONDUIT OR CABLE BETWEEN TELEPHONE UTILITY DEMARCATION POINT AND PROJECT OWNER CELL SITE TELCO CABINET AND BTS CABINET AS INDICATED ON THIS DRAWING. PROVIDE FULL LENGTH PULL ROPE IN INSTALLED TELCO CONDUIT. PROVIDE GREENLEE CONDUIT MEASURING TAPE AT EACH END.
 - FIBER OPTIC CIRCUITS SHALL BE IN ACCORDANCE WITH NEC ARTICLE 770-OPTICAL FIBER CABLES AND RACEWAYS.
 - COMMUNICATIONS CIRCUITS SHALL BE IN ACCORDANCE WITH NEC ARTICLE 800-COMMUNICATIONS SYSTEMS.

- PROTECTIVE GROUNDING SYSTEMS GENERAL NOTES:**
- GROUNDING SHALL BE IN ACCORDANCE WITH NEC ARTICLE 250-GROUNDING AND BONDING.
 - GROUNDING SHALL BE IN ACCORDANCE WITH SPRINT SSEO DOCUMENTS 3.018.02.004 "BONDING, GROUNDING AND TRANSIENT PROTECTION FOR CELL SITES" AND 3.018.10.002 "SITE RESISTANCE TO EARTH TESTING".
 - PROVIDE GROUND CONNECTIONS FOR ALL METALLIC STRUCTURES, ENCLOSURES, RACEWAYS AND OTHER CONDUCTIVE ITEMS ASSOCIATED WITH THE INSTALLATION OF CARRIER'S EQUIPMENT.
 - GROUND CONNECTIONS: CLEAN SURFACES THOROUGHLY BEFORE APPLYING GROUND LUGS OR CLAMPS. IF SURFACE IS COATED, REMOVE THE COATING, APPLY A NON-CORROSIVE APPROVED COMPOUND TO CLEAN SURFACE AND INSTALL LUGS OR CLAMPS. WHERE GALVANIZING IS REMOVED FROM METAL, IT SHALL BE PAINTED OR TOUCHED UP WITH "GALVAMOX" OR EQUAL.
 - ALL GROUNDING WIRES SHALL PROVIDE A STRAIGHT, DOWNWARD PATH TO GROUND WITH GRADUAL BENDS AS REQUIRED. GROUND WIRES SHALL NOT BE LOOPED OR SHARPLY BENT.
 - ALL CLAMPS AND SUPPORTS USED TO SUPPORT THE GROUNDING SYSTEM CONDUCTORS AND PVC CONDUITS SHALL BE PVC TYPE (NON CONDUCTIVE). DO NOT USE METAL BRACKETS OR SUPPORTS WHICH WOULD FORM A COMPLETE RING AROUND ANY GROUNDING CONDUCTOR.
 - ALL GROUND WIRES SHALL BE #2 SOLID TINNED BCW UNLESS NOTED OTHERWISE.
 - PROVIDE DEDICATED #2 AWG COPPER GROUND WIRE FROM EACH ANTENNA MOUNTING PIPE TO ASSOCIATED CIGBE.
 - GROUND ANTENNA BASES, FRAMES, CABLE RACKS, AND OTHER METALLIC COMPONENTS WITH #2 INSULATED TINNED STRANDED COPPER GROUNDING CONDUCTORS AND CONNECT TO INSULATED SURFACE MOUNTED GROUND BARS. CONNECTION DETAILS SHALL FOLLOW MANUFACTURER'S SPECIFICATIONS FOR GROUNDING.
 - EACH EQUIPMENT CABINET SHALL BE CONNECTED TO THE MASTER ISOLATION GROUND BAR (MGB) WITH #2 SOLID TINNED BCW EQUIPMENT CABINETS WALL HAVE (2) CONNECTIONS.
 - GROUND HYBRIFLEX SHIELD AT TOP, BOTTOM AND AT TRANSITION TO HYBRIFLEX JUMPER CABLES AT EQUIPMENT CABINET ENTRANCE USING MANUFACTURER'S GUIDELINES. WHEN HYBRIFLEX CABLE EXCEEDS 200', GROUND AT INTERVALS NOT EXCEEDING 100'.
 - THE CONTRACTOR SHALL VERIFY THAT THE EXISTING GROUND BARS HAVE ENOUGH SPACE/HOLES FOR ADDITIONAL TWO HOLE LUGS.
 - EXOTHERMIC WELDING IS RECOMMENDED FOR GROUNDING CONNECTION WHERE PRACTICAL OTHERWISE. THE CONNECTION SHALL BE MADE USING COMPRESSION TYPE-2 HOLES, LONG BARREL LUGS OR DOUBLE CRIMP "C" CLAMP. THE COPPER CABLES SHALL BE COATED WITH AN ANTI-OXIDANT (THOMAS BETTS KOPR-SHILD) BEFORE MAKING THE CRIMP CONNECTIONS THE CONTRACTOR SHALL FOLLOW MANUFACTURER'S RECOMMENDED TORQUES ON THE BOLT ASSEMBLY TO SECURE CONNECTIONS.
 - AT ALL TERMINATIONS AT EQUIPMENT ENCLOSURES, PANEL, AND FRAMES OF EQUIPMENT AND WHERE EXPOSED FOR GROUNDING. CONDUCTOR TERMINATION SHALL BE PERFORMED UTILIZING TWO HOLE BOLTED TONGUE COMPRESSION TYPE LUGS WITH STAINLESS STEEL SELF-TAPPING SCREWS.
 - THE MASTER GROUND BAR (MGB) SHALL BE MADE OF BARE 1/4"x2" COPPER (FOR OUTDOOR APPLICATIONS IT SHALL BE TINNED COPPER) AND LARGE ENOUGH TO ACCOMMODATE THE REQUIRED NUMBER OF GROUND CONNECTIONS. THE HARDWARE SECURING THE MGB SHALL ELECTRICAL INSULATE THE MGB FROM ANY STRUCTURE TO WHICH IT IS FASTENED.
 - ALL BOLTS, WASHERS, AND NUTS USED ON GROUNDING CONNECTIONS SHALL BE STAINLESS STEEL.
 - ALL GROUNDING CONNECTIONS SHALL BE COATED WITH A COPPER SHIELD ANTI-CORROSIVE AGENT SUCH AS T&B KOPR SHIELD. VERIFY PRODUCT WITH SPRINT CONSTRUCTION MANAGER.
 - FOR NEW OR REPAIRED GROUNDING EQUIPMENT. REFER TO SPRINT GROUNDING STANDARDS AND FOLLOWING (SUPPLEMENTS):
-ANTI-THEFT UPDATE TO SPRINT GROUNDING DATED 08-24-12 (OR CURRENT VERSION)
-SPRINT ENGINEERING LETTER EL-0504 DATED 04-20-12 (OR CURRENT VERSION)

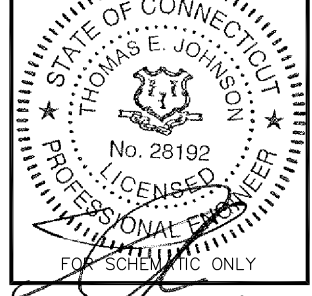

SUBMITTALS

REV.	DATE	DESCRIPTION	BY
0	02/14/18	ISSUED FOR CONSTRUCTION	JEB

SITE NUMBER:
CT33XC579
SITE NAME:
WATER TREATMENT PLANT

SITE ADDRESS:
1 WESTERBERG DRIVE
FARMINGTON, CT 06032

SHEET TITLE
ELECTRICAL AND GROUNDING DETAILS

SHEET NUMBER
E-1

Augment ID: CT33XC579Q17.1
RFDS ID: 111278



RF Design Sheet

NOTE:
VERIFY PROPOSED AZIMUTHS
WITH RF ENGINEER PRIOR TO
INSTALLATION

Site Identification	
Cascade	CT33XC579
SMS Schedule ID	1249696
SMS Schedule Name	DO Micro Upgrade
PID	
RRU OEM	ALU
Switch OEM	Alcatel Lucent
RFDS Issue Date	2017-08-15 00:00:00.0
RFDS Revision Date	2017-10-19 00:00:00.0
RFDS Revision	2
Filter Analysis Complete	
RFDS - Issue Date	08/15/2017
Design Status	Complete
Project Description	DO Micro Upgrade - Add 28MHz CC - 42 and 28MHz

Contact Information	
Engineer Email	SB.M.Hadley@sprint.com
Sprint Badged RF Engineer	SB.M.Hadley
RF Engineer Email	SB.M.Hadley@sprint.com
RF Engineer Phone	978-980-9700
RF Manager	Jonathan Hull
RF Manager Email	Jonathan.H.Hull@sprint.com
RF Manager Phone	617-233-2920
Carrier Count	
2500 LTE	0
1900 LTE	1
1900 EVDO	1
1900 Voice	1
800 LTE	1
800 Voice	1

Location Details		
Latitude	41.7304765	
Longitude	-72.8244811	
Market	Northern Connecticut	
Region	Northeast	
City	Farmington	
State	CT	
Zip Code	CT06032	
County	Hartford	
2500MHz		2
1900MHz		3
800MHz		3

Battery Backup Cabinet Model	
Model Number	60ECV2
Weight (lbs.)	200
Dimensions (in.)	60 x 31 x 30
Manufacturer	ALU

BTS #2 Model	
Model Number	
Weight (lbs.)	
Dimensions (in.)	
Manufacturer	
Needed at site	1

BTS #1 Model	
Model Number	9927 Cabinet
Weight (lbs.)	984
Dimensions (in.)	67.5 x 31.5 x 38.1
Manufacturer	ALU
Number of BTS #1	1

A&E Drawing Requirements

10/17/2017 (WR): RFDS revised to ground mount RRUs add 6 twin Diplexers for ground mount 1900/800/2500 RRUs.

Additional RF Notes

Replace Existing Antenna with 16 port MMW Panel Antenna for 1900 4T4R, 800 2T4R and 2500 8T8R.

Band: 2500		Alpha	Beta	Gamma	Delta	Epsilon	Zeta
Radio Model							
Model Number	TD-RRHx20-25	TD-RRHx20-25	N/A	N/A	N/A	N/A	N/A
Weight (lbs)	76.2	76.2	N/A	N/A	N/A	N/A	N/A
Dimensions	26 x 18.6 x 6.7	26 x 18.6 x 6.7	N/A	N/A	N/A	N/A	N/A
Manufacturer	ALU	ALU	N/A	N/A	N/A	N/A	N/A
Number of RRUs needed	1	1	0	0	0	0	0
Trunk Cable 1							
Model Number	Hybridica	N/A	N/A	N/A	N/A	N/A	N/A
Weight (lbs)	1	N/A	N/A	N/A	N/A	N/A	N/A
Dimensions (in.)	1.54	N/A	N/A	N/A	N/A	N/A	N/A
Manufacturer	ALU	N/A	N/A	N/A	N/A	N/A	N/A
Trunk Cable 1 Qty							

Band: 800		Alpha	Beta	Gamma	Delta	Epsilon	Zeta
Radio Model							
Model Number	RRH-2x50-800	RRH-2x50-800	RRH-2x50-800	N/A	N/A	N/A	N/A
Weight (lbs)	69.1	69.1	69.1	N/A	N/A	N/A	N/A
Dimensions	16 x 13 x 10	16 x 13 x 10	16 x 13 x 10	N/A	N/A	N/A	N/A
Manufacturer	ALU	ALU	ALU	N/A	N/A	N/A	N/A
Number of RRUs needed	1	1	1	0	0	0	0

Band: 1900		Alpha	Beta	Gamma	Delta	Epsilon	Zeta
Antenna 1							
Model Number	DHHT165B-3XR	DHHT165B-3XR	DHHT165B-3XR	N/A	N/A	N/A	N/A
Weight (lbs)	48.5	48.5	48.5	N/A	N/A	N/A	N/A
Dimensions	72 x 12 x 7.1	72 x 12 x 7.1	72 x 12 x 7.1	N/A	N/A	N/A	N/A
Manufacturer	CommScope	CommScope	CommScope	N/A	N/A	N/A	N/A
Ant 1 Top Jumper Make/Model/Qty	800/1900 Jumper	800/1900 Jumper	800/1900 Jumper	N/A	0	N/A	0
Ant 1 RF requested Diameter	1/2"	1/2"	1/2"	N/A	N/A	N/A	N/A
Ant 1 RF requested Top Jumper Length (ft)	8	8	8	N/A	N/A	N/A	N/A
Antenna 1 Azimuth	30	150	270	N/A	N/A	N/A	N/A
Antenna 1 Mechanical DT	N/A	N/A	N/A	N/A	N/A	N/A	N/A
Antenna 1 Center Line (ft)	150.0000048	150.0000048	150.0000048	N/A	N/A	N/A	N/A
Antenna 1 Electrical DT	3	3	3	N/A	N/A	N/A	N/A
Antenna 1 Electrical DT 2	N/A	N/A	N/A	N/A	N/A	N/A	N/A
Antenna 1 Electrical DT 3	N/A	N/A	N/A	N/A	N/A	N/A	N/A
Antenna 1 Twist	N/A	N/A	N/A	N/A	N/A	N/A	N/A

NOTE: RFDS PROVIDED BY SPRINT DATED 08/15/2017, REVISED 10/17/2017.. EXCERPTS TAKEN DEPICT RELEVANT RF DESIGN INFORMATION. A&E VENDOR SCOPE OF WORK LIMITED TO DESIGN OF MECHANICAL/STRUCTURAL EQUIPMENT ATTACHMENTS.

SPRINT CONSTRUCTION STANDARDS:

GENERAL CONTRACTOR SHALL ADHERE TO THE FOLLOWING SPRINT CONSTRUCTION STANDARDS.

- CONSTRUCTION STANDARDS: INTEGRATED CONSTRUCTION STANDARDS FOR WIRELESS SITES - CURRENT VERSION, INCLUDING EXHIBITS A-M.
 - CONSTRUCTION SPECIFICATIONS: CONSTRUCTION STANDARDS EXHIBIT A - STANDARD CONSTRUCTION SPECIFICATIONS FOR WIRELESS SITES (CURRENT VERSION).
 - GROUNDING STANDARDS: EXTERIOR GROUNDING SYSTEM DESIGN. GROUNDING STANDARDS (SUPPLEMENT): ANTI-THEFT UPDATE TO SPRINT GROUNDING 082412 AND SPRINT ENGINEERING LETTER EL-0504 DATED 04.20.12.
 - WEATHER PROOFING STANDARDS: EXCEPT FROM CONSTRUCTION STANDARDS EXHIBIT A, SECTION 3.6 WEATHERPROOFING CONNECTORS AND GROUND KITS.
 - COLOR CODING: SPRINT NEXTEL ANT AND LINE COLOR CODING PER SPRINT TS-0200 CURRENT VERSION.
 - GENERAL CONTRACTOR TO FIELD VERIFY AZIMUTH AND CL HEIGHT AND MECHANICAL DOWNTILT. IF DIFFERENT THAN CALLED OUT IN RFDS, HALT ANTENNA WORK FOR ONE HOUR, CALL SPRINT RF ENGINEER (OR MANAGER IF RF ENGINEER DOES NOT ANSWER, BUT STILL LEAVE A MESSAGE TO RF ENGINEER) USING SPRINT-PROVIDED CONTACT INFORMATION FOR FURTHER INSTRUCTIONS. IF SPRINT DOES NOT RESPOND WITHIN ONE HOUR, PLACE ANTENNA AT SAME CL HEIGHT AS PLAN AND EMAIL CORRECT CL HEIGHT AND AZIMUTH TO SPRINT RF ENGINEER. UPDATE AS-BUILT DRAWING WITH CORRECT CL HEIGHT. ALSO EMAIL CORRECT ANTENNA CL HEIGHT, AZIMUTH AND MECHANICAL DOWNTILT TO RF ENGINEER.
 - AISG TESTS TO VERIFY OPERATION IS TO BE PERFORMED AFTER FINAL INSTALLATION OF ANTENNAS AND AISG CABLES HAVE BEEN CONNECTED. VERIFY OPERATION OF ALL EXISTING SPRINT AISG EQUIPMENT INCLUDING 800MHZ, 1.9GHZ AND 2.5G. TEST INCLUDE COMPLETE DOWNTILT, AZIMUTH (IF APPLICABLE) AND BEAMWIDTH SWINGS (IF APPLICABLE). DOCUMENT AISG TEST RESULTS IN COAX SWEEP TEST SPREADSHEET.
 - GENERAL CONTRACTOR MUST INSURE THAT NO OBJECT IS LOCATED IN FRONT OF ANTENNA. THIS MEANS NO OBJECT IS TO BE LOCATED 45 DEGREES LEFT AND RIGHT OF FRONT OF ANTENNA OR 7 DEGREES UP AND DOWN FROM CENTER OF ANTENNA. IF THIS IS NOT POSSIBLE, CONTACT RF ENGINEER FOR FURTHER INSTRUCTION.
 - GENERAL CONTRACT IS REQUIRED TO USE A DIGITAL ALIGNMENT TOOL TO SET AZIMUTH, ROLL AND DOWNTILT. AZIMUTH ACCURACY IS TO BE WITHIN 1 DEGREES. DOWNTILT AND ROLL (LEFT TO RIGHT TILT) IS TO BE WITHIN 0.1 DEGREES. IF FOR SOME REASON THIS ACCURACY CANNOT BE ACHIEVED, UPDATE AS-BUILT DRAWINGS AND EMAIL SPRINT RF ENGINEER WITH AS-BUILT SETTINGS. USE 3Z RF ALIGNMENT TOOL OR EQUIVALENT TOOL.
- HTTP://WWW.3ZTELECOM.COM/ANTENNA-ALIGNMENT-TOOL/.

Antenna 1 Upper Passive Component Model						
Model Number	DPD-7126Y-0-11 (1.905 & 4.2 Diplexer)	DPD-7126Y-0-11 (1.905 & 4.2 Diplexer)	DPD-7126Y-0-11 (1.905 & 4.2 Diplexer)			
Weight (lbs)	7.3	7.3	7.3	N/A	N/A	N/A
Dimensions	6.26 x 4.07 x 7.42	6.26 x 4.07 x 7.42	6.26 x 4.07 x 7.42	N/A	N/A	N/A
Manufacturer	CCI	CCI	CCI	N/A	N/A	N/A
Ant1 Upper Passive Comp Qty needed	1	1	1	0	0	0
Ant1 Upper Pass Comp band comb with	1900MHz	1900MHz	1900MHz			
Antenna 1 Lower Passive Component Model						
Model Number	DPD-7126Y-0-11 (1.905 & 4.2 Diplexer)	DPD-7126Y-0-11 (1.905 & 4.2 Diplexer)	DPD-7126Y-0-11 (1.905 & 4.2 Diplexer)			
Weight (lbs)	7.3	7.3	7.3	N/A	N/A	N/A
Dimensions	6.26 x 4.07 x 7.42	6.26 x 4.07 x 7.42	6.26 x 4.07 x 7.42	N/A	N/A	N/A
Manufacturer	CCI	CCI	CCI	N/A	N/A	N/A
Ant1 Lower Passive Comp Qty needed	1	1	1	0	0	0
Ant1 Low Pass Comp band comb with	1900MHz	1900MHz	1900MHz			
Position Ant 1						
Antenna 1 Upper Passive Component Model						
Model Number	FD9R6004/1C-3L	FD9R6004/1C-3L	FD9R6004/1C-3L			
Weight (lbs)	2.6	2.6	2.6	N/A	N/A	N/A
Dimensions	5.8 x 6.5 x 1.5	5.8 x 6.5 x 1.5	5.8 x 6.5 x 1.5	N/A	N/A	N/A
Manufacturer	RFS	RFS	RFS	N/A	N/A	N/A
Ant1 Upper Passive Comp Qty needed	1	1	1	0	0	0
Ant1 Upper Pass Comp band comb with	800MHz	800MHz	800MHz			
Antenna 1 Lower Passive Component Model						
Model Number	FD9R6004/1C-3L	FD9R6004/1C-3L	FD9R6004/1C-3L			
Weight (lbs)	2.6	2.6	2.6	N/A	N/A	N/A
Dimensions	5.8 x 6.5 x 1.5	5.8 x 6.5 x 1.5	5.8 x 6.5 x 1.5	N/A	N/A	N/A
Manufacturer	RFS	RFS	RFS	N/A	N/A	N/A
Ant1 Lower Passive Comp Qty needed	1	1	1	0	0	0
Ant1 Low Pass Comp band comb with	800MHz	800MHz	800MHz			
Position Ant 1						




1 INTERNATIONAL BLVD, SUITE 800
MAHWAH, NJ 07495
TEL: (800) 357-7641



SBA COMMUNICATIONS CORP.
134 FLANDERS ROAD, SUITE 125
WESTBOROUGH, MA 01581
TEL: (508) 251-0720



4 Bay Road, Building A
Suite 200
Hadley, MA 01035 Ph: (413)320-4918

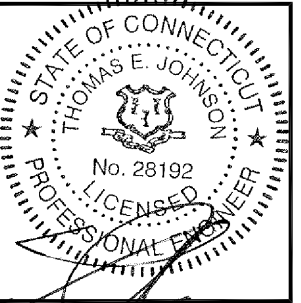

CHECKED BY: 2-14-JMM/TEU

APPROVED BY: JMM/TEU

SUBMITTALS			
REV.	DATE	DESCRIPTION	BY
0	02/14/18	ISSUED FOR CONSTRUCTION	JEB

SITE NUMBER:
CT33XC579
SITE NAME:
WATER TREATMENT PLANT


SITE ADDRESS:
1 WESTERBERG DRIVE
FARMINGTON, CT 06032

SHEET TITLE
RF DATA SHEET

SHEET NUMBER
RF-1


Option Z-12 (All Ground Mount) Plumb. Diag.

- 12 Total Coax Runs
- 2.5 RRHs are on GM
- 800/1900 RRH's are Ground Mounted
- RED: 2 x 800
- BLUE: 4 x 1900
- YELLOW: 2 x 2500

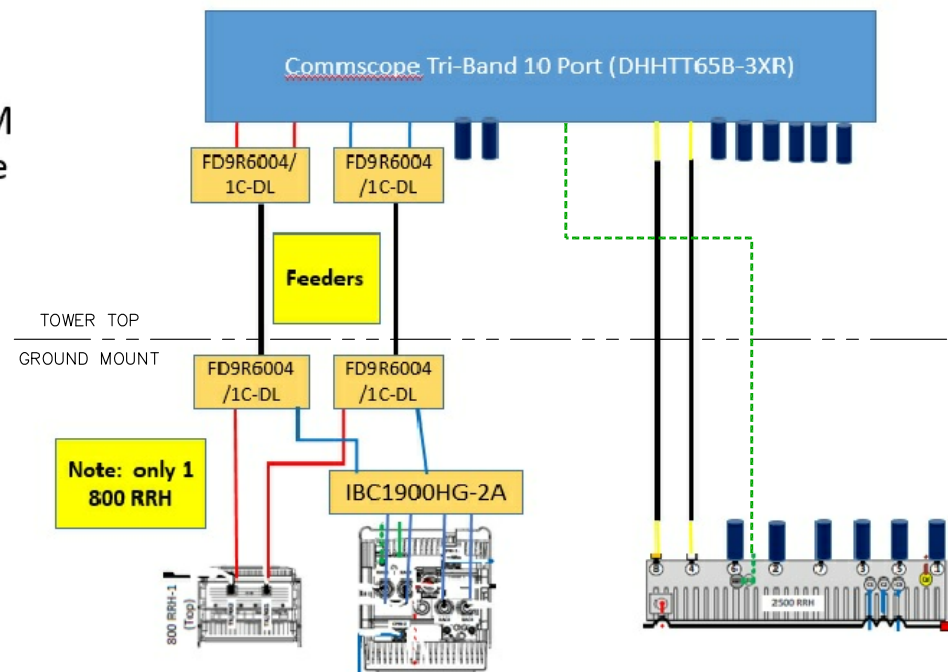


RAN WIRING DIAGRAM: ALU EQUIPMENT

SCALE: N.T.S.

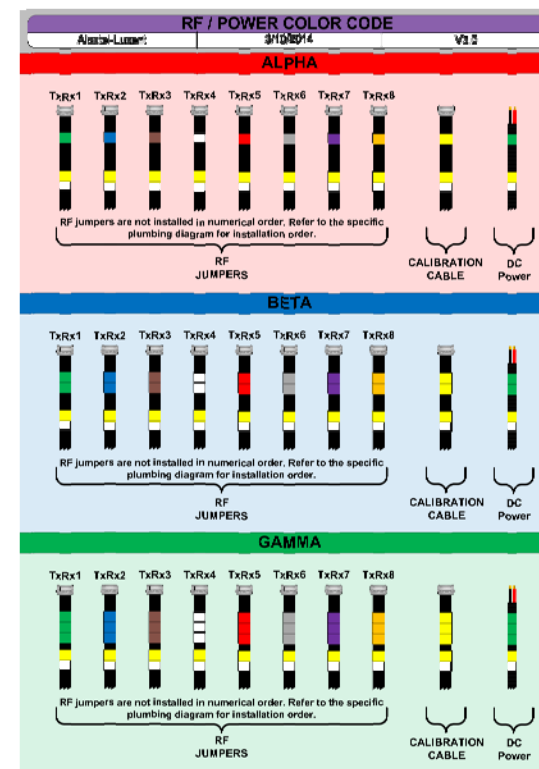

COLOR CODING

SCALE: N.T.S.

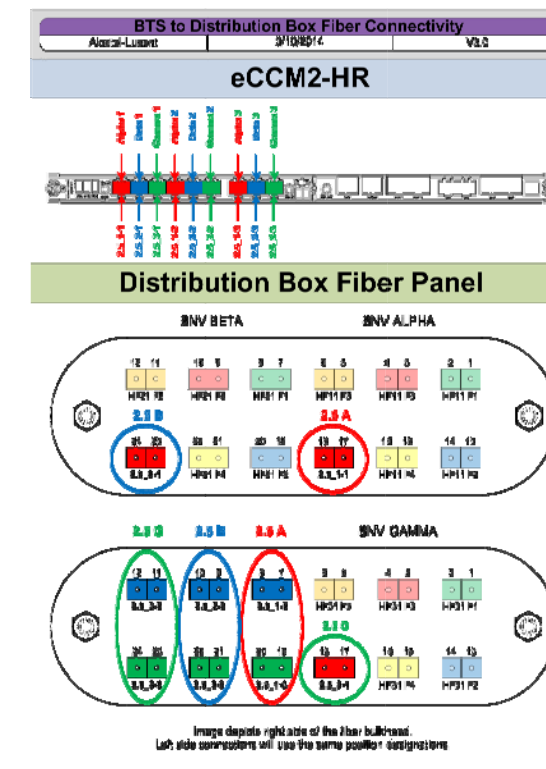

DISTRIBUTION BOX CONNECTIVITY

SCALE: N.T.S.




1 INTERNATIONAL BLVD, SUITE 800
MAHWAH, NJ 07495
TEL: (800) 357-7641



SBA COMMUNICATIONS CORP.
134 FLANDERS ROAD, SUITE 125
WESTBOROUGH, MA 01581 TEL: (508) 251-0720



4 Bay Road, Building A
Suite 200
Hadley, MA 01035 Ph: (413)320-4918

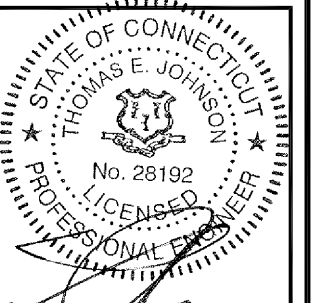

CHECKED BY: 2-14-18/JMM/TEJ

APPROVED BY: JMM/TEJ

SUBMITTALS			
REV.	DATE	DESCRIPTION	BY
0	02/14/18	ISSUED FOR CONSTRUCTION	JEB

SITE NUMBER:
CT33XC579
SITE NAME:
WATER TREATMENT PLANT
SITE ADDRESS:
1 WESTERBERG DRIVE
FARMINGTON, CT 06032

SHEET TITLE
PLUMBING DIAGRAM
AND RAN WIRING

SHEET NUMBER
RF-2