


COMPLIANCE CODE



ATC SITE NAME: ENFD-ENFIELD ATC SITE NUMBER: 302489 VERIZON SITE NAME: ENFIELD 4 CT **VERIZON SITE NUMBER:535791** SITE ADDRESS: 77 TOWN FARM RD., ENFIELD, CT 06082

PROJECT SUMMARY

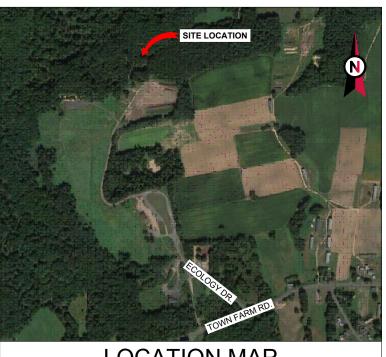

**LOCATION MAP** 

SHEET INDEX

### **VERIZON** 5G L-SUB6 CARRIER ADD ANTENNA AMENDMENT DRAWINGS

PROJECT DESCRIPTION

ALL WORK SHALL BE PERFORMED AND MATERIALS INSTALLED N ACCORDANCE WITH THE CURRENT EDITIONS OF THE	SITE ADDRESS:	THE PROPOSED PROJECT INCLUDES MODIFYING GROUND BASED AND TOWER MOUNTED EQUIPMENT AS INDICATED PER BELOW:	SHEET NO:	DESCRIPTION:	REV:	DATE:	BY:
FOLLOWING CODES AS ADOPTED BY THE LOCAL GOVERNMENT AUTHORITIES. NOTHING IN THESE PLANS IS	77 TOWN FARM RD.,	REMOVE (3) ANTENNA(s)	G-001	TITLE SHEET	0	09/17/21	BR
O BE CONSTRUED TO PERMIT WORK NOT CONFORMING TO THESE CODES.	ENFIELD, CT 06082	INSTALL (3) ANTENNA(s) AND (3) RRH(s)	G-002	GENERAL NOTES	0	09/17/21	BR
. 2018 CONNECTICUT STATE BUILDING CODE-AMENDMENTS	COUNTY: HARTFORD	EXISTING (9) ANTENNA(s), (9) RRH(s), (1) OVP(S), (2) 1-5/8" HYBRID	C-101	DETAILED SITE PLAN	0	09/17/21	BR
TO IBC 2015 INTERNATIONAL BUILDING CODE 2015, INTERNATIONAL	GEOGRAPHIC COORDINATES:	CABLE(s) AND (6) 1-5/8" COAX CABLES TO REMAIN	C-201	TOWER ELEVATION	0	09/17/21	BR
CODE COUNCIL	LATITUDE: 41.96591 LONGITUDE: -72.5527		C-401	ANTENNA INFORMATION & SCHEDULE	0	09/17/21	BR
TIA-222-G-4, STRUCTURAL STANDARD FOR ANTENNA SUPPORTING STRUCTURES AND ANTENNAS	GROUND ELEVATION: 159' AMSL				0	09/17/21	BR
ASCE 7-10 MINIMUM DESIGN LOADS FOR BUILDINGS AND			C-501	CONSTRUCTION DETAILS			
OTHER STRUCTURES, AMERICAN SOCIETY OF CIVIL			E-501	GROUNDING DETAILS	0	09/17/21	BR
ENGINEERS STEEL CONSTRUCTION MANUAL 14TH EDITION, AMERICAN			R-601	SUPPLEMENTAL			
INSTITUTE OF STEEL CONSTRUCTION			R-602	SUPPLEMENTAL			
CITY/COUNTY ORDINANCES	PROJECT TEAM	PROJECT NOTES		MOUNT MODIFICATION DRAWINGS (9 PAGES)			
	TOWER OWNER: APPLICANT:	THE FACILITY IS UNMANNED.     A TECHNICIAN WILL VISIT THE SITE APPROXIMATELY ONCE					
	AMERICAN TOWER VERIZON WIREL	A MONTH FOR ROUTINE INSPECTION AND MAINTENANCE.					
	10 PRESIDENTIAL WAY 118 FLANDERS F WOBURN, MA 01801 WESTBOROUGH, M	DISTURBANCE OR EFFECT OF STORM WATER DRAINAGE.					
UTILITY COMPANIES	, , , , , , , , , , , , , , , , , , , ,	4. NO SANITARY SEWER, POTABLE WATER OR TRASH DISPOSAL IS REQUIRED.					
POWER COMPANY: CENTRAL HUDSON GAS & ELECTRIC CO	ENGINEER:	HANDICAP ACCESS IS NOT REQUIRED.     HE PROJECT DEPICTED IN THESE PLANS QUALIFIES AS					
PHONE: (845)-452-2700	DEWBERRY ENGINEERS, INC. 99 SUMMER STREET	AN ELIGIBLE FACILITIES REQUEST ENTITLED TO EXPEDITED REVIEW UNDER 47 U.S.C. 1455(A) AS A					
TELEPHONE COMPANY: N/A	SUITE 700	MODIFICATION OF AN EXISTING WIRELESS TOWER THAT					
PHONE: N/A	BOSTON, MA 02110	INVOLVES THE COLLOCATION REMOVAL AND/OR REPLACEMENT OF TRANSMISSION EQUIPMENT THAT IS					
	PROPERTY OWNER:	NOT A SUBSTANTIAL CHANGE UNDER CFR 1.61000 (B)(7).					
XIII	ENFIELD TOWN OF 820 ENFIELD ST.	PROJECT LOCATION DIRECTIONS					
	ENFIELD, CT 06082	I-91 N. TO EXIT 46. TURN RIGHT OFF EXIT ONTO RT 5 N. TURN RIGHT	1				
		ONTO POST OFFICE ROAD. THIS WILL TURN INTO TOWNE FARM ROAD. LOOK FOR TOWN TRANSFER STATION ON LEFT. ACCESS TO					
Know what's <b>below</b> .		SITE IS GAINED BY ENTERING THE TOWN TRANSFER STATION AT ATTENDANT SHACK. FOLLOW ROAD AROUND BEHIND TRANSFER					
Call before you dig.		STATION TO TOWER. NOTE: GATE AT ENTRANCE IS LOCKED WHEN THE STATION IS CLOSED.					





Dewberry Engineers Inc. 99 SUMMER STREET SUITE 700 BOSTON, MA 02110 PHONE: 617.695.3400 FAX: 617.695.3310

REV.	DESCRIPTION	BY	DATE
<u> </u>	PRELIM	PP	06/03/21
<u>^</u>	FINAL	BR_	09/17/21
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ATC SITE NUMBER: 302489

ATC SITE NAME: **ENFD-ENFIELD** 

VERIZON SITE NAME: **ENFIELD 4 CT** 

SITE ADDRESS: 77 TOWN FARM RD., ENFIELD, CT 06082

# verizon /

DATE DRAWN:	06/03/21
ATC JOB NO:	13669399
CUSTOMER ID:	ENFIELD 4 CT
CUSTOMER #:	535791

TITLE SHEET

G-001

REVISION: 0

#### **GENERAL CONSTRUCTION NOTES:**

- OWNER FURNISHED MATERIALS, VERIZON "THE COMPANY" WILL PROVIDE AND THE CONTRACTOR WILL INSTALL
- A. BTS EQUIPMENT FRAME (PLATFORM) AND ICEBRIDGE SHELTER (GROUND BUILD/CO-LOCATE ONLY)
  - AC/TELCO INTERFACE BOX (PPC)
- D. TOWERS, MONOPOLES
- TOWER LIGHTING
- GENERATORS & LIQUID PROPANE TANK
- ANTENNA STANDARD BRACKETS, FRAMES AND PIPES FOR MOUNTING
- ANTENNAS (INSTALLED BY OTHERS)
- TRANSMISSION LINE
- TRANSMISSION LINE JUMPERS
- TRANSMISSION LINE CONNECTORS WITH WEATHERPROOFING KITS
- TRANSMISSION LINE GROUND KITS
- HANGERS
- HOISTING GRIPS
- O. BTS EQUIPMENT
- THE CONTRACTOR IS RESPONSIBLE TO PROVIDE ALL OTHER MATERIALS FOR THE COMPLETE INSTALLATION OF THE SITE INCLUDING, BUT NOT LIMITED TO, SUCH MATERIALS AS FENCING, STRUCTURAL STEEL SUPPORTING SUB-FRAME FOR PLATFORM, ROOFING LABOR AND MATERIALS GROUNDING RINGS GROUNDING WIRES COPPER-CLAD OR XIT CHEMICAL GROUND ROD(S), BUSS BARS, TRANSFORMERS AND DISCONNECT SWITCHES WHERE APPLICABLE, TEMPORARY ELECTRICAL POWER, CONDUIT, LANDSCAPING COMPOUND STONE, CRANES, CORE DRILLING, SLEEPERS AND RUBBER MATTING, REBAR, CONCRETE CAISSONS, PADS AND/OR AUGER MOUNTS, MISCELLANEOUS FASTENERS, CABLE TRAYS, NON-STANDARD ANTENNA FRAMES AND ALL OTHER MATERIAL AND LABOR REQUIRED TO COMPLETE THE JOB ACCORDING TO THE DRAWINGS AND SPECIFICATIONS. IT IS THE POSITION OF VERIZON TO APPLY FOR PERMITTING AND CONTRACTOR RESPONSIBLE FOR PICKUP AND PAYMENT OF REQUIRED
- ALL WORK SHALL CONFORM TO ALL CURRENT APPLICABLE FEDERAL, STATE, AND LOCAL CODES, INCLUDING ANSI/EIA/TIA-222, AND COMPLY WITH ATC CONSTRUCTION
- CONTRACTOR SHALL CONTACT LOCAL 811 FOR IDENTIFICATION OF UNDERGROUND
- CONTRACTOR SHALL BE RESPONSIBLE FOR COORDINATING ALL REQUIRED
- ALL DIMENSIONS TO, OF, AND ON EXISTING BUILDINGS, DRAINAGE STRUCTURES, AND SITE IMPROVEMENTS SHALL BE VERIFIED IN FIELD BY CONTRACTOR WITH ALL DISCREPANCIES REPORTED TO THE ENGINEER.
- DO NOT CHANGE SIZE OR SPACING OF STRUCTURAL ELEMENTS
- DETAILS SHOWN ARE TYPICAL; SIMILAR DETAILS APPLY TO SIMILAR CONDITIONS UNLESS
- THESE DRAWINGS DO NOT INCLUDE NECESSARY COMPONENTS FOR CONSTRUCTION SAFETY WHICH SHALL BE THE SOLE RESPONSIBILITY OF THE CONTRACTOR
- CONTRACTOR SHALL BRACE STRUCTURES UNTIL ALL STRUCTURAL ELEMENTS NEEDED FOR STABILITY ARE INSTALLED. THESE ELEMENTS ARE AS FOLLOWS: LATERAL BRACING,
- CONTRACTOR SHALL DETERMINE EXACT LOCATION OF EXISTING UTILITIES. GROUNDS DRAINS, DRAIN PIPES, VENTS, ETC, BEFORE COMMENCING WORK
- INCORRECTLY FABRICATED, DAMAGED, OR OTHERWISE MISFITTING OR NONCONFORMING MATERIALS OR CONDITIONS SHALL BE REPORTED TO THE VERIZON REP PRIOR TO REMEDIAL OR CORRECTIVE ACTION, ANY SUCH REMEDIAL ACTION SHALL REQUIRE WRITTEN APPROVAL BY THE VERIZON REP PRIOR TO PROCEEDING.
- EACH CONTRACTOR SHALL COOPERATE WITH THE VERIZON REP, AND COORDINATE HIS WORK WITH THE WORK OF OTHERS.
- CONTRACTOR SHALL REPAIR ANY DAMAGE CAUSED BY CONSTRUCTION OF THIS PROJECT TO MATCH EXISTING PRE-CONSTRUCTION CONDITIONS TO THE SATISFACTION
- ALL CABLE/CONDUIT ENTRY/EXIT PORTS SHALL BE WEATHERPROOFED DURING 15. INSTALLATION LISING A SILICONE SEALANT
- WHERE EXISTING CONDITIONS DO NOT MATCH THOSE SHOWN IN THIS PLAN SET. CONTRACTOR SHALL NOTIFY THE VERIZON REP AND ENGINEER OF RECORD
- CONTRACTOR SHALL ENSURE ALL SUBCONTRACTORS ARE PROVIDED WITH A COMPLETE AND CURRENT SET OF DRAWINGS AND SPECIFICATIONS FOR THIS PROJECT
- CONTRACTOR SHALL REMOVE ALL RUBBISH AND DEBRIS FROM THE SITE AT THE END OF
- CONTRACTOR SHALL COORDINATE WORK SCHEDULE WITH AMERICAN TOWER CORPORATION (ATC) AND TAKE PRECAUTIONS TO MINIMIZE IMPACT AND DISRUPTION OF OTHER OCCUPANTS OF THE FACILITY.
- CONTRACTOR SHALL FURNISH VERIZON AND AMERICAN TOWER CORPORATION (ATC) /ITH A PDF MARKED UP AS-BUILT SET OF DRAWINGS UPON COMPLETION OF WORK
- PRIOR TO SUBMISSION OF BID. CONTRACTOR SHALL COORDINATE WITH VERIZON REP TO DETERMINE WHAT, IF ANY, ITEMS WILL BE PROVIDED. ALL ITEMS NOT PROVIDED SHALL BE PROVIDED AND INSTALLED BY THE CONTRACTOR. CONTRACTOR WILL INSTALL

- 22. PRIOR TO SUBMISSION OF BID, CONTRACTOR SHALL COORDINATE WITH VERIZON REP TO DETERMINE IF ANY PERMITS WILL BE OBTAINED BY CONTRACTOR. ALL REQUIRED PERMITS NOT OBTAINED BY VERIZON MUST BE OBTAINED, AND PAID FOR, BY THE
- 23. CONTRACTOR SHALL INSTALL ALL SITE SIGNAGE IN ACCORDANCE WITH VERIZON SPECIFICATIONS AND REQUIREMENTS.
- ICE BRIDGE (CABLE TRAY WITH COVER) (GROUND BUILD/CO-LOCATE ONLY, GC TO FURNISH AND INSTALL FOR ROOFTOP INSTALLATION)

  24. CONTRACTOR SHALL SUBMIT ALL SHOP DRAWINGS TO VERIZON FOR REVIEW AND APPROVAL PRIOR TO FABRICATION.
  - ALL EQUIPMENT SHALL BE INSTALLED ACCORDING TO MANUFACTURER'S SPECIFICATIONS AND LOCATED ACCORDING TO VERIZON SPECIFICATIONS, AND AS SHOWN IN THESE PLANS
  - 26. THE CONTRACTOR SHALL SUPERVISE AND DIRECT THE PROJECT DESCRIBED HEREIN THE CONTRACTOR SHALL BE SOLELY RESPONSIBLE FOR ALL THE CONSTRUCTION MEANS, METHODS, TECHNIQUES, SEQUENCES AND PROCEDURES AND FOR COORDINATING ALL PORTIONS OF THE WORK UNDER THE CONTRACT.
  - CONTRACTOR SHALL NOTIFY VERIZON REP A MINIMUM OF 48 HOURS IN ADVANCE OF POURING CONCRETE OR BACKFILLING ANY UNDERGROUND UTILITIES, FOUNDATIONS OR SEALING ANY WALL, FLOOR OR ROOF PENETRATIONS FOR ENGINEERING REVIEW AND
  - CONTRACTOR SHALL BE RESPONSIBLE FOR SITE SAFETY INCLUDING COMPLIANCE WITH ALL APPLICABLE OSHA STANDARDS AND RECOMMENDATIONS AND SHALL PROVIDE ALL NECESSARY SAFETY DEVICES INCLUDING PPE AND PPM AND CONSTRUCTION DEVICES SUCH AS WELDING AND FIRE PREVENTION, TEMPORARY SHORING, SCAFFOLDING, TRENCH BOXES/SLOPING, BARRIERS, ETC.
  - THE CONTRACTOR SHALL PROTECT AT HIS OWN EXPENSE ALL EXISTING FACILITIES AND SUCH OF HIS NEW WORK LIABLE TO INJURY DURING THE CONSTRUCTION PERIOD. ANY DAMAGE CAUSED BY NEGLECT ON THE PART OF THIS CONTRACTOR OR HIS REPRESENTATIVES, OR BY THE ELEMENTS DUE TO NEGLECT ON THE PART OF THIS CONTRACTOR OR HIS REPRESENTATIVES, EITHER TO THE EXISTING WORK, OR TO HIS WORK OR THE WORK OF ANY OTHER CONTRACTOR, SHALL BE REPAIRED AT HIS EXPENSE TO THE OWNER'S SATISFACTION.
  - ALL WORK SHALL BE INSTALLED IN A FIRST CLASS, NEAT AND WORKMANLIKE MANNER BY MECHANICS SKILLED IN THE TRADE INVOLVED. THE QUALITY OF WORKMANSHIP SHALL BE SUBJECT TO THE APPROVAL OF THE VERIZON REP. ANY WORK FOUND BY THE VERIZON REP TO BE OF INFERIOR QUALITY AND/OR WORKMANSHIP SHALL BE REPLACED AND/OR REWORKED AT CONTRACTOR EXPENSE UNTIL APPROVAL IS
  - 31. IN ORDER TO ESTABLISH STANDARDS OF QUALITY AND PERFORMANCE, ALL TYPES OF MATERIALS LISTED HEREINAFTER BY MANUFACTURER'S NAMES AND/OR
    MANUFACTURER'S CATALOG NUMBER SHALL BE PROVIDED BY THESE MANUFACTURERS
  - VERIZON FURNISHED EQUIPMENT SHALL BE PICKED-UP AT THE VERIZON WAREHOUSE. NO LATER THAN 48HR AFTER BEING NOTIFIED INSURED, STORED, UNCRATE, PROTECTED AND INSTALLED BY THE CONTRACTOR WITH ALL APPURTENANCES REQUIRED TO PLACE THE EQUIPMENT IN OPERATION, READY FOR USE. THE CONTRACTOR SHALL BE RESPONSIBLE FOR THE EQUIPMENT AFTER PICKING IT UP.
  - VERIZON OR HIS ARCHITECT/ENGINEER RESERVES THE RIGHT TO REJECT ANY 33. EQUIPMENT OR MATERIALS WHICH, IN HIS OWN OPINION ARE NOT IN COMPLIANCE WITH THE CONTRACT DOCUMENTS, EITHER BEFORE OR AFTER INSTALLATION AND THE EQUIPMENT SHALL BE REPLACED WITH EQUIPMENT CONFORMING TO THE REQUIREMENTS OF THE CONTRACT DOCUMENTS BY THE CONTRACTOR AT NO COST TO VERIZON OR THEIR ARCHITECT/ENGINEER

#### SPECIAL CONSTRUCTION ANTENNA INSTALLATION NOTES:

- WORK INCLUDED:
  - ANTENNA AND COAXIAL CABLES ARE FURNISHED BY VERIZON UNDER A SEPARATE CONTRACT. THE CONTRACTOR SHALL ASSIST ANTENNA INSTALLATION CONTRACTOR IN TERMS OF COORDINATION AND SITE ACCESS. ERECTION SUBCONTRACTOR SHALL BE RESPONSIBLE FOR THE PROTECTION OF
  - B. INSTALL ANTENNA AS INDICATE ON DRAWINGS AND VERIZON SPECIFICATIONS
  - C. INSTALL GALVANIZED STEEL ANTENNA MOUNTS AS INDICATED ON DRAWINGS
  - D. INSTALL FURNISHED GALVANIZED STEEL OR ALUMINUM WAVEGUIDE
  - CONTRACTOR SHALL PROVIDE FOUR (4) SETS OF SWEEP TESTS USING ANRITZU-PACKARD 8713B RF SCALAR NETWORK ANALYZER, SUBMIT FREQUENCY DOMAIN REFLECTOMETER(FDR) TESTS RESULTS TO THE PROJECT MANAGER. SWEEP TESTS SHALL BE AS PER ATTACHED RFS "MINIMUM FIELD TESTING RECOMMENDED FOR ANTENNA AND HELIAX COAXIAL CABLE SYSTEMS" DATED 10/5/93 TESTING SHALL BE PERFORMED BY AN INDEPENDENT TESTING SERVICE AND BE BOUND AND SUBMITTED WITHIN ONE WEEK OF WORK COMPLETION.
  - INSTALL COAXIAL CABLES AND TERMINATING BETWEEN ANTENNAS AND EQUIPMENT PER MANUFACTURER'S RECOMMENDATIONS, WEATHERPROOF ALL CONNECTIONS BETWEEN THE ANTENNA AND EQUIPMENT PER MANUFACTURER'S REQUIREMENTS. TERMINATE ALL COAXIAL CABLE THREE (3) FEET IN EXCESS OF ENTRY PORT LOCATION UNLESS OTHERWISE STATED.
  - G ANTENNA AND COAXIAL CABLE GROUNDING:
- ALL EXTERIOR #6 GREED GROUND WIRE "DAISY CHAIN" CONNECTIONS ARE TO BE WEATHER SEALED WITH RFS CONNECTORS/SPLICE WEATHERPROOFING KIT #221213 OR
- ALL COAXIAL CABLE GROUNDING KITS ARE TO BE INSTALLED ON STRAIGHT RUNS OF

ALL DISCREPANCIES FROM WHAT IS SHOWN ON THESE CONSTRUCTION DRAWINGS SHALL BE COMMUNICATED TO ATC ENGINEERING IMMEDIATELY FOR CORRECTION OR RE-DESIGN. FAILURE TO COMMUNICATE DIRECTLY WITH ATC ENGINEERING OR ANY CHANGES FROM THE DESIGN CONDUCTED WITHOUT PRIOR APPROVAL FROM ATC ENGINEERING SHALL BE THE SOLE RESPONSIBILITY OF THE GENERAL CONTRACTOR.





99 SUMMER STREET SUITE 700 BOSTON, MA 02110 PHONE: 617.695.3400 FAX: 617.695.3310

REV	. DESCRIPTION	BY	DATE
$\triangle$	PRELIM	PP	06/03/21
<u> </u>	FINAL	BR	09/17/21
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ATC SITE NUMBER: 302489

ATC SITE NAME: **ENFD-ENFIELD** 

VERIZON SITE NAME: **ENFIELD 4 CT** 

SITE ADDRESS: 77 TOWN FARM RD., ENFIELD, CT 06082



DATE DRAWN:	06/03/21
ATC JOB NO:	13669399
CUSTOMER ID:	ENFIELD 4 CT
CUSTOMER #:	535791

**GENERAL NOTES** 


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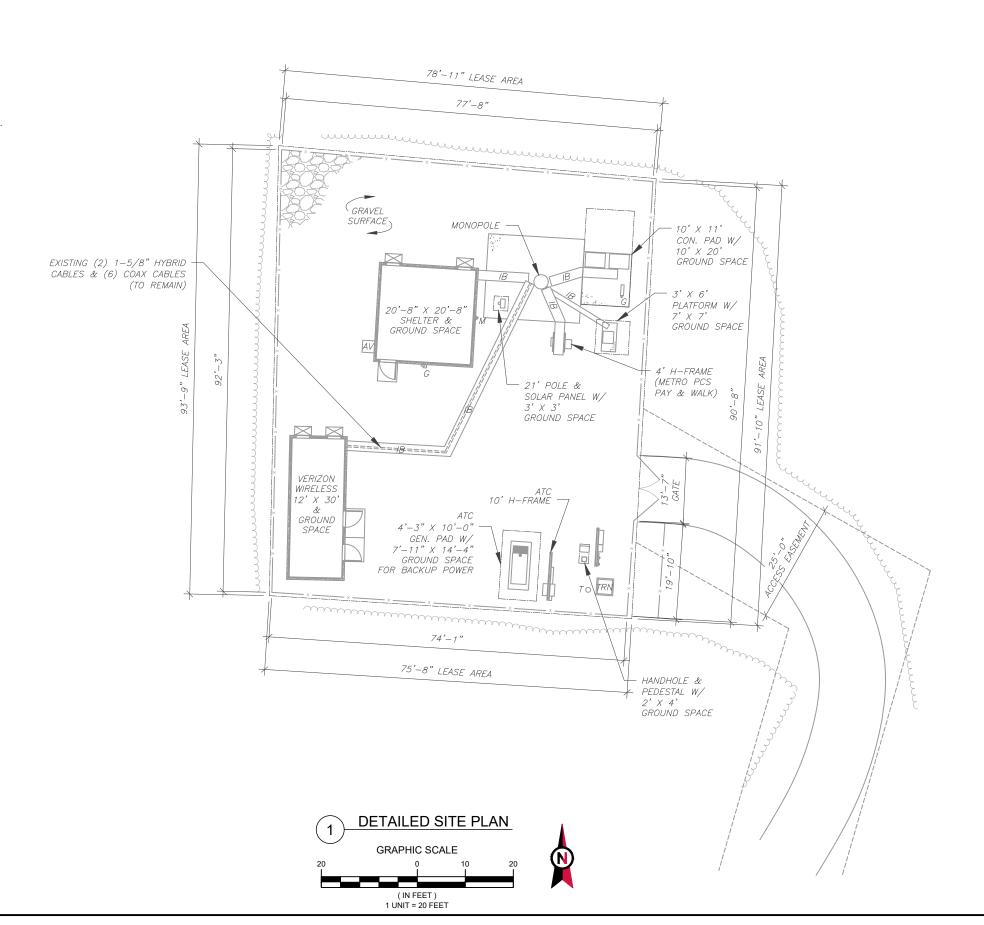
G-002

REVISION

#### SITE PLAN NOTES:

- THIS SITE PLAN REPRESENTS THE BEST PRESENT KNOWLEDGE AVAILABLE TO THE ENGINEER AT THE TIME OF THIS DESIGN. THE CONTRACTOR SHALL VISIT THE SITE PRIOR TO CONSTRUCTION AND VERIFY ALL EXISTING CONDITIONS RELATED TO THE SCOPE OF WORK FOR THIS PROJECT.
- 2. ICE BRIDGE, CABLE LADDER, COAX PORT, AND COAX CABLE ARE SHOWN FOR REFERENCE ONLY. CONTRACTOR SHALL CONFIRM THE EXACT LOCATION OF ALL PROPOSED AND EXISTING EQUIPMENT AND STRUCTURES DEPICTED ON THIS PLAN. BEFORE UTILIZING EXISTING CABLE SUPPORTS, COAX PORTS, INSTALLING NEW PORTS OR ANY OTHER EQUIPMENT, CONTRACTOR SHALL VERIFY ALL ASPECTS OF THE COMPONENTS MEET THE ATC SPECIFICATIONS.
- 3. NO ELECTRICAL SCOPE IS INCLUDED IN THIS PROJECT.



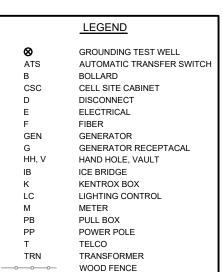





Dewberry Engineers Inc.

99 SUMMER STREET
SUITE 700
BOSTON, MA 02110
PHONE: 617.695.3400
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VERIZON SITE NAME: ENFIELD 4 CT

SITE ADDRESS: 77 TOWN FARM RD., ENFIELD, CT 06082

SEAL:





П	DATE DRAWN:	06/03/21
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П	CUSTOMER #:	535791

DETAILED SITE PLAN


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C-101

REVISION

CONSULTING CONNECTICUT, DATED 07/30/2021, THE EXISTING MOUNT MUST BE MODIFIED TO ADEQUATELY SUPPORT THE PROPOSED

LOADING. THE MOUNT MODIFICATION DETAILED AT THE END OF THIS PLAN SET, MUST BE INSTALLED PRIOR TO THE INSTALLATION OF THE PROPOSED ANTENNAS AND OTHER EQUIPMENT.



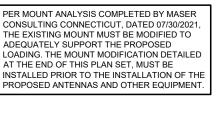

- TOWER NOTE:

  1. IT IS THE CONTRACTOR'S RESPONSIBILITY TO CONFIRM WITH THE PROJECT MANAGER THAT THEY HAVE THE MOST RECENT VERSION OF THE STRUCTURAL ANALYSIS BEFORE COMMENCING WORK. EXISTING AND PROPOSED TOWER APPURTENANCES, MOUNTS, AND ANTENNAS ARE SHOWN BASED ON THE STRUCTURAL ANALYSIS.
- 2. WHERE APPLICABLE, ALL NEW ANTENNAS, EQUIPMENT, MOUNTS, CABLING, ETC. SHALL BE PAINTED/SOCKED TO MATCH EXISTING EQUIPMENT IN ACCORDANCE WITH FAA, JURISDICTION, AND/OR OTHER LOCAL REQUIREMENTS.
- TOWER ELEVATIONS ARE MEASURED FROM TOP OF BASE PLATE TO MATCH STRUCTURAL ANALYSIS. ELEVATIONS DO NOT REFLECT TRUE ABOVE GROUND LEVEL (A.G.L.)





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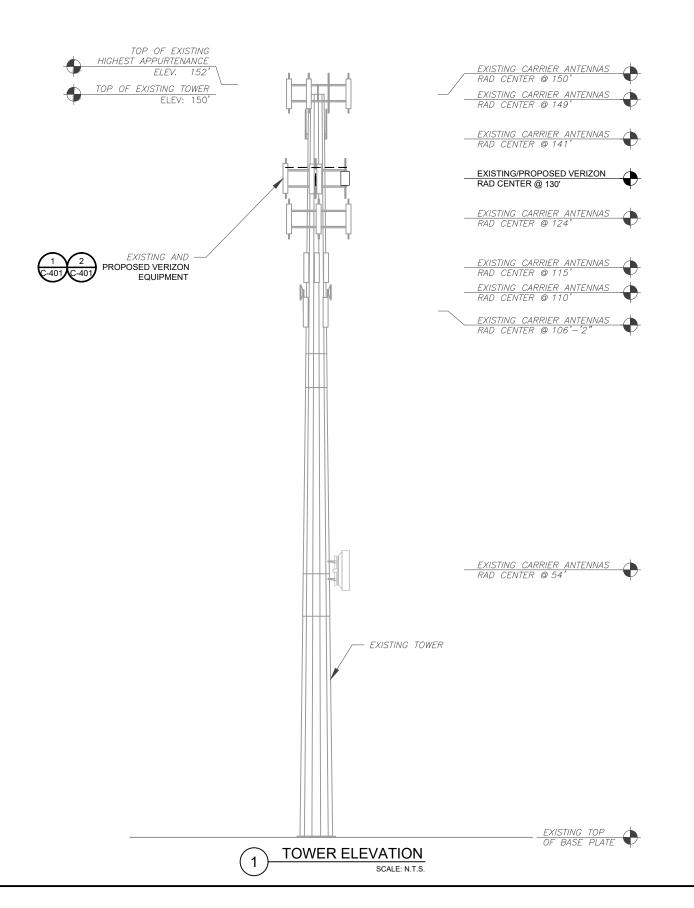
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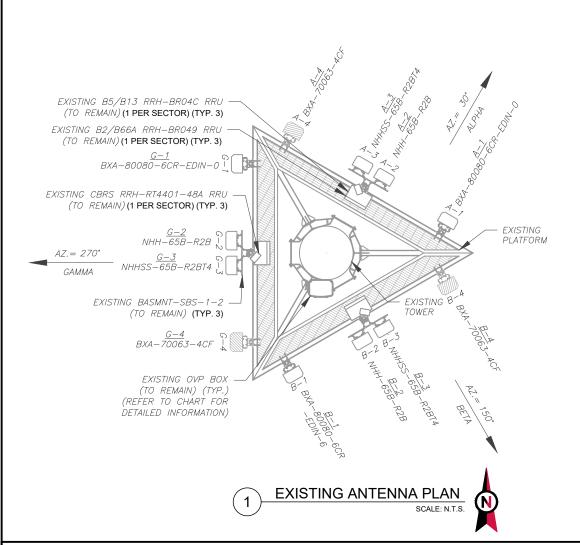
**TOWER ELEVATION** 


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C-201







				EXISTING ANTENNA S	SCHEDULE				NOTES						FINAL ANTENNA SCH	DULE		
LOCATIO	N		AN	TENNA SUMMARY			NON ANTENNA SUMMA	RY	1. CONFIRM WITH VERIZON REP	L	OCATION	V		AN	TENNA SUMMARY			NON ANTENNA SUMMA
SECTOR RAD	AZ	POS	ANTENNA	BAND	MECH/ELEC D-TILT	STATUS	ADDITIONAL TOWER MOUNTED EQUIPMENT	STATUS	FOR APPLICABLE UPDATES/REVISIONS AND MOST RECENT RFDS FOR NSN	SECTOR	RAD	AZ	POS	ANTENNA	BAND	MECH/ELEC D-TILT	STATUS	ADDITIONAL TOWER MOUNTED EQUIPMENT
		A1	BXA-80080-6CF-EDI N-0	850 CDMA	2/0	RMN	-	-	CONFIGURATION (CONFIG). GC TO CAP ALL UNUSED PORTS.				A1	BXA-80080-6CF-EDIN-0	850 CDMA	0/2	RMN	-
ALPHA 130°	30°	A2	NHH-65B-R2B	700/850/1900/ AWS	0/3,3,1,1	RMN	B2/B66A RRH-BR049 B5/B13 RRH-BR04C	RMN RMN	2. CONFIRM SPACING OF PROPOSED EQUIP DOES NOT CAUSE TOWER CONFLICTS	ALPHA	130'	30°	A2	NHH-65B-R2B	700/850/1900/AWS	0/3,3,1,1	RMN	B2/B66A RRH-BR049 B5/B13 RRH-BR04C
7127777 7700		A3	NHHSS-65B-R2BT4	CBRS	0/4	RMN	CBRS RRH-RT4401-48A	RMN	NOR IMPEDE TOWER CLIMBING PEGS.				А3	NHHSS-65B-R2BT4	CBRS	0/4	RMN	CBRS RRH-RT4401-48A
		A4	BXA-70063-4CF	_	_	RMV	_	_					A4	MT6407-77A	L-SUB6	0/6	ADD	MT6407-77A
		B1	BXA-80080-6CF-EDI N-6	850 CDMA	0/6	RMN	_	_	STATUS ABBREVIATIONS	]			B1	BXA-80080-6CF-EDIN-6	850 CDMA	0/6	RMN	-
		B2	NHH-65B-R2B	700/850/1900/	0/5,5,2,2	RMN	B2/B66A RRH-BR049	RMN	RMV: TO BE REMOVED  RMN: TO REMAIN	BETA	130'	150°	B2	NHH-65B-R2B	700/850/1900/AWS	0/5,5,2,2	RMN	B2/B66A RRH-BR049 B5/B13 RRH-BR04C
BETA 130'	150°			AWS	,		B5/B13 RRH-BR04C	RMN	REL: TO BE RELOCATED				В3	NHHSS-65B-R2BT4	CBRS	0/4	RMN	CBRS RRH-RT4401-48A
		<i>B3</i>	NHHSS-65B-R2BT4	CBRS	0/4	RMN	CBRS RRH-RT4401-48A	RMN	ADD: TO BE ADDED	]			B4	MT6407-77A	L-SUB6	0/6	ADD	MT6407-77A
		B4	BXA-70063-4CF	_	_	RMV	-	_					G1	BXA-80080-6CF-EDIN-0	850 CDMA	0/0	RMN	-
		G1	BXA-80080-6CF-EDI N-0	850 CDMA	0/0	RMN	_	_	CABLE LENGTHS FOR JUMPERS	]			G2	NHH-65B-R2B	700/850/1900/AWS	0/7,7,3,3	RMN	B2/B66A RRH-BR049
GAMMA 130°	270°	G2	NHH-65B-R2B	700/850/1900/ AWS	0/7,7,3,3	RMN	B2/B66A RRH-BR049 B5/B13 RRH-BR04C	RMN RMN	JUNCTION BOX TO RRU: 15' RRU TO ANTENNA: 10'	GAMMA	130'	270°	G3	NHHSS-65B-R2BT4	CBRS	0/4	RMN	B5/B13 RRH-BR04C CBRS RRH-RT4401-48A
3, ,,,,,,,,		G3	NHHSS-65B-R2BT4	CBRS	0/4	RMN	CBRS RRH-RT4401-48A	RMN					G4	MT6407-77A	L-SUB6	0/6	ADD	MT6407-77A
		G4	BXA-70063-4CF		_	RMV		_					-			1	1	

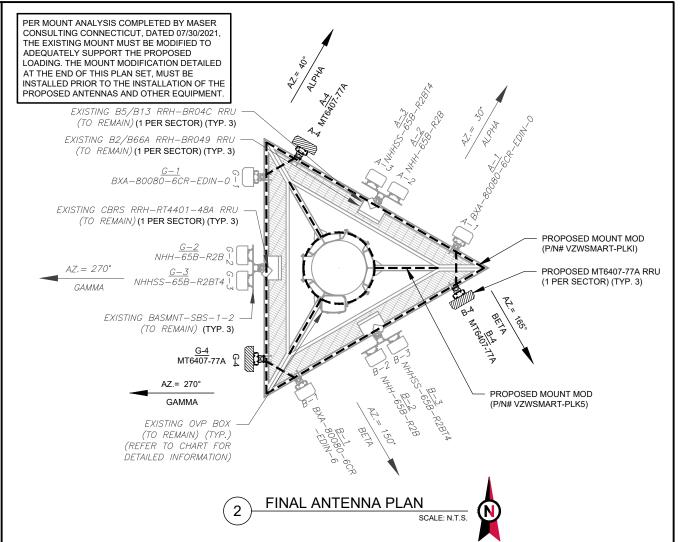EXISTING FIBER DISTRIBUTION/O	/P BOX	EXISTING CABLING SUMMARY				
MODEL NUMBER	STATUS	COAX	HYBRID	STATUS		
(1) RCMDC-6627-PF-48	RMN	(6) 1-5/8"	(2) 1-5/8"	RMN		



	FINAL FIBER DISTRIBUTION / OVE	BOX	FINAL CABLING SUMMARY			
MODEL NUMBER (1) RCMDC-6627-PF-48		STATUS	COAX	HYBRID	STATUS	
		RMN	(6) 1-5/8"	(2) 1-5/8"	RMN	





Dewberry Engineers Inc. 99 SUMMER STREET SUITE 700 BOSTON, MA 02110 PHONE: 617.695.3400 FAX: 617.695.3310

REV.	DESCRIPTION	BY	DATE
<u> </u>	PRELIM	PP	06/03/21
<u> </u>	FINAL	BR	09/17/21
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ATC SITE NUMBER: 302489

ATC SITE NAME: **ENFD-ENFIELD** 

VERIZON SITE NAME: **ENFIELD 4 CT** 

SITE ADDRESS: 77 TOWN FARM RD., ENFIELD, CT 06082

NON ANTENNA SUMMARY

STATUS

RMN RMN

RMN

ADD

RMN

RMN

RMN ADD

RMN RMN

RMN

ADD




# verizon /

DATE DRAWN:	06/03/21
ATC JOB NO:	13669399
CUSTOMER ID:	ENFIELD 4 CT
CUSTOMER #:	535791

### **ANTENNA INFORMATION** & SCHEDULE

SHEET NUMBER: C-401 REVISION: 0

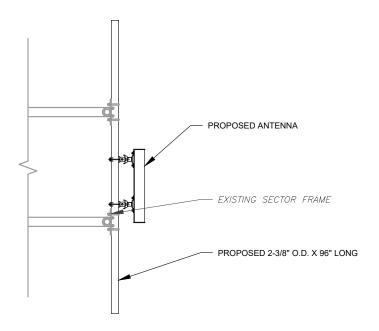

PROPOSED 5G ANTENNA MOUNTING DETAIL - TYPICAL





Dewberry Engineers Inc.
99 SUMMER STREET
SUITE 700
BOSTON, MA 02110
PHONE: 617.695.3400
FAX: 617.695.3310

REV.	DESCRIPTION	BY	DATE
<u> </u>	PRELIM	PP	06/03/21
<u></u>	FINAL	BR	09/17/21
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ATC SITE NUMBER: 302489

ATC SITE NAME: ENFD-ENFIELD

VERIZON SITE NAME: **ENFIELD 4 CT** 

SITE ADDRESS: 77 TOWN FARM RD., ENFIELD, CT 06082






	DATE DRAWN:	06/03/21
	ATC JOB NO:	13669399
	CUSTOMER ID:	ENFIELD 4 CT
	CUSTOMER #:	535791

### CONSTRUCTION **DETAILS**

SHEET NUMBER:


REVISION: C-501

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- 1. THIS DETAIL IS INTENDED TO SHOW THE GENERAL GROUNDING REQUIREMENTS. SLIGHT ADJUSTMENTS MAY BE REQUIRED BASED ON EXISTING SITE CONDITIONS. THE CONTRACTOR SHALL MAKE FIELD ADJUSTMENTS AS NEEDED AND INFORM THE CONSTRUCTION MANAGER OF ANY CONFLICTS.
- 2. SITE GROUNDING SHALL COMPLY WITH VERIZON GROUNDING STANDARDS, LATEST EDITION, AND COMPLY WITH VERIZON GROUNDING CHECKLIST, LATEST VERSION. WHEN NATIONAL AND LOCAL GROUNDING CODES ARE MORE STRINGENT THEY SHALL GOVERN.

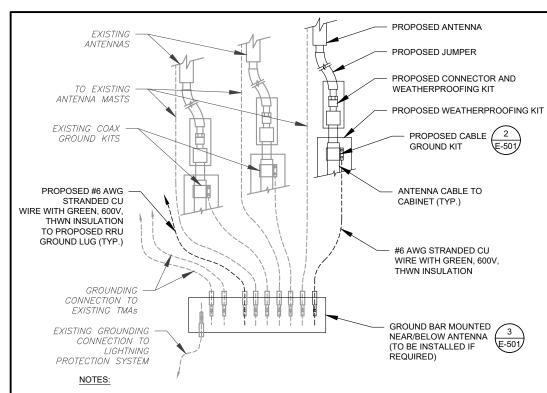




- GROUND KIT NOTES:

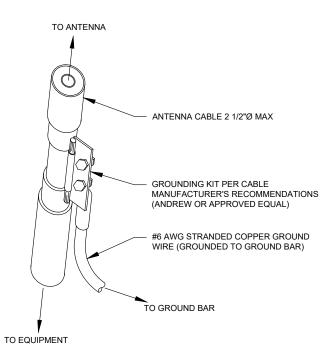  1. DO NOT INSTALL CABLE GROUND KIT AT A BEND AND ALWAYS DIRECT GROUND WIRE DOWN TO GROUND BAR.
- 2. CONTRACTOR SHALL PROVIDE WEATHERPROOFING KIT (ANDREW PART NUMBER 221213) AND INSTALL/TAPE PER MANUFACTURER'S SPECIFICATIONS.

CABLE GROUND KIT CONNECTION DETAIL

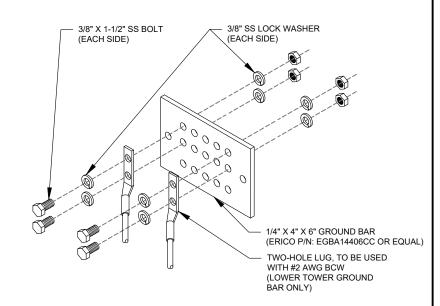

#### **GROUND BAR NOTES:**

- GROUND BAR KITS COME WITH ALL HARDWARE, NUTS, BOLTS, WASHERS, ETC. EXCEPT THE STRUCTURAL MOUNTING MEMBER(S).
- 2. GROUND BAR TO BE BONDED DIRECTLY TO TOWER.







Dewberry Engineers Inc. 99 SUMMER STREET SUITE 700 BOSTON, MA 02110 PHONE: 617.695.3400 FAX: 617.695.3310

REV.	DESCRIPTION	BY	DATE
<u> </u>	PRELIM	PP	06/03/21
<u> </u>	FINAL	BR	09/17/21
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ATC SITE NUMBER: 302489

ATC SITE NAME: **ENFD-ENFIELD** 

VERIZON SITE NAME:

**ENFIELD 4 CT** 

SITE ADDRESS: 77 TOWN FARM RD., ENFIELD, CT 06082






	DATE DRAWN:	06/03/21
	ATC JOB NO:	13669399
	CUSTOMER ID:	ENFIELD 4 CT
	CUSTOMER #:	535791
l		

**GROUNDING DETAILS** 

SHEET NUMBER:


REVISION: E-501

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## 1 ANTENNA SPECIFICATIONS FOR ILLUSTRATIVE PURPOSES ONLY - NOT TO SCALE

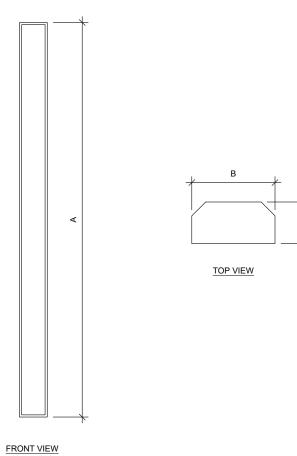ANTENN	IA SPECIFIC	ATIONS		
ANTENNA MODEL	A	В	С	WEIGHT (LBS)
MT6407-77A	35.1"	16.1"	5.5"	81.6



FRONT VIEW
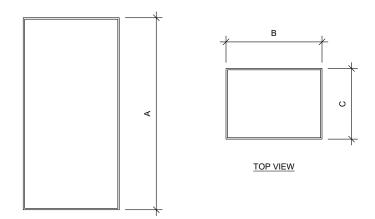
## 2 RRU SPECIFICATIONS FOR ILLUSTRATIVE PURPOSES ONLY - NOT TO SCALE

RRU	SPECIFICAT	IONS		
RRU MODEL	А	В	С	WEIGHT (LBS)
MT6407-77A	35.1"	16.1"	5.5"	81.6





Dewberry Engineers Inc.
99 SUMMER STREET
SUITE 700
BOSTON, MA 02110
PHONE: 617.695.3400
FAX: 617.695.3310

ATC SITE NUMBER: 302489

ATC SITE NAME: ENFD-ENFIELD

VERIZON SITE NAME: ENFIELD 4 CT

SITE ADDRESS: 77 TOWN FARM RD., ENFIELD, CT 06082

SEAL:



DATE DRAWN: 06/03/21
ATC JOB NO: 13669399
CUSTOMER ID: ENFIELD 4 CT
CUSTOMER #: 535791

SUPPLEMENTAL

SHEET NUMBER:

R-601





Maser Consulting Connecticut 2000 Midlantic Drive, Suite 100 Mt. Laurel, NJ 08054 (856) 797-0412 peter.albano@colliersengineering.com

#### Post-Mod Antenna Mount Analysis Report and PMI Requirements

Mount Fix

SMART Tool Project #: 10088395 Maser Consulting Connecticut Project #: 21777518A

July 30, 2021

Site Information Site ID: 535791-VZW / ENFIELD 4 CT

Site Name: ENFIELD 4 CT
Carrier Name: Verizon Wireless
Address: 400 Ecology Rd

Enfield, Connecticut 06082

Hartford County
Latitude: 41.965903\*
Longitude: -72.552692\*

<u>Structure Information</u>

Tower Type: 162-Ft Monopole
Mount Type: 12.50-Ft Platform

FUZE ID # 16251544

**Analysis Results** 

Platform: 55.5% Pass

\*\*\*Contractor PMI Requirements:
Included at the end of this MA report
Available & Submitted via portal at https://pmi.vzwsmart.com
Contractor - Please Review Specific Site PMI Requirements Upon Award
Requirements also Noted on Mount Modification Drawings
Requirements may also be Noted on A & E drawings

Report Prepared By: Andy Hanes



Mount Post-Modification Analysis Report (1) 12.50-Ft Platform July 30, 2021 Site ID: 535791-VZW / ENFIELD 4 CT Page | 4

- All member connections are assumed to have been designed to meet or exceed the load carrying capacity
  of the connected member unless otherwise specified in this report.
- The mount was checked up to, and including, the bolts that fasten it to the mount collar/attachment and threaded rod connections in collar members if applicable. Local deformation and interaction between the mount collar/attachment and the supporting tower structure are outside the scope of this analysis.
- All services are performed, results obtained, and recommendations made in accordance with generally accepted engineering principles and practices. Maser Consulting Connecticut is not responsible for the conclusion, opinions, and recommendations made by others based on the information supplied.
- Structural Steel Grades have been assumed as follows, if applicable, unless otherwise noted in this analysis:

 o Channel, Solid Round, Angle, Plate
 ASTM A36 (Gr. 36)

 o HSS (Rectangular)
 ASTM 500 (Gr. B-46)

 o Pipe
 ASTM A53 (Gr. B-35)

 o Threaded Rod
 F1554 (Gr. 36)

 o Bolts
 ASTM A325

Any mount modifications listed under Sources of Information are assumed to have been installed per the design specifications.

Discrepancies between in-field conditions and the assumptions listed above may render this analysis invalid unless explicitly approved by Maser Consulting Connecticut.

#### Analysis Results:

Component	Utilization %	Pass/Fail
Connection Check	42.4 %	Pass
Face Horizontal	12.6 %	Pass
Standoff Horizontal	31.9 %	Pass
Cross Brace	55.5 %	Pass
Grating Support	15.7 %	Pass
Corner Plate	40.4 %	Pass
Cross Brace Plate	23.5 %	Pass
Mount Pipe	34.6 %	Pass
MOD Support Rail	12.4 %	Pass
MOD Support Rail Corner	19.0 %	Pass
MOD Kicker Kit	4.9 %	Pass

Structure Rating – (Controlling Utilization of all Components)	55.5%

#### Recommendation:

The existing mount will be **SUFFICIENT** for the final loading after the proposed modifications are successfully completed.

ANSI/ASSP rigging plan review services compliant with the requirements of ANSI/TIA 322 are available for a Construction Class IV site or other, if required. Separate review fees will apply.





Dewberry Engineers Inc.
99 SUMMER STREET
SUITE 700
BOSTON, MA 02110
PHONE: 617.695.3400
FAX: 617.695.3310

ATC SITE NUMBER: 302489

ATC SITE NAME: ENFD-ENFIELD

VERIZON SITE NAME: ENFIELD 4 CT

SITE ADDRESS: 77 TOWN FARM RD., ENFIELD, CT 06082

SEAL:

verizon<sup>/</sup>

DATE DRAWN: 06/03/21
ATC JOB NO: 13669399
CUSTOMER ID: ENFIELD 4 CT
CUSTOMER #: 535791

SUPPLEMENTAL

SHEET NUMBER:

R-602



### MOUNT MODIFICATION DRAWINGS **EXISTING 12.50' PLATFORM**

TOWER OWNER: AMERICAN TOWER COMPANY **TOWER OWNER SITE NUMBER: 302489** 

> CARRIER SITE NAME: ENFIELD 4 CT **CARRIER SITE NUMBER: 535791** FUZE ID: 16251544

> > 400 ECOLOGY RD ENFIELD, CT 06082 HARTFORD COUNTY

LATITUDE: 41.965903° N LONGITUDE: 72.552692° W

#### **DESIGN CRITERIA**

#### WIND LOADS

BASIC WIND SPEED (3 SECOND GUST), V = 116 MPH EXPOSURE CATEGORY C

TOPOGRAPHIC CATEGORY I MEAN BASE ELEVATION (AMSL) = 162.94'

ICE WIND SPEED (3 SECOND GUST), V = 50 MPH

ICE THICKNESS = 1.50 IN

#### SEISMIC LOADS

SEISMIC DESIGN CATEGORY B

SHORT TERM MCER GROUND MOTION,  $S_s = .174$ LONG TERM MCER GROUND MOTION, S<sub>I</sub> = .055

#### APPLICANT/LESSEE

VERIZON WIRELESS

#### CLIENT REPRESENTATIVE

VERIZON WIRELESS COMPANY: 118 FLANDERS ROAD, THIRD FLOOR WESTBOROUGH, MA 01581 ADDRESS:

CITY, STATE, ZIP: CONTACT: ANDREW CANDIELLO ANDREW.CANDIELLO@VERIZONWIRELESS.COM

PROJECT INFORMATION

#### PROJECT MANAGER

COMPANY MASER CONSULTING CONNECTICUT CONTACT:

PETER ALBANO

PETER.ALBANO@COLLIERSENGINEERING.COM F-MAII ·

#### CONTRACTOR PMI REQUIREMENTS

MLI OCATION: SMART TOOL PROJECT #: VZW LOCATION CODE (PSLC): ANALYSIS DATE:

10088395

PMI REQUIREMENTS EMBEDDED WITHIN MOUNT MODIFICATION REPORT

HTTPS://PMI.VZWSMART.COM

**SHEET INDEX** 

SHEET DESCRIPTION ST-I TITLE SHEET SBOM-I BILL OF MATERIALS SGN-I GENERAL NOTES SCF-I CLIMBING FACILITY DETAIL SS-I MODIFICATION DETAILS SS-2 MOUNT PHOTOS SPECIFICATION SHEETS

NOTE: DO NOT SCALE DRAWINGS FOR CONSTRUCTIO

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—CONNECTICUT— PENNSYLVANIA VIRGINIA TEXAS FI ORIDA ser Cons@**@NSHILTING**@.This drawing rized for usoogly by the period of others the ser This drawing may hot be copied, reused, disclose verizon v REV DATE DESCRIPTION ENFIELD 4 CT 535791 400 ECOLOGY RD ENFIELD, CT 06082 HARTFORD COUNTY Phone: 856.797.0412 Fax: 856.722.1120 TITLE SHEET

### **BILL OF MATERIALS**

			SI	ection 1 - vzwsmart kits		
QUANTITY	MANUFACTURER	PART NUMBER	DESCRIPTION	NOTES	UNIT WEIGHT (LBS.)	WEIGHT (LBS.)
I		VZWSMART-PLK1	SUPPORT RAIL KIT	CONTRACTOR TO VERIFY THE LENGTH REQUIRED AND TRIM AS NECESSARY IN ACCORDANCE WITH THE 'STRUCTURAL STEEL' NOTES ON SHEET SGN-I	504	504
I		VZWSMART-PLK5	KICKER KIT	CONTRACTOR TO VERIFY THE LENGTH REQUIRED AND TRIM AS NECESSARY IN ACCORDANCE WITH THE 'STRUCTURAL STEEL' NOTES ON SHEET SGN-I	291	291
I	_	VZWSMART-PLK7	MONOPOLE COLLAR MOUNT ASSEMBLY		150	150
	_					
	VZWSMART -					
	_					
	_					
	-					
			SECTI	ON 2 - OTHER REQUIRED PARTS		
QUANTITY	MANUFACTURER	PART NUMBER	DESCRIPTION	NOTES	UNIT WEIGHT (LBS.)	WEIGHT (LBS.)

### NOTES:

- I. THE MANUFACTURERS LISTED ARE THE APPROVED VENDORS FOR THE VZW MOUNT KITS. EACH MANUFACTURER WILL BE AWARE OF WHICH KITS HAVE BEEN THROUGH THE VZW APPROVAL PROCESS AND THEY ARE IN TURN APPROVED TO SELL. PLEASE NOTE THAT THE MATERIAL UTILIZED ON THE MOUNT MODIFICATIONS WILL BE REVIEWED AS A PART OF THE DESKTOP PMI COMPLETED BY THE SMART TOOL VENDOR. IT WILL BE REQUIRED THAT THE VZW KITS SPECIFIED ARE UTILIZED IN THE MODIFICATIONS.
- 2. ALL MATERIALS REQUIRED FOR THE DESIGNED MODIFICATIONS BUT NOT LISTED IN THIS SHEET ARE ASSUMED TO BE PROVIDED BY THE CONTRACTOR.

	COMMSCOPE
CONTACT	SALVADOR ANGUIANO
PHONE	(817) 304-7492
EMAIL	SALVADOR.ANGUIANO@COMMSCOPE.COM
WEBSITE	WWW.COMMSCOPE.COM
N	IETROSITE FABRICATORS, LLC
CONTACT	KENT RAMEY
PHONE	(706) 335-7045 (O), (706) 982-9788 (M)
EMAIL	KENT@METROSITELLC.COM
WEBSITE	METROSITEFABRICATORS.COM
	PERFECTVISION
CONTACT	WIRELESS SALES
PHONE	(844) 887-6723
EMAIL	WWW.PERFECT-VISION.COM
WEBSITE	WIRELESSSALES@PERFECT-VISION.COM
	SABRE INDUSTRIES, INC.
CONTACT	ANGIE WELCH
PHONE	(866) 428-6937
EMAIL	AKWELCH@SABREINDUSTRIES.COM
WEBSITE	www.sabresitesolutions.com
	SITE PRO 1
CONTACT	PAULA BOSWELL
PHONE	(972) 236-9843
EMAIL	PAULA.BOSWELL@VALMONT.COM
WEBSITE	WWW.SITEPROI.COM



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FOR STATE SPECIFIC DIRECT PHONE NUMBERS VISIT: WWW.CALL811.COM

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	0	7/30/2021	ISSUED FOR CONSTRUCTION	NC	AJH	DX
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10	_					



SITE NAME:

**ENFIELD 4 CT** 535791

400 ECOLOGY RD ENFIELD, CT 06082 HARTFORD COUNTY



Phone: 856.797.0412 Fax: 856.722.1120

BILL OF MATERIALS

SBOM-I

#### PROJECT NOTES

- I. SEE MODIFICATION NOTES
- THE CONTRACTOR SHALL COMPLY WITH ALL APPLICABLE CODES, ORDINANCES, LAWS AND REGULATIONS OF ALL MUNICIPALITIES, UTILITY COMPANIES OR OTHER PUBLIC/GOVERNING AUTHORITIES.
- THE CONTRACTOR SHALL BE RESPONSIBLE FOR OBTAINING ALL PERMITS
  AND INSPECTIONS THAT MAY BE REQUIRED BY ANY FEDERAL, STATE,
  COUNTY OR MUNICIPAL AUTHORITIES.
- THE CONTRACTOR SHALL NOTIFY THE CONSTRUCTION MANAGER, IN WRITING, OF ANY CONFLICTS, ERRORS OR OMISSIONS PRIOR TO THE SUBMISSION OF BIDS OR PERFORMANCE OF WORK.
- 5. THE CONTRACTOR SHALL BE RESPONSIBLE FOR PROTECTING ALL EXISTING SITE IMPROVEMENTS PRIOR TO COMMENCING CONSTRUCTION. THE CONTRACTOR SHALL REPAIR ANY DAMAGE AS A RESULT OF CONSTRUCTION OF THIS FACILITY AT THE CONTRACTOR'S EXPENSE TO THE SATISFACTION OF THE OWNER.
- 6. THE SCOPE OF WORK FOR THIS PROJECT SHALL INCLUDE PROVIDING ALL MATERIALS, EQUIPMENT AND LABOR REQUIRED TO COMPLETE THIS PROJECT. ALL EQUIPMENT SHALL BE INSTALLED IN ACCORDANCE WITH MANUFACTURER'S RECOMMENDATIONS.
- 7. THE CONTRACTOR SHALL VISIT THE PROJECT SITE PRIOR TO SUBMITTING THE BID TO VERIFY THAT THE PROJECT CAN BE CONSTRUCTED IN ACCORDANCE WITH THE CONTRACT DOCUMENTS AND CONSTRUCTION DRAWINGS.
- 8. THE CONTRACTOR SHALL VERIFY ALL EXISTING DIMENSIONS AND CONDITIONS PRIOR TO COMMENCING ANY WORK. ALL DIMENSIONS OF EXISTING CONSTRUCTION SHOWN ON THESE DRAWINGS MUST BE VERIFIED. THE CONTRACTOR SHALL NOTIFY THE CONSTRUCTION MANAGER OF ANY DISCREPANCIES PRIOR TO ORDERING MATERIAL OR PROCEEDING WITH CONSTRUCTION.
- 9. SINCE THE CELL SITE MAY BE ACTIVE, ALL SAFETY PRECAUTIONS MUST BE TAKEN WHEN WORKING AROUND HIGH LEVELS OF ELECTROMAGNETIC RADIATION. EQUIPMENT SHOULD BE SHUTDOWN PRIOR TO PERFORMING ANY WORK THAT COULD EXPOSE THE WORKERS TO DANGER. PERSONAL RF EXPOSURE MONITORS ARE REQUIRED TO BE WORN TO ALERT OF ANY POTENTIALLY DANGEROUS EXPOSURE LEVELS.
- NO NOISE, SMOKE, DUST OR ODOR WILL RESULT FROM THIS FACILITY AS TO CAUSE A NUISANCE.
- THE FACILITY IS UNMANNED AND NOT FOR HUMAN HABITATION (NO HANDICAP ACCESS IS REQUIRED).

#### **GENERAL NOTES**

- THESE MODIFICATIONS HAVE BEEN DESIGNED IN ACCORDANCE WITH THE GOVERNING PROVISIONS OF THE TELECOMMUNICATIONS INDUSTRY STANDARD TIA-222-H. MATERIALS AND SERVICES PROVIDED BY THE CONTRACTOR SHALL CONFORM TO THE ABOVE MENTIONED CODES.
- CONTRACTOR SHALL TAKE ALL PRECAUTIONS NECESSARY TO PREVENT DAMAGE TO EXISTING STRUCTURES. ANY DAMAGE TO EXISTING STRUCTURES AS A RESULT OF THE CONTRACTOR'S WORK OR FROM DAMAGE DUE TO OTHER CAUSES SHALL BE REPAIRED AT THE CONTRACTOR'S EXPENSE TO THE SATISFACTION OF THE OWNER.
- 3. CONTRACTOR SHALL VERIFY ALL DIMENSIONS AND EXISTING CONDITIONS BEFORE BEGINNING WORK, ORDERING MATERIAL, AND PREPARING OF SHOP DRAWINGS. ANY DISCREPANCIES BETWEEN FIELD CONDITIONS AND THE CONTRACT DOCUMENTS SHALL BE BROUGHT TO THE IMMEDIATE ATTENTION OF THE ENGINEER. IF THE CONTRACTOR DISCOVERS ANY EXISTING CONDITIONS THAT ARE NOT REPRESENTED ON THESE DRAWINGS, OR ANY CONDITIONS THAT WOULD INTERFERE WITH THE INSTALLATION OF THE MODIFICATIONS, NOTIFY THE ENGINEER IMMEDIATELY.
- IT IS ASSUMED THAT ANY STRUCTURAL MODIFICATION WORK SPECIFIED ON THESE PLANS WILL BE ACCOMPLISHED BY KNOWLEDGEABLE WORKMEN WITH TOWER CONSTRUCTION EXPERIENCE.
- THE CONTRACTOR SHALL SUPERVISE AND DIRECT THE WORK AND SHALL BE SOLELY RESPONSIBLE FOR ALL CONSTRUCTION METHODS, MEANS, TECHNIQUES, SEQUENCES, AND PROCEDURES.
- 6. ALL CONSTRUCTION MEANS AND METHODS; INCLUDING BUT NOT LIMITED TO, ERECTION PLANS, RIGGING PLANS, CLIMBING PLANS, AND RESCUE PLANS SHALL BE THE RESPONSIBILITY OF THE GENERAL CONTRACTOR RESPONSIBLE FOR THE EXECUTION OF THE WORK CONTAINED HEREIN AND SHALL MEET ANSI/TIA-322 (LATEST EDITION), OSHA, AND GENERAL INDUSTRY STANDARDS. ALL RIGGING PLANS SHALL ADHERE TO ANSI/TIA-322 (LATEST EDITION) INCLUDING THE REQUIRED INVOLVEMENT OF A QUALIFIED ENGINEER FOR CLASS IV CONSTRUCTION.
- THE CONTRACTOR IS SOLELY RESPONSIBLE FOR INITIATING, MAINTAINING, AND SUPERVISING ALL SAFETY PROGRAMS IN ACCORDANCE WITH APPLICABLE SAFETY CODES.
- WORK SHALL ONLY BE PERFORMED DURING CALM DRY DAYS (WINDS LESS THAN 30-MPH). THE STRUCTURE SHOWN ON THE DRAWINGS IS STRUCTURALLY SOUND ONLY IN THE COMPLETED FORM. THE CONTRACTOR SHALL BE RESPONSIBLE FOR THE STRENGTH AND STABILITY

- OF THE STRUCTURE DURING ERECTION. CONTRACTOR SHALL PROVIDE TEMPORARY SUPPORT, SHORING, BRACING AND ANY OTHER STRUCTURAL SYSTEMS AS REQUIRED TO RESIST ALL FORCES THAT MAY OCCUR DURING HANDLING AND ERECTION UNTIL THE STRUCTURE IS FULLY COMPLETED. TEMPORARY SUPPORTS, BRACING AND OTHER STRUCTURAL SYSTEMS REQUIRED DURING CONSTRUCTION SHALL REMAIN THE CONTRACTOR'S PROPERTY AFTER THEIR USE.
- ALL INSTALLATIONS PERFORMED ON THIS STRUCTURE SHALL BE COMPLETED IN ACCORDANCE WITH THE GOVERNING PROVISIONS OF THE STANDARD FOR INSTALLATION, ALTERATION AND MAINTENANCE OF ANTENNA SUPPORTING STRUCTURES AND ANTENNAS, ANSI/TIA-322.
- 10. CONTRACTOR SHALL SECURE SITE BACK TO EXISTING CONDITION UNDER SUPERVISION OF OWNER. ALL FENCE, STONE, GEOFABRIC, GROUNDING, AND SURROUNDING GRADE SHALL BE REPLACED AND REPAIRED AS REQUIRED TO ACHIEVE OWNER APPROVAL. POSITIVE DRAINAGE AWAY FROM TOWER SITE SHALL BE MAINTAINED.
- II. CONNECTIONS BETWEEN ITEMS SUPPORTED BY THE STRUCTURE AND THE STRUCTURE NOT SPECIFICALLY DETAILED IN THE CONTRACT DOCUMENTS ARE THE RESPONSIBILITY OF THE CONTRACTOR. SUCH CONNECTIONS SHALL BE DESIGNED, COORDINATED AND INSPECTED BY A PROFESSIONAL STRUCTURAL ENGINEER LICENSED IN THE STATE OF THE PROJECT. SUBMIT SIGNED AND SEALED CALCULATIONS DURING SHOP DRAWING REVIEW.
- 12. DO NOT SCALE DRAWINGS.
- 13. DO NOT USE THESE DRAWINGS FOR ANY OTHER SITE.
- 14. ALL MATERIAL UTILIZED FOR THIS PROJECT MUST BE NEW AND FREE OF ANY DEFECTS. ANY MATERIAL SUBSTITUTIONS, INCLUDING BUT NOT LIMITED TO ALTERED SIZE AND/OR STRENGTHS, MUST BE APPROVED BY THE OWNER AND ENGINEER IN WRITING.
- 15. THE MOUNT UNDER NO CIRCUMSTANCES SHOULD BE USED AS A TIE OFF POINT

#### STRUCTURAL STEEL

- I. DESIGN, DETAILING, FABRICATION AND ERECTION OF STRUCTURAL STEEL SHALL CONFORM TO THE FOLLOWING PUBLICATIONS EXCEPT AS SPECIFICALLY INDICATED IN THE CONTRACT DOCUMENTS.
  - a. AMERICAN INSTITUTE OF STEEL CONSTRUCTION (AISC) MANUAL OF STEEL CONSTRUCTION (15TH EDITION)
  - b. SPECIFICATION FOR STRUCTURAL JOINTS USING ASTM A325 OR A490 BOLTS
  - c. AISC CODE OF STANDARD PRACTICE
- STRUCTURAL STEEL SHALL CONFORM TO THE FOLLOWING UNLESS OTHERWISE SHOWN:

CHANNELS, ANGLES, PLATES, ETC. ASTM A36 (GR 36)
STEEL PIPE ASTM A53 (GR 35)
BOLTS ASTM A325
NUTS ASTM A563

LOCK WASHERS LOCKING STRUCTURAL GRADE

- 3. ALL SUBSTITUTIONS PROPOSED BY THE CONTRACTOR SHALL BE APPROVED IN WRITING BY THE ENGINEER. CONTRACTOR SHALL PROVIDE DOCUMENTATION TO ENGINEER FOR VERIFYING THE SUBSTITUTE IS SUITABLE FOR USE AND MEETS ORIGINAL DESIGN CRITERIA. DIFFERENCES FROM THE ORIGINAL DESIGN, INCLUDING MAINTENANCE, REPAIR AND REPLACEMENT, SHALL BE NOTED. ESTIMATES OF COSTS/CREDITS ASSOCIATED WITH THE SUBSTITUTION (INCLUDING RE-DESIGN COSTS AND COSTS TO SUB-CONTRACTORS) SHALL BE PROVIDED TO THE ENGINEER. CONTRACTOR SHALL PROVIDE ADDITIONAL DOCUMENTATION AND/OR SPECIFICATIONS TO THE ENGINEER AS REQUESTED.
- PROVIDE STRUCTURAL STEEL SHOP DRAWINGS TO ENGINEER FOR APPROVAL PRIOR TO FABRICATION.
  - a. SUBMIT SHOP DRAWINGS TO
    PETER.ALBANO@COLLIERSENGINEERING.COM
  - b. PROVIDE MASER CONSULTING PROJECT # AND MASER CONSULTING PROJECT ENGINEER CONTACT IN THE BODY OF THE EMAIL.
- DRILL NO HOLES IN ANY NEW OR EXISTING STRUCTURAL STEEL MEMBERS
  OTHER THAN THOSE SHOWN ON STRUCTURAL DRAWINGS WITHOUT THE
  APPROVAL OF THE ENGINEER OF RECORD.
- 6. GALVANIZED ASTM A325 BOLTS SHALL NOT BE REUSED.
- ALL NEW STEEL SHALL BE HOT BE DIPPED GALVANIZED FOR FULL WEATHER PROTECTION. IN ADDITION ALL NEW STEEL SHALL BE PAINTED TO MATCH EXISTING STEEL. CONTRACTOR SHALL OBTAIN WRITTEN PERMISSION TO PROTECT STEEL BY ANY OTHER MEANS.
- ALL BOLT ASSEMBLIES FOR STRUCTURAL MEMBERS REPRESENTED IN THIS
  DRAWING REQUIRE LOCKING DEVICES TO BE INSTALLED IN ACCORDANCE
  WITH TIA-222-H SECTION 4.9.2 REQUIREMENTS.
- WHERE CONNECTIONS ARE NOT FULLY DETAILED ON THESE DRAWINGS, FABRICATOR SHALL DESIGN CONNECTIONS TO RESIST LOADS AND FORCES WHERE SHOWN ON DRAWINGS AND AS OUTLINED IN SPECIFICATIONS.
   FOR MEMBERS BEING REPLACED, PROVIDE NEW BOLTS AND MATCH EXISTING

SIZE AND GRADE. MAINTAIN AISC REQUIREMENTS FOR MINIMUM BOLT

- DISTANCE AND SPACING.

  11. ALL PROPOSED AND/OR REPLACED BOLTS SHALL BE OF SUFFICIENT LENGTH SUCH THAT THE END OF THE BOLT IS AT LEAST FLUSH WITH THE FACE OF THE NUT. IT IS NOT PERMITTED FOR THE BOLT END TO BE BELOW THE FACE OF THE NUT AFTER TIGHTENING IS COMPLETED.
- 12. GALVANIZED ASTM A325 BOLTS SHALL NOT BE REUSED.


- 13. ALL NEW STEEL SHALL BE HOT BE DIPPED GALVANIZED FOR FULL WEATHER PROTECTION. CONTRACTOR SHALL OBTAIN WRITTEN PERMISSION TO PROTECT STEEL BY ANY OTHER MEANS.
- 14. ALL EXISTING PAINTED/GALVANIZED SURFACES DAMAGED DURING REHAB INCLUDING AREAS UNDER STIFFENER PLATES SHALL BE WIRE BRUSHED CLEAN, REPAIRED BY COLD GALVANIZING (ZINGA OR ZINC COTE), AND REPAINTED TO MATCH THE EXISTING FINISH (IF APPLICABLE).
- ALL HOLES IN STEEL MEMBERS SHALL BE SIZED 1/16" LARGER THAN THE BOLT DIAMETER. STANDARD HOLES SHALL BE USED UNLESS NOTED OTHERWISE.

#### **WELDING NOTES**

- ALL WELDING SHALL BE DONE IN ACCORDANCE WITH AWS D1.0 (LATEST EDITION). THIS SHALL INCLUDE A CERTIFIED WELD INSPECTION (CWI) FOR ACCEPTANCE OR REJECTION OF ALL WELDING OPERATIONS, PRE, DURING, AND POST INSTALLATION. USING THE ACCEPTANCE CRITERIA OF AWS D1.1
- CONTRACTOR IS RESPONSIBLE FOR COMMISSIONING A THIRD PARTY CERTIFIED WELD INSPECTOR (CWI) THROUGHOUT THE ENTIRETY OF THE PROJECT. A PASSING CWI REPORT SHALL BE PROVIDED TO THE ENGINEER UPON COMPLETION OF THE PROJECT.
- 3. THE CERTIFIED WELD INSPECTOR SHALL INDICATE, IN A WRITTEN CWI REPORT, THAT ALL WELDING OPERATIONS PRE, DURING, AND POST INSTALLATION WERE CONDUCTED IN ACCORDANCE WITH AWS DI.I WITH PHOTOGRAPHS AND DOCUMENTATION SUPPORTING THE ACCEPTANCE OR REJECTION OF ALL WELDING. ALL CWI WELD INSPECTION DOCUMENTATION AND PHOTOS SHALL BE SUBMITTED DURING THE PMI.
- 4. IN CASES WHERE A WELD IS SPECIFIED BETWEEN TWO MEMBERS IN WHICH THERE IS A GAP IN BETWEEN, THE WELD IS TO BE BUILT-UP SUCH THAT THE SIZE OF WELD ON THE MEMBER IS EQUAL TO THAT SHOWN IN THE DRAWINGS
- OXY FUEL GAS WELDING OR BRAZING IS STRICTLY PROHIBITED.
   SPECIFICALLY, NO TORCH CUTTING IS PERMITTED ON SITE. ALL HOLES SHALL BE CUT WITH A GRINDER.
- CONTRACTOR SHALL EXERCISE CAUTION WHEN WELDING A GALVANIZED SURFACE.

	BOLT SCHEDULE (IN.)						
BOLT DIAMETER	STANDARD HOLE	SHORT SLOT	MIN. EDGE DISTANCE	SPACING			
1/2	9/16	9/16 x 11/16	7/8	I I/2			
5/8	11/16	11/16 x 7/8	1 1/8	I 7/8			
3/4	13/16	13/16 x 1	1 1/4	2 1/4			
7/8	15/16	15/16 x 1 1/8	1 1/2	2 5/8			
1	1 1/16	1 1/16 x 1 5/16	I 3/4	3			


WORKABLE GAGES (IN.)				
LEG	GAGE			
4	2 1/2			
3 1/2	2			
3	I 3/4			
2 1/2	I 3/8			
2	I I/8			

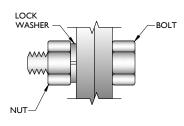

TYP. BOLT ASSEMBLY

NOTE

- I. ALL DIMENSIONS REPRESENTED IN THE ABOVE TABLES ARE AISC MINIMUM REQUIREMENTS. CONTRACTOR SHALL VERIFY EXISTING CONDITIONS IN FIELD AND NOTIFY ENGINEER IF DISTANCES ARE LESS THAN THOSE PROVIDED.
- 2. THE DIMENSIONS PROVIDED ARE MINIMUM REQUIREMENTS. ACTUAL DIMENSIONS OF PROPOSED MEMBERS WITHIN THESE DRAWINGS MAY VARY FROM THE AISC MINIMUM REQUIREMENTS.
- SHORT SLOT HOLES SHALL ONLY BE USED WHEN DEPICTED IN THE DRAWINGS
- MATCH EXISTING GAGES WHEN APPLICABLE, UNLESS MINIMUM EDGE DISTANCES ARE COMPROMISED.

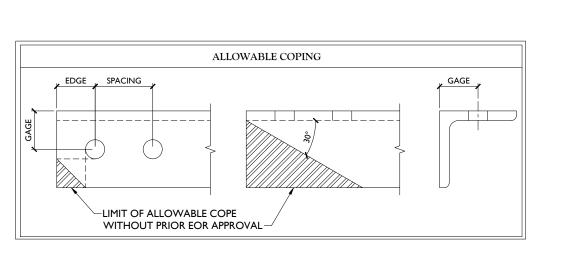



WILL BE KNOWN AS COLLIERS ENGINEERING & DESIGN IN
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- NEW JERSEY ■ NEW YORK
- PENNSYLVANIA VIRGINIA

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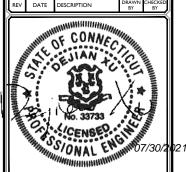
EXCAVATORS DESIGNERS, OR ANY FERPREPARING TO DISTURB THE PARTH

SURFACE ANYWHERE IN ANY STATE

What's Delow.

Bloom of the providing.

FOR STATE SPECIFIC DIRECT PHONE NUMBERS VISIT:



IT IS A VIOLATION OF LAW FOR ANY PERSON, UNLESS THEY ARE ACTING UNDER THE DIRECTIC OF THE RESPONSIBLE LICENSED PROFESSIONAL ENGINEER, TO ALTER THIS DOCUMENT.

SITE NAME:

ENFIELD 4 CT 535791

400 ECOLOGY RD ENFIELD, CT 06082 HARTFORD COUNTY





MT. LAUREL OFFICE
2000 Midlantic Drive
Suite 100
Mount Laurel, NJ 08054
Phone: 856.797.0412
Fax: 856.721.1120

MODIFICATION NOTES

SGN-1

NOTE: DO NOT SCALE DRAWINGS FOR CONSTRUCTION

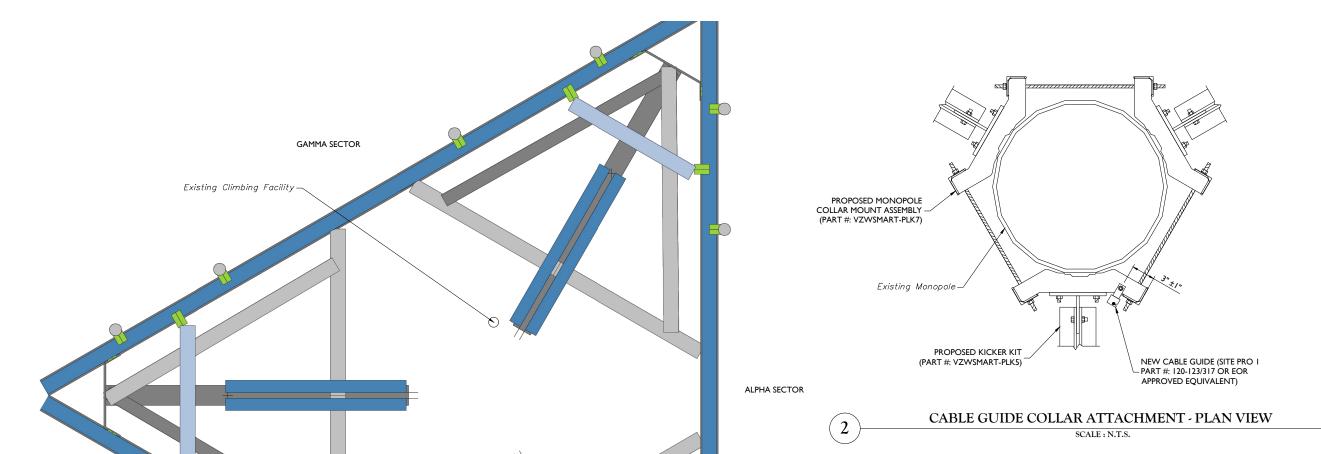

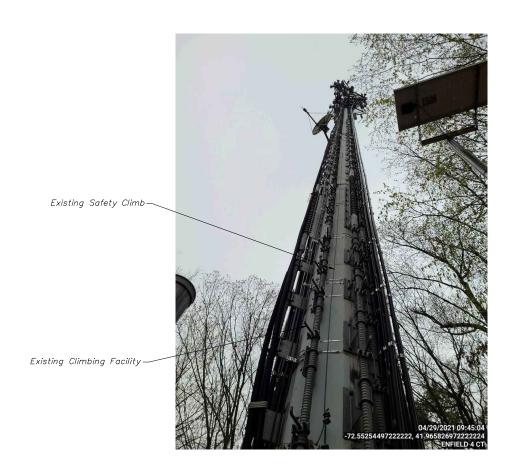

CLIMBING FACILITY PHOTO



CLIMBING FACILITY DETAIL

SCF-I

CLIMBING FACILITY LOCATION

BETA SECTOR

#### STRUCTURAL NOTES:

- I. PER THE MOUNT MAPPING COMPLETED BY ROAMING NETWORKS INC. ON 5/6/2021, THE SAFETY CLIMB AND CLIMBING FACILITIES UP TO THE VERIZON MOUNT ELEVATION (124'-6") ARE IN GOOD CONDITION. MASER DOES NOT WARRANT THIS INFORMATION.
- INSTALL SHALL NOT CAUSE HARM TO THE STRUCTURE, CLIMBING FACILITY, SAFETY CLIMB, OR ANY SYSTEM INSTALLED ON THE STRUCTURE. TIMELY NOTICE AND DOCUMENTATION SHALL BE PROVIDED BY CONTRACTORS TO THE EOR (OF STRUCTURAL DESIGN) IF AN OBSTRUCTION WAS REQUIRED TO MEET THE RF SYSTEM DESIGN REQUIREMENTS AND PERFORMANCES.



LEGEND:	
	PROPOSED
	RELOCATED
	EXISTING

MOUNT MODIFICATION SCHEDULE						
NO.	ELEVATION	QUANTITY	DESCRIPTION	NOTES	MASER O	
ı		ı	PROPOSED SUPPORT RAIL KIT (PART #: VZWSMART-PLKI)	CONTRACTOR TO VERIFY THE LENGTH REQUIRED AND TRIM AS NECESSARY IN ACCORDANCE WITH THE 'STRUCTURAL STEEL' NOTES ON SHEET SGN-I. RADIO AND/OR TME POSITIONS SHALL BE ADJUSTED VERTICALLY AS NEEDED IN ORDER TO ACHIEVE INSTALLATION OF HORIZONTAL AS SHOWN. EOR SHALL BE NOTIFIED IF EQUIPMENT NEEDS TO BE RELOCATED TO ANOTHER MOUNT PIPE.	Customer Loyalty through www.masercons Office Locatio  NEW JERSEY NEW YORK PENNSYLVANIA VIRGINIA	
2		I	PROPOSED KICKER KIT (PART #: VZWSMART-PLK5)	CONTRACTOR TO VERIFY THE LENGTH REQUIRED AND TRIM AS NECESSARY IN ACCORDANCE WITH THE 'STRUCTURAL STEEL' NOTES ON SHEET SGN-1. CONNECT OTHER END OF KICKER KIT TO MONOPOLE COLLAR MOUNT ASSEMBLY (PART #: VZWSMART-PLK7).	■ FLORIDA ■ NORTH CAROLINA ■ SOUTH CAROLINA MASER Copyright © 2021. Maser Cons@@NSULTINGG	
3					contained herein is authorized for us only by the party of to whom it is certified. This drawing may not be copied, upon for any other purpose without the express wri	
4	124'-6"					
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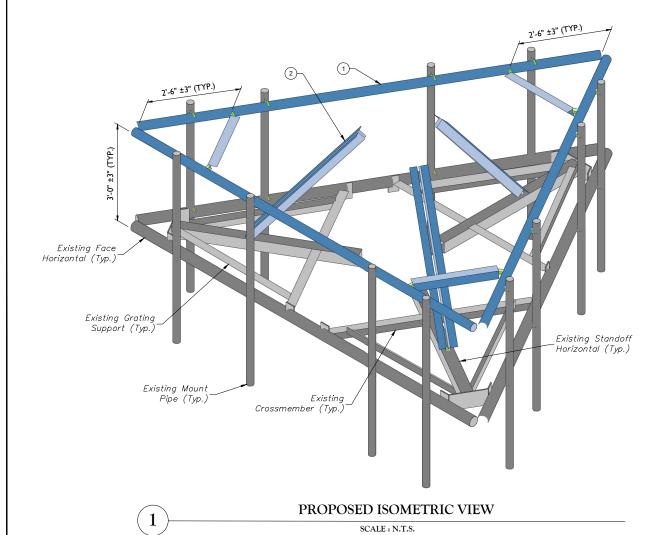
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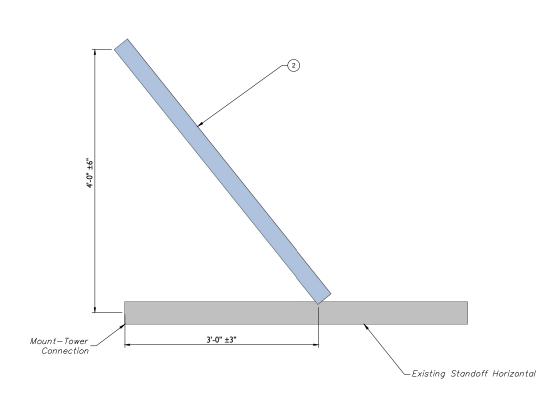
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—CONNECTICUT—

NOTES.

MOUNT MEMBERS NOT SHOWN FOR CLARITY U.N.O.





PROPOSED SIDE ELEVATION VIEW (TYP. ALL SECTORS) SCALE: N.T.S.

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AS SHOWN

REV DATE DESCRIPTION

21777518A

SITE NAME:

ENFIELD 4 CT 535791

400 ECOLOGY RD ENFIELD, CT 06082 HARTFORD COUNTY



Phone: 856.797.0412 Fax: 856.722.1120

MODIFICATION DETAILS

SS-I




MOUNT PHOTO 1



MOUNT PHOTO 3



MOUNT PHOTO 2

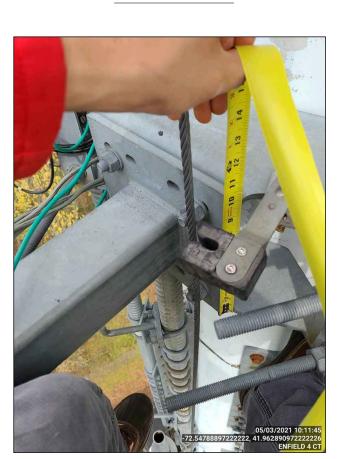


**MOUNT PHOTO 4** 



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	SCALE :	AS SHO\	WN	JOB NUMBER: 21777518A		
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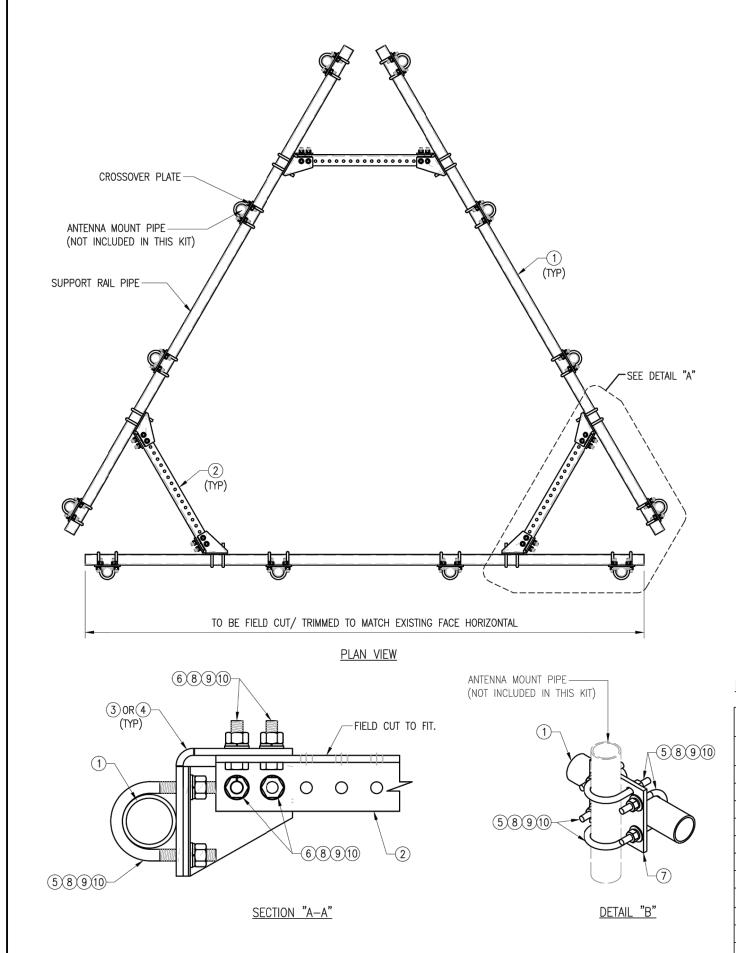
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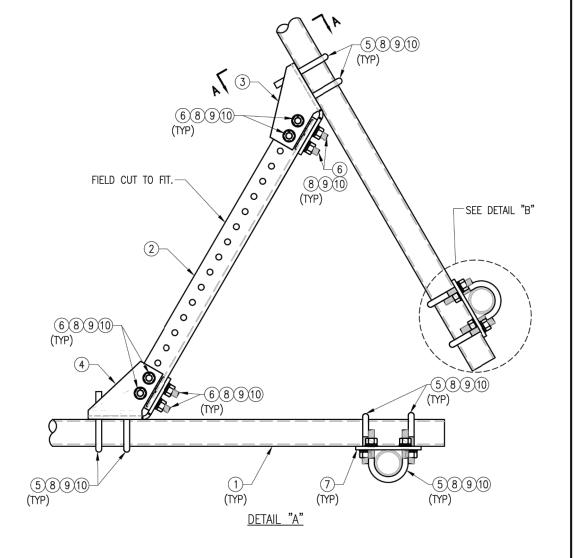
400 ECOLOGY RD ENFIELD, CT 06082 HARTFORD COUNTY

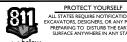

MOUNT PHOTOS

SS-2





## NOTES: 1. HOT-DIPPED GALVANIZED PER ASTM A123.

	VZW SMART-PLK1 (SUPPORT RAIL KIT)						
ITEM NO.	QTY.	PART NO.	DESCRIPTION	SHEET #	WT		
1	3	PST2875-12.5	2.5" PST (2.875" O.D. X 0.203" THK.) X 12'-6" A53 GR-B	PLK1-F1	292		
2	3	L33375-3	L 3" X 3" X 3/8" X 3'-0" A36	PLK1-F1	66		
3	3	CBP-L	CORNER BENT PLATE BRACKET	PLK1-F2	28		
4	3	CBP-R	CORNER BENT PLATE BRACKET	PLK1-F2	28		
5	60	MS02-625-300-500	RU-BOLT 5/8" X 3" I.W. X 5" I.L. A36 (OR EQUIV.)	RBC-1	82		
6	24		BOLT 5/8" X 2" A325		9		
7	12	PL375-857	PL 3/8" X 8 1/2" X 7'-0" A36	PLK1-F3	77		
8	144	FW-625	5/8" HDG USS FLAT WASHER		12		
9	144	LW-625	5/8" HDG LOCK WASHER		3		
10	144	NUT-625	5/8" HDG HEX NUT		17		
	GALVANIZED WT 504						


## VzW SMART Tool<sup>©</sup> Vendor

## verizon

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HEET TITLE:					
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VZWSMART-PLK1 SUPPORT RAIL KIT

SHEET NUMBER:	REV #:
VZWSMART-PLK1	0

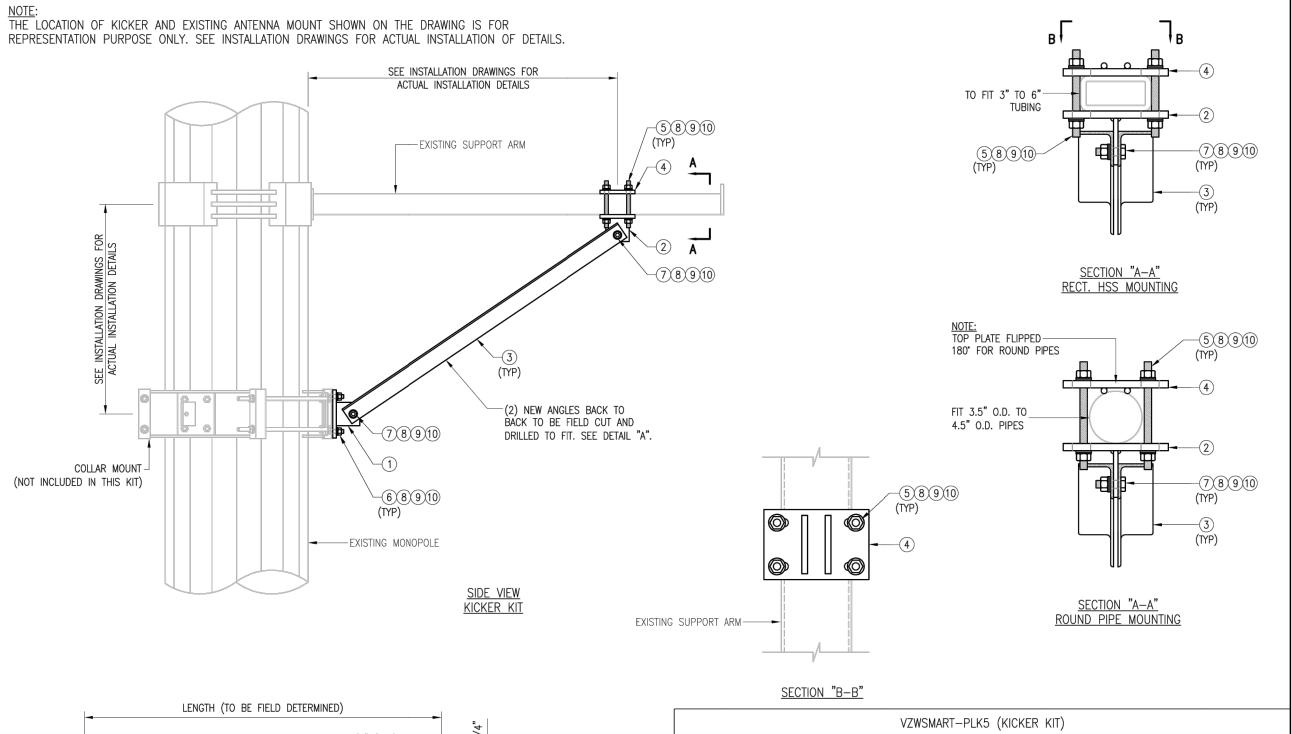

L-	LENGTH (TO BE FIELD DETERI	MINED)		
		1 1/8" (TYP)		1 3/4"
<b>•</b>			•	, ž
	DETAIL "A"			D DRILL 16"ø HOLE

#### NOTES:

- 1. ALL HOLES ARE 11/16" DIA. U.N.O
- 2. HOT-DIPPED GALVANIZED PER ASTM A123.
- 3. FIT UP TO 6" SQ. TUBING OR 4 1/2" O.D. PIPE


	VZWSMART-PLK5 (KICKER KIT)					
ITEM NO.	QTY.	PART NO.	DESCRIPTION	SHEET #	WT	
1	3	BRKW-XXX	BRACKET WELDMENT A36	PLK5-F3	43.8	
2	3	BRKW-XXXX	BRACKET WELDMENT A36	PLK5-F2	35.7	
3	6	L331875-8	L 3" X 3" X 3/16" X 8'-0" A36	PLK5-F4	182.9	
4	3	PL-KI	PL 5/8" X 6" X 9" A36	PLK5-F1	29.0	
5	12		THREADED ROD 5/8" DIA. X 1'-0" F1554-36 HDG			
6	6		BOLT 5/8" X 2" A325			
7	12		BOLT 5/8" X 2 1/2" A325			
8	42	FW-625	5/8" HDG USS FLAT WASHER		3	
9	42	LW-625	5/8" HDG LOCK WASHER		1	
10	42	NUT-625	5/8" HDG HEX NUT		5	
				GALVANIZED WT	291	


## VzW SMART Tool<sup>©</sup> Vendor

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. — –	RT-PLK5
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SHEET NUMBER:	REV #:
VZWSMART-PLK5	0



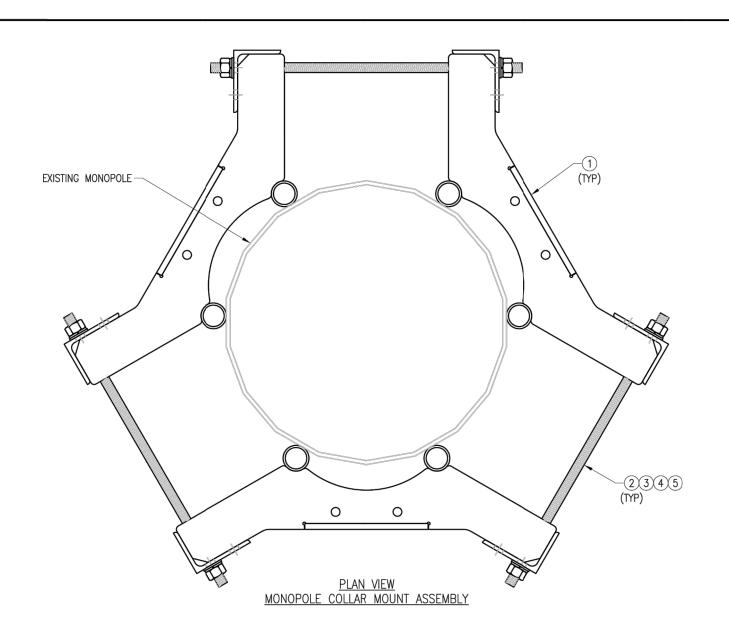

# NOTES: 1. FIT 12" TO 45" DIA MONOPOLE. 2. HOT-DIPPED GALVANIZED PER ASTM A123.
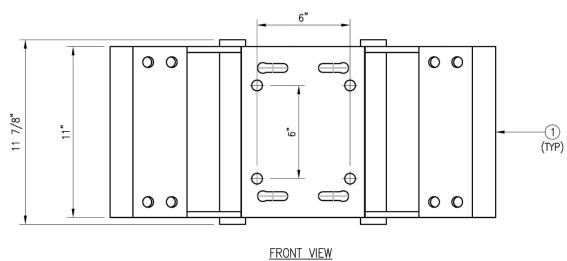
### VZWSMART-PLK7 (MONOPOLE COLLAR MOUNT ASSEMBLY)

ITEM NO.	QTY.	PART NO.	DESCRIPTION	SHEET #	WT	
1	3	CM-1245	COLLAR MOUNT ASSEMBLY	PLK7-F1	147	П
2	6		THREADED ROD 5/8" X 4'-0" A193-B7			l
3	12	FW-625	5/8" HDG USS FLAT WASHER		1	l
4	12	LW-625	5/8" HDG LOCK WASHER		0	
5	12	NUT-625	5/8" HDG HEX NUT		1	
			GAL	VANIZED WT	150	

## VzW SMART Tool® Vendor

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DRAWN BY: BT	CHECKED BY: HMA/KW		
REV. DESCRIPTION  FIRST ISSUE		BY BT	DATE 05/11/20
SHEET TITLE:			

VZWSMART-PLK7 MONOPOLE COLLAR MOUNT ASSEMBLY

SHEET NUMBER:	REV #:
VZWSMART-PLK7	0