3009 FEDERAL HILL DRIVE FALLS CHURCH, VIRGINIA 22044 phone 703.533.1006

EM-SPRINT-045-110318

March 14, 2011

Chairman Daniel F. Caruso Connecticut Siting Council 10 Franklin Square New Britain, CT 06501 TOTAL COLUMN TO THE PART OF TH

SUBJECT:

Sprint Spectrum L.P.'s Notice of Intent to Make an Exempt Modification to an

Existing Facility at 93 Roxbury Road, East Lyme, CT 06333

(Site # CT03XC110)

Dear Chairman Caruso:

Pursuant to R.C.S.A. Sections 16-50j-73 and 16-50j-72(b), Sprint Spectrum L.P. (Sprint) hereby gives notice to the Connecticut Siting Council (Council) and the Town of East Lyme of its intent to make an exempt modification to an existing telecommunications facility located at 93 Roxbury Road, East Lyme, Connecticut

Sprint plans to install a hydrogen fuel cell at its 93 Roxbury Road facility to provide emergency backup power in the event of an electric outage. This planned installation does not constitute a modification subject to the Council's review as it falls within those activities provided for in R.C.S.A. Section 16-50j-72(b)(2). Specifically, this installation will not change the height of the existing tower, will not extend the boundaries of the existing compound, will not increase noise levels at the site by six decibels or more, and will not increase the total radio frequency electromagnetic radiation power density at the site to levels above applicable standards.

PROPOSED INSTALLATION

Sprint plans to install a 4kW ReliOn hydrogen fuel cell generator within the existing fenced equipment compound; the entire installation mounted to a new 9'0" x 6'0" concrete pad. The fuel cell will be inside a cabinet measuring 3'4" x 2'4" x 6'0". There will also be four cabinets with dimensions of 4'8" x 4'8" x 6'0", each cabinet houses four hydrogen cylinders.

Please contact me at 703.533.1006 should you have any questions about this planned modification.

Sincerely,

Mark Mulshart Principal

cc: Paul M. Formica, First Selectman, Town of East Lyme (property owner and town representative)

ERONOR 21:3W/Ontologr Solution






Features:

- T-2000® Outdoor Solution
- Ideal for site loads ranging from 0 4kW
 - Simple installation
 - Minimal site footprint
- Modular fuel storage solutions available for extended run capabilities

Dimensions (w x d x h)	h) 27.5" x 41" x 72" (70 cm x 104 cm x 183 cm)	
Weight	654 lbs / 297.3 kg without cylinders	
Rated net power	0 to 4,000 Watts	
Rated current	0 to 160A @ 24 VDC / 0 to 80A @ 48 VDC	
DC voltage	24 or 48 VDC nominal	
Fuel Composition	Standard industrial grade hydrogen (99.95%)	
Supply pressure to unit	3.5 to 6 psig / 24 to 41 KPag / 0.24 bar to 0.41 bar	
Fuel Consumption	60 slpm @ 4,000 Watts	
Hydrogen Storage Capacity	Modular fuel storage solutions available	
Ambient temperature	-40°F to 115°F / -40°C to 46°C	
Relative humidity	0 to 95% non-condensing	
Altitude	-197 ft to 13,800 ft / -60m to 4,206m	
Location	Outdoors	
Safety Compliance	UL/CSA/CE/NEBS	
Water emissions	Max. 30mL / kWh	
Noise	47 dBA @ 5 ft	
Remote Monitoring/Control	System configuration & status / Historical & operational data	
Communications	RJ45 / DB9/ Dry Contact	

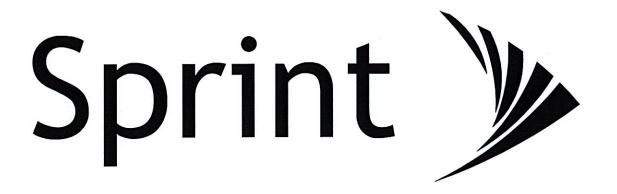

OFFICE: 913-766-4256 MOBILE: 913-486-2550

doainter@relion-inc.com

POWER COMPANY:

PHONE: 800-286-5000 TELCO COMPANY:

COUNTY:

NEW LONDON

41° 20' 4.995" N

41.334721

LATITUDE (NAD83):

LONGITUDE (NAD83): 72° 13' 19.995" W -72.22221

CONTACT ENGINEER:

WORK: 913-458-7343

E-MAIL: hansenbj@bv.com

BRYAN HANSEN

EAST LYME SITE NAME:

CT03XC110 SITE NUMBER:

SITE ADDRESS: 93 ROXBURY ROAD

EAST LYME, CT 06333

EXISTING 150'-0" SELF SUPPORT TOWER SITE TYPE:

Sprint


6580 SPRINT PARKWAY OVERLAND PARK, KANSAS 66251



10950 GRANDVIEW DRIVE OVERLAND PARK, KANSAS 66210 (913) 458-2000

١	PROJECT NO:	168202
1	DRAWN BY:	ASK
1	CHECKED BY:	ВЈН

0 02/25/2011 ISSUED FOR CONSTRUCTION DATE DESCRIPTION

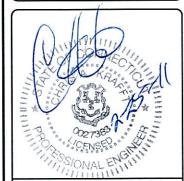

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> EAST LYME CT03XC110 93 ROXBURY ROAD EAST LYME, CT 06333 **CO-LOCATION**

> > SHEET TITLE

TITLE SHEET & **PROJECT DATA**

SHEET NUMBER

T-1

SITE INFORMATION AREA MAP SITE ADDRESS: 93 ROXBURY ROAD EAST LYME, CT 06333 PROPERTY OWNER: CROWN CASTLE 2000 CORPORATE DRIVE REFERENCE: 806384 CAWONSBURG, PA 15317 EQUIPMENT SUPPLIER: 15913 EAST EUCLID AVENUE SPOKANE, WASHINGTON 99216 DARIN PAINTER **DIRECTOR OF SALES**

> LOCATION MAP SOKBURY DO JOHNNY CAKERD

PROJECT DESCRIPTION

INSTALL POWER BACK UP EQUIPMENT TO EXISTING SITE WITHIN EXISTING COMPOUND. INSTALL (1) NEW FUEL CELL WITH (1) FUEL STORAGE CABINET ON CONCRETE PAD AND CONNECT TO THE SITE'S DC POWER PLANT BUS.

APPLICABLE CODES

ALL WORK SHALL COMPLY WITH THE FOLLOWING APPLICABLE

2003 INTERNATIONAL MECHANICAL CODE WITH 2005 STATE OF

2003 INTERNATIONAL PLUMBING CODE WITH 2005 STATE OF

2003 INTERNATIONAL BUILDING CODE WITH 2005 STATE OF

ENGINEER OF RECORD

CHRISTOPHER ALAN KRAFFT PE # 0027383

DRAWING INDEX

TITLE SHEET & PROJECT DATA

EQUIPMENT CABINET DETAILS

HYDROGEN PIPING SCHEMATIC

ELECTRICAL ONE-LINE DIAGRAM

OVERALL CONDUIT DETAILS

FUEL CELL INSTALL DETAIL

ELECTRICAL WIRING DIAGRAM

GROUNDING PLAN AND DETAILS

CONCRETE PAD DETAILS

OVERALL SITE PLAN

SITE PLAN

C-2

S-1

S-2

M-1

E-1

E-3

E-4

G-1

BLACK & VEATCH CORPORATION

GROTON- NEW LONDON AIRPORT: HEAD WEST ON S ROAD/RUNWAY LANE/TOWER AVENUE TOWARDS RHODE ISLAND LANE, CONTINUE TO FOLLOW TOWER AVENUE, TURN RIGHT AT HIGH ROCK ROAD, TURN LEFT AT POQUONNOCK ROAD, TURN RIGHT AT MITCHELL STREET, CONTINUE ONTO NORTH STREET, TAKE THE RAMP ONTO I-95 S, TAKE EXIT 74 FOR CT-161 TOWARDS NIANTIC, TURN RIGHT AT CT-161 S/FLANDERS ROAD, SLIGHT RIGHT AT SOCIETY ROAD, TURN LEFT AT RIVERVIEW ROAD, TURN RIGHT AT

IN THE EVENT OF CONFLICT, THE MOST RESTRICTIVE CODE SHALL


CONNECTICUT MODIFICATIONS

CONNECTICUT MODIFICATIONS

2005 NEC NATIONAL ELECTRICAL CODE

DRIVING DIRECTIONS FROM NEAREST AIRPORT

ROXBURY ROAD, TAKE THE FIRST LEFT TO STAY ON ROXBURY ROAD, SITE IS ON THE RIGHT.

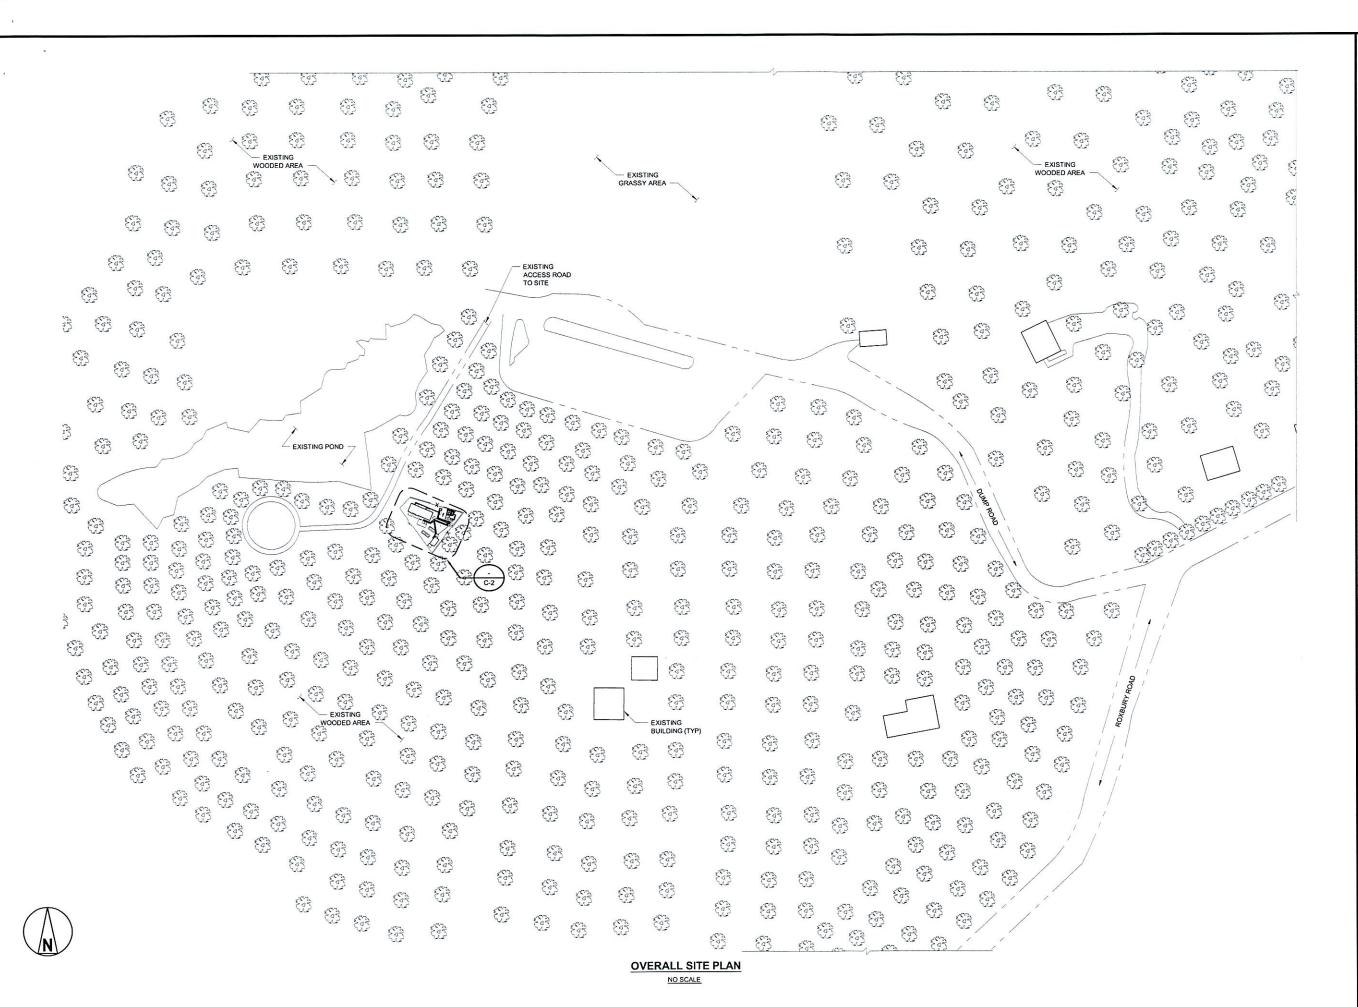





10950 GRANDVIEW DRIVE OVERLAND PARK, KANSAS 66210 (913) 458-2000

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> EAST LYME CT03XC110 93 ROXBURY ROAD EAST LYME, CT 06333 CO-LOCATION

> > SHEET TITLE

OVERALL SITE PLAN

SHEET NUMBER

C-1

GENERAL NOTES:

- CONTRACTOR SHALL GROUND ALL NEW EQUIPMENT TO THE NEAREST GROUND RING (SEE G-1).
- CONTRACTOR SHALL ROUTE CONDUIT TO AVOID TRIP HAZARDS BY EITHER
 UTILIZING EXISTING CABLE TRAY, OVERHEAD ICE BRIDGE, UNDERNEATH RAISED
 PLATFORM, OR AROUND EDGE OF CONCRETE PAD.
- CONTRACTOR SHALL FOLLOW ALL MANUFACTURER'S RECOMMENDATIONS FOR INSTALLATION OF ALL NEW EQUIPMENT.
- 4. CONTRACTOR SHALL VERIFY THE ALARM CABLES ARE OF SUFFICIENT LENGTH.
- 5. EXCESS CABLES SHALL BE LACED IN A NEAT AND ORGANIZED MANNER.
- 6. HYDROGEN STORAGE CABINET HAS A REQUIRED SET BACK OF 15' FROM IGNITION SOURCES & AIR INTAKES.



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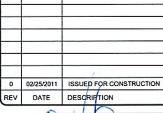


10950 GRANDVIEW DRIVE OVERLAND PARK, KANSAS 66210 (913) 458-2000

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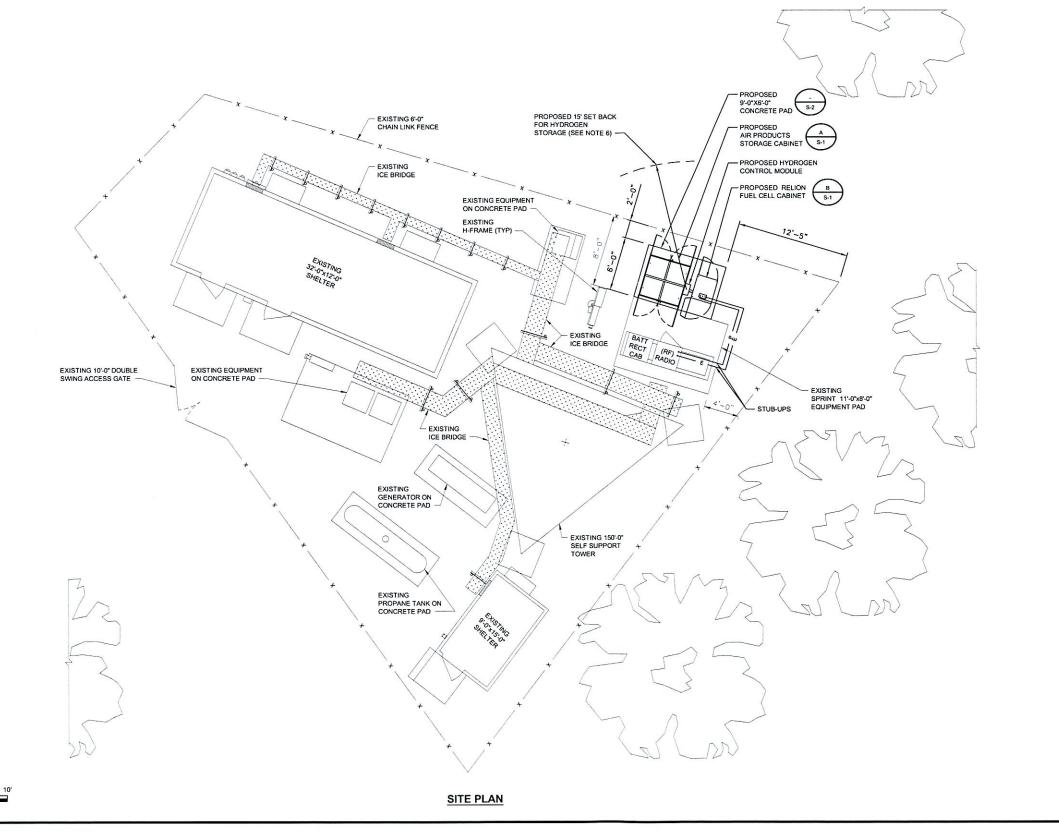



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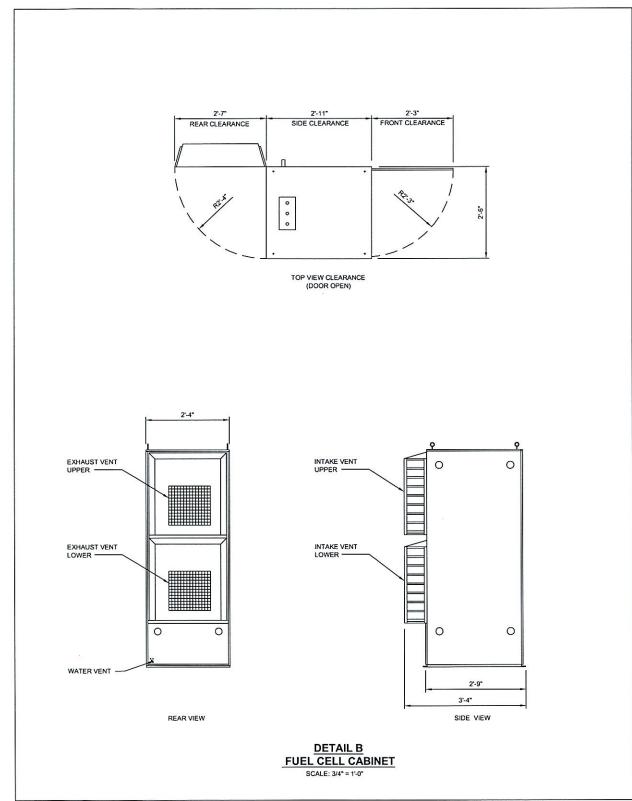
EAST LYME CT03XC110 93 ROXBURY ROAD EAST LYME, CT 06333 CO-LOCATION

SHEET TITLE
SITE PLAN

C-2





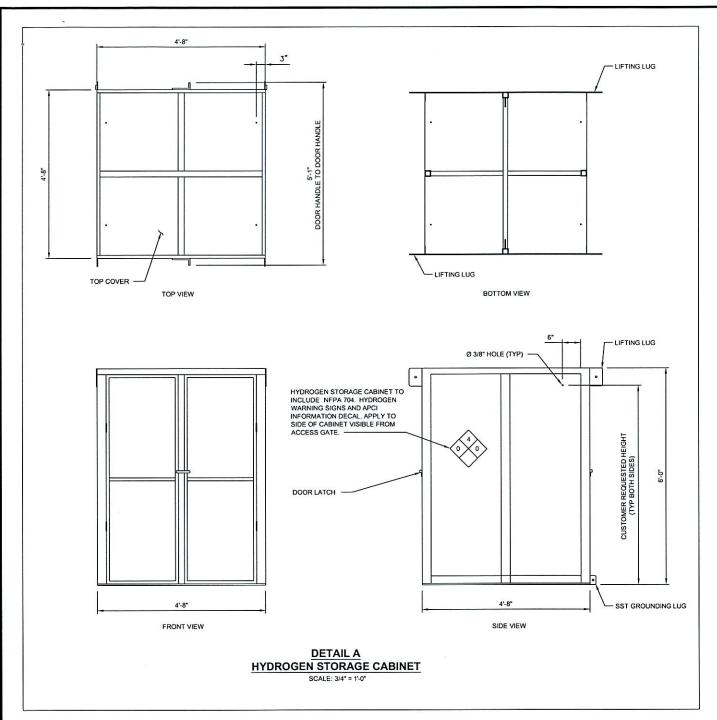





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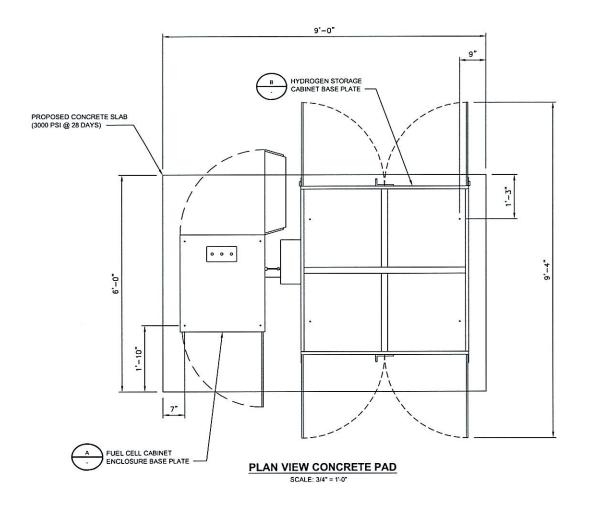
EAST LYME CT03XC110 93 ROXBURY ROAD EAST LYME, CT 06333 CO-LOCATION


SHEET TITLE

EQUIPMENT CABINET DETAILS


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S-1




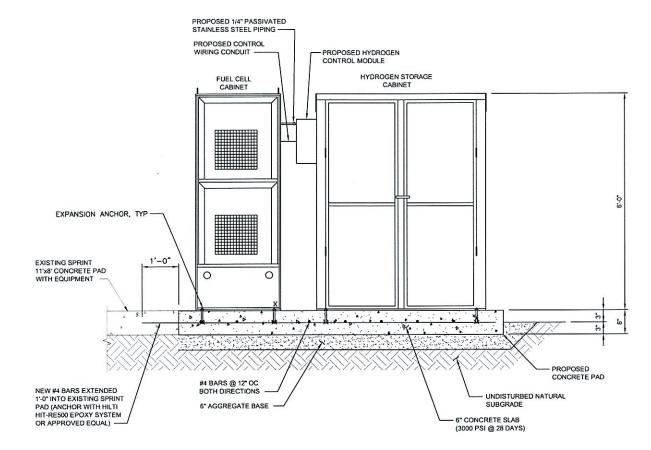

ELEVATION CONCRETE PAD SCALE: 3/4" = 1'-0"

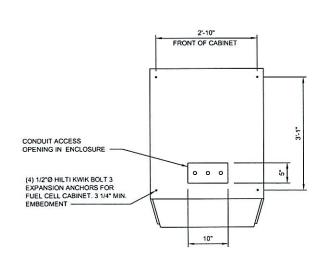

DETAIL A
CABINET
BOLT PATTERN
SCALE: 1" = 1'-0"

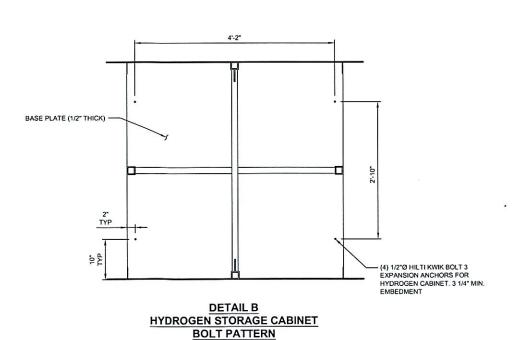

SCALE: 1" = 1'-0"




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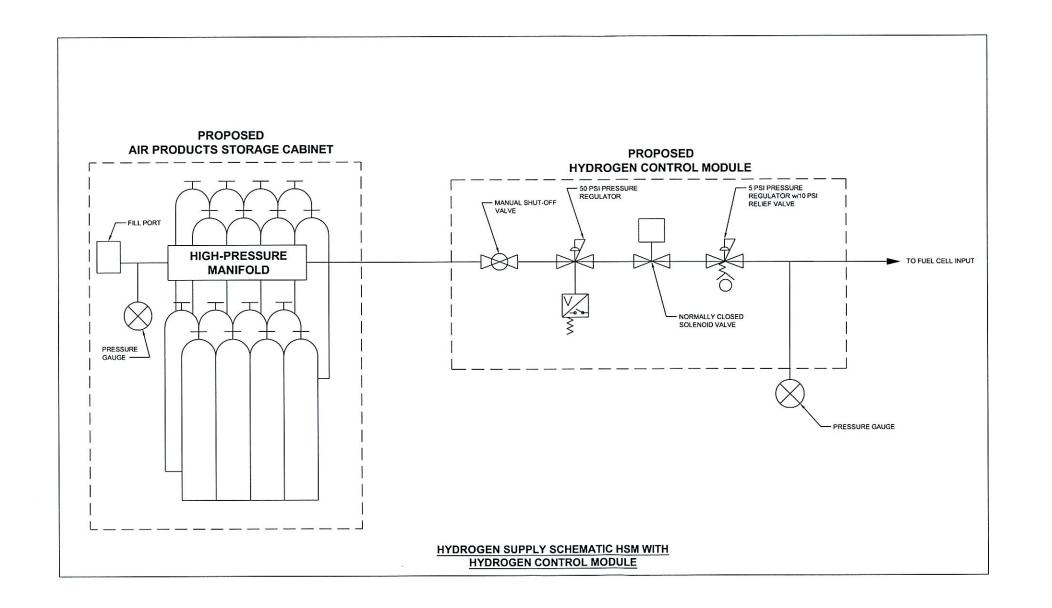
> EAST LYME CT03XC110 93 ROXBURY ROAD EAST LYME, CT 06333 CO-LOCATION

> > SHEET TITLE

CONCRETE PAD DETAILS

SHEET NUMBER

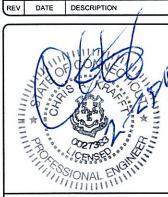S-2








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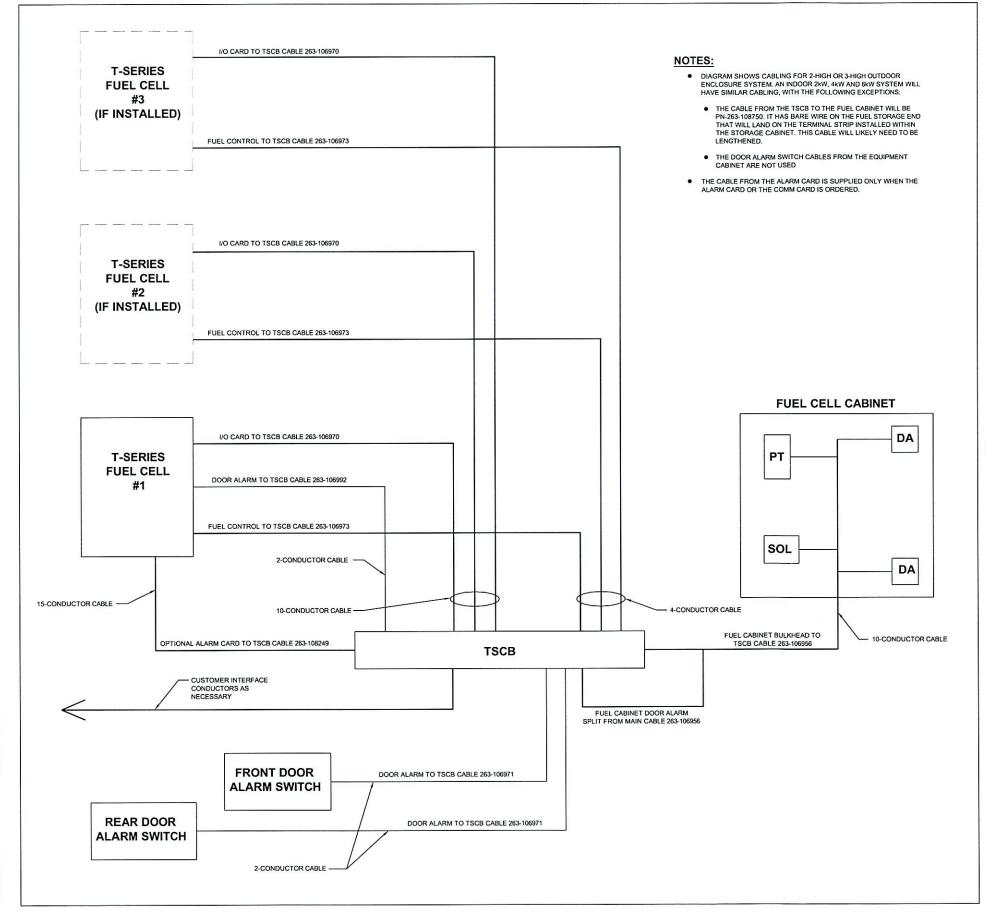
EAST LYME CT03XC110 93 ROXBURY ROAD EAST LYME, CT 06333 CO-LOCATION

SHEET TITLE

HYDROGEN PIPING SCHEMATIC

SHEET NUMBER

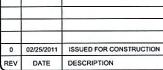M-1



T-SERIES SIGNAL INTERCONNECT DIAGRAM

GENERAL ELECTRICAL NOTES:

- ALL ELECTRICAL WORK SHALL CONFORM TO THE LATEST EDITION OF THE NATIONAL ELECTRICAL CODE (NEC), AND LOCAL CODES.
- ALL ELECTRICAL MATERIALS, EQUIPMENT AND INSTALLATION PROCEDURES SHALL CONFORM WITH SPRINT'S STANDARD CONSTRUCTION SPECIFICATIONS.
- ALL MATERIALS SHALL BE MANUFACTURED IN ACCORDANCE WITH APPLICABLE STANDARDS ESTABLISHED BY ANSI, NEMA NFPA, AND "UL" LISTED.
- THE ELECTRICAL PLANS, DETAILS, AND DIAGRAMS SHOWN ON THESE DRAWINGS ARE DIAGRAMMATIC ONLY. ACTUAL FIELD CONDITIONS AND SITE REQUIREMENTS SHALL DICTATE THE AMOUNT AND LOCATION OF EQUIPMENT.
- THE ENTIRE ELECTRICAL INSTALLATION SHALL BE GROUNDED AS REQUIRED BY THE NEC AND ALL APPLICABLE LOCAL CODES.
- 6. ALL CIRCUIT BREAKERS, FUSES AND ELECTRICAL EQUIPMENT SHALL HAVE A MINIMUM INTERRUPTING RATING OF 65,000 AIC (UNLESS NOTED OTHERWISE).
- REFER TO THE VENDOR DRAWINGS OF THE PPC CABINET, BATTERY, AND BTS CABINETS FOR COMPLETE INTERNAL WIRING AND ARRANGEMENT.
- 8. PATCH, REPAIR AND PAINT ANY AREA THAT HAS BEEN DAMAGED IN THE COURSE OF THE
- 9. LABEL ALL ELECTRICAL EQUIPMENT PER SPRINT'S SPECIFICATIONS.
- 10. ALL SINGLE-PHASE SELF-CONTAINED METER CONNECTION DEVICES MUST INCLUDE HORN TYPE BYPASS PROVISIONS SO THAT SERVICE WILL NOT BE INTERRUPTED WHEN A METER IS REMOVED FROM THE SOCKET.
- 11. USE METER CONNECTION DEVICES LABELED BY THE MANUFACTURER WITH THE LETTERS
- 12. ALL INTERIOR CONDUITS AND BUSHINGS SHALL BE EMT. ALL EXTERIOR SHALL BE PVC UNLESS NOTED OTHERWISE (SEE SPRINT'S STANDARD CONSTRUCTION SPECIFICATIONS).
- 13. PROVIDE 2 PULL STRINGS SECURELY FASTENED AT EACH END OF ALL CONDUITS. THE PULL STRINGS ARE TO BE 200 LB. TEST POLYETHYLENE CORD. PROVIDE CAP ON THE END OF EACH CONDUIT AND MARK AS SHOWN ON THIS SITE PLAN.
- 14. THE CONTRACTOR SHALL LOCATE AND MARK ALL EXISTING UNDERGROUND POWER, TELCO, GROUNDING CONDUITS, AND ALL OTHER UTILITIES EASEMENTS AND/OR WIRES PRIOR TO TRENCHING. ANY DAMAGE CAUSED TO THE EXISTING UNDERGROUND SERVICES OR SYSTEMS SHALL BE REPAIRED AT THE CONTRACTOR'S EXPENSE. VERIFY WITH UTILITY NEW SERVICE HAS BEEN APPLIED FOR. THERE SHALL BE NO SPLICING OF GROUND CONDUCTORS BELOW GRADE.
- UTILITY RACK AND CONDUIT SIZES TO BE FIELD DETERMINED BY CONTRACTOR IN ACCORDANCE WITH THE LOCAL JURISDICTION.
- ALL WORK SHALL MEET OR EXCEED ALL APPLICABLE LOCAL AND NATIONAL ELECTRICAL CODE REQUIREMENTS.
- 17. ALL INSTALLATION AND EQUIPMENT SHALL MEET OR EXCEED SPRINT CONSTRUCTION SPECIFICATIONS.

ELECTRICAL NOTES:

- 1. LIGHT SHADED LINES INDICATE EXISTING CONSTRUCTION
- CONTRACTOR TO VERIFY POWERWAVE MODEL AND ASSOCIATED POWER REQUIREMENTS.
 IF LARGER CIRCUIT BREAKERS ARE REQUIRED, CONTRACTOR SHALL PROVIDE CORRECT ELECTRICAL
 CONDUCTOR SIZES.



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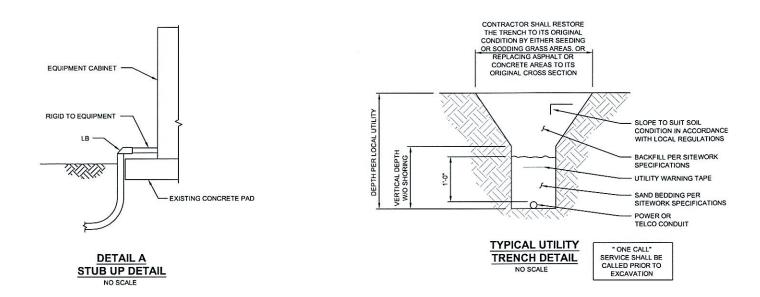
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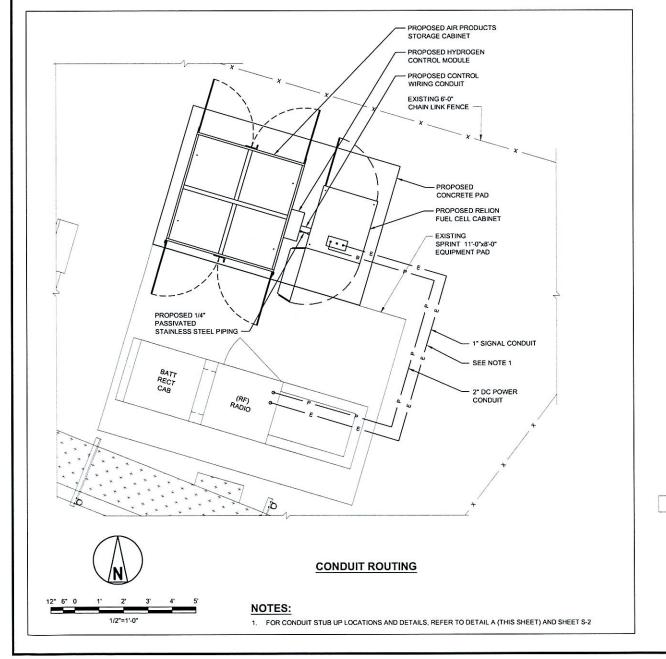
EAST LYME CT03XC110 93 ROXBURY ROAD EAST LYME, CT 06333 CO-LOCATION


SHEET TITLE

ELECTRICAL ONE-LINE DIAGRAM

SHEET NUMBER





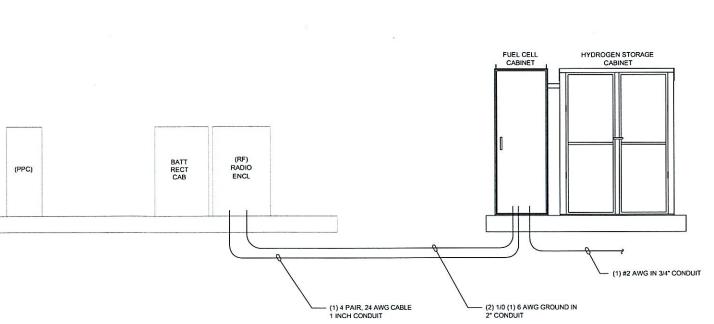

ELECTRICAL & SIGNAL RISER DIAGRAM

GENERAL NOTES:

- MATERIALS: ALL HANGERS, SUPPORTS, FASTENERS AND HARDWARE SHALL BE ZINC COATED OR OF EQUIVALENT CORROSION RESISTANCE BY TREATMENT OR INHERENT PROPERTY, AND SHALL BE MANUFACTURED PRODUCTS DESIGNED FOR THE APPLICATION. PRODUCTS FOR OUTDOOR USE SHALL BE HOT DIP GALVANIZED.
- CONDUIT SEALS: INSTALL CONDUIT SEAL FOR EACH CONDUIT PENETRATING AN EXTERIOR BUILDING WALL BELOW
 GRADE (UNLESS PENETRATION IS BELOW LOWEST BUILDING FLOOR SLAB), AND ELSEWHERE AS INDICATED, AND SO AS
 TO ACHIEVE A SEALED WATERTIGHT INSTALLATION. MATCH EXISTING CONDITIONS AND MEET OR EXCEED INTEGRITY OF
 WALLS.
- INSTALLATION: RIGIDLY SUPPORT AND SECURE ALL MATERIALS, RACEWAY AND EQUIPMENT TO BUILDING STRUCTURE
 USING HANGERS, SUPPORTS AND FASTENERS, SUITABLE FOR THE USE, MATERIALS AND LOADS ENCOUNTERED.
 PROVIDE ALL NECESSARY HARDWARE. PROVIDE CONDUIT SUPPORTS AT MAXIMUM 5 FT. O.C.
- 4. STRUCTURAL MEMBERS: DO NOT CUT, DRILL OR WELD ANY STRUCTURAL MEMBER EXCEPT AS SPECIFICALLY APPROVED BY THE ENGINEER.
- INDEPENDENT SUPPORT: DO NOT SUPPORT MATERIALS OR EQUIPMENT FROM OTHER EQUIPMENT, PIPING, DUCTWORK OR SUPPORTS FOR SAME.
- MISCELLANEOUS SUPPORTS: PROVIDE ANY ADDITIONAL STRUCTURAL SUPPORT STEEL BRACKETS ANGLES, FASTENERS
 AND HARDWARE AS REQUIRED TO ADEQUATELY SUPPORT ALL ELECTRICAL MATERIALS AND EQUIPMENT.
- 7. ONE HOLE STRAPS SHALL NOT BE USED FOR CONDUITS LARGER THAN 3/4"Ø.



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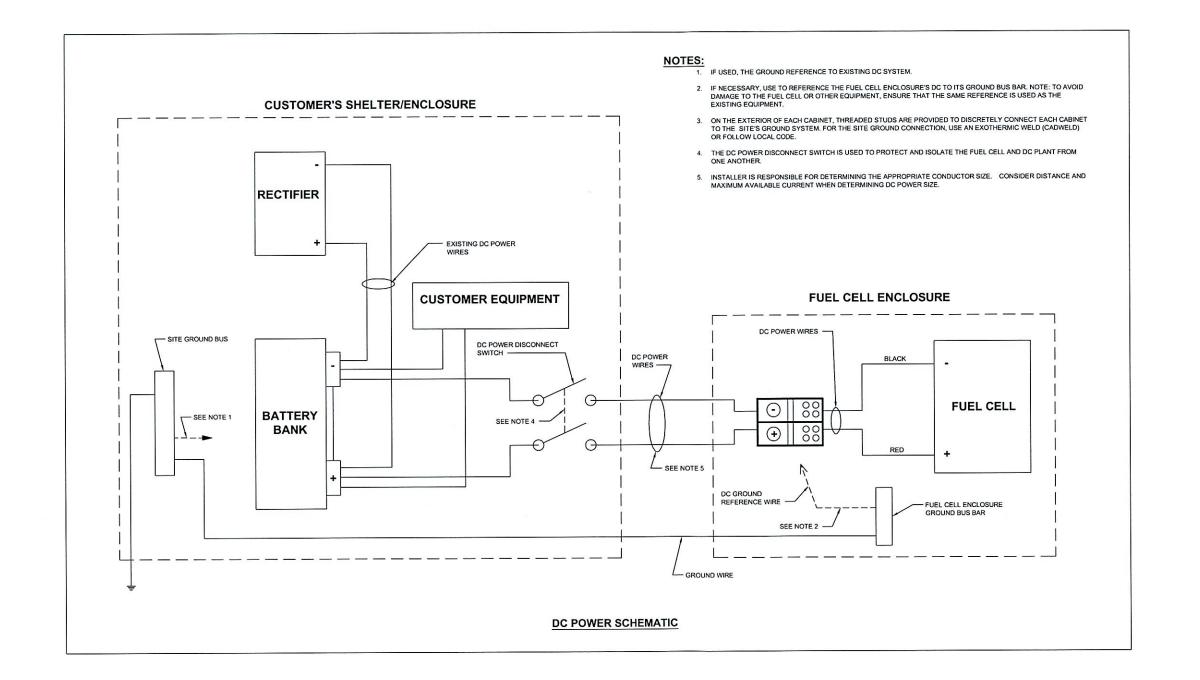
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> > SHEET TITLE

OVERALL CONDUIT DETAILS

SHEET NUMBER







10950 GRANDVIEW DRIVE OVERLAND PARK, KANSAS 66210 (913) 458-2000

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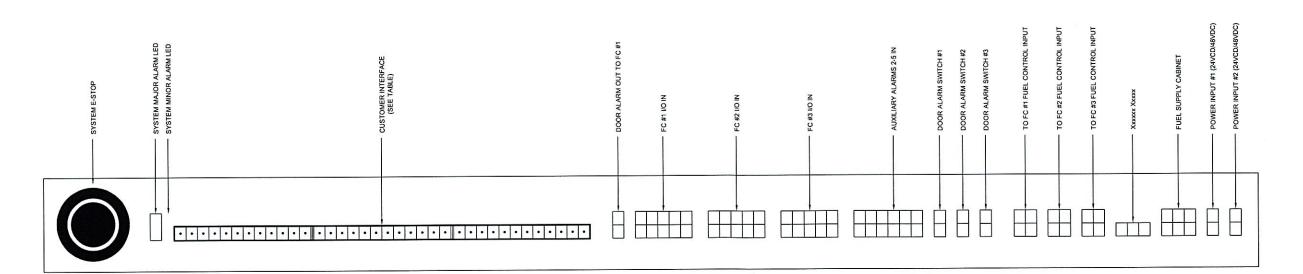
> EAST LYME CT03XC110 93 ROXBURY ROAD EAST LYME, CT 06333 CO-LOCATION

> > SHEET TITLE

ELECTRICAL WIRING DIAGRAM

SHEET NUMBER

				CUSTOMER CONNECTION	DNS			
PIN	SIGNAL NAME	NOTES	PIN	SIGNAL NAME	<u>NOTES</u>	PIN	SIGNAL NAME	NOTES
1	DOOR SWITCH ALARM	THERE IS 1.1 k OHM SERIES	13	FC #1 AUX. ALARM RELAY (N.O.)	THERE IS 1.1 k OHM SERIES RESISTANCE BETWEEN PINS 1 & 2	25	AUX. 2 ALARM RELAY (N.O.)	AUXILIARY RELAYS 2 THROUGH 5 ARE AVAILABLE WITH THE ADDITION
2	DOOR SWITCH ALARM RETURN	RESISTANCE BETWEEN PINS 1 & 2	14	FC #1 AUX. ALARM RELAY (COMMON)	RESISTANCE BETWEEN PINS 1 & 2	26	AUX. 2 ALARM RELAY (COMMON)	OF AN OPTIONAL ALARM CARD OR COMM CARD INSTALLED ONTO ONE
3	NOT USED		15	FC #1 AUX. ALARM RELAY (N.C.)		27	AUX. 2 ALARM RELAY (N.C.)	OF THE FUEL CELLS
4	NOT USED		16	FC #2 AUX. ALARM RELAY (N.O.)		28	AUX. 2 ALARM RELAY (N.O.)	
5	SYSTEM MAJOR ALARM (N.O.)		17	FC #2 AUX. ALARM RELAY (COMMON.)		29	AUX. 3 ALARM RELAY (COMMON)	
6	SYSTEM MAJOR ALARM (COMMON)		18	FC #2 AUX. ALARM RELAY (N.C.)		30	AUX. 3 ALARM RELAY (N.C.)	
7	SYSTEM MAJOR ALARM (N.C.)		19	FC #3 AUX. ALARM RELAY (N.O.)		31	AUX. 3 ALARM RELAY (N.O.)	
8	SYSTEM MINOR ALARM (N.O.)		20	FC #3 AUX. ALARM RELAY (COMMON)		32	AUX. 4 ALARM RELAY (COMMON)	
9	SYSTEM MINOR ALARM (COMMON)		21	FC #3 AUX. ALARM RELAY (N.C.)		33	AUX. 4 ALARM RELAY (N.C.)	
10	SYSTEM MINOR ALARM (N.C.)		22	PRESSURE SW ALARM RELAY (N.O.)		34	AUX. 5 ALARM RELAY (N.O.)	
11	CONTACT START	THESE ARE WETTED CONTACTS; USE	23	PRESSURE SW ALARM RELAY (COMMON)		35	AUX. 5 ALARM RELAY (COMMON)	
12	CONTACT START RETURN	A CLOSED SWITCH TO ACTIVATE.	24	PRESSURE SW ALARM RELAY (N.C.)		36	AUX. 5 ALARM RELAY (N.C.)	



T-SERIES SIGNAL AND CONTROL CONNECTIONS



6580 SPRINT PARKWAY OVERLAND PARK, KANSAS 66251



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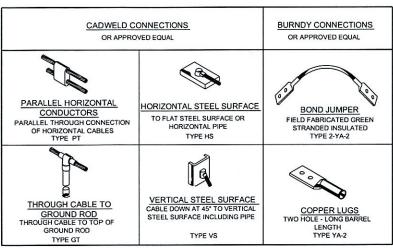
EAST LYME CT03XC110 93 ROXBURY ROAD EAST LYME, CT 06333 CO-LOCATION


SHEET TITLE

FUEL CELL INSTALL DETAIL

SHEET NUMBER

THE DETAILS ON THIS SHEET APPLY ONLY AS CALLED OUT ON SITE PLANS OR SITE SPECIFIC DRAWINGS.



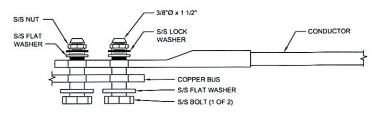

LUG DETAIL NO SCALE

NOTES:

- 1. ALL HARDWARE 18-8 STAINLESS STEEL COAT ALL SURFACES WITH
- FOR GROUND BOND TO STEEL ONLY: INSERT A DRAGON TOOTH WASHER BETWEEN LUG AND STEEL. COAT ALL SURFACES WITH ANTI-OXIDATION COMPOUND (BURNDY PENETROX E, OR THOMAS & BETTS KOPR-SHIELD).

GROUNDING LEGEND

--- NEW GROUND RING


---- EXISTING GROUND RING


NEW GROUND ROD

CADWELD CONNECTION (EXOTHERMIC WELD)

GROUNDING NOTES:

- THE SUBCONTRACTOR IS RESPONSIBLE FOR PROPERLY SEQUENCING INSTALLATION AS TO PREVENT ANY LOSS OF CONTINUITY IN THE GROUNDING SYSTEM OR DAMAGE TO THE CONDUIT.
- ALL GROUND CONNECTIONS ABOVE GRADE (INTERIOR & EXTERIOR) SHALL BE FORMED USING HIGH PRESS CRIMPS.
- ALL EXTERIOR GROUNDING CONNECTIONS SHALL BE COATED WITH A CORROSION RESISTANT MATERIAL.
- ALL EXTERIOR GROUNDING CONDUCTORS SHALL BE 2 AWG SOLID TINNED COPPER UNLESS OTHERWISE INDICATED.
- CONNECTIONS TO THE GROUNDING BUS SHALL NOT BE DOUBLED UP OR STACKED. BACK TO BACK CONNECTIONS ON OPPOSITE SIDES OF THE GROUND BUS ARE PERMITTED.
- USE OF 90° BENDS IN THE PROTECTION GROUNDING CONDUCTORS SHALL BE AVOIDED WHEN 45° BENDS CAN BE ADEQUATELY SUPPORTED.
- MAXIMUM RESISTANCE OF THE COMPLETED GROUND SYSTEM SHALL NOT EXCEED 5 OHMS. TESTING SHALL BE PERFORMED IN ACCORDANCE WITH PROJECT SPECIFICATIONS FOR FACILITY GROUNDING, USING FALL OF POTENTIAL METIOD

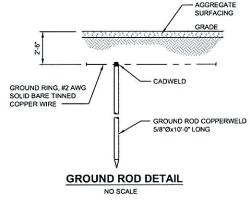

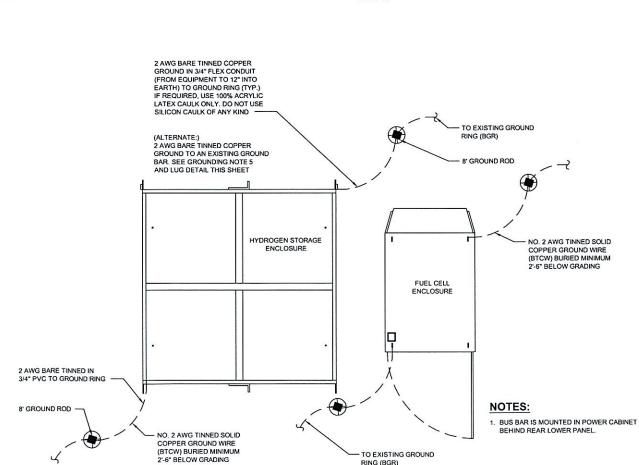

HYDROGEN TANKS AND ENGINE STAND ALONE GROUNDING DETAIL (IF APPLICABLE)



6580 SPRINT PARKWAY OVERLAND PARK, KANSAS 66251



10950 GRANDVIEW DRIVE OVERLAND PARK, KANSAS 66210 (913) 458-2000

PRC	JECT NO:	168202
DRA	WN BY:	ASK
CHE	CKED BY:	мв
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0	02/25/2011	ISSUED FOR CONSTRUCTION
REV	DATE	DESCRIPTION



IT IS A VIOLATION OF LAW FOR ANY PERSON, UNLESS THEY ARE ACTING UNDER THE DIRECTION OF A LICENSED PROFESSIONAL ENGINEER, TO ALTER THIS DOCUMENT.


EAST LYME CT03XC110 93 ROXBURY ROAD EAST LYME, CT 06333 CO-LOCATION

SHEET TITLE

GROUNDING PLAN AND DETAILS

SHEET NUMBER

G-1

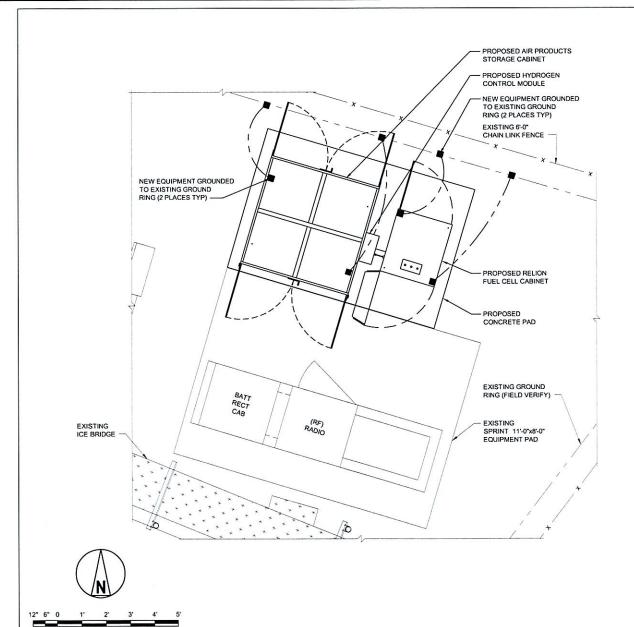

GROUNDING PLAN