From: Jason Blinkhorn < jblinkhorn@qualtekwireless.com>

Sent: Monday, May 24, 2021 1:54 PM

To: CSC-DL Siting Council <Siting.Council@ct.gov>; towncouncil@easthamptonct.gov;

dcox@easthamptonct.gov

Cc: Michael Cypranowski < mcypranowski@qualtekwireless.com >; Corey Michaud

<cmichaud@qualtekwireless.com>; John Centore <jcentore@qualtekwireless.com>; ATT Closeouts

<attcloseouts@empiretelecomm.com>; New England Compliance

<newenglandcompliance@empiretelecomm.com>; Siyuan Liu <sliu@qualtekwireless.com>; Karin Turner <kturner@qualtekwireless.com>

Subject: CT5838 ATT BUILD AT CSC EM-AT&T-042-210401

CSC team,

Can we please request NTP for 6-7.

COP team,

Please note this site requires additional COP documents for CSC.

Thank You,

Jason Blinkhorn / Project Manager / 401-787-6007 / jblinkhorn@qualtekwireless.com 16 Esquire Rd, N Billerica MA 01862 125 Depot St, Bellingham, MA 02019



Disclaimer: This email is intended only for the use of the individual or entity to which it is addressed, and may contain information that is privileged, confidential and exempt from disclosure under applicable law. If you received this communication in error, please do not distribute it and notify us immediately by email (administrator@qualtekservices.com) or via telephone (484.804.4500) and delete the original message. Unless expressly stated in this email, nothing in this message or any attachment should be construed as a digital or electronic signature.



Town of East Hampton 1 Community Drive East Hampton, CT 06424 Phone: (860) 267-9601 **PERMIT # B-21-163**

Permit Type: Cell Tower

BUILDING PERMIT

Application Date: 05/10/2021 Issue Date: 05/12/2021

Location: 1 PUBLIC WORKS DR Cell Tower

Parcel ID#: 06/5A/8B

Applicants Name: Crown Castle

Applicant's Address: 2000 Corporate Drive Canonsburg, PA 15317

Owner: Town Of East Hampton
Address: 1 Community Drive

East Hampton, CT 06424

Edition of Code:

Other Required Permits (If Applicable):

Electrical -Mechanical -Plumbing -

Permit Fee: \$387.50 Valuation: \$30,000.00

Contractor: Crown Castle License#: MCO.0903225 Address:2000 Corporate Drive Canonsburg, PA 15317

Zone: R-4

Description of Work:

Replace (3) existing antenna & RRU on cell tower. Add (3) antenna, (2) support cabinets to existing tower and compound.

Notes:

Building Official

THIS PERMIT CONVEYS NO RIGHT TO OCCUPY ANY STREET, ALLEY OR SIDEWALK OR ANY PART THEREOF, EITHER TEMPORARILY OR PERMANENTLY, ENCROACHMENTS ON PUBLIC PROPERTY, NOT SPECIFICALLY PERMITTED UNDER THE BUILDING CODE, MUST BE APPROVED BY THE JURISDICTION, STREET OR ALLEY GRADES AS WELL AS DEPTH AND LOCATION OF PUBLIC SEWERS MAY BE COMBINED FROM THE DEPARTMENT OF PUBLIC WORKS. THE ISSUANCE OF THIS PERMIT DOES NOT RELEASE THE APPLICANT FROM THE CONDITIONS OF ANY APPLICABLE SUBDIVISION RESTRICTIONS.

THE GRANTING OF A PERMIT FOR THE PURPOSED WORK SHALL NOT BE ASSUMED OR CONSTRUED TO ALLOW PERFORMANCE CONTRARY TO THE LAWS AND REGULATIONS OF THE STATE OF CONNECTICUT AND THE TOWN OF EAST HAMPTON. THE APPLICANT SHALL BE RESPONSIBLE FOR COMPLIANCE TO AND KNOWLEDGE OF ALL APPLICABLE CODES, STANDARDS AND REQUIREMENTS. ANY FALSE STATEMENT WILL RENDER THIS APPLICATION AND PERMITS OBTAINED HEREBY NULL AND VOID.

PLEASE CALL THE OFFICE TECHNICIAN, <u>72 HOURS IN ADVANCE</u>, AT 860-267-9601 WITH PERMIT NUMBER, TO SCHEDULE REQUIRED INSPECTIONS.

REQUIRED INSPECTIONS:

Electrical Final Fire Marshal Oversight Cell Tower Antenna Cell Tower Antenna Final Cell Tower Final



STATE OF CONNECTICUT CONNECTICUT SITING COUNCIL

Ten Franklin Square, New Britain, CT 06051 Phone: (860) 827-2935 Fax: (860) 827-2950 E-Mail: siting.council@ct.gov Web Site: portal.ct.gov/csc

VIA ELECTRONIC MAIL

April 26, 2021

Denise Sabo Northeast Site Solutions 54 Main Street, Unit 3 Sturbridge, MA 01566-1359

RE: **EM-AT&T-042-210401** - AT&T notice of intent to modify an existing telecommunications facility located at 1 Public Works Drive, East Hampton, Connecticut.

Dear Ms. Sabo:

The Connecticut Siting Council (Council) hereby acknowledges your notice to modify this existing telecommunications facility, pursuant to Section 16-50j-73 of the Regulations of Connecticut State Agencies with the following conditions:

- 1. Any deviation from the proposed modification as specified in this notice and supporting materials with the Council shall render this acknowledgement invalid;
- 2. Any material changes to this modification as proposed shall require the filing of a new notice with the Council;
- 3. The Council shall be notified in writing at least two weeks prior to the commencement of site construction activities;
- 4. Within 45 days after completion of construction, the Council shall be notified in writing that construction has been completed;
- 5. Any nonfunctioning antenna and associated antenna mounting equipment on this facility owned and operated by AT&T shall be removed within 60 days of the date the antenna ceased to function;
- 6. The validity of this action shall expire one year from the date of this letter; and
- 7. The applicant may file a request for an extension of time beyond the one year deadline provided that such request is submitted to the Council not less than 60 days prior to the expiration.

The proposed modifications including the placement of all necessary equipment and shelters within the tower compound are to be implemented as specified here and in your notice dated March 30, 2021. The modifications are in compliance with the exception criteria in Section 16-50j-72 (b) of the Regulations of Connecticut State Agencies as changes to an existing facility site that would not increase tower height, extend the boundaries of the tower site by any dimension, increase noise levels at the tower site boundary by six decibels or more, and increase the total radio frequencies electromagnetic radiation power density measured at the tower site boundary to or above the standards adopted by the Federal Communications Commission pursuant to Section 704 of the Telecommunications Act of 1996 and by the state Department

of Energy and Environmental Protection pursuant to Connecticut General Statutes § 22a-162. This facility has also been carefully modeled to ensure that radio frequency emissions are conservatively below state and federal standards applicable to the frequencies now used on this tower.

This decision is under the exclusive jurisdiction of the Council. Please be advised that the validity of this action shall expire one year from the date of this letter. Any additional change to this facility will require explicit notice to this agency pursuant to Regulations of Connecticut State Agencies Section 16-50j-73. Such notice shall include all relevant information regarding the proposed change with cumulative worst-case modeling of radio frequency exposure at the closest point of uncontrolled access to the tower base, consistent with Federal Communications Commission, Office of Engineering and Technology, Bulletin 65. Thank you for your attention and cooperation.

Sincerely,

s/Melanie A. Bachman

Melanie A. Bachman Executive Director

MAB/IN/emr

c: The Honorable Pete Brown, Chairman, Town of East Hampton (towncouncil@easthamptonct.gov)
David Cox, Town Manager, Town of East Hampton (dcox@easthamptonct.gov)



AT&T SITE NUMBER: CTL05838

EAST HAMPTON CENTRAL AT&T SITE NAME:

AT&T FA CODE: 10071008

AT&T PACE NUMBER: MRCTB048910, MRCTB048919, MRCTB048902, MRCTB048893

SHEET#

LTE 4C/5C/4TX4RX/5G NR UPGRADE AT&T PROJECT:

876368 **BUSINESS UNIT #:**

1 PUBLIC WORKS DRIVE **SITE ADDRESS:** EAST HAMPTON, CT 06424

MIDDLESEX COUNTY: MONOPOLE SITE TYPE:

180'-0" **TOWER HEIGHT:**

SITE INFORMATION

CROWN CASTLE USA INC. YANKEE LAKEEAST HAMPTONTOWN

SITE NAME:

CURRENT ZONING:

TOWER OWNER:

CARRIER/APPLICANT:

SITE ADDRESS: 1 PUBLIC WORKS DRIVE EAST HAMPTON, CT 06424

COUNTY: M IDDLESEX 06-5A-8B MAP/PARCEL #:

AREA OF CONSTRUCTION: **EXISTING** 41° 33′ 53.14″ (41.56476111) LATITUDE: LONGITUDE: 72° 32' 35.18" (-72.54310556)

NAD83 LAT/LONG TYPE: 377' (AMSL) GROUND ELEVATION:

JURISDICTION: TOWN OF EAST HAMPTON

OCCUPANCY CLASSIFICATION: U TYPE OF CONSTRUCTION:

A.D.A. COMPLIANCE: FACILITY IS UNMANNED AND NOT FOR

HUMAN HABITATION

PROPERTY OWNER: TOWN OF EAST HAMPTON & SPRINT SPECTRUM LP PROPTY TAX

> PO BOX 8430 (CT33XC018) KANSAS CITY, MO 64114

CROWN CASTLE USA INC. 2000 CORPORATE DRIVE

CANONSBURG, PA 15317

AT&T TOWER ASSET GROUP

575 MOROSGO DRIVE ATLANTA, GA 30324-3300

ELECTRIC PROVIDER: CONNECTICUT LIGHT & POWER CO. (800) 286-2000

TELCO PROVIDER: AT&T IMMEDIATELY NOTIFY THE ENGINEER IN WRITING OF ANY DISCREPANCIES BEFORE PROCEEDING WITH THE WORK OR \blacksquare BE RESPONSIBLE FOR SAME.

DRAWING INDEX

EXISTING & FINAL EQUIPMENT PLANS

FINAL ELEVATION & ANTENNA PLANS

FINAL EQUIPMENT SCHEDULE

EQUIPMENT MOUNTING DETAILS

TITLE SHEET

SITE PLAN

ATTACHED PLUMBING DIAGRAMS

GENERAL NOTES

EQUIPMENT SPECS

GROUNDING SCHEMATIC

GROUNDING DETAILS

SHEET DESCRIPTION



CALL CONNECTICUT ONE CALL (800) 922-4455 CBYD.COM CALL 2 WORKING DAYS BEFORE YOU DIG!

PROJECT DESCRIPTION

THE PURPOSE OF THIS PROJECT IS TO ENHANCE BROADBAND CONNECTIVITY AND CAPACITY TO

LOCATION MAP A Restoration Company KOCO Child Care Cente COBALT MIDDLE HADDAM Christ Episcopal Church Dart Tree Farm United States Postal Service

NO SCALE



SITE PHOTO

PROJECT TEAM

(800) 288-2020

A&E FIRM: TOWER ENGINEERING PROFESSIONALS

> 326 TRYON ROAD RALEIGH, NC 27603

BRITTON S. ENGLAND - PROJECT MANAGER

(919) 661-6351

GRAHAM M. ANDRES - CIVIL ENGINEER

(919) 661-6351

GRAHAM M. ANDRES - ELECTRICAL ENGINEER

(919) 661-6351

1200 MACARTHUR BLVD, SUITE 200 CROWN CASTLE USA INC. DISTRICT MAHWAH, NJ 07430

CONTACTS:

CROWN NOC AT (800) 788-7011 & CROWN CONSTRUCTION MANAGER.

NICHOLAS ROMBACH - A&E SPECIALIST

(502) 318-1303

GROUND SCOPE OF WORK:

TOWER SCOPE OF WORK:

• INSTALL (3) RRUS 4449 B5/B12

• INSTALL (3) RRUS-32 B66A

• INSTALL (3) RRUS 4478 B14

• INSTALL (1) DC6 SQUID

• REMOVE GSM CABINET AND INSTALL NEW FLX12 CABINET

• INSTALL (3) CCI DMP65R-BU6DA POSITION 4 ALL SECTORS

• INSTALL(3) CCI OPA65R-BU6BA POSITION 3 ALL SECTORS

- INSTALL (1) 6630 BASEBAND • INSTALL (1) IDLE CABLE
- INSTALL (1) 19" DISTRIBUTION SHELF
- INSTALL (12) VERTIV UP-CONVERTERS

• INSTALL (2) #6AWG DC POWER TRUNKS

• INSTALL (3) Y CABLES ON DUAL BAND RRHS

THE EXISTING ELIGIBLE WIRELESS FACILITY.

• REMOVE (3) RRUS-11 B12 RADIOS POSITION 4

• REMOVE (3) KMW AM-X-CD-16-65-00T-RET ANTENNAS

- INSTALL (1) PROPOSED FLEX 16 DOOR UPGRADE KIT
- INSTALL (1) PROPOSED DC12
- INSTALL (1) PROPOSED FIBER MANAGEMENT BOX

THE POWER DESIGN FOR ANY AC ELECTRICAL POWER CHANGES IS TO BE PERFORMED BY OTHERS PRIOR TO ACCESSING/ENTERING THE SITE YOU MUST CONTACT THE AND IS SHOWN HERE FOR REFERENCE PURPOSES ONLY. AT&T IS SOLELY RESPONSIBLE FOR THE ELECTRICAL POWER DESIGN.

APPLICABLE CODES/REFERENCE DOCUMENTS

ALL WORK SHALL BE PERFORMED AND MATERIALS INSTALLED IN ACCORDANCE WITH THE CURRENT EDITIONS OF THE FOLLOWING CODES AS ADOPTED BY THE LOCAL GOVERNING AUTHORITIES. NOTHING IN THESE PLANS IS TO BE CONSTRUED TO PERMIT WORK NOT CONFORMING TO THESE CODES:

CODE TYPE CODE

2015 INTERNATIONAL BUILDING CODE BUILDING 2015 INTERNATIONAL MECHANICAL CODE MECHANICAL

ELECTRICAL 2017 NEC

REFERENCE DOCUMENTS:

STRUCTURAL ANALYSIS: BY CROWN CASTLE

DATED: 12/11/2020

MOUNT ANALYSIS: BY POD GROUP DATED: 12/07/2020

AC ELECTRICAL POWER DESIGN: BY OTHERS

DATED:

RFDS REVISION: 2.00

DATED: 10/28/2020 ORDER ID: 528756

REVISION: 1

ATLANTA, GA 30324-3300 **CROWN**



TOWER **ENGINEERING PROFESSIONALS** 326 TRYON RD RALEIGH, NC 27603

(919) 661-6351

TEP JOB #: 218229.479065

AT&T SITE NUMBER: CTL05838

BU #: **876368** YANKEE LAKEAST **HAMPTONTOWN**

1 PUBLIC WORKS DRIVE EAST HAMPTON, CT 06424 (MIDDLESEX COUNTY)

EXISTING 180' MONOPOLE

	ISSUED FOR:												
REV	DATE	DRWN	DESCRIPTION	DES./QA									
Α	01/13/21	BSE	PRELIMINARY	JTC									
В	01/25/21	BSE	PRELIMINARY	JTC									
С	02/12/21	BSE	PRELIMINARY	JTC									
0	03/09/21	BSE	CONSTRUCTION	JTC									
1	03/12/21	BSE	CONSTRUCTION	JTC									



IT IS A VIOLATION OF LAW FOR ANY PERSON, UNLESS THEY ARE ACTING UNDER THE DIRECTION OF A LICENSED PROFESSIONAL ENGINEER, TO ALTER THIS DOCUMENT.

SHEET NUMBER:

CROWN CASTLE USA INC. SITE ACTIVITY REQUIREMENTS:

- 1. NOTICE TO PROCEED— NO WORK SHALL COMMENCE PRIOR TO CROWN CASTLE USA INC. WRITTEN NOTICE TO PROCEED (NTP) AND THE ISSUANCE OF A PURCHASE ORDER. PRIOR TO ACCESSING/ENTERING THE SITE YOU MUST CONTACT THE CROWN CASTLE USA INC. NOC AT 800-788-7011 & THE CROWN CASTLE USA INC. CONSTRUCTION MANAGER.
- "LOOK UP" CROWN CASTLE USA INC. SAFETY CLIMB REQUIREMENT
- THE INTEGRITY OF THE SAFETY CLIMB AND ALL COMPONENTS OF THE CLIMBING FACILITY SHALL BE CONSIDERED DURING ALL STAGES OF DESIGN, INSTALLATION, AND INSPECTION. TOWER MODIFICATION, MOUNT REINFORCEMENTS, AND/OR EQUIPMENT INSTALLATIONS SHALL NOT COMPROMISE THE INTEGRITY OR FUNCTIONAL USE OF THE SAFETY CLIMB OR ANY COMPONENTS OF THE CLIMBING FACILITY ON THE STRUCTURE. THIS SHALL INCLUDE, BUT NOT BE LIMITED TO: PINCHING OF THE WIRE ROPE, BENDING OF THE WIRE ROPE FROM ITS SUPPORTS, DIRECT CONTACT OR CLOSE PROXIMITY TO THE WIRE ROPE WHICH MAY CAUSE FRICTIONAL WEAR, IMPACT TO THE ANCHORAGE POINTS IN ANY WAY, OR TO IMPEDE/BLOCK ITS INTENDED USE. ANY COMPROMISED SAFETY CLIMB, INCLUDING EXISTING CONDITIONS MUST BE TAGGED OUT AND REPORTED TO YOUR CROWN CASTLE USA INC. POC OR CALL THE NOC TO GENERATE A SAFETY CLIMB MAINTENANCE AND CONTRACTOR NOTICE TICKET.
- PRIOR TO THE START OF CONSTRUCTION, ALL REQUIRED JURISDICTIONAL PERMITS SHALL BE OBTAINED. THIS INCLUDES, BUT IS NOT LIMITED TO, BUILDING, ELECTRICAL, MECHANICAL, FIRE, FLOOD ZONE, ENVIRONMENTAL, AND ZONING. AFTER ONSITE ACTIVITIES AND CONSTRUCTION ARE COMPLETED, ALL REQUIRED PERMITS SHALL BE SATISFIED AND CLOSED OUT ACCORDING TO LOCAL JURISDICTIONAL REQUIREMENTS
- ALL CONSTRUCTION MEANS AND METHODS; INCLUDING BUT NOT LIMITED TO, ERECTION PLANS, RIGGING PLANS, CLIMBING PLANS, AND RESCUE PLANS SHALL BE THE RESPONSIBILITY OF THE GENERAL CONTRACTOR RESPONSIBLE FOR THE EXECUTION OF THE WORK CONTAINED HEREIN, AND SHALL MEET ANSI/ASSE A10.48 (LATEST EDITION); FEDERAL, STATE, AND LOCAL REGULATIONS; AND ANY APPLICABLE INDUSTRY CONSENSUS STANDARDS RELATED TO THE CONSTRUCTION ACTIVITIES BEING PERFORMED. ALL RIGGING PLANS SHALL ADHERE TO ANSI/ASSE A10.48 (LATEST EDITION) AND CROWN CASTLE USA INC. STANDARD CED-STD-10253, INCLUDING THE REQUIRED INVOLVEMENT OF A QUALIFIED ENGINEER FOR CLASS IV CONSTRUCTION, TO CERTIFY THE SUPPORTING STRUCTURE(S) IN ACCORDANCE WITH ANSI/TIA-322 (LATEST EDITION)
- 5. ALL SITE WORK TO COMPLY WITH QAS-STD-10068 "INSTALLATION STANDARDS FOR CONSTRUCTION ACTIVITIES ON CROWN CASTLE USA INC. TOWER SITE," CED-STD-10294 "STANDARD FOR INSTALLATION OF MOUNTS AND APPURTENANCES," AND LATEST VERSION OF ANSI/TIA-1019-A-2012 "STANDARD FOR INSTALLATION, ALTERATION, AND MAINTENANCE OF ANTENNA SUPPORTING STRUCTURES AND ANTENNAS.
- IF THE SPECIFIED EQUIPMENT CAN NOT BE INSTALLED AS SHOWN ON THESE DRAWINGS, THE CONTRACTOR SHALL PROPOSE AN ALTERNATIVE INSTALLATION FOR APPROVAL BY CROWN CASTLE USA INC. PRIOR TO PROCEEDING WITH ANY SUCH CHANGE OF INSTALLATION.
- ALL MATERIALS FURNISHED AND INSTALLED SHALL BE IN STRICT ACCORDANCE WITH ALL APPLICABLE CODES, REGULATIONS AND ORDINANCES. CONTRACTOR SHALL ISSUE ALL APPROPRIATE NOTICES AND COMPLY WITH ALL LAWS, ORDINANCES, RULES, REGULATIONS AND LAWFUL ORDERS OF ANY PUBLIC AUTHORITY REGARDING THE PERFORMANCE OF THE WORK. ALL WORK CARRIED OUT SHALL COMPLY WITH ALL APPLICABLE MUNICIPAL AND UTILITY COMPANY SPECIFICATIONS AND LOCAL JURISDICTIONAL CODES, ORDINANCES AND APPLICABLE REGULATIONS.
- THE CONTRACTOR SHALL INSTALL ALL EQUIPMENT AND MATERIALS IN ACCORDANCE WITH MANUFACTURER'S RECOMMENDATIONS UNLESS SPECIFICALLY STATED OTHERWISE.
- THE CONTRACTOR SHALL CONTACT UTILITY LOCATING SERVICES PRIOR TO THE START OF CONSTRUCTION.
- 10. ALL EXISTING ACTIVE SEWER, WATER, GAS, ELECTRIC AND OTHER UTILITIES WHERE ENCOUNTERED IN THE WORK, SHALL BE PROTECTED AT ALL TIMES AND WHERE REQUIRED FOR THE PROPER EXECUTION OF THE WORK, SHALL BE RELOCATED AS DIRECTED BY CONTRACTOR, EXTREME CAUTION SHOULD BE USED BY THE CONTRACTOR WHEN EXCAVATING OR DRILLING PIERS AROUND OR NEAR UTILITIES. CONTRACTOR SHALL PROVIDE SAFETY TRAINING FOR THE WORKING CREW. THIS WILL INCLUDE BUT NOT BE LIMITED TO A) FALL PROTECTION B) CONFINED SPACE C) ELECTRICAL SAFETY D) TRENCHING AND EXCAVATION E) CONSTRUCTION SAFETY PROCEDURES.
- 11. ALL SITE WORK SHALL BE AS INDICATED ON THE STAMPED CONSTRUCTION DRAWINGS AND PROJECT SPECIFICATIONS, LATEST APPROVED REVISION.
- 12. CONTRACTOR SHALL KEEP THE SITE FREE FROM ACCUMULATING WASTE MATERIAL, DEBRIS, AND TRASH AT THE COMPLETION OF THE WORK. IF NECESSARY, RUBBISH, STUMPS, DEBRIS, STICKS, STONES AND OTHER REFUSE SHALL BE REMOVED FROM THE SITE AND DISPOSED OF LEGALLY
- 13. ALL EXISTING INACTIVE SEWER, WATER, GAS, ELECTRIC AND OTHER UTILITIES, WHICH INTERFERE WITH THE EXECUTION OF THE WORK, SHALL BE REMOVED AND/OR CAPPED, PLUGGED OR OTHERWISE DISCONTINUED AT POINTS WHICH WILL NOT INTERFERE WITH THE EXECUTION OF THE WORK, SUBJECT TO THE APPROVAL OF CONTRACTOR, TOWER OWNER, CROWN CASTLE USA INC., AND/OR LOCAL UTILITIES
- 14. THE CONTRACTOR SHALL PROVIDE SITE SIGNAGE IN ACCORDANCE WITH THE TECHNICAL SPECIFICATION FOR SITE SIGNAGE REQUIRED BY LOCAL JURISDICTION AND SIGNAGE REQUIRED ON INDIVIDUAL PIECES OF EQUIPMENT, ROOMS, AND SHELTERS.
- 15. THE SITE SHALL BE GRADED TO CAUSE SURFACE WATER TO FLOW AWAY FROM THE CARRIER'S EQUIPMENT AND TOWER AREAS.
- 16. THE SUB GRADE SHALL BE COMPACTED AND BROUGHT TO A SMOOTH UNIFORM GRADE PRIOR TO FINISHED RFACE APPLICATION.
- 17. THE AREAS OF THE OWNERS PROPERTY DISTURBED BY THE WORK AND NOT COVERED BY THE TOWER, EQUIPMENT OR DRIVEWAY, SHALL BE GRADED TO A UNIFORM SLOPE, AND STABILIZED TO PREVENT EROSION AS SPECIFIED ON THE CONSTRUCTION DRAWINGS AND/OR PROJECT SPECIFICATIONS.
- 18. CONTRACTOR SHALL MINIMIZE DISTURBANCE TO EXISTING SITE DURING CONSTRUCTION. EROSION CONTROL MEASURES, IF REQUIRED DURING CONSTRUCTION, SHALL BE IN CONFORMANCE WITH THE LOCAL GUIDELINES
- FOR EROSION AND SEDIMENT CONTROL. 19. THE CONTRACTOR SHALL PROTECT EXISTING IMPROVEMENTS, PAVEMENTS, CURBS, LANDSCAPING AND STRUCTURES. ANY DAMAGED PART SHALL BE REPAIRED AT CONTRACTOR'S EXPENSE TO THE SATISFACTION
- 20. CONTRACTOR SHALL LEGALLY AND PROPERLY DISPOSE OF ALL SCRAP MATERIALS SUCH AS COAXIAL CABLES AND OTHER ITEMS REMOVED FROM THE EXISTING FACILITY. ANTENNAS REMOVED SHALL BE RETURNED TO THE OWNER'S DESIGNATED LOCATION.
- 21. CONTRACTOR SHALL LEAVE PREMISES IN CLEAN CONDITION. TRASH AND DEBRIS SHOULD BE REMOVED FROM SITE ON A DAILY BASIS.
- 22. NO FILL OR EMBANKMENT MATERIAL SHALL BE PLACED ON FROZEN GROUND. FROZEN MATERIALS, SNOW OR ICE SHALL NOT BE PLACED IN ANY FILL OR EMBANKMENT.

GENERAL NOTES:

- FOR THE PURPOSE OF CONSTRUCTION DRAWING, THE FOLLOWING DEFINITIONS SHALL APPLY: CONTRACTOR: GENERAL CONTRACTOR RESPONSIBLE FOR CONSTRUCTION
- CARRIER: TOWER OWNER: CROWN CASTLE USA INC.
- 2. THESE DRAWINGS HAVE BEEN PREPARED USING STANDARDS OF PROFESSIONAL CARE AND COMPLETENESS NORMALLY EXERCISED UNDER SIMILAR CIRCUMSTANCES BY REPUTABLE ENGINEERS IN THIS OR SIMILAR LOCALITIES. IT IS ASSUMED THAT THE WORK DEPICTED WILL BE PERFORMED BY AN EXPERIENCED CONTRACTOR AND/OR WORKPEOPLE WHO HAVE A WORKING KNOWLEDGE OF THE APPLICABLE CODE STANDARDS AND REQUIREMENTS AND OF INDUSTRY ACCEPTED STANDARD GOOD PRACTICE. AS NOT EVERY CONDITION OR ELEMENT IS (OR CAN BE) EXPLICITLY SHOWN ON THESE DRAWINGS, THE CONTRACTOR SHALL USE INDUSTRY ACCEPTED STANDARD GOOD PRACTICE FOR MISCELLANEOUS WORK NOT EXPLICITLY SHOWN.
- THESE DRAWINGS REPRESENT THE FINISHED STRUCTURE. THEY DO NOT INDICATE THE MEANS OR METHODS OF CONSTRUCTION. THE CONTRACTOR SHALL BE SOLELY RESPONSIBLE FOR THE CONSTRUCTION MEANS, METHODS TECHNIQUES, SEQUENCES, AND PROCEDURES. THE CONTRACTOR SHALL PROVIDE ALL MEASURES NECESSARY FOR PROTECTION OF LIFE AND PROPERTY DURING CONSTRUCTION. SUCH MEASURES SHALL INCLUDE. BUT NOT BE LIMITED TO. BRACING. FORMWORK. SHORING. ETC. SITE VISITS BY THE ENGINEER OR HIS REPRESENTATIVE WILL NOT INCLUDE INSPECTION OF THESE ITEMS AND IS FOR STRUCTURAL OBSERVATION OF THE FINISHED STRUCTURE ONLY.
- NOTES AND DETAILS IN THE CONSTRUCTION DRAWINGS SHALL TAKE PRECEDENCE OVER GENERAL NOTES AND TYPICAL DETAILS. WHERE NO DETAILS ARE SHOWN, CONSTRUCTION SHALL CONFORM TO SIMILAR WORK ON THE PROJECT, AND/OR AS PROVIDED FOR IN THE CONTRACT DOCUMENTS. WHERE DISCREPANCIES OCCUR BETWEEN PLANS, DETAILS, GENERAL NOTES, AND SPECIFICATIONS, THE GREATER, MORE STRICT REQUIREMENTS, SHALL GOVERN. IF FURTHER CLARIFICATION IS REQUIRED CONTACT THE ENGINEER OF RECORD.
- SUBSTANTIAL EFFORT HAS BEEN MADE TO PROVIDE ACCURATE DIMENSIONS AND MEASUREMENTS ON THE DRAWINGS TO ASSIST IN THE FABRICATION AND/OR PLACEMENT OF CONSTRUCTION ELEMENTS BUT IT IS THE SOLE RESPONSIBILITY OF THE CONTRACTOR TO FIELD VERIFY THE DIMENSIONS, MEASUREMENTS, AND/OR CLEARANCES SHOWN IN THE CONSTRUCTION DRAWINGS PRIOR TO FABRICATION OR CUTTING OF ANY NEW OR EXISTING CONSTRUCTION ELEMENTS. IF IT IS DETERMINED THAT THERE ARE DISCREPANCIES AND/OR CONFLICTS WITH THE CONSTRUCTION DRAWINGS THE ENGINEER OF RECORD IS TO BE NOTIFIED AS SOON AS POSSIBLE.
- PRIOR TO THE SUBMISSION OF BIDS, THE BIDDING CONTRACTOR SHALL VISIT THE CELL SITE TO FAMILIARIZE WITH THE EXISTING CONDITIONS AND TO CONFIRM THAT THE WORK CAN BE ACCOMPLISHED AS SHOWN ON THE CONSTRUCTION DRAWINGS. ANY DISCREPANCY FOUND SHALL BE BROUGHT TO THE ATTENTION OF CROWN CASTLE
- ALL MATERIALS FURNISHED AND INSTALLED SHALL BE IN STRICT ACCORDANCE WITH ALL APPLICABLE CODES, REGULATIONS AND ORDINANCES. CONTRACTOR SHALL ISSUE ALL APPROPRIATE NOTICES AND COMPLY WITH ALL LAWS, ORDINANCES, RULES, REGULATIONS AND LAWFUL ORDERS OF ANY PUBLIC AUTHORITY REGARDING THE PERFORMANCE OF THE WORK. ALL WORK CARRIED OUT SHALL COMPLY WITH ALL APPLICABLE MUNICIPAL AND UTILITY COMPANY SPECIFICATIONS AND LOCAL JURISDICTIONAL CODES, ORDINANCES AND APPLICABLE REGULATIONS.
- UNLESS NOTED OTHERWISE, THE WORK SHALL INCLUDE FURNISHING MATERIALS, EQUIPMENT, APPURTENANCES AND LABOR NECESSARY TO COMPLETE ALL INSTALLATIONS AS INDICATED ON THE DRAWINGS.
- THE CONTRACTOR SHALL INSTALL ALL EQUIPMENT AND MATERIALS IN ACCORDANCE WITH MANUFACTURER'S
- RECOMMENDATIONS UNLESS SPECIFICALLY STATED OTHERWISE. 10. IF THE SPECIFIED EQUIPMENT CAN NOT BE INSTALLED AS SHOWN ON THESE DRAWINGS, THE CONTRACTOR SHALL PROPOSE AN ALTERNATIVE INSTALLATION FOR APPROVAL BY THE CARRIER AND CROWN CASTLE PRIOR TO PROCEEDING
- WITH ANY SUCH CHANGE OF INSTALLATION. 11. CONTRACTOR IS TO PERFORM A SITE INVESTIGATION AND IS TO DETERMINE THE BEST ROUTING OF ALL CONDUITS FOR POWER, AND TELCO AND FOR GROUNDING CABLES AS SHOWN IN THE POWER, TELCO, AND GROUNDING PLAN
- DRAWINGS 12. THE CONTRACTOR SHALL PROTECT EXISTING IMPROVEMENTS, PAVEMENTS, CURBS, LANDSCAPING AND STRUCTURES. ANY
- DAMAGED PART SHALL BE REPAIRED AT CONTRACTOR'S EXPENSE TO THE SATISFACTION OF CROWN CASTLE USA INC. 13. CONTRACTOR SHALL LEGALLY AND PROPERLY DISPOSE OF ALL SCRAP MATERIALS SUCH AS COAXIAL CABLES AND OTHER ITEMS REMOVED FROM THE EXISTING FACILITY. ANTENNAS REMOVED SHALL BE RETURNED TO THE OWNER'S
- 14. CONTRACTOR SHALL LEAVE PREMISES IN CLEAN CONDITION. TRASH AND DEBRIS SHOULD BE REMOVED FROM SITE ON A DAILY BASIS.

CONCRETE, FOUNDATIONS, AND REINFORCING STFFI:

DESIGNATED LOCATION.

- ALL CONCRETE WORK SHALL BE IN ACCORDANCE WITH THE ACI 301, ACI 318, ACI 336, ASTM A184, ASTM A185 AND THE DESIGN AND CONSTRUCTION SPECIFICATION FOR CAST-IN-PLACE CONCRETE.
- 3. ALL CONCRETE SHALL HAVE A MINIMUM COMPRESSIVE STRENGTH (f'c) OF 3000 psi AT 28 DAYS, UNLESS NOTED OTHERWISE. NO MORE THAN 90 MINUTES SHALL ELAPSE FROM BATCH TIME TO TIME OF PLACEMENT UNLESS APPROVED BY THE ENGINEER OF RECORD. TEMPERATURE OF CONCRETE SHALL NOT EXCEED 90°f AT TIME OF PLACEMENT
- ALL STEEL REINFORCING SHALL CONFORM TO ASTM A615. ALL WELDED WIRE FABRIC (WWF) SHALL CONFORM TO ASTM A185. ALL SPLICES SHALL BE CLASS "B" TENSION SPLICES, UNLESS NOTED OTHERWISE. ALL HOOKS SHALL BE STANDARD 90 DEGREE HOOKS, UNLESS NOTED OTHERWISE. YIELD STRENGTH (Fy) OF STANDARD DEFORMED BARS ARE
- #5 BARS AND LARGER.... ..60 ksi
- ON DRAWINGS:
- #5 BARS AND SMALLER... .1-1/2" CONCRETE NOT EXPOSED TO EARTH OR WEATHER:
- SLAB AND WALLS.... BEAMS AND COLUMNS ..

- 2. UNLESS NOTED OTHERWISE, SOIL BEARING PRESSURE USED FOR DESIGN OF SLABS AND FOUNDATIONS IS ASSUMED TO BE 1000 psf.
- CONCRETE EXPOSED TO FREEZE-THAW CYCLES SHALL CONTAIN AIR ENTRAINING ADMIXTURES. AMOUNT OF AIR ENTRAINMENT TO BE BASED ON SIZE OF AGGREGATE AND F3 CLASS EXPOSURE (VERY SEVERE). CEMENT USED TO BE TYPE II PORTLAND CEMENT WITH A MAXIMUM WATER-TO-CEMENT RATIO (W/C) OF 0.45.
- AS FOLLOWS: #4 BARS AND SMALLER...
- THE FOLLOWING MINIMUM CONCRETE COVER SHALL BE PROVIDED FOR REINFORCING STEEL UNLESS SHOWN OTHERWISE
- CONCRETE CAST AGAINST AND PERMANENTLY EXPOSED TO EARTH... CONCRETE EXPOSED TO EARTH OR WEATHER: #6 BARS AND LARGER ...
- 7. A TOOLED EDGE OR A 3/4" CHAMFER SHALL BE PROVIDED AT ALL EXPOSED EDGES OF CONCRETE, UNLESS NOTED OTHERWISE, IN ACCORDANCE WITH ACI 301 SECTION 4.2.4.

GREENFIELD GROUNDING NOTES:

- ALL GROUND ELECTRODE SYSTEMS (INCLUDING TELECOMMUNICATION, RADIO, LIGHTNING PROTECTION AND AC POWER GES'S) SHALL BE BONDED TOGETHER AT OR BELOW GRADE, BY TWO OR MORE COPPER BONDING CONDUCTORS IN ACCORDANCE WITH THE NEC.
- THE CONTRACTOR SHALL PERFORM IEEE FALL—OF—POTENTAL RESISTANCE TO EARTH TESTING (PER IEEE 1100 AND 81) FOR GROUND ELECTRODE SYSTEMS, THE CONTRACTOR SHALL FURNISH AND INSTALL SUPPLEMENTAL GROUND ELECTRODES AS NEEDED TO ACHIEVE A TEST RESULT OF 5 OHMS OR LESS.
- THE CONTRACTOR IS RESPONSIBLE FOR PROPERLY SEQUENCING GROUNDING AND UNDERGROUND CONDUIT INSTALLATION AS TO PREVENT ANY LOSS OF CONTINUITY IN THE GROUNDING SYSTEM OR DAMAGE TO THE CONDUIT AND PROVIDE
- 4. METAL CONDUIT AND TRAY SHALL BE GROUNDED AND MADE ELECTRICALLY CONTINUOUS WITH LISTED BONDING FITTINGS OR BY BONDING ACROSS THE DISCONTINUITY WITH #6 COPPER WIRE UL APPROVED GROUNDING TYPE CONDUIT CLAMPS. METAL RACEWAY SHALL NOT BE USED AS THE NEC REQUIRED EQUIPMENT GROUND CONDUCTOR. STRANDED COPPER CONDUCTORS WITH GREEN INSULATION, SIZED IN ACCORDANCE WITH THE NEC, SHALL BE FURNISHED AND INSTALLED
- WITH THE POWER CIRCUITS TO BTS EQUIPMENT. EACH CABINET FRAME SHALL BE DIRECTLY CONNECTED TO THE MASTER GROUND BAR WITH GREEN INSULATED SUPPLEMENTAL EQUIPMENT GROUND WIRES, #6 STRANDED COPPER OR LARGER FOR INDOOR BTS; #2 BARE SOLID TINNED
- COPPER FOR OUTDOOR BTS. CONNECTIONS TO THE GROUND BUS SHALL NOT BE DOUBLED UP OR STACKED BACK TO BACK CONNECTIONS ON OPPOSITE SIDE OF THE GROUND BUS ARE PERMITTED.
- ALL EXTERIOR GROUND CONDUCTORS BETWEEN EQUIPMENT/GROUND BARS AND THE GROUND RING SHALL BE #2 SOLID TINNED COPPER UNLESS OTHERWISE INDICATED.
- ALUMINUM CONDUCTOR OR COPPER CLAD STEEL CONDUCTOR SHALL NOT BE USED FOR GROUNDING CONNECTIONS. USE OF 90° BENDS IN THE PROTECTION GROUNDING CONDUCTORS SHALL BE AVOIDED WHEN 45° BENDS CAN BE ADEQUATELY SUPPORTED
- 11. EXOTHERMIC WELDS SHALL BE USED FOR ALL GROUNDING CONNECTIONS BELOW GRADE.
- 12. ALL GROUND CONNECTIONS ABOVE GRADE (INTERIOR AND EXTERIOR) SHALL BE FORMED USING HIGH PRESS CRIMPS. 13. COMPRESSION GROUND CONNECTIONS MAY BE REPLACED BY EXOTHERMIC WELD CONNECTIONS.
- 14. ICE BRIDGE BONDING CONDUCTORS SHALL BE EXOTHERMICALLY BONDED OR BOLTED TO THE BRIDGE AND THE TOWER GROUND BAR.
- 15. APPROVED ANTIOXIDANT COATINGS (i.e. CONDUCTIVE GEL OR PASTE) SHALL BE USED ON ALL COMPRESSION AND BOLTED GROUND CONNECTIONS.
- 16. ALL EXTERIOR GROUND CONNECTIONS SHALL BE COATED WITH A CORROSION RESISTANT MATERIAL.
- 17. MISCELLANEOUS ELECTRICAL AND NON-ELECTRICAL METAL BOXES, FRAMES AND SUPPORTS SHALL BE BONDED TO THE GROUND RING, IN ACCORDANCE WITH THE NEC. 18. BOND ALL METALLIC OBJECTS WITHIN 6 ft OF MAIN GROUND RING WITH (1) #2 BARE SOLID TINNED COPPER GROUND CONDUCTOR.
- 19. GROUND CONDUCTORS USED FOR THE FACILITY GROUNDING AND LIGHTNING PROTECTION SYSTEMS SHALL NOT BE ROUTED THROUGH METALLIC OBJECTS THAT FORM A RING AROUND THE CONDUCTOR, SUCH AS METALLIC CONDUITS, METAL SUPPORT CLIPS OR SLEEVES THROUGH WALLS OR FLOORS. WHEN IT IS REQUIRED TO BE HOUSED IN CONDUIT TO MEET CODE REQUIREMENTS OR LOCAL CONDITIONS, NON-METALLIC MATERIAL SUCH AS PVC CONDUIT SHALL BE USED. WHERE USE OF METAL CONDUIT IS UNAVOIDABLE (i.e., NONMETALLIC CONDUIT PROHIBITED BY LOCAL CODE) THE GROUND CONDUCTOR SHALL BE BONDED TO EACH END OF THE METAL CONDUIT.
- 20. ALL GROUNDS THAT TRANSITION FROM BELOW GRADE TO ABOVE GRADE MUST BE #2 BARE SOLID TINNED COPPER IN 3/4" NON-METALLIC, FLEXIBLE CONDUIT FROM 24" BELOW GRADE TO WITHIN 3" TO 6" OF CAD-WELD TERMINATION POINT. THE EXPOSED END OF THE CONDUIT MUST BE SEALED WITH SILICONE CAULK. (ADD TRANSITIONING GROUND STANDARD DETAIL AS WELL).
- 21. BUILDINGS WHERE THE MAIN GROUNDING CONDUCTORS ARE REQUIRED TO BE ROUTED TO GRADE, THE CONTRACTOR SHALL ROUTE TWO GROUNDING CONDUCTORS FROM THE ROOFTOP, TOWERS, AND WATER TOWERS GROUNDING RING, TO THE EXISTING GROUNDING SYSTEM, THE GROUNDING CONDUCTORS SHALL NOT BE SMALLER THAN 2/0 COPPER. ROOFTOP GROUNDING RING SHALL BE BONDED TO THE EXISTING GROUNDING SYSTEM, THE BUILDING STEEL COLUMNS, LIGHTNING PROTECTION SYSTEM, AND BUILDING MAIN WATER LINE (FERROUS OR NONFERROUS METAL PIPING ONLY).

ELECTRICAL INSTALLATION NOTES:

- ALL ELECTRICAL WORK SHALL BE PERFORMED IN ACCORDANCE WITH THE PROJECT SPECIFICATIONS, NEC AND ALL APPLICABLE FEDERAL, STATE, AND LOCAL CODES/ORDINANCES.
- CONDUIT ROUTINGS ARE SCHEMATIC. CONTRACTOR SHALL INSTALL CONDUITS SO THAT ACCESS TO EQUIPMENT IS NOT BLOCKED
- AND TRIP HAZARDS ARE ELIMINATED.
- 3. WIRING, RACEWAY AND SUPPORT METHODS AND MATERIALS SHALL COMPLY WITH THE REQUIREMENTS OF THE NEC. 4. ALL CIRCUITS SHALL BE SEGREGATED AND MAINTAIN MINIMUM CABLE SEPARATION AS REQUIRED BY THE NEC.
- ALL EQUIPMENT SHALL BEAR THE UNDERWRITERS LABORATORIES LABEL OF APPROVAL, AND SHALL CONFORM TO REQUIREMENT OF THE NATIONAL ELECTRICAL CODE.
- ALL OVERCURRENT DEVICES SHALL HAVE AN INTERRUPTING CURRENT RATING THAT SHALL BE GREATER THAN THE SHORT CIRCUIT CURRENT TO WHICH THEY ARE SUBJECTED, 22,000 AIC MINIMUM. VERYIFY AVAILABLE SHORT CIRCUIT CURRENT DOES NOT EXCEED THE RATING OF ELECTRICAL EQUIPMENT IN ACCORDANCE WITH ARTICLE 110.24 NEC OR THE MOST CURRENT ADOPTED CODE PRE THE GOVERNING JURISDICTION.
- EACH END OF EVERY POWER PHASE CONDUCTOR, GROUNDING CONDUCTOR, AND TELCO CONDUCTOR OR CABLE SHALL BE LABELED WITH COLOR-CODED INSULATION OR ELECTRICAL TAPE (3M BRAND, 1/2" PLASTIC ELECTRICAL TAPE WITH UV PROTECTION, OR EQUAL). THE IDENTIFICATION METHOD SHALL CONFORM WITH NEC AND OSHA.
- ALL ELECTRICAL COMPONENTS SHALL BE CLEARLY LABELED WITH LAMICOID TAGS SHOWING THEIR RATED VOLTAGE, PHASE CONFIGURATION. WIRE CONFIGURATION, POWER OR AMPACITY RATING AND BRANCH CIRCUIT ID NUMBERS (i.e. PANEL BOARD AND CIRCUIT ID'S).
- PANEL BOARDS (ID NUMBERS) SHALL BE CLEARLY LABELED WITH PLASTIC LABELS
- 8. ALL TIE WRAPS SHALL BE CUT FLUSH WITH APPROVED CUTTING TOOL TO REMOVE SHARP EDGES. ALL POWER AND EQUIPMENT GROUND WIRING IN TUBING OR CONDUIT SHALL BE SINGLE COPPER CONDUCTOR (#14 OR LARGER) WITH TYPE THHW, THWN, THWN-2, XHHW, XHHW-2, THW, THW-2, RHW, OR RHW-2 INSULATION UNLESS OTHERWISE SPECIFIED.
- 10. SUPPLEMENTAL EQUIPMENT GROUND WIRING LOCATED INDOORS SHALL BE SINGLE COPPER CONDUCTOR (#6 OR LARGER) WITH
- TYPE THHW, THWN, THWN-2, XHHW, XHHW-2, THW, THW-2, RHW, OR RHW-2 INSULATION UNLESS OTHERWISE SPECIFIED. 11. POWER AND CONTROL WIRING IN FLEXIBLE CORD SHALL BE MULTI-CONDUCTOR, TYPE SOOW CORD (#14 OR LARGER) UNLESS
- OTHERWISE SPECIFIED. 12. POWER AND CONTROL WIRING FOR USE IN CABLE TRAY SHALL BE MULTI—CONDUCTOR, TYPE TC CABLE (#14 OR LARGER), WITH
- TYPE THHW, THWN, THWN-2, XHHW, XHHW-2, THW, THW-2, RHW, OR RHW-2 INSULATION UNLESS OTHERWISE SPECIFIED. 13. ALL POWER AND GROUNDING CONNECTIONS SHALL BE CRIMP—STYLE, COMPRESSION WIRE LUGS AND WIRE NUTS BY THOMAS AND
- BETTS (OR EQUAL). LUGS AND WIRE NUTS SHALL BE RATED FOR OPERATION NOT LESS THAN 75° C (90° C IF AVAILABLE). 14. RACEWAY AND CABLE TRAY SHALL BE LISTED OR LABELED FOR ELECTRICAL USE IN ACCORDANCE WITH NEMA, UL, ANSI/IEEE
- 15. ELECTRICAL METALLIC TUBING (EMT), INTERMEDIATE METAL CONDUIT (IMC), OR RIGID METAL CONDUIT (RMC) SHALL BE USED FOR 💵
- EXPOSED INDOOR LOCATIONS 16. ELECTRICAL METALLIC TUBING (EMT) OR METAL-CLAD CABLE (MC) SHALL BE USED FOR CONCEALED INDOOR LOCATIONS.
- 17. SCHEDULE 40 PVC UNDERGROUND ON STRAIGHTS AND SCHEDULE 80 PVC FOR ALL ELBOWS/90s AND ALL APPROVED ABOVE GRADE PVC CONDUIT.
- 18. LIQUID-TIGHT FLEXIBLE METALLIC CONDUIT (LIQUID-TITE FLEX) SHALL BE USED INDOORS AND OUTDOORS, WHERE VIBRATION OCCURS OR FLEXIBILITY IS NEEDED.
- 19. CONDUIT AND TUBING FITTINGS SHALL BE THREADED OR COMPRESSION-TYPE AND APPROVED FOR THE LOCATION USED. SET SCREW FITTINGS ARE NOT ACCEPTABLE.
- 20. CABINETS, BOXES AND WIRE WAYS SHALL BE LABELED FOR ELECTRICAL USE IN ACCORDANCE WITH NEMA, UL, ANSI/IEEE AND
- 21. WIREWAYS SHALL BE METAL WITH AN ENAMEL FINISH AND INCLUDE A HINGED COVER, DESIGNED TO SWING OPEN DOWNWARDS
- (WIREMOLD SPECMATE WIREWAY).
- 22. SLOTTED WIRING DUCT SHALL BE PVC AND INCLUDE COVER (PANDUIT TYPE E OR EQUAL). 23. CONDUITS SHALL BE FASTENED SECURELY IN PLACE WITH APPROVED NON-PERFORATED STRAPS AND HANGERS. EXPLOSIVE DEVICES (i.e. POWDER-ACTUATED) FOR ATTACHING HANGERS TO STRUCTURE WILL NOT BE PERMITTED. CLOSELY FOLLOW THE LINES OF THE STRUCTURE, MAINTAIN CLOSE PROXIMITY TO THE STRUCTURE AND KEEP CONDUITS IN TIGHT ENVELOPES. CHANGES IN DIRECTION TO ROUTE AROUND OBSTACLES SHALL BE MADE WITH CONDUIT OUTLET BODIES. CONDUIT SHALL BE INSTALLED IN

A NEAT AND WORKMANLIKE MANNER. PARALLEL AND PERPENDICULAR TO STRUCTURE WALL AND CEILING LINES. ALL CONDUIT

SHALL BE FISHED TO CLEAR OBSTRUCTIONS. ENDS OF CONDUITS SHALL BE TEMPORARILY CAPPED FLUSH TO FINISH GRADE TO

- PREVENT CONCRETE, PLASTER OR DIRT FROM ENTERING. CONDUITS SHALL BE RIGIDLY CLAMPED TO BOXES BY GALVANIZED MALLEABLE IRON BUSHING ON INSIDE AND GALVANIZED MALLEABLE IRON LOCKNUT ON OUTSIDE AND INSIDE 24. EQUIPMENT CABINETS, TERMINAL BOXES, JUNCTION BOXES AND PULL BOXES SHALL BE GALVANIZED OR EPOXY-COATED SHEET STEEL. SHALL MEET OR EXCEED UL 50 AND BE RATED NEMA 1 (OR BETTER) FOR INTERIOR LOCATIONS AND NEMA 3R (OR
- BETTER) FOR EXTERIOR LOCATIONS. METAL RECEPTACLE, SWITCH AND DEVICE BOXES SHALL BE GALVANIZED, EPOXY—COATED OR NON—CORRODING; SHALL MEET OR EXCEED UL 514A AND NEMA OS 1 AND BE RATED NEMA 1 (OR BETTER) FOR INTERIOR LOCATIONS AND WEATHER PROTECTED
- (WP OR BETTER) FOR EXTERIOR LOCATIONS. 26. NONMETALLIC RECEPTACLE, SWITCH AND DEVICE BOXES SHALL MEET OR EXCEED NEMA OS 2 (NEWEST REVISION) AND BE RATED
- NEMA 1 (OR BETTER) FOR INTERIOR LOCATIONS AND WEATHER PROTECTED (WP OR BETTER) FOR EXTERIOR LOCATIONS.

APWA UNIFORM COLOR CODE:

PROPOSED EXCAVATION

GASEOUS MATERIALS

POTABLE WATER

SLURRY LINES

EMPORARY SURVEY MARKINGS

LECTRIC POWER LINES, CABLES,

GAS, OIL, STEAM, PETROLEUM, OR

COMMUNICATION. ALARM OR SIGNAL LINES. CABLES, OR CONDUIT AND TRAFFIC LOOPS

ECLAIMED WATER, IRRIGATION, AND

SEWERS AND DRAIN LINES

CONDUIT, AND LIGHTING CABLES

- 27. THE CONTRACTOR SHALL NOTIFY AND OBTAIN NECESSARY AUTHORIZATION FROM THE CARRIER AND/OR CROWN CASTLE USA INC BEFORE COMMENCING WORK ON THE AC POWER DISTRIBUTION PANELS.
- 28. THE CONTRACTOR SHALL PROVIDE NECESSARY TAGGING ON THE BREAKERS, CABLES AND DISTRIBUTION PANELS IN ACCORDANCI WITH THE APPLICABLE CODES AND STANDARDS TO SAFEGUARD LIFE AND PROPERTY. 29. INSTALL LAMICOID LABEL ON THE METER CENTER TO SHOW "AT&T".
- 30. ALL EMPTY/SPARE CONDUITS THAT ARE INSTALLED ARE TO HAVE A METERED MULE TAPE PULL CORD INSTALLED.

CONDUCTOR COLOR CODE							
SYSTEM	CONDUCTOR	COLOR					
	A PHASE	BLACK					
 120/240V, 1Ø	B PHASE	RED					
120/2400, 10	NEUTRAL	WHITE					
	GROUND	GREEN					
	A PHASE	BLACK					
	B PHASE	RED					
120/208V, 3Ø	C PHASE	BLUE					
	NEUTRAL	WHITE					
	GROUND	GREEN					
	A PHASE	BROWN					
	B PHASE	ORANGE OR PURPLE					
277/480V, 3Ø	C PHASE	YELLOW					
	NEUTRAL	GREY					
	GROUND	GREEN					
DC VOLTAGE	POS (+)	RED**					
DC VOLTAGE	NEG (-)	BLACK**					

SEE NEC 210.5(C)(1) AND (2) ** POLARITY MARKED AT TERMINATION

ABBREVIATIONS:

- ANTENNA EXISTING
- FACILITY INTERFACE FRAME GEN GENERATOR
- GPS GLOBAL POSITIONING SYSTEM GSM GLOBAL SYSTEM FOR MOBILE
- LTE LONG TERM EVOLUTION MGB MASTER GROUND BAR
- MW MICROWAVE
- PROPOSED POWER PLANT
- QTY QUANTITY RECT RECTIFIER

NEC

TMA

- RADIO BASE STATION RBS
- RET REMOTE ELECTRIC TILT
- RFDS RADIO FREQUENCY DATA SHEET REMOTE RADIO HEAD
- RRU REMOTE RADIO UNIT
- SIAD SMART INTEGRATED DEVICE
- TYP TYPICAL UMTS UNIVERSAL MOBILE TELECOMMUNICATIONS SYSTEM

NATIONAL ELECTRIC CODE

W.P. WORK POINT

TOWER MOUNTED AMPLIFIER

ATLANTA, GA 30324-3300



MAHWAH, NJ 07430

TOWER ENGINEERING **PROFESSIONALS** 326 TRYON RD

(919) 661-6351

RALEIGH, NC 27603

TEP JOB #: 218229.479065

AT&T SITE NUMBER: CTL05838

BU #: **876368** YANKEE LAKEAST **HAMPTONTOWN**

1 PUBLIC WORKS DRIVE EAST HAMPTON, CT 06424 (MIDDLESEX COUNTY)

EXISTING 180' MONOPOLE

IC.												
CE		ISSUED FOR:										
	REV	DATE	DRWN	DESCRIPTION	DES./Q							
	A	01/13/21	BSE	PRELIMINARY	JTC							
	В	01/25/21	BSE	PRELIMINARY	JTC							
	С	02/12/21	BSE	PRELIMINARY	JTC							
	0	03/09/21	BSE	CONSTRUCTION	JTC							
	1	03/12/21	DCE	CONSTRUCTION	ITC							




IT IS A VIOLATION OF LAW FOR ANY PERSON, UNLESS THEY ARE ACTING UNDER THE DIRECTION OF A LICENSED PROFESSIONAL ENGINEER, TO ALTER THIS DOCUMENT.

SHEET NUMBER:

REVISION:

03/12/21

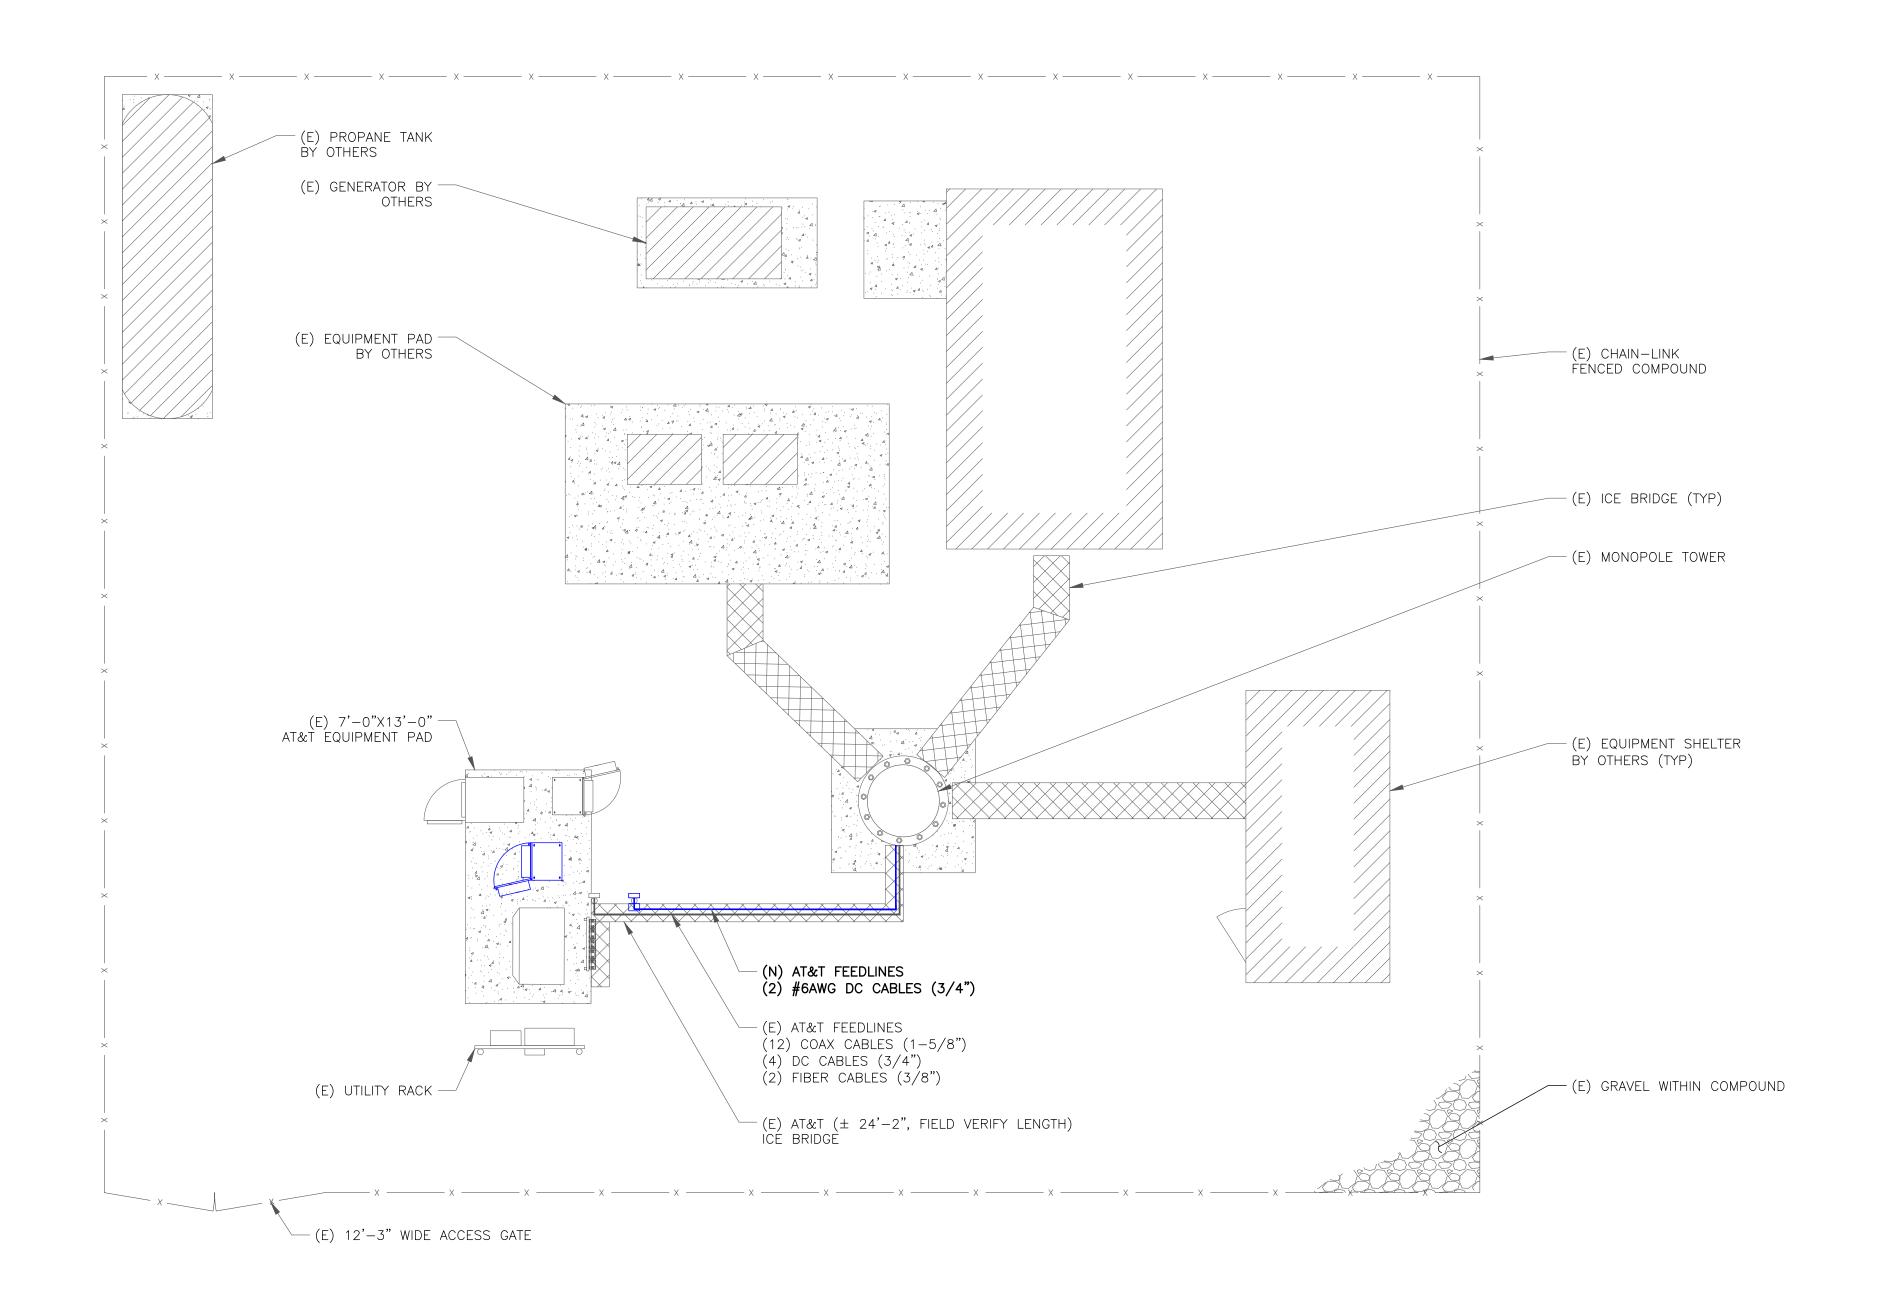





MAHWAH, NJ 07430

TOWER ENGINEERING PROFESSIONALS

326 TRYON RD RALEIGH, NC 27603 (919) 661-6351

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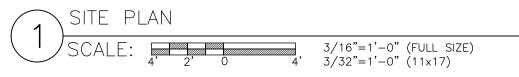
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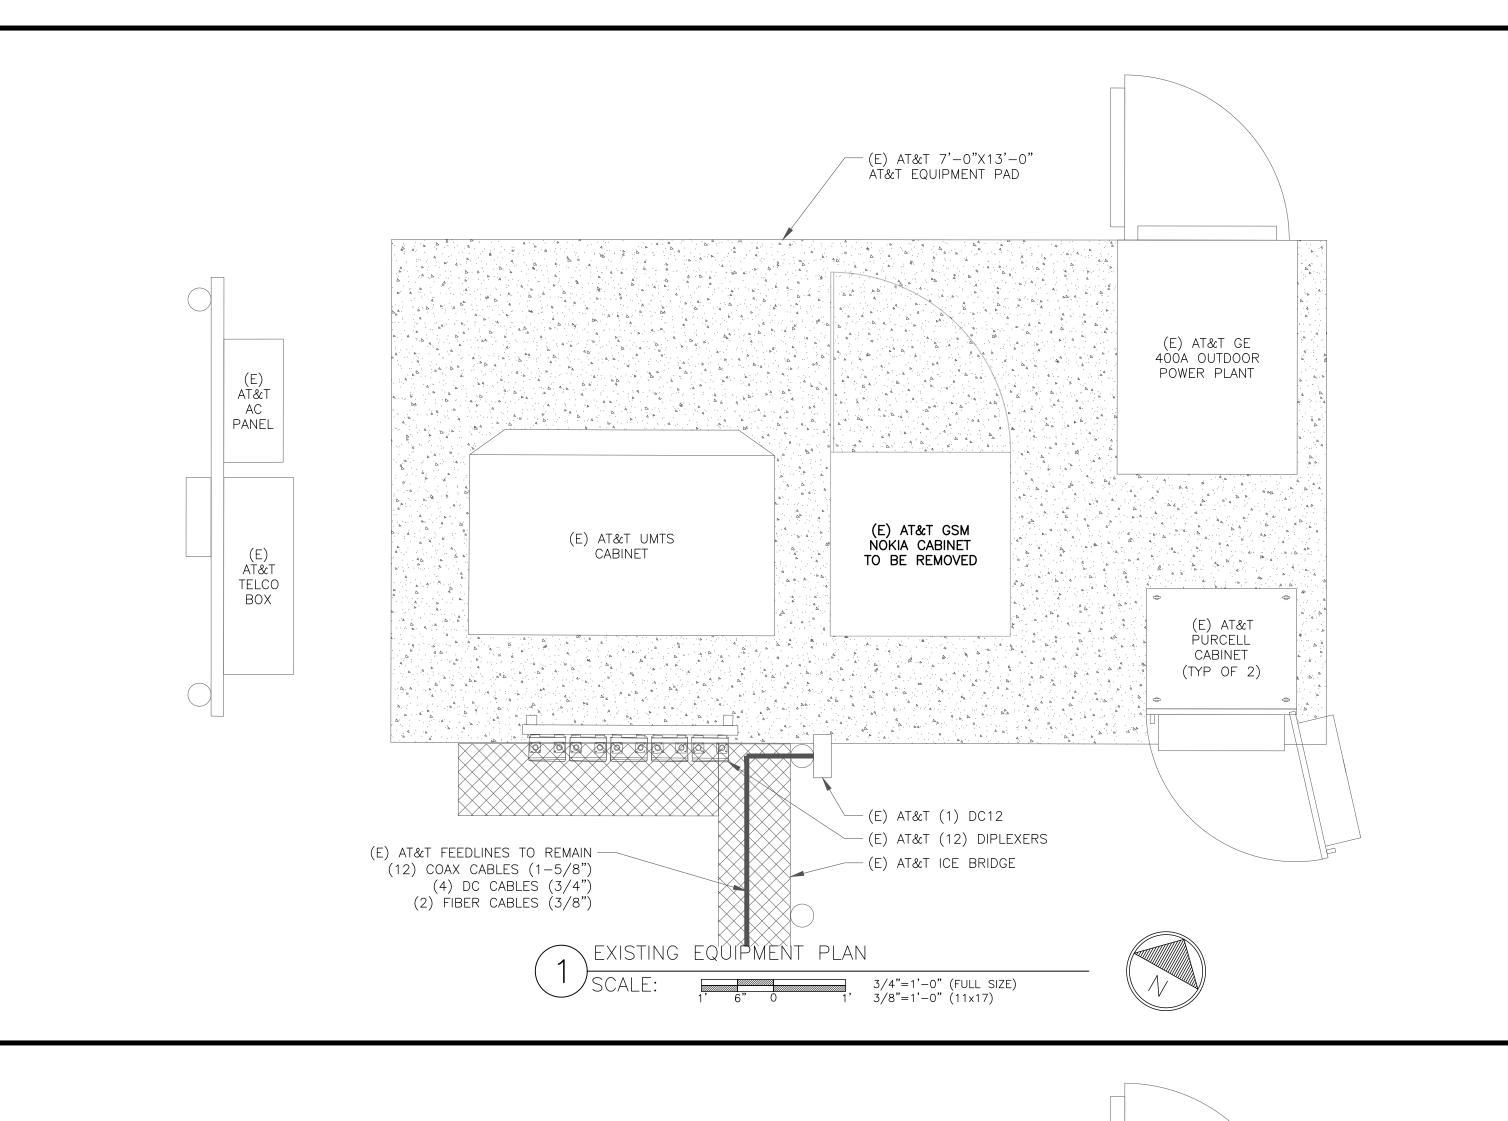
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SHEET NUMBER:

(E) AT&T 7'-0"X13'-0" AT&T EQUIPMENT PAD (E) AT&T GE 400A OUTDOOR POWER PLANT PANEL (N) AT&T EQUIPMENT INSTALL (1) 19" DISTRIBUTION SHELF & (12) VERTIV UP-CONVERTÉRS IN (N) FLX12 CABINET FOR 5G EQUIPMENT (E) AT&T UMTS CABINET (N) AT&T FLX12 CABINET TELCO BOX (E) AT&T (N) AT&T EQUIPMENT PURCELL CABINET INSTALL (1) 6630 BASEBAND, (1) IDLE CABLE & FLEX16 (TYP OF 2) DOOR UPGRATE KIT IN (E) TOP PURCELL CABINET - (E) AT&T (1) DC12 (E) AT&T (12) DIPLEXERS (N) AT&T FEEDLINES (E) AT&T ICE BRIDGE (2) #6AWG DC CABLES (3/4") (N) AT&T FIBER MANAGEMENT BOX (E) AT&T FEEDLINES (12) COAX CABLES (1-5/8")(N) AT&T DC12 (4) DC CABLES (3/4")(2) FIBER CABLES (3/8")

> 3/4"=1'-0" (FULL SIZE) 3/8"=1'-0" (11×17)

GROUND SCOPE OF WORK:

• REMOVE GSM CABINET AND INSTALL NEW FLX12 CABINET


•INSTALL (1) 6630 BASEBAND
•INSTALL (1) IDLE CABLE
•INSTALL (1) 19" DISTRIBUTION SHELF

•INSTALL (12) VERTIV UP—CONVERTERS
•INSTALL (3) Y CABLES ON DUAL BAND RRHS

•INSTALL (1) FLEX16 DOOR UPGRATE KIT •INSTALL (1) DC12 •INSTALL (1) FIBER MANAGEMENT BOX

THE POWER DESIGN FOR ANY AC ELECTRICAL POWER CHANGES IS TO BE PERFORMED BY OTHERS AND IS SHOWN HERE FOR REFERENCE PURPOSES ONLY.

AT&T IS SOLELY RESPONSIBLE FOR THE ELECTRICAL AT&T IS SOLELY RESPONSIBLE FOR THE ELECTRICAL POWER DESIGN.

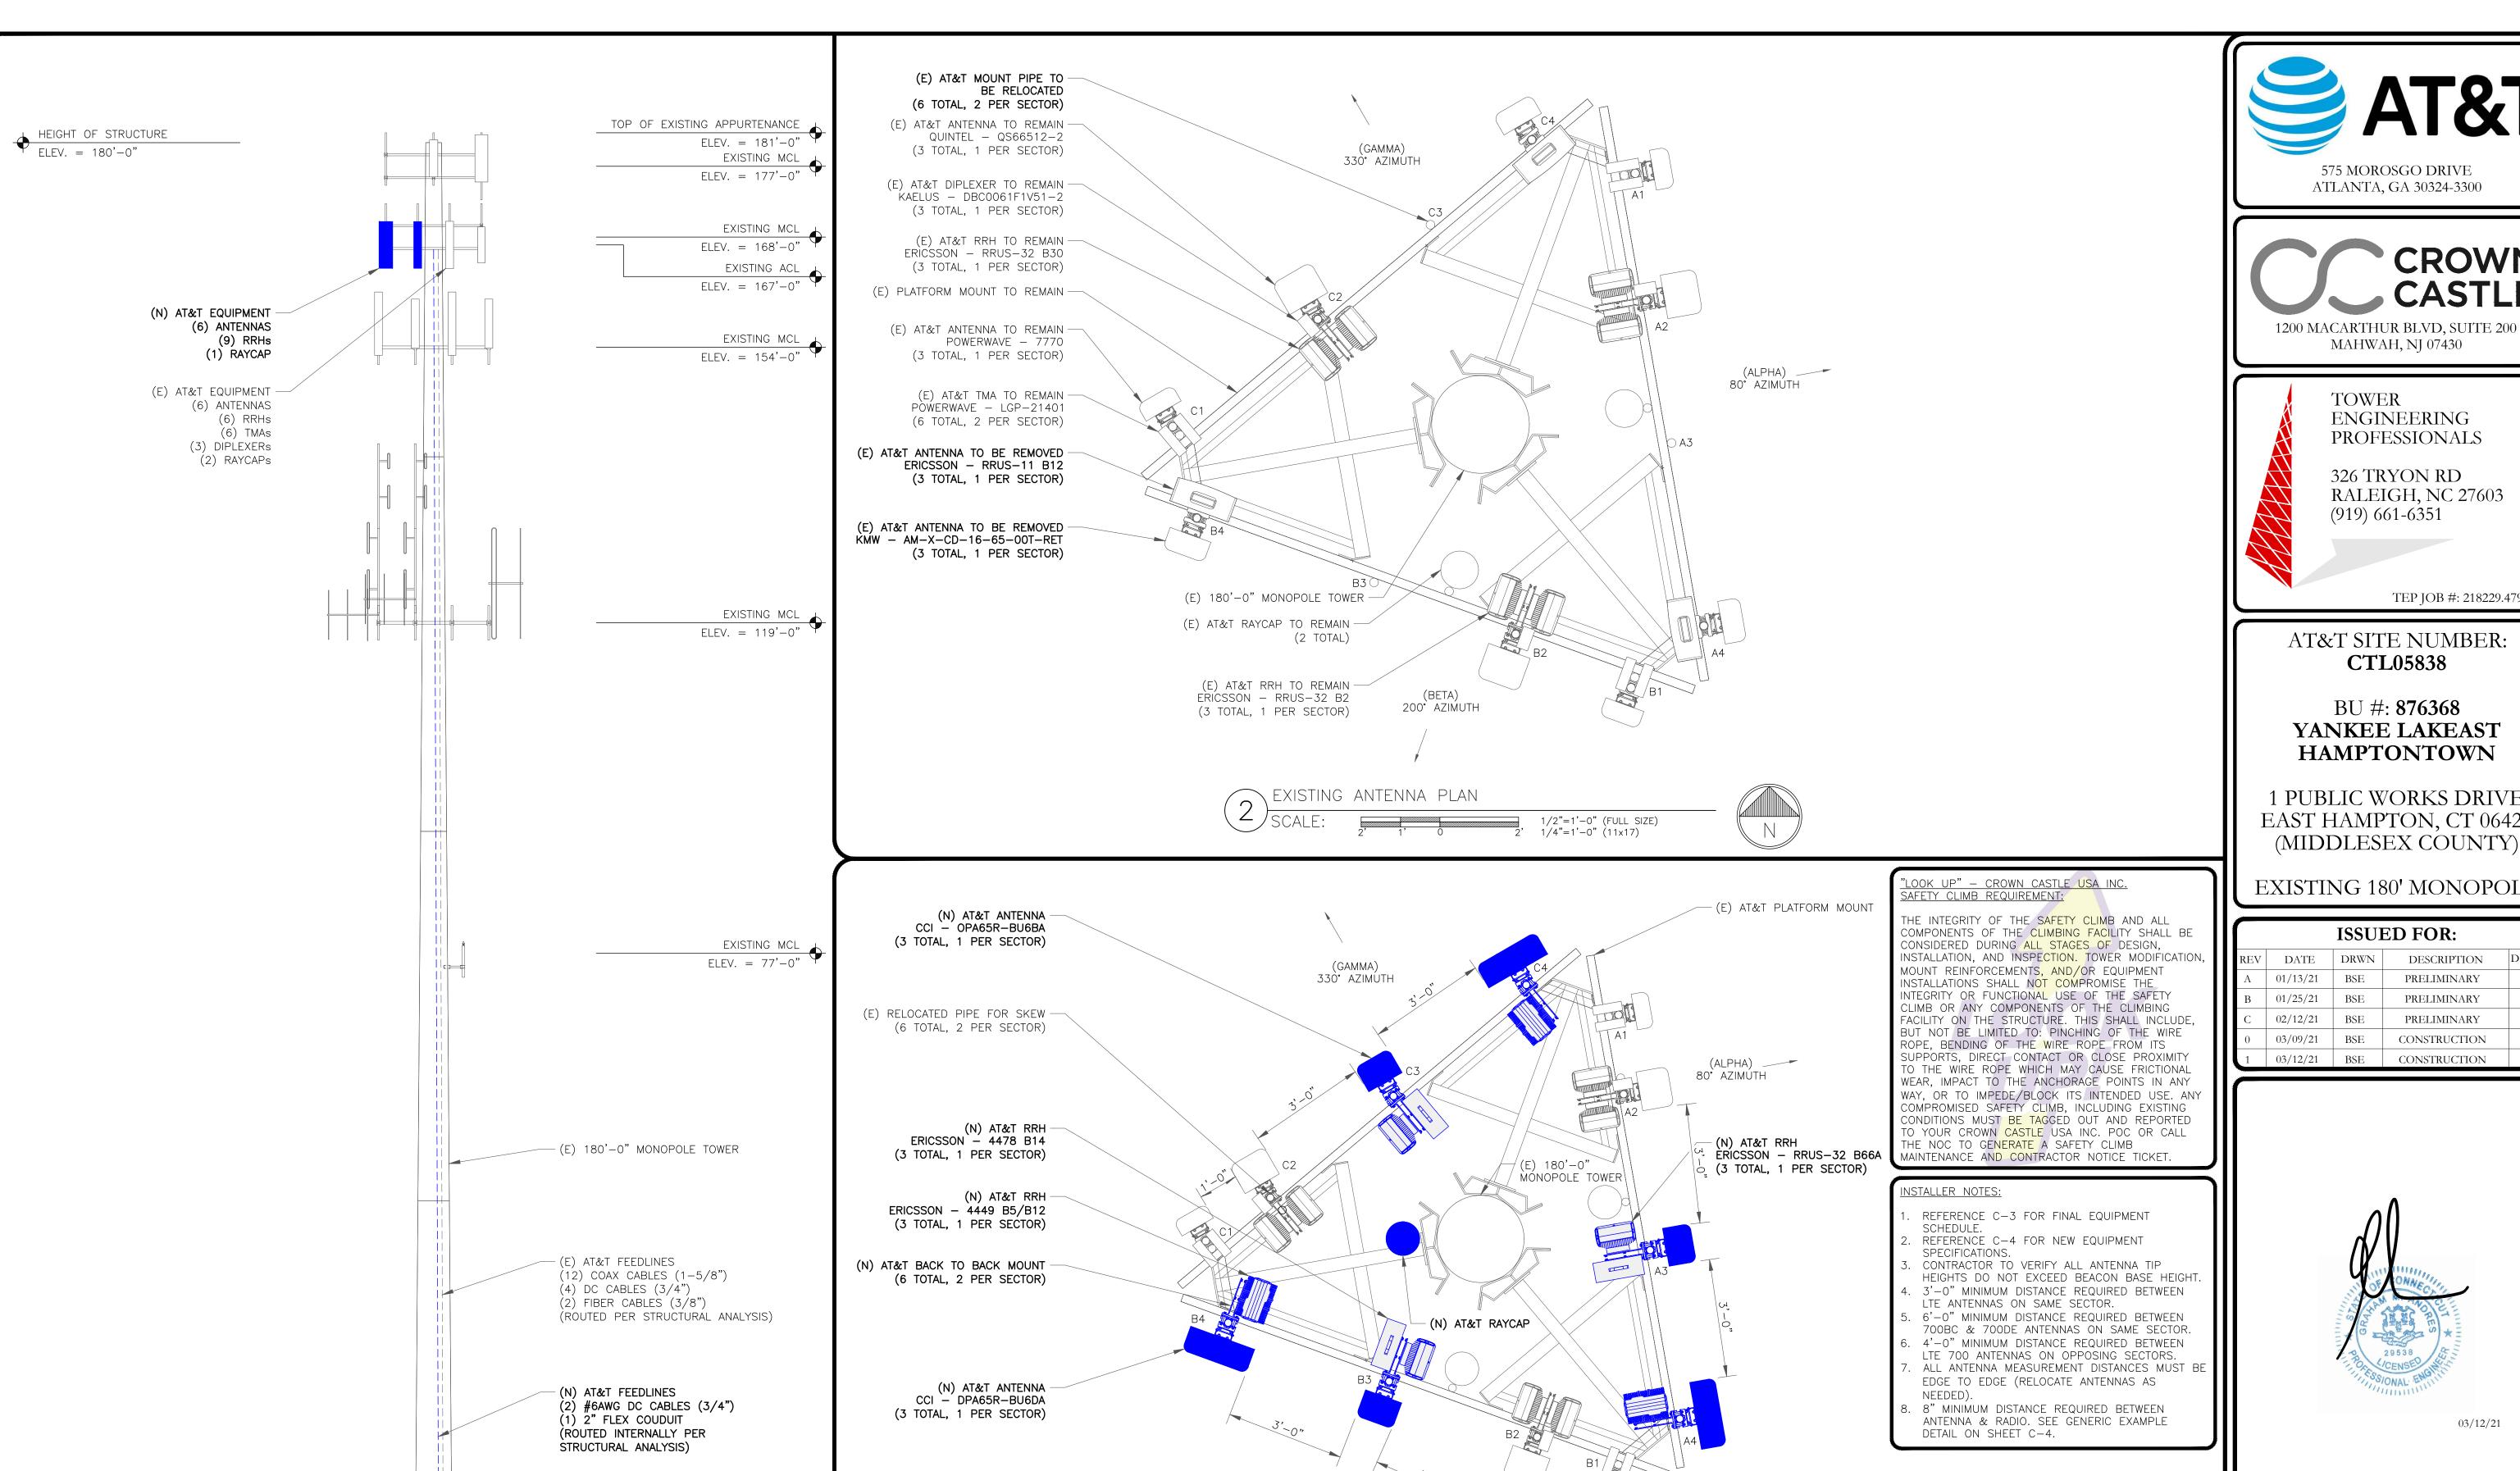

REFERENCE

FINAL ELEVATION

CALE: NOT TO SCALE

200° AZIMUTH

1/2"=1'-0" (FULL SIZE) 1/4"=1'-0" (11x17)





TOWER ENGINEERING PROFESSIONALS

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BU #: **876368** YANKEE LAKEAST **HAMPTONTOWN**

1 PUBLIC WORKS DRIVE EAST HAMPTON, CT 06424 (MIDDLESEX COUNTY)

EXISTING 180' MONOPOLE

ISSUED FOR:												
REV	DATE	DRWN	DESCRIPTION	DES./QA								
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В	01/25/21	BSE	PRELIMINARY	JTC								
С	02/12/21	BSE	PRELIMINARY	JTC								
0	03/09/21	BSE	CONSTRUCTION	JTC								
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03/12/21

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SHEET NUMBER:

ALPHA							EQUIPM Y WITH										
ANTENNA RADIO DIPLEXER TMA SURGE PROTECTION								CABLES	<u> </u>								
POSITION	TECH.	STATUS/MANUFACTURER MODEL	AZIMUTH	RAD CENTER	QTY.	STATUS/MODEL	LOCATION QTY.	STATUS	LOCATION	QTY.	STATUS/MANUFACTURER MODEL	QTY.	STATUS/MODEL	QTY.	STATUS/TYPE	SIZE	LENGTH
A1	UMTS 850	(E) POWERWAVE 7770	80°	167'	_	_	- 2	(E)	GROUND	2	(E) POWERWAVE — LGP—21401	_	_	2	(E) COAX 1	-5/8"	219'-0"
	LTE				1	(E) RRUS-32 B2	TOWER 1	(E)	TOWER				(E)	1			219'-0"
A2	1900/WCS	(E) QUINTEL QS66512-2	80°	167'	1	(E) RRUS-32 B30	TOWER 1	(E)	GROUND	-	_	1	(E) DC6-48-60-18-8C-EV	2			219'-0" 219'-0"
	LTE				1	(N) 4478 B14	TOWER									,	
A3	700/AWS	(N) CCI OPA65R-BU6BA	80°	167'	1	(N) RRUS-32 B66A	TOWER -	_	_	-	_	-	_	-	-	-	-
A4	LTE 700/850/ 5G 850	(N) CCI DMP65R-BU6DA	80°	167'	1	(N) 4449 B5/B12	TOWER -	_	-	_	_	_	_	_	-	-	-
ВЕТА																	
B1	UMTS 850	(E) POWERWAVE 7770	200°	167'	_	_	- 2	(E)	GROUND	2	(E) POWERWAVE — LGP—21401	_	_	2	(E) COAX 1	-5/8"	219'-0"
	LTE	(E) OUNTEL OCCC540 0	0000		1	(E) RRUS-32 B2	TOWER 1	(E)	TOWER				(F) DOC 40 CO 40 OF	1			219'-0"
B2	LTE 1900/WCS	(E) QUINTEL QS66512-2	200°	167'	1	(E) RRUS-32 B30	TOWER 1	(E)	GROUND		_	1	(E) DC6-48-60-18-8F	2			219'-0" 219'-0"
	LTE	(1)			1	(N) 4478 B14	TOWER										
B3	700/AWS	(N) CCI OPA65R-BU6BA	200°	167'	1	(N) RRUS-32 B66A	TOWER	_	_	_	_	_	_	_	_	_	_
B4	LTE 700/850/ 5G 850	(N) CCI DMP65R-BU6DA	200*	167'	1	(N) 4449 B5/B12	TOWER -	_	_	_	_	_	_		-	_	-
GAMMA					T .							T					
C1	UMTS 850	(E) POWERWAVE 7770	330°	167'	_	_	- 2	(E)	GROUND	2	(E) POWERWAVE – LGP-21401	_	_	2	(E) COAX 1	-5/8"	219'-0"
C2	LTE	(E) QUINTEL QS66512-2	330°	107'	1	(E) RRUS-32 B2	TOWER 1	(E)	TOWER				(N)	2	(N) #6AWG DC	3/4"	219'-0"
C2	1900/WCS	(E) QUINTEL Q300312-2	330	167'	1	(E) RRUS-32 B30	TOWER 1	(E)	GROUND		_		(N) DC6-48-60-18-8C-EV	2	(E) COAX 1	-5/8"	219'-0"
C3	LTE	(N) CCI OPA65R-BU6BA	330°	167'	1	(N) 4478 B14	TOWER	_			_						_
	700/AWS	(II) OOI OI AOOIN-BOODA	330	107	1	(N) RRUS-32 B66A	TOWER	_		_	_	_	_		_	_	_
C4	LTE 700/850/ 5G 850	(N) CCI DMP65R-BU6DA	330°	167'	1	(N) 4449 B5/B12	TOWER -	_	_	_	_	_	_	_	-	-	-
NOTE:			1	<u> </u>					1			1	1				

NOTE: (E) - EXISTING (N) - NEW







TOWER

ENGINEERING PROFESSIONALS

326 TRYON RD RALEIGH, NC 27603 (919) 661-6351

TEP JOB #: 218229.479065

AT&T SITE NUMBER: CTL05838

BU #: **876368** YANKEE LAKEAST HAMPTONTOWN

1 PUBLIC WORKS DRIVE EAST HAMPTON, CT 06424 (MIDDLESEX COUNTY)

EXISTING 180' MONOPOLE

	ISSUED FOR:											
REV	DATE	DRWN	DESCRIPTION	DES./QA								
A	01/13/21	BSE	PRELIMINARY	JTC								
В	01/25/21	BSE	PRELIMINARY	JTC								
С	02/12/21	BSE	PRELIMINARY	JTC								
0	03/09/21	BSE	CONSTRUCTION	JTC								
1	03/12/21	BSE	CONSTRUCTION	JTC								




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SHEET NUMBER:

INSTALLER NOTES:

- 1. COMPLY WITH MANUFACTURERS INSTRUCTIONS TO ENSURE THAT ALL RRHs RECEIVE ELECTRICAL POWER WITHIN 24 HOURS OF BEING REMOVED FROM THE MANUFACTURER'S PACKAGING.
- 2. DO NOT OPEN RRH PACKAGES IN THE RAIN.
 3. ALL PIPES, BRACKETS, AND MISCELLANEOUS HARDWARE TO BE GALVANIZED UNLESS NOTED OTHERWISE.




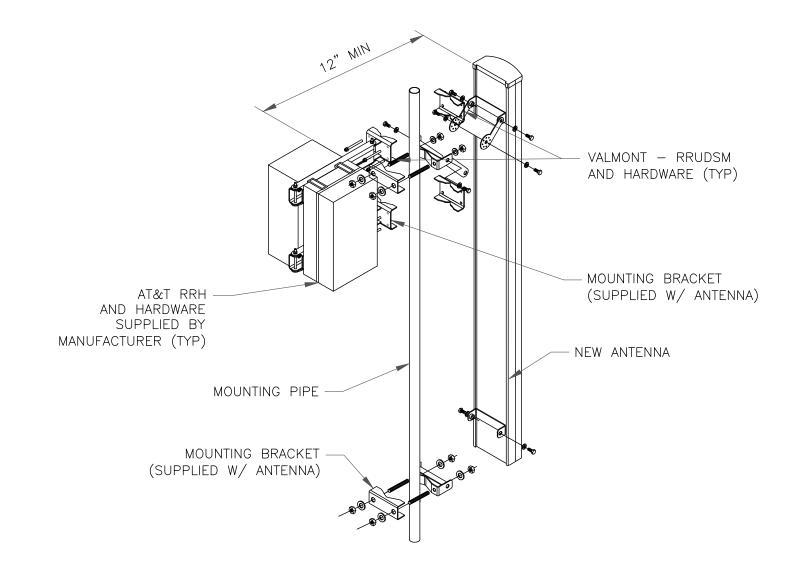


DC6-48-60-18-8C-EV


RAYCAP - DC6-48-60-18-8C-EV NOMINAL OPERATING VOLTAGE: 48 VDC VOLTAGE PROTECTION RATING: 400 V WIND LOADING: 150 MPH SUSTAINED (105.7 LBS) WIND LOADING: 195 MPH GUST (213.6 LBS)

CONTRACTOR TO USE "THREAD LUBRICANT" ON MOUNTING BOLTS DURING INSTALLATION

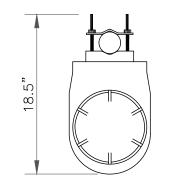

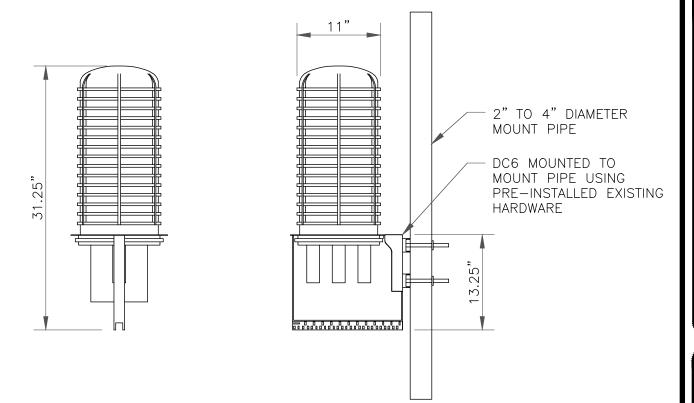

CONNECTING CONDUIT TO OVP.

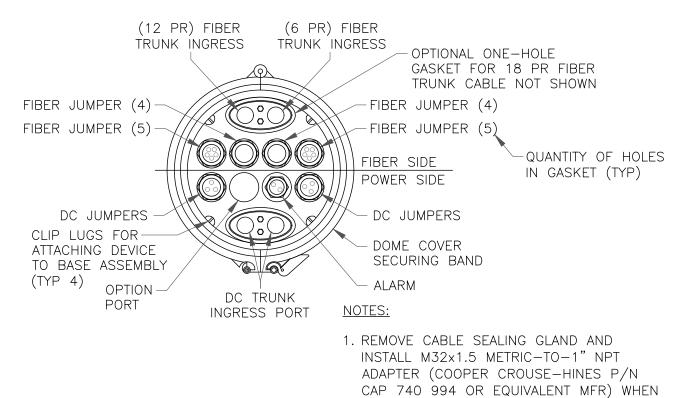

SQUID MOUNTING DETAIL

(2) SCALE: NOT TO SCALE





MAHWAH, NJ 07430

TOWER ENGINEERING PROFESSIONALS

326 TRYON RD RALEIGH, NC 27603 (919) 661-6351

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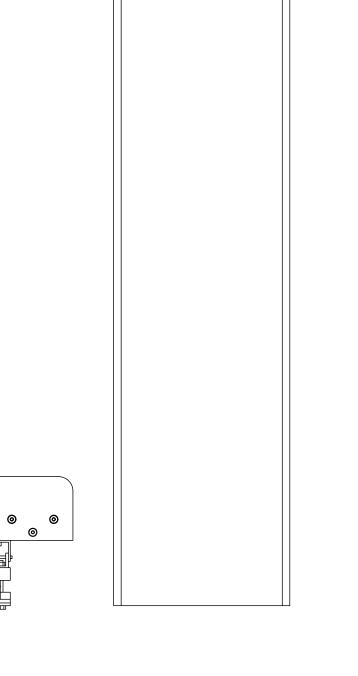
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REVISION:


ANTENNA WITH RRHS MOUNTING DETAIL


SCALE: NOT TO SCALE




CCI — DMP65R—BU6DA WEIGHT (WITHOUT MOUNTING HARDWARE): 96.0 LBS SIZE (HxWxD): 71.20x20.7x7.70 IN.

CCI - DMP65R-BU6DA

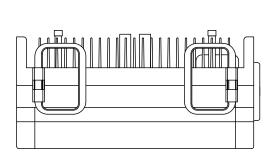

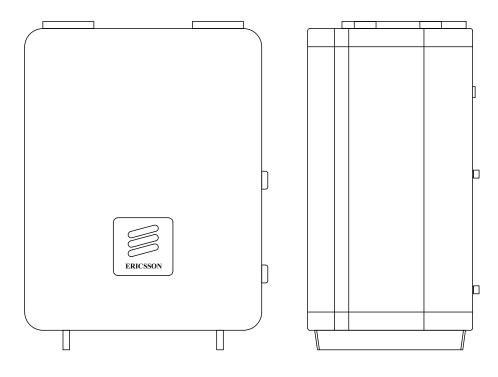


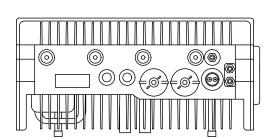



ERICSSON — RADIO 4478 B14 WEIGHT: 59.9 LBS SIZE (HxWxD): 16.50x13.40x7.70 IN.


ERICSSON - RADIO 4478 B14 SCALE: NOT TO SCALE




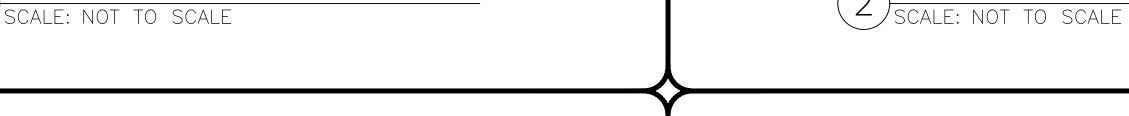

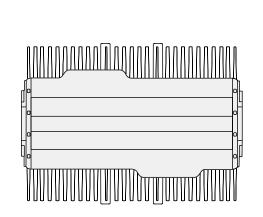

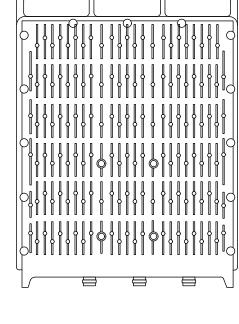


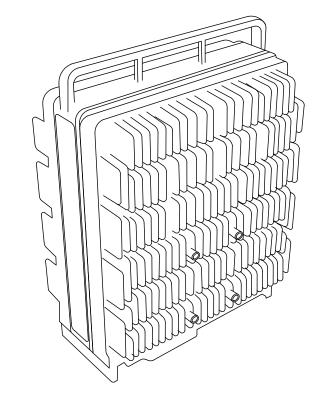


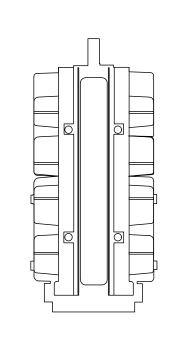

ERICSSON - RADIO 4449 B5/B12 WEIGHT: 71.0 LBS SIZE (HxWxD): 17.90x13.19x9.44 IN.


ERICSSON - RADIO 4449 B5/B12 SCALE: NOT TO SCALE

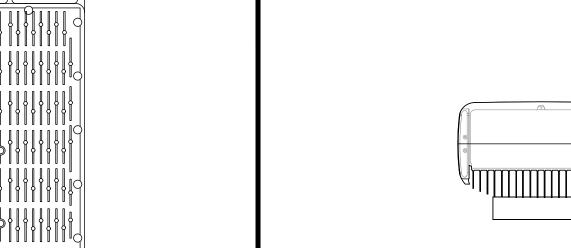

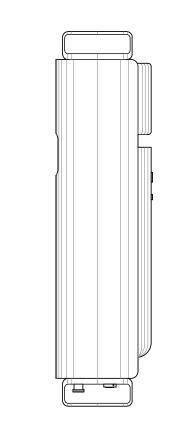


CCI — OPA65R—BU6BA WEIGHT (WITHOUT MOUNTING HARDWARE): 55.0 LBS SIZE (HxWxD): 71.10x11.7x8.40 IN.


CCI - OPA65R-BU6BA

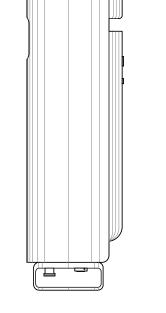

ERICSSON — RRUS—32 B66A WEIGHT: 55.12 LBS SIZE (HxWxD): 27.60x12.45x7.41 IN.

ERICSSON - RRUS-32 B66A SCALE: NOT TO SCALE

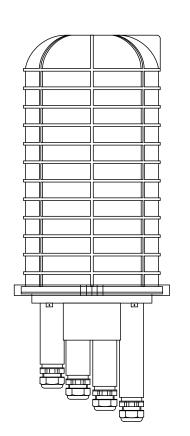

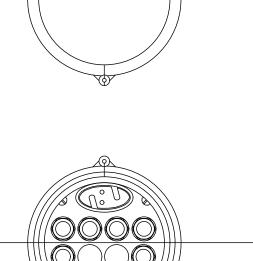

RAYCAP - DC6-48-60-18-8C-EV WEIGHT: 32.80 LBS SIZE (HxWxD): 31.25x11.0x11.0 IN.

(6) SCALE: NOT TO SCALE





MAHWAH, NJ 07430



RALEIGH, NC 27603

(919) 661-6351

TEP JOB #: 218229.479065

AT&T SITE NUMBER: CTL05838

BU #: **876368** YANKEE LAKEAST **HAMPTONTOWN**

1 PUBLIC WORKS DRIVE EAST HAMPTON, CT 06424 (MIDDLESEX COUNTY)


EXISTING 180' MONOPOLE

	ISSUED FOR:												
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SHEET NUMBER:



GROUNDING PLAN LEGEND:

--- GROUND WIRE

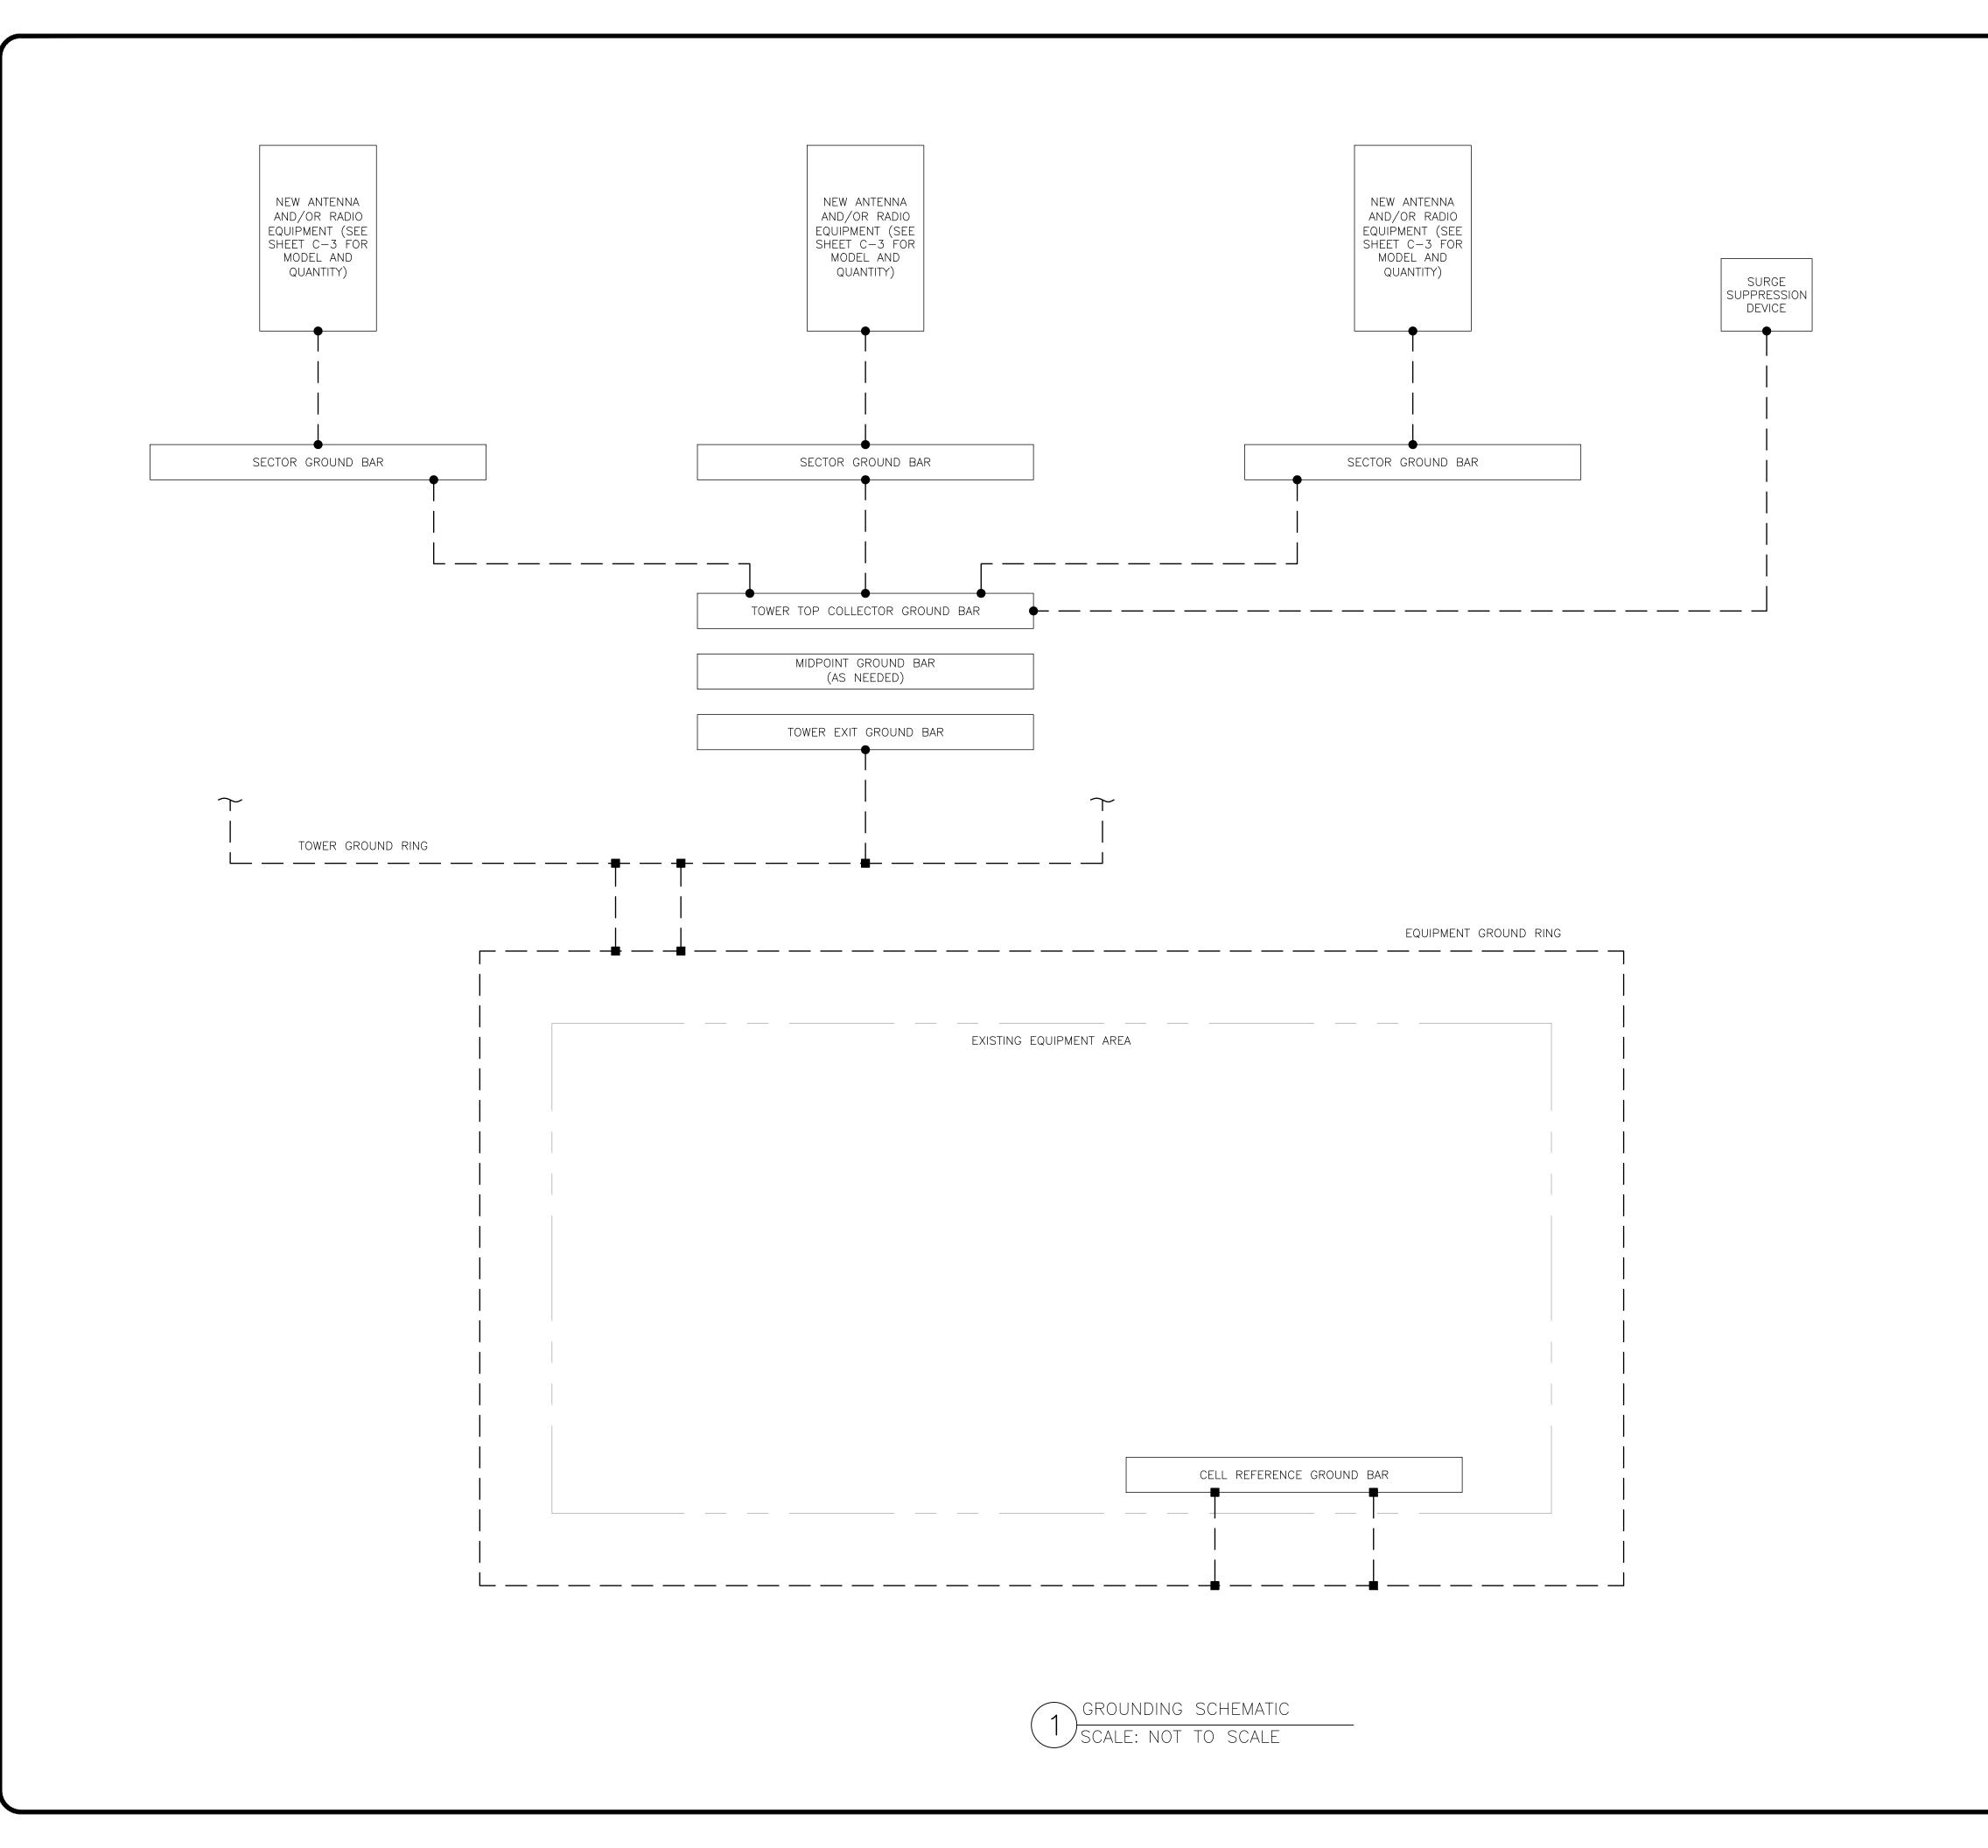© COPPER GROUND ROD

■ EXOTHERMIC WELD

MECHANICAL CONNECTION

S GROUND ROD W/ TEST WELL

CELL REFERENCE GROUND BAR: POINT OF GROUND REFERENCE FOR ALL COMMUNICATIONS EQUIPMENT FRAMES. ALL BONDS ARE MADE WITH #2 STRANDED GREEN INSULATED COPPER CONDUCTORS. BOND TO GROUND RING WITH (2) #2 SOLID TINNED COPPER CONDUITS (ATT-TP-76416 7.6.7).

HATCH PLATE GROUND BAR: BOND TO THE INTERIOR GROUND RING WITH (2) #2 STRANDED GREEN INSULATED COPPER CONDUCTORS. WHEN A HATCH-PLATE AND A CELL REFERENCE GROUND BAR ARE BOTH PRESENT, THE CELL SITE REFERENCE GROUND BAR MUST BE CONNECTED TO THE HATCH-PLATE AND TO THE INTERIOR GROUND RING USING (2) #2 STRANDED GREEN INSULATED COPPER CONDUCTORS.

EXTERIOR CABLE ENTRY PORT GROUND BARS:
LOCATED AT THE ENTRANCE TO THE CELL SITE
BUILDING. BOND TO GROUND RING WITH A #2 SOLID
TINNED COPPER CONDUCTORS WITH AN EXOTHERMIC
WELD AND INSPECTION SLEEVE (ATT-TP-76416
7.6.7.2).

DURING ALL DC POWER SYSTEM CHANGES INCLUDING DC SYSTEM CHANGE OUTS, RECTIFIER REPLACEMENTS OR ADDITIONS, BREAKER DISTRIBUTION CHANGES, BATTERY ADDITIONS, BATTERY REPLACEMENTS AND INSTALLATIONS OR CHANGES TO DC CONVERTER SYSTEMS IT SHALL BE REQUIRED THAT SERVICES CONTRACTORS VERIFY ALL DC POWER SYSTEMS ARE EQUIPPED WITH MASTER DC SYSTEM RETURN GROUND CONDUCTOR FROM THE DC POWER SYSTEM COMMON RETURN BUS DIRECTLY CONNECTED TO THE CELL SITE REFERENCE GROUND BAR PER TP76300 SECTION H 6 AND TP76416 FIGURE 7-11 REQUIREMENTS.



ATLANTA, GA 30324-3300

CROWN CASTLE
1200 MACARTHUR BLVD, SUITE 200

MAHWAH, NJ 07430

TOWER ENGINEERING PROFESSIONALS

326 TRYON RD RALEIGH, NC 27603 (919) 661-6351

TEP JOB #: 218229.479065

AT&T SITE NUMBER: CTL05838

BU #: 876368 YANKEE LAKEAST HAMPTONTOWN

1 PUBLIC WORKS DRIVE EAST HAMPTON, CT 06424 (MIDDLESEX COUNTY)

EXISTING 180' MONOPOLE

	ISSUED FOR										
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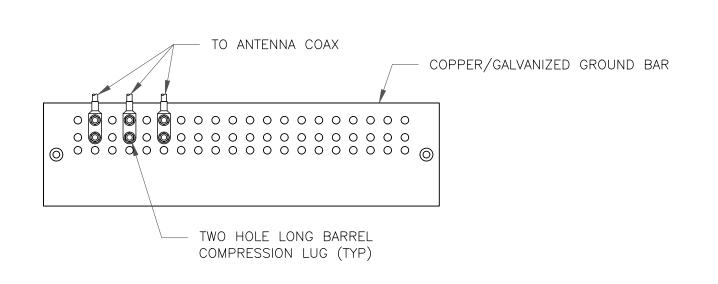


03/12/21

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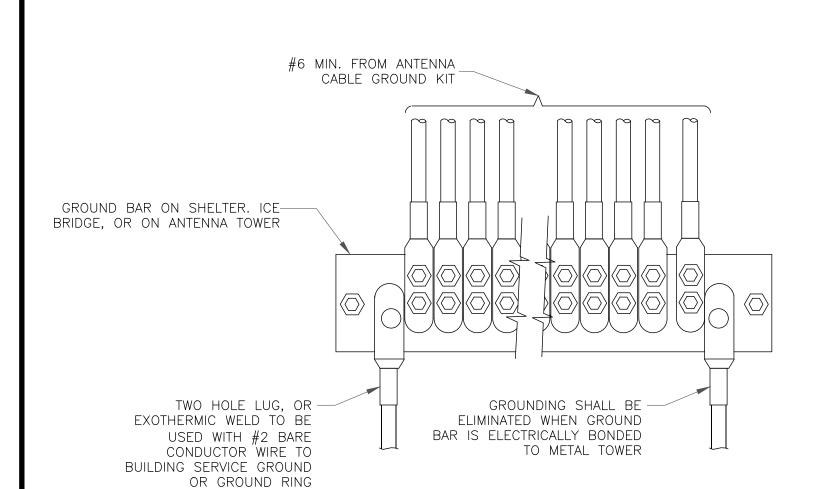
SHEET NUMBER:

G-1




NOTES:


- 1. DOUBLING UP "OR STACKING" OF CONNECTIONS IS NOT PERMITTED.
- 2. EXTERIOR ANTIOXIDANT JOINT COMPOUND TO BE USED ON ALL EXTERIOR CONNECTIONS.
 3. GROUND BAR SHALL NOT BE ISOLATED FROM TOWER. MOUNT DIRECTLY TO ANTENNA MOUNT STEEL.
- 1 ANTENNA SECTOR GROUND BAR DETAIL SCALE: NOT TO SCALE



NGROUNDWIRE INSTALLATION

SCALE: NOT TO SCALE

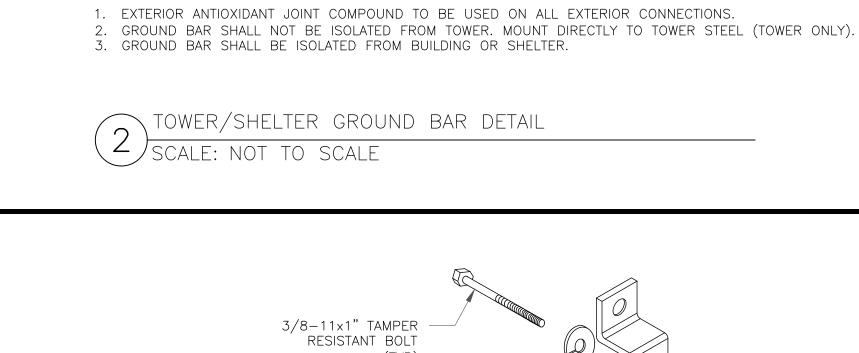

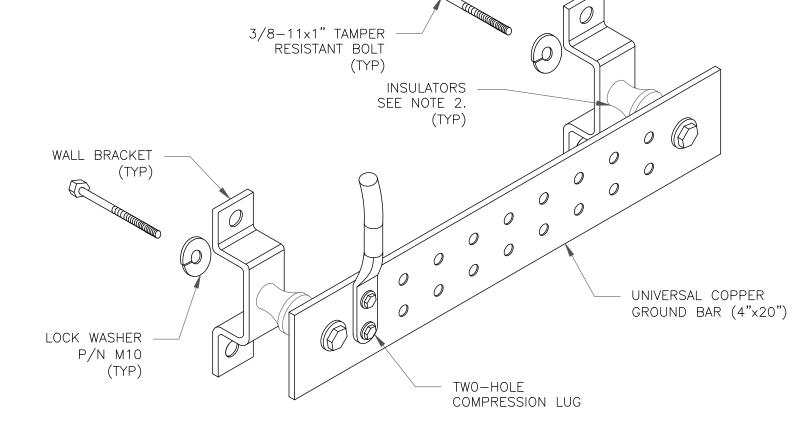

TO ANTENNA COAX

TWO HOLE LONG BARREL COMPRESSION LUG

COPPER/GALVANIZED GROUND BAR

#2 SOLID TINNED COPPER

GROUND RING (2 TYP. FOR


BOTTOM GROUND BAR ONLY)

CONDUCTOR TO TOWER/SHELTER

NOTES:

NOTES:

- 1. DOWN LEAD (HOME RUN) CONDUCTORS ARE <u>NOT</u> TO BE INSTALLED ON CROWN CASTLE USA INC. TOWER, PER THE GROUNDING DOWN CONDUCTOR POLICY QAS—STD—10091. NO MODIFICATION OR DRILLING TO TOWER STEEL IS ALLOWED IN ANY FORM OR FASHION, CAD—WELDING ON THE TOWER AND/OR IN THE AIR ARE NOT PERMITTED.
- 2. OMIT INSULATOR WHEN MOUNTING TO TOWER STEEL OR PLATFORM STEEL USE INSULATORS WHEN ATTACHING TO BUILDING OR SHELTERS.
- 5 GROUND BAR DETAIL SCALE: NOT TO SCALE

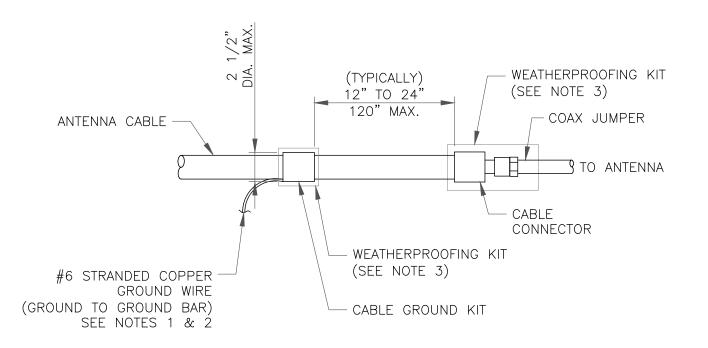


NOTES:


- 1. DO NOT INSTALL CABLE GROUND KIT AT A BEND AND ALWAYS DIRECT GROUND WIRE DOWN TO GROUND BAR.
- 2. GROUNDING KIT SHALL BE TYPE AND PART NUMBER AS SUPPLIED OR RECOMMENDED BY CABLE MANUFACTURER.
- 3. WEATHER PROOFING SHALL BE TWO-PART TAPE KIT, COLD SHRINK SHALL NOT BE USED.


CABLE GROUND KIT CONNECTION

CALE: NOT TO SCALE

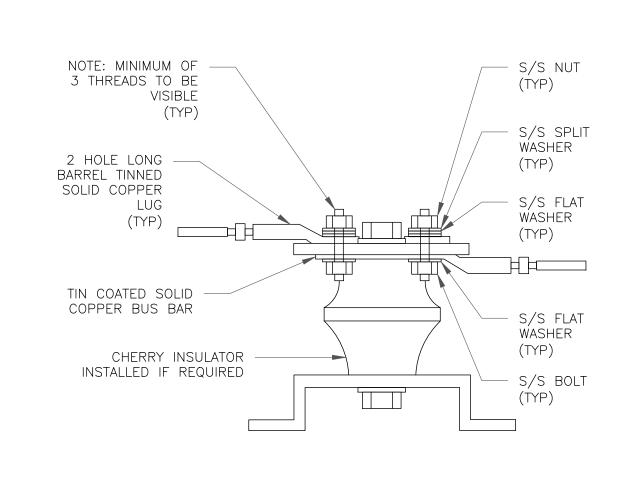


T SCALE: NOT TO SCALE

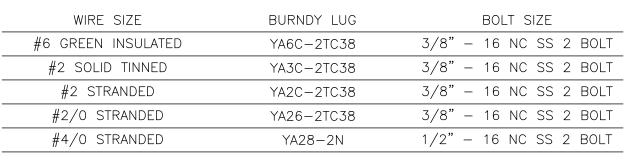


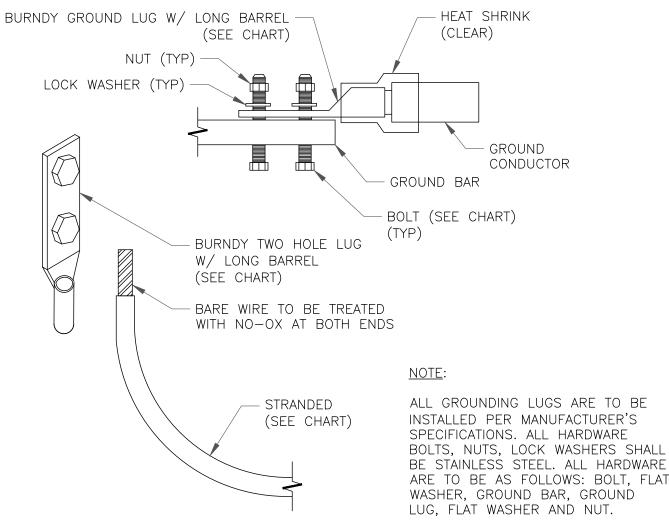


MECHANICAL LUG CONNECTION

SCALE: NOT TO SCALE

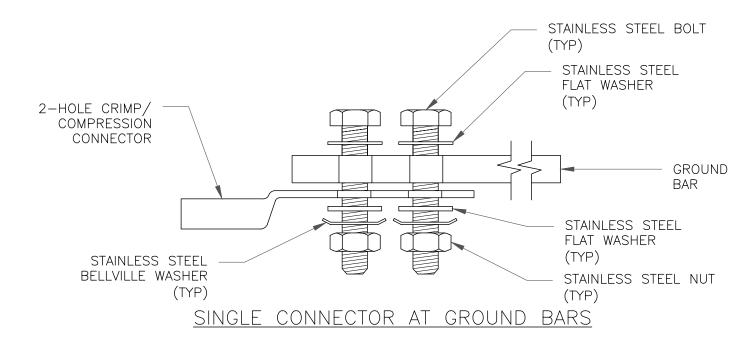

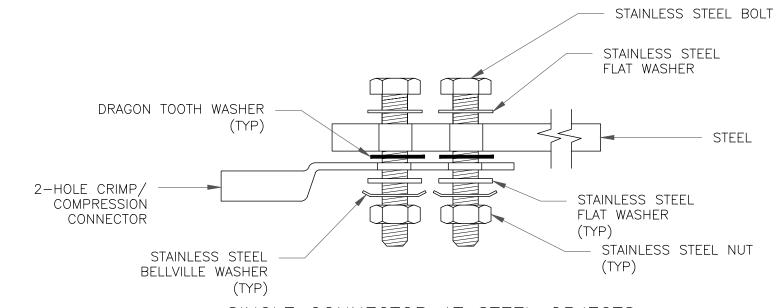

SINGLE CONNECTOR AT STEEL OBJECTS

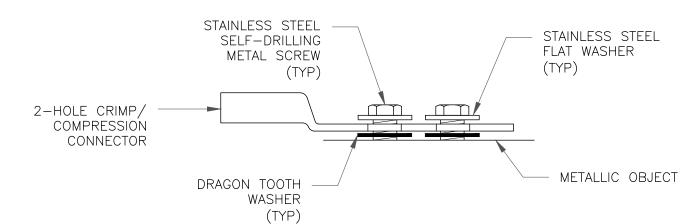

SINGLE CONNECTOR AT METALLIC/STEEL OBJECTS

8 HARDWARE DETAIL FOR EXTERIOR CONNECTIONS SCALE: NOT TO SCALE





TOWER ENGINEERING PROFESSIONALS 326 TRYON RD RALEIGH, NC 27603

(919) 661-6351

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Diagram - Sector A Diagram File Name - CT5838_ABC_d2.vsd

Atoll Site Name - CTL05838 Location Name - EAST HAMPTON CENTRAL Market - CONNECTICUT Market Cluster - NEW ENGLAND

Comments: Important Note: For detailed radio to antenna wiring refer to the latest field notice - Antenna_Radio Connection Drawings Playbook v6.0_Ericsson

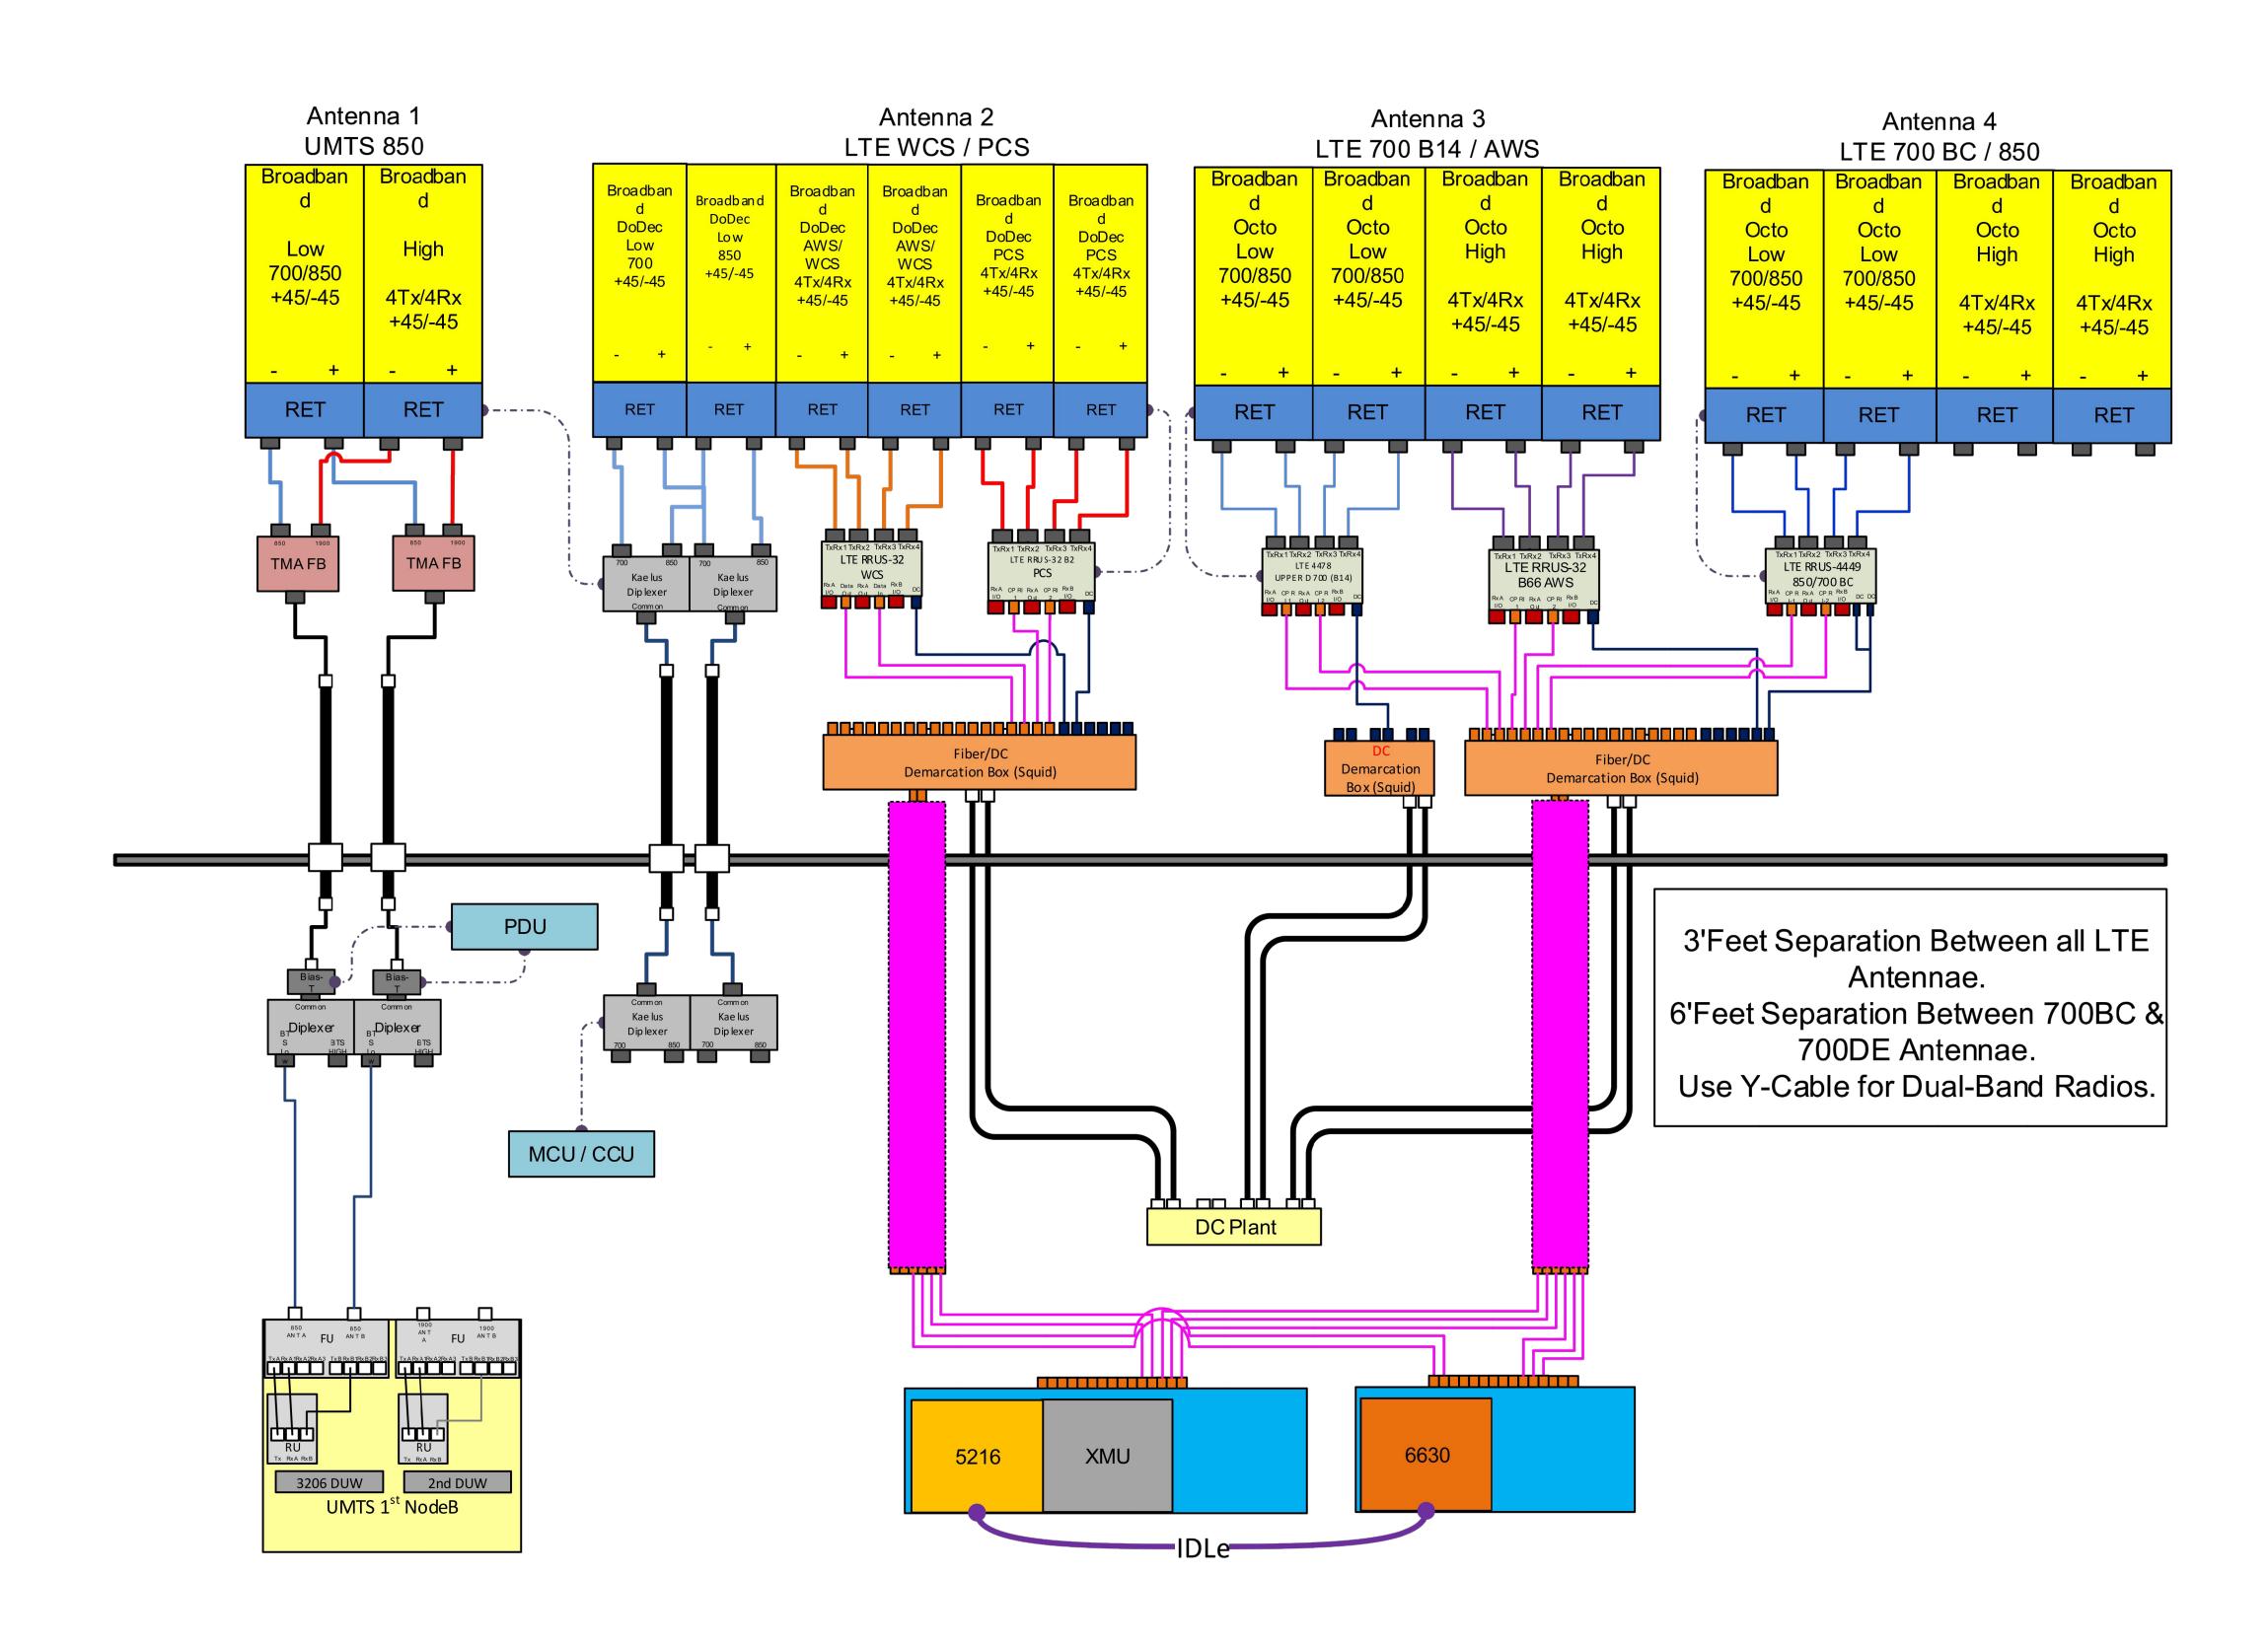


Diagram - Sector B Diagram File Name - CT5838_ABC_d2.vsd

Atoll Site Name - CTL05838 Location Name - EAST HAMPTON CENTRAL Market - CONNECTICUT Market Cluster - NEW ENGLAND

Comments: Important Note: For detailed radio to antenna wiring refer to the latest field notice - Antenna_Radio Connection Drawings Playbook v6.0_Ericsson

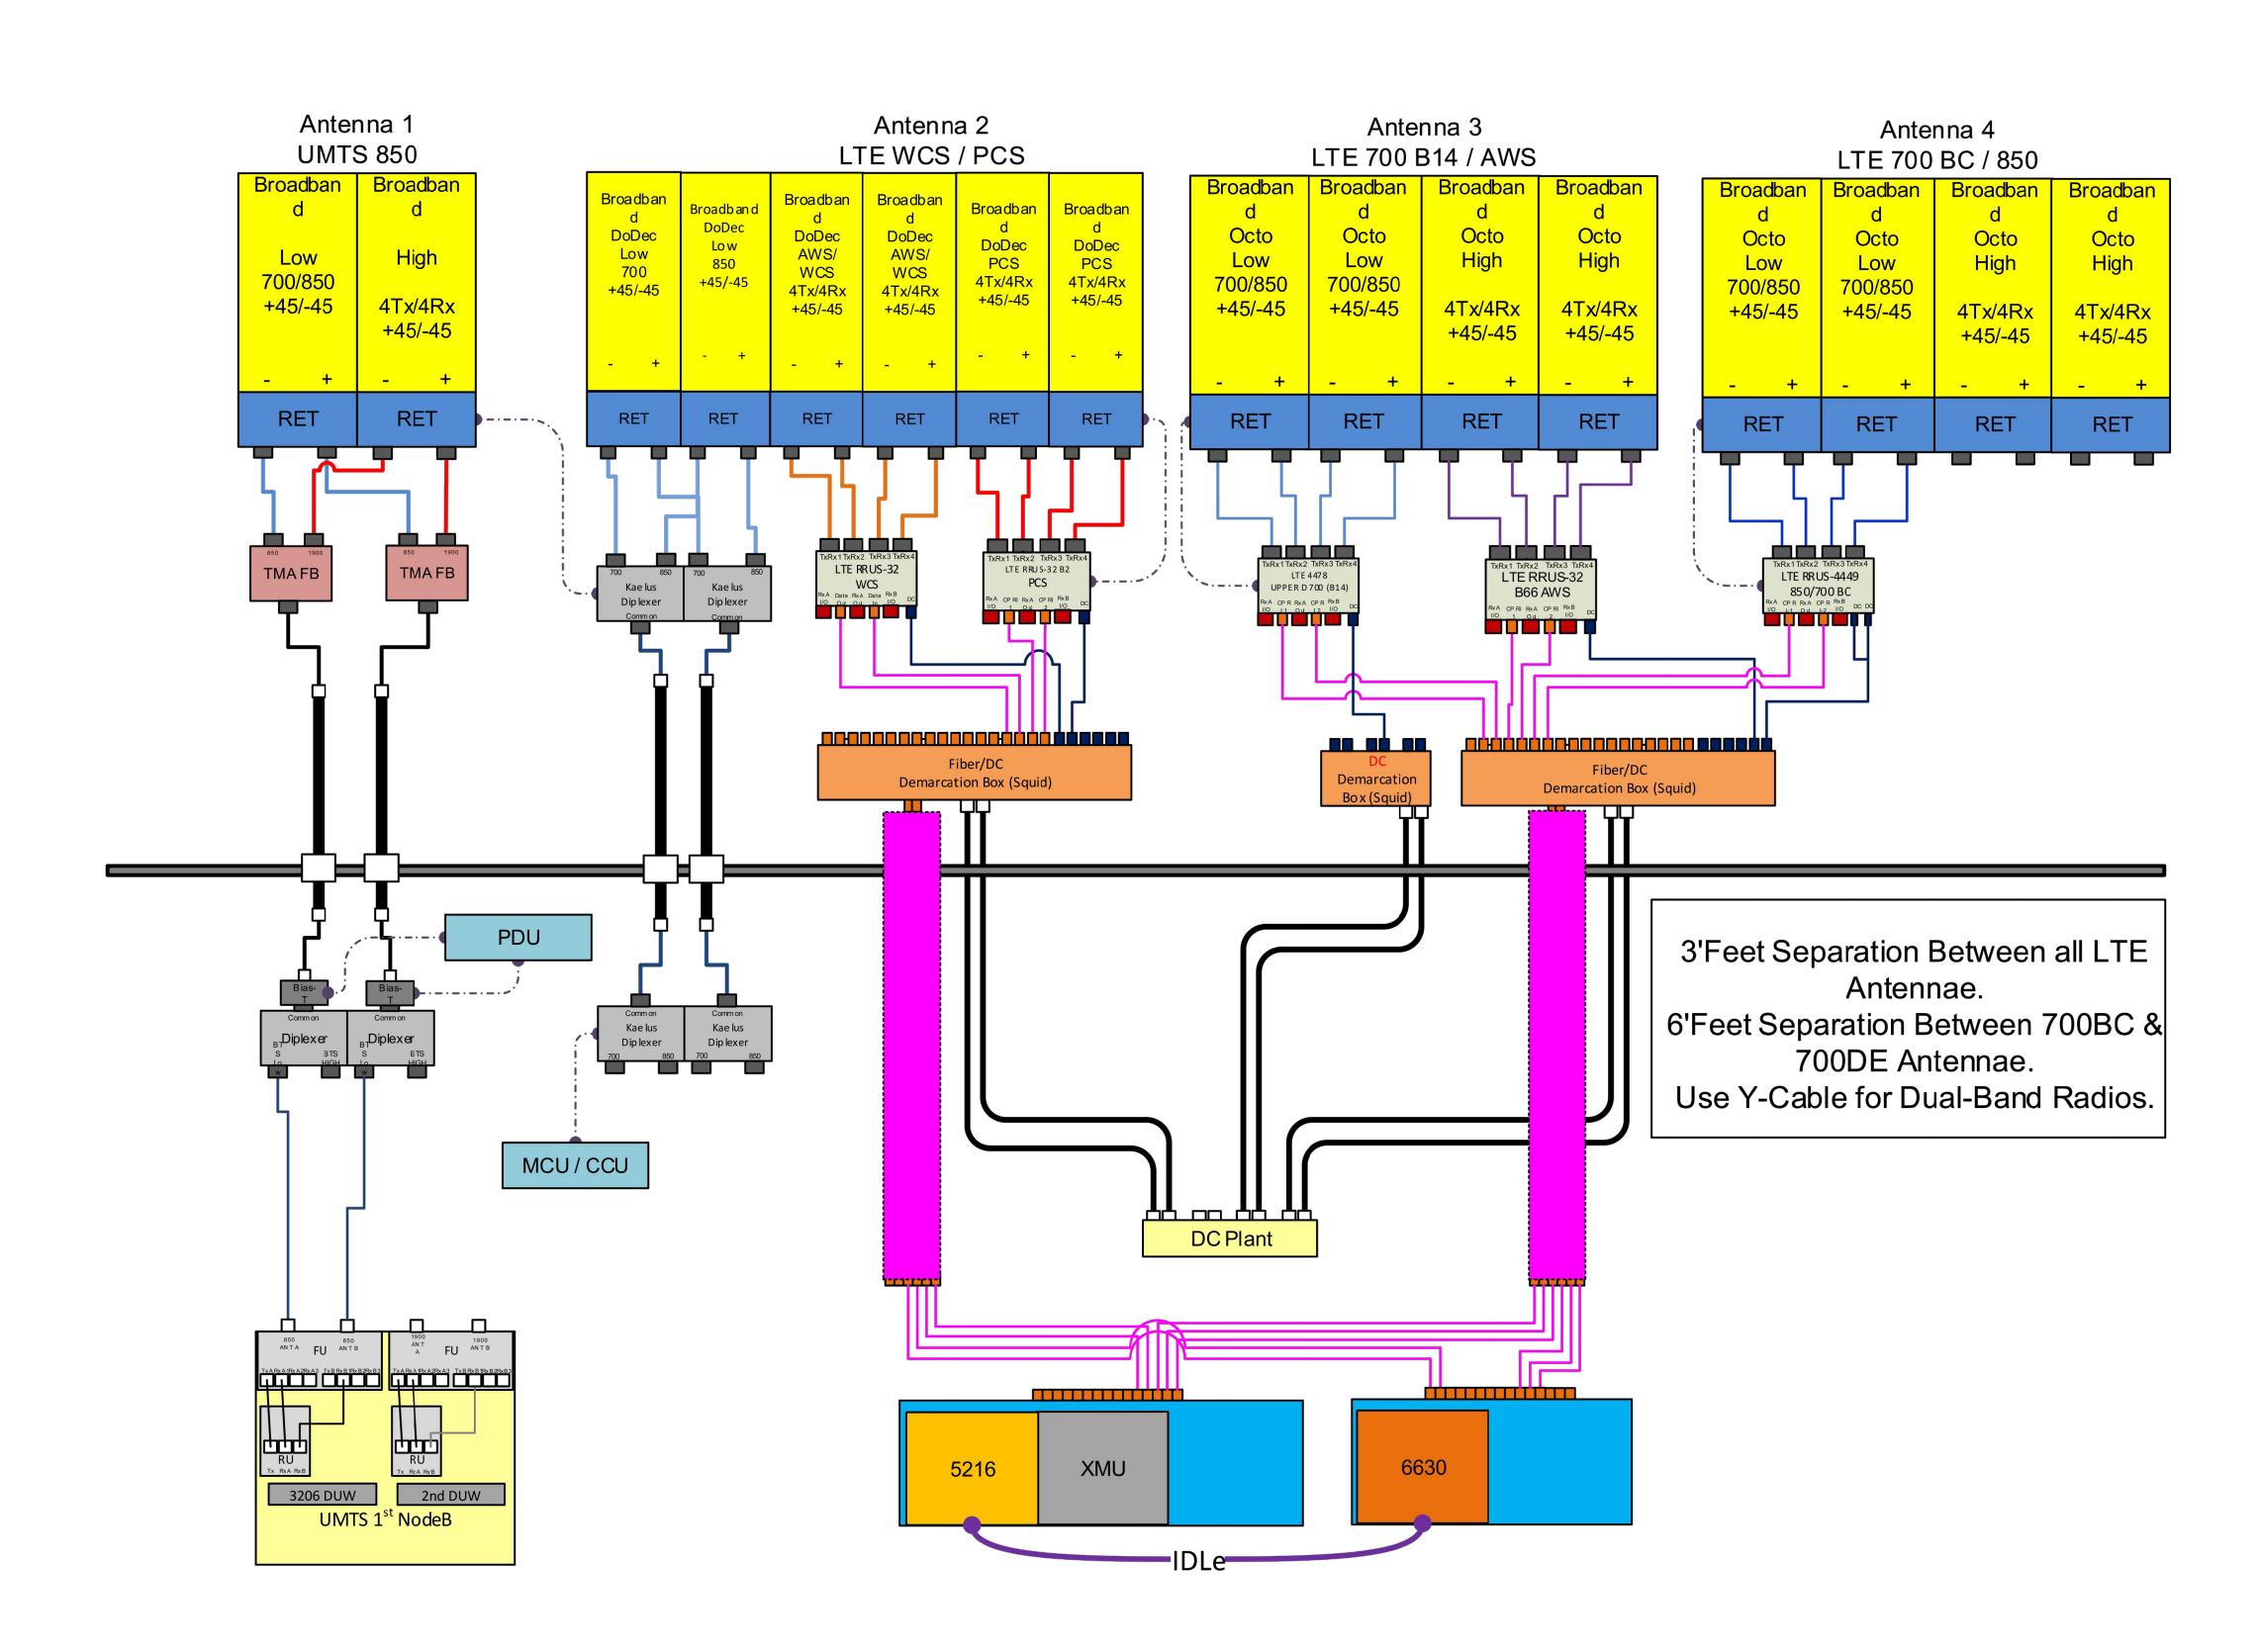


Diagram - Sector C Diagram File Name - CT5838_ABC_d2.vsd

Atoll Site Name - CTL05838 Location Name - EAST HAMPTON CENTRAL Market - CONNECTICUT Market Cluster - NEW ENGLAND

Comments: Important Note: For detailed radio to antenna wiring refer to the latest field notice - Antenna_Radio Connection Drawings Playbook v6.0_Ericsson

