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Lucia Chiocchio lchiocchio@cuddyfeder.com

3/17/20 <u>BY OVERNIGHT FED EX</u> Melanie A. Bachman Executive Director Connecticut Siting Council 10 Franklin Square New Britain, CT 06051

Re: New Cingular Wireless PCS, LLC ("AT&T") Notice of Exempt Modification Emergency Back-up Generator 94 East High Street, East Hampton, CT 06424 Lat.: 41.58727810°; Long.:-72.48868500°

Dear Ms. Bachman:

This letter and enclosures are respectfully submitted on behalf of New Cingular Wireless PCS, LLC ("AT&T"). AT&T currently maintains its wireless telecommunications facility at 94 East High Street in the Town of East Hampton, Connecticut. Pauls & Sandys Too Inc. is the owner of the underlying property and Crown Castle is the owner of the tower. AT&T submits this letter and enclosures to the Connecticut Siting Council ("Council") to notify the Council of AT&T's intent to perform modifications to the existing facility that do not have substantial adverse environmental effects and thus do not require a certificate pursuant to Section 16-50k of the Connecticut General Statutes.

AT&T intends to install one (1) new Generac 20kW Diesel Generator within the existing gradelevel fenced equipment compound as demonstrated on the plans enclosed as Attachment 1. AT&T's existing facility supports its FirstNet program which provides first responders with priority access to AT&T's network to ensure adequate communication capabilities in the event of emergency. AT&T's proposed generator will ensure that critical communication capability for first responders and the public are not lost in the event of a loss of power.

AT&T's proposed generator will also advance the State's goal of natural disaster and emergency preparedness. As discussed in the Council's Docket 432 Findings and Report and Docket 440 proceedings and Findings of Fact (Nos. 76-77), in response to two significant storm events in

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2011, the State formed a Two Storm Panel (the "Panel") that evaluated Connecticut's approach to planning and mitigation of impacts associated with emergencies and natural disasters. The Panel found that "wireless telecommunications service providers were not prepared to serve residential and business customers during a power outage" because certain companies had limited backup generator capacity.¹ The Panel also noted that "[t]he failure of a large portion of Connecticut's telecommunications system during the two storms is a life safety issue." The Panel recommended that State regulatory bodies review "telecommunications services currently in place to verify that the vendors have sufficient generator and backhaul capacity to meet the emergency needs of consumers and businesses" and that the "Connecticut Siting Council should require continuity of service plans for any cellular tower to be erected."² The planned modifications will ensure continuity of services by reinforcing AT&T's back-up power and backhaul capacity to meet the emergency needs of first responders, consumers and businesses in the event of a power outage.

The planned modifications to the facility fall squarely within the activities explicitly provided for in R.C.S.A. § 16-50j-72(b)(2) as the planned modifications:

- Will not result in an increase in the height of the existing structure;
- Will not require the extension of the site boundary;
- Will not increase noise levels at the facility by more than six decibels or more, or to levels that exceed state or local criteria since emergency backup generators are exempt from noise regulations as "noise created as a result of, or relating to, an emergency";³
- Will not increase radio frequency emission at the facility to a level at or above the Federal Communications Commission safety standards;
- Will not cause a change or alteration in the physical or environmental characteristics of the site; and
- Will not impair the structural integrity of the facility.

The original approvals for this facility were not available to AT&T at the time of this application. However, AT&T wishes to refer the Council to its several previous approvals at this facility for emergency back-up generators, including AT&T's exempt modification acknowledgement in EM-AT&T-042-140207 dated February 21, 2014 enclosed as Attachment 2.4 The modification thus complies with prior approvals.

¹ See Council Administrative Notice Item No. 39

² See Council Administrative Notice Item No. 39.

³ R.C.S.A. § 22a-69-1.8.

⁴ Though AT&T never installed this previously proposed generator.



The proposed modifications will have no impact on the existing tower structure itself or the radiofrequency emissions as the proposed modifications only consist of the addition of one new generator within the grade-level fenced equipment compound. Thus, AT&T respectfully requests a waiver from submission of information relating to the existing tower structure or the radiofrequency emissions.

Please accept this letter as notification pursuant to R.C.S.A. § 16-50j-73 for construction that constitutes an exempt modification pursuant to R.C.S.A. § 16-50j-73. In accordance with R.C.S.A. § 16-50j-73, a copy of this letter and enclosure are being sent to the Town Council Chairman Pete Brown as well as the property owner and structure owner identified above. Proof of notification is enclosed as Attachment 3.

For the foregoing reasons, AT&T respectfully submits that the proposed modification to the above referenced wireless telecommunications facility constitutes an exempt modification under R.C.S.A. § 16-50j-72(b)(2).

Very truly yours,

ucie Chrocchio

Lucia Chiocchio

Attachments

cc: Council Chairman Pete Brown, Town of East Hampton Crown Castle, Tower Owner
Pauls & Sandys Too INC, Property Owner
AT&T
General Dynamics Information Technology
Daniel Patrick, Esq. & Julie Durkin, Cuddy & Feder, LLP


ATTACHMENT 1



SITE NAME: EAST HAMPTON EAST FA LOCATION CODE: 10035422 CROWN BUN: 876352

GENERATOR PROJECT 20KW GENERAC DIESEL GENERATOR 200A GENERAC ATS

94 EAST HIGH EAST HAMPTO

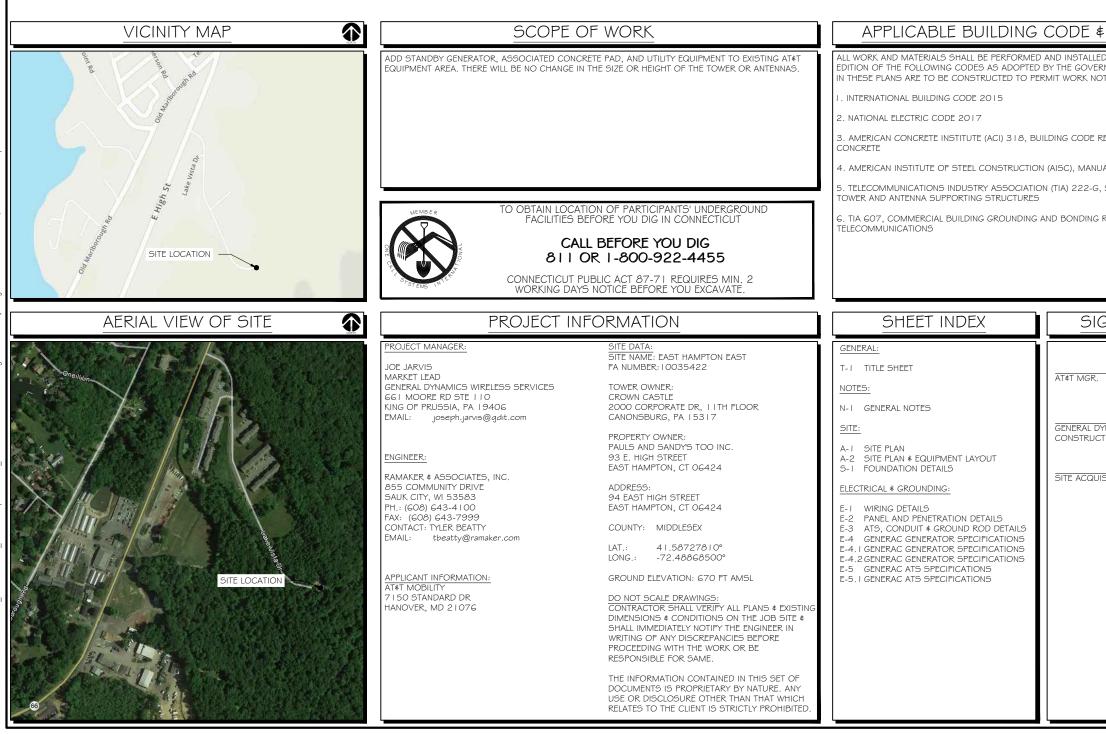

H STREET N, CT 06424	ASSOCIATES, INC. LOO% EMPLOYEE-OWNED S55 Community Dr, Sauk City, WI 53583 608-643-4100 www.Ramaker.com Sauk City, WI Willmar, MN Woodcliff Lake, NJ Bayamon, PR PREPARED FOR: PREPARED FOR: ASSOCIATES, INC. Sauk City, WI S3583 Bayamon, PR PREPARED FOR: ASSOCIATES, INC. Sauk City, WI S3583 Bayamon, PR Bayamon, PR B
STANDARDS	CONSULTANT: GENERAL DYNAMICS Information Technology, Inc. GENERAL DYNAMICS 661 MOORE RD STE 110 KING OF PRUSSIA, PA 19406
EQUIREMENTS FOR STRUCTURAL AL OF STEEL CONSTRUCTION STRUCTURAL STANDARDS FOR STEEL REQUIREMENTS FOR	Certification 4 Seal: I hereby certify that this plan, specification, or report was prepared by me or under my direct supervision and that I am a duly Licensed Professional Engineer under the laws of the State of <u>Connecticut</u> .
GNATURE BLOCK	Jane Returned 3/12/2020 Signature: Date:
DATE NAMICS DATE TON MGR.	I 3/12/20 REVISED CDs MARK DATE DESCRIPTION
DATE DATE	PROJECT TITLE: EAST HAMPTON EAST FA ID # 10035422 PROJECT INFORMATION: 94 EAST HIGH STREET EAST HAMPTON, CT 06424 SHEET TITLE:
	TITLE SHEET

3			
MJR	NOTES TO SUBCONTRACTOR:	ACCESS IS REQUIRED)	 SCHEDULE 80 PVC CONDUIT SHALL BE USED ABOVE GR DEFINED AS THE GROUND OF THE TURN-UP
KED BY: N	I. THE GENERAL SUBCONTRACTOR MUST VERIFY ALL DIMENSIONS, CONDITIONS AND ELEVATIONS BEFORE PROCEEDING WITH THE WORK. ALL WORK SHALL BE PERFORMED IN A WORKMANLIKE MANNER IN ACCORDANCE WITH ACCEPTED CONSTRUCTION PRACTICES.	4. OCCUPANCY IS LIMITED TO PERIODIC MAINTENANCE AND INSPECTION, APPROXIMATELY 2 TIMES PER MONTH BY AT&T TECHNICIANS.	 BELL END OR TERMINAL ADAPTER MUST BE INSTALLED O 352.46. 300.4 F, (3)
CHEC	2. IT IS THE INTENTION OF THESE DRAWINGS TO SHOW THE COMPLETED INSTALLATION. THE SUBCONTRACTOR SHALL BE RESPONSIBLE FOR ALL TEMPORARY BRACING, SHORING, TIES, FORM	 OUTDOOR STORAGE AND SOLID WASTE CONTAINERS ARE NOT PROPOSED. ALL MATERIAL SHALL BE FURNISHED AND WORK SHALL BE PERFORMED IN ACCORDANCE WITH 	 CONDUIT BENDS SHALL BE MADE IN ACCORDANCE WITH ANGLE DEVICE OTHER THAN STANDARD CONDUIT ELBOW
RB RB	WORK, ETC. IN ACCORDANCE WITH ALL NATIONAL, STATE, AND LOCAL ORDINANCES, TO SAFELY EXECUTE ALL WORK AND SHALL BE RESPONSIBLE FOR SAME. ALL WORK SHALL BE IN	THE PROJECT SPECIFICATIONS.	SWEEPS FOR ALL CONDUITS 2" OR LARGER.
4 BY: TF	ACCORDANCE WITH LOCAL CODES.	7. SUBCONTRACTOR SHALL BE RESPONSIBLE FOR REPAIRING ANY DAMAGE CAUSED BY THE CONSTRUCTION OPERATION.	G. POWER WIRING SIZE SHALL NOT BE SMALLER THAN #12
DRAW	3. THE SUBCONTRACTOR SHALL USE ADEQUATE NUMBER OF SKILLED WORKMAN WHO ARE THOROUGHLY TRAINED AND EXPERIENCED IN THE NECESSARY CRAFTS AND WHO ARE COMPLETELY FAMILIAR WITH THE SPECIFIED REQUIREMENTS AND METHOD NEEDED FOR PROPER PERFORMANCE	8. SUBCONTRACTOR SHALL BE RESPONSIBLE FOR OBTAINING ALL PERMITS AND INSPECTION REQUIRED FOR CONSTRUCTION.	 ALL WIRING SHALL BE COPPER. ALUMINUM WILL NOT BE SHALL CONTAIN A GROUND WIRE.
- 6103	OF THE WORK. 4. CONSTRUCTION SUBCONTRACTOR AGREES THAT IN ACCORDANCE WITH GENERALLY ACCEPTED	9. SUBCONTRACTOR SHALL REMOVE ALL TRASH AND DEBRIS FROM THE SITE ON A DAILY BASIS.	 PHASE MARKINGS TO BE USED AT POWER CONDUCTOR CONTRACTOR SHALL ENSURE INTEGRITY IS MAINTAINED IN
yı ıgıır	CONSTRUCTION PRACTICES, CONSTRUCTION SUBCONTRACTOR WILL BE REQUIRED TO ASSUME SOLE AND COMPLETE RESPONSIBILITY FOR JOB SITE CONDITIONS DURING THE COURSE OF	ELECTRICAL NOTES: A. GENERAL	WIRING.
<u>)</u>	CONSTRUCTION OF THE PROJECT, INCLUDING THE SAFETY OF ALL PERSONS AND PROPERTY, THAT THIS REQUIREMENT SHALL BE MADE TO APPLY CONTINUOUSLY AND NOT BE LIMITED TO NORMAL		I O. INSTALL PULL STRING IN ALL CONDUIT.
2	WORKING HOURS AND CONSTRUCTION SUBCONTRACTOR FURTHER AGREES TO INDEMNIFY AND HOLD DESIGN ENGINEER HARMLESS FROM ANY AND ALL LIABILITY, REAL OR ALLEGED, IN CONNECTION WITH PERFORMANCE OF WORK ON THIS PROJECT.	EQUIPMENT SUPPLIER PRIOR TO INSTALLATION. 2. COORDINATE LOCATION AND REQUIREMENTS FOR ELECTRICAL AND TELEPHONE SERVICES	I I. FOR ROOFTOP INSTALLS AND BUILD-OUTS, CONDUITS IN SHALL BE RGS, UNLESS OTHERWISE NOTED. FOR RAW L SCHEDULE 80 SHALL BE UTILIZED UNLESS NOTED OTHER
	CONNECTION WITH PERFORMANCE OF WORK ON THIS PROJECT. 5. SITE GROUNDING SHALL COMPLY WITH AT¢T WIRELESS SERVICES TECHNICAL SPECIFICATIONS FOR FACILITY GROUNDING FOR CELL SITE STANDARDS, LATEST EDITION, AND COMPLY WITH AT¢T	WITH THE PROPERTY REPRESENTATIVE, AT&T AND UTILITY COMPANIES. ROUTING OF CONDUITS MAY BE MODIFIED TO MEET SITE REQUIREMENTS. EXACT CONDUIT ROUTING TO BE DETERMINED IN THE FIELD.	 MAINTAIN MINIMUM 1'-0" VERTICAL AND 1'-0" HORIZONT. MECHANICAL GAS PIPING.
	TOWERS GROUNDING CHECKLIST, LATEST VERSION. WHEN NATIONAL AND LOCAL GROUNDING CODES ARE MORE STRINGENT THEY SHALL GOVERN. GROUNDING SHALL BE COMPLETED BEFORE ERECTION OF TOWER.	3. ALL WIRING AND EQUIPMENT SHOWN ON ELECTRICAL SHEETS SHALL BE FURNISHED AND INSTALLED UNDER ELECTRICAL PORTION OF CONTRACT UNLESS OTHERWISE NOTED	1.3. ALL WIRING ROUTED IN PLENUM TO BE RATED OR IN MET
	6. ALL WORK SHALL COMPLY WITH OSHA AND STATE SAFETY REQUIREMENTS. PROCEDURES FOR THE PROTECTION OF EXCAVATIONS, EXISTING CONSTRUCTION AND UTILITIES SHALL BE	 UNINTERRUPTED ELECTRICAL SERVICE FOR EXISTING EQUIPMENT SHALL BE MAINTAINED DURING THE INSTALLATION OF THE WORK DESCRIBED UNDER THESE DOCUMENTS. 	C. EQUIPMENT I. EQUIPMENT/PARTS CONNECTED TO EXISTING PANELS, DL
	ESTABLISHED PRIOR TO FOUNDATION INSTALLATION, IF TEMPORARY LIGHTING AND MARKING IS REQUIRED BY THE FEDERAL AVIATION ADMINISTRATION (FAA), IT IS THE SUBCONTRACTOR'S	TEMPORARY EQUIPMENT, CABLES AND WHATEVER ELSE IS NECESSARY SHALL BE PROVIDED AS REQUIRED TO MAINTAIN ELECTRICAL SERVICE. TEMPORARY SERVICE FACILITIES, IF	CHARACTERISTICS (A/C, V, A) OF THAT EQUIPMENT.
	RESPONSIBILITY TO MAINTAIN THE NECESSARY LIGHTS AND NOTIFY THE PROPER AUTHORITIES IN THE EVENT OF A PROBLEM.	REQUIRED AT ANY TIME, SHALL NOT BE DISCONNECTED OR REMOVED UNTIL NEW SERVICE EQUIPMENT IS IN PROPER OPERATION. IF ANY SERVICE OR SYSTEM MUST BE INTERRUPTED,	2. ALL ELECTRICAL EQUIPMENT OUTSIDE SHALL BE NEMA OF
	7. ALL WORK SHALL BE ACCOMPLISHED IN ACCORDANCE WITH ALL LOCAL, STATE, AND FEDERAL CODES OR ORDINANCES. THE MOST STRINGENT CODE WILL APPLY IN THE CASE OF	THE CONTRACTOR SHALL REQUEST PERMISSION IN WRITING STATING THE DATE, TIME, ETC. THE SERVICE WILL BE INTERRUPTED AND THE AREAS AFFECTED. THIS REQUEST SHALL BE MADE IN SUFFICIENT TIME FOR PROPER ARRANGEMENTS TO BE MADE. WRITTEN	D. GROUNDING
3:05pm	DISCREPANCIES OR DIFFERENCES IN THE CODE REQUIREMENTS.	PERMISSION SHALL BE OBTAINED FROM THE OWNER BEFORE INTERRUPTING ELECTRICAL SERVICE.	PROVIDE STAINLESS STEEL BOLTS AND LOCK WASHERS CONNECTIONS.
0 - 3	EXPENSE TO THE SATISFACTION OF THE LANDOWNER AND THE ENGINEER.	 COORDINATE NEW WORK WITH OTHER TRADES AND VERIFY EXISTING CONDITIONS TO AVOID INTERFERENCE. IN CASE OF INTERFERENCE, AT&T'S REPRESENTATIVE WILL DECIDE WHICH 	 ALL EQUIPMENT SURFACES TO BE BONDED TO GROUNDI ALL PAINT AND DIRT. CONNECTIONS TO VARIOUS METAL
2, 202	 THE COMPLETE BID PACKAGE INCLUDES THESE CONSTRUCTION DRAWINGS ALONG WITH THE SPECIFICATIONS. SUBCONTRACTOR IS RESPONSIBLE FOR REVIEW OF TOTAL BID PACKAGE PRIOR TO BID SUBMITTAL 	WORK IS TO BE RELOCATED, REGARDLESS OF WHICH WAS FIRST INSTALLED. 6. THE INSTALLATION MUST COMPLY WITH NEC AND ALL FEDERAL, STATE AND LOCAL RULES AND REGULATIONS.	CAUSE A GALVANIC OR CORROSIVE REACTION. AREA SI BONDING. 3. ANY METALLIC ITEM WITHIN 6' OF GROUND CONDUCTORS
Mar I	I.O. SUBCONTRACTOR SHALL VERIFY LOCATION OF ALL EXISTING UTILITIES WITHIN CONSTRUCTION LIMITS PRIOR TO CONSTRUCTION.	7. THE DRAWINGS ARE DIAGRAMMATIC AND INDICATE THE GENERAL ARRANGEMENT OF	GROUNDING SYSTEM.
ro on	I I. THE SUBCONTRACTOR IS RESPONSIBLE FOR MAINTAINING POSITIVE DRAINAGE ON THE SITE	SYSTEMS AND EQUIPMENT UNLESS OTHERWISE DEFINED BY DIMENSIONS OR DETAILS. EXACT EQUIPMENT LOCATIONS AND RACEWAY ROUTING SHALL BE GOVERNED BY ACTUAL	 EXTERIOR, ABOVE GRADE GROUND CONNECTIONS SHALL PROTECTIVE COATING OF ANTI-OXIDE COMPOUND.
rguerre	AT ALL TIMES. SILT AND EROSION CONTROL SHALL BE MAINTAINED ON THE DOWNSTREAM SIDE OF THE SITE AT ALL TIMES. ANY DAMAGE TO ADJACENT PROPERTIES WILL BE CORRECTED AT THE SUBCONTRACTOR'S EXPENSE.	FIELD CONDITIONS AND/OR DIRECTIONS FROM AT&T'S REPRESENTATIVE.	5. ALL MATERIALS AND LABOR REQUIRED FOR THE GROUND PLANS AND DETAILS, AND AS DESCRIBED HEREIN SHALL CONTRACTOR LINE FEE OTHERWASE NOTED
д Ру:	12. CLEARING OF TREES AND VEGETATION ON THE SITE SHOULD BE HELD TO A MINIMUM. ONLY THE TREES NECESSARY FOR CONSTRUCTION OF THE FACILITIES SHALL BE REMOVED. ANY	 ALL MATERIALS SHALL BE FURNISHED AND WORK SHALL BE PERFORMED IN ACCORDANCE WITH THE APPLICABLE SECTIONS OF THE STANDARDS REFERENCED BELOW: 	CONTRACTOR UNLESS OTHERWISE NOTED.
Printed	DAMAGE TO THE PROPERTY OUTSIDE THE LEASED PROPERTY SHALL BE REPAIRED BY THE SUBCONTRACTOR.	 a. ANSI (AMERICAN NATIONAL STANDARDS INSTITUTE) b. ASTIM (AMERICAN SOCIETY FOR TESTING MATERIALS) c. ETL (ELECTRICAL TESTING LABORATORY) 	ADJUST LOCATIONS INDICATED ON PLANS ACCORDING T TO KEEP THE GROUND CONNECTION CABLES AS SHORT
gwb.	13. ALL SUITABLE BORROW MATERIAL FOR BACK FILL OF THE SITE SHALL BE INCLUDED IN THE BID. EXCESS TOPSOIL AND UNSUITABLE MATERIAL SHALL BE DISPOSED OF OFF SITE AT LOCATIONS	 d. ICEA (INSULATED CABLE ENGINEERS ASSOCIATION) e. IEEE (INSTITUTE OF ELECTRICAL AND ELECTRONIC ENGINEERS) 	 PROVIDE ALL ELECTRICAL SYSTEM AND EQUIPMENT GROU CURRENT EDITION OF THE NATIONAL ELECTRIC CODE (19
r CDs.	APPROVED BY GOVERNING AGENCIES PRIOR TO DISPOSAL.	 MBFU (NATIONAL BOARD OF FIRE UNDERWRITERS) MESC (NATIONAL ELECTRICAL SAFETY CODE) NEMA (NATIONAL ELECTRICAL MANUFACTURER'S ASSOCIATION) 	THE NATIONAL ELECTRICAL SAFETY CODE. BONDING JUN FITTINGS SHALL BE INSTALLED AT ALL RACEWAYS, EQUIPI ETC. TO MAINTAIN GROUND CONTINUITY WHERE REQUIRE
or ATT	COMPLETION OF THE SITE DEVELOPMENT. THE SUBCONTRACTOR IS RESPONSIBLE FOR PROVIDING AND MAINTAIN AN ADEQUATE COVER OF VEGETATION OVER THE SITE FOR A ONE YEAR	NFPA (NATIONAL FIRE PROTECTION ASSOCIATION) UL (UNDERWRITER'S LABORATORY)	8. ALL EQUIPMENT GROUND CONDUCTORS SHALL BE TIN C
enerat	PERIOD.	I O. CONTRACTOR SHALL REVIEW PLANS, DETAILS AND SPECIFICATIONS IN DETAIL AND ADJUST	NOTED OTHERWISE ON THE DRAWINGS.
st_Ge	15. PERMITS: THE SUBCONTRACTOR SHALL BE RESPONSIBLE FOR OBTAINING AND INCURRING THE COST OF ALL REQUIRED PERMITS, INSPECTIONS, CERTIFICATES, ETC.	WORK TO CONFORM WITH ACTUAL SITE CONDITIONS SO THAT ELECTRICAL DEVICES AND EQUIPMENT WILL BE LOCATED AND READILY ACCESSIBLE. QUANTITIES LISTED IN MATERIAL LISTS ON THE DRAWINGS ARE FOR INFORMATION ONLY. THE CONTRACTOR SHALL PROVIDE	PROVIDE PRE AND POST GROUND TEST RESULTS, USING SHALL BE PHOTOS WITH DIGITAL TIME AND GPS STAMPE
con Ea	I G. RECORD DRAWINGS: MAINTAIN A RECORD OF ALL CHANGES, SUBSTITUTIONS BETWEEN WORK AS SPECIFIED AND INSTALLED. RECORD CHANGES ON A CLEAN SET OF CONTRACT	HIS OWN TAKEOFF FOR MATERIAL QUANTITY AND TYPES BASED ON ACTUAL SITE CONDITIONS, IN ADDITION, CONTRACTOR SHALL PROVIDE ALL NECESSARY MATERIALS TO	E. INSPECTION/DOCUMENTATION
st Hampi	DRAWINGS WHICH SHALL BE TURNED OVER TO THE CONSTRUCTION MANAGER UPON COMPLETION OF THE PROJECT.	INSTALL EQUIPMENT FURNISHED BY AT¢T OR ITS SUPPLIERS. ALL ITEMS NOT SPECIFICALLY MENTIONED HEREIN OR SHOWN ON THE DRAWINGS, BUT WHICH ARE OBVIOUSLY NECESSARY TO MAKE A COMPLETE WORKING INSTALLATION, SHALL BE INCLUDED.	 THE CONTRACTOR, UPON COMPLETION OF HIS WORK, S INFORMATION SHOULD BE GIVEN TO THE GENERAL CONT AS-BUILT SURVEY DOCUMENTS TO BE GIVEN TO THE OW
2_East	17. THE PLANS SHOW SOME KNOWN SUBSURFACE STRUCTURES, ABOVE GROUND STRUCTURES AND/OR EXISTING UTILITIES BELIEVED TO BE IN THE WORKING AREA. IT IS THE RESPONSIBILITY OF THE SUBCONTRACTOR TO VERIFY ALL UTILITIES, PIPELINES AND OTHER STRUCTURES SHOWN OR	II. THE CONTRACTOR OR BIDDER SHALL BEAR THE RESPONSIBILITY OF NOTIFYING (IN WRITING) AT&T'S REPRESENTATIVE OF ANY CONFLICTS PRIOR TO THE SUBMISSION OF CONTRACTOR'S	 CONTRACTOR SHALL SUPPLY DOCUMENTATION ATTESTIN SYSTEM'S RECEPTIVITY (MAX, 5 OHMS).
0035422	NOT SHOWN ON THESE PLANS. THE SUBCONTRACTOR SHALL CONTACT THE LOCAL JURISDICTION'S DIGGER'S HOTLINE BEFORE DIGGING OR DRILLING. ANY DAMAGE TO EXISTING UTILITIES SHALL BE REPAIRED TO THE SATISFACTION OF THE OWNER AND ENGINEER AT THE	PROPOSAL OR PERFORMANCE OF WORK, UN THE EVENT OF DISCREPANCIES THE CONTRACTOR SHALL PRICE THE MORE COSTLY OR EXTENSIVE WORK, UNLESS DIRECTED IN WRITING OTHERWISE.	 AN ELECTRICAL INSPECTION SHALL BE MADE BY AND INS AT\$TS REPRESENTATIVE. CONTRACTOR SHALL COORDIN
D\45804_I	SUBCONTRACTOR'S EXPENSE.	12. ALL FLOORS WHERE PENETRATIONS ARE REQUIRED IN BUILDING ARE TO BE CORE DRILLED AND THEN FIREPROOFED.	POWER COMPANY APPROVAL. 4. CONTRACTOR SHALL HAVE ATS AND GENERATOR RELAY I
AD\45	I. THIS PROPOSAL IS FOR THE ADDITION OF A NEW GENERATOR ON A CONCRETE PAD TO AN EXISTING UNMANNED TELECOMMUNICATIONS FACILITY CONSISTING OF AN EQUIPMENT SHELTER	B, WIRING/CONDUIT	INSPECTED BY OTHERS TO ENSURE THAT UL LISTING FOR
304\C.	AND TOWER.	 PROVIDE PULL BOXES AND JUNCTION BOXES WHERE SHOWN OR AS REQUIRED BY CODE SUCH THAT NO MORE THAN THE EQUIVALENT OF FOUR QUARTER BENDS (380 DEGREES) 	
00\458	2. THE PROPOSED FACILITY WILL BE UNMANNED AND DOES NOT REQUIRE POTABLE WATER OR SERVICE.	TOTAL) EXIST IN A CONDUIT RUN.	
1:\4580(3. THE PROPOSED FACILITY IS UNMANNED AND IS NOT FOR HUMAN HABITAT. (NO HANDICAP	 ALL POWER AND CONTROL/INDICATION WIRING SHALL BE TYPE THHN/THWN 800V RATED 75 DEGREES CELSIUS, UNLESS NOTED OTHERWISE. 	

o O E GROUND, WHERE ABOVE GRADE IS

ED ON END OF PVC CONDUIT PER NEC

WITH NEC TABLE 346-10. NO RIGHT LBOWS WITH 12" MINIMUM INSIDE

#12 AWG.

T BE ACCEPTABLE ALL POWER CIRCUITS

TOR TERMINATIONS.

NED WHEN INSTALLING CONDUIT AND

ITS INSIDE BUILDING AND ON ROOF RAW LAND SITES AND CO-LOCATES, PVC DTHERWISE.

ZONTAL SEPARATIONS FROM ANY

I METALLIC FLEX (LIQUIDITE) CONDUIT.

S, DUCTS, ETC. SHALL MATCH THE

MA OR 3R RATED.

E MADE USING TWO-HOLE CONNECTORS. IERS ON ALL MECHANICAL GROUND

DUNDING SYSTEM SHALL BE STRIPPED OF METALS SHALL BE OF A TYPE AS TO ÆA SHALL BE REPAINTED FOLLOWING

CTORS MUST BE CONNECTED TO THE

SHALL BE FURNISHED WITH A LIBERAL

OUNDING SYSTEM AS INDICATED ON THE HALL BE FURNISHED BY THIS

5 SHALL BE DETERMINED IN FIELD. NING TO ACTUAL EQUIPMENT LOCATIONS 10RT AS PRACTICAL.

GROUNDS AS REQUIRED BY THE (I) (1999) AND THE CURRENT EDITION OF G JUMPERS WITH APPROVED GROUND QUIPMENT ENCLOSURES, PULL BOXES, QUIRED BY CODE.

TIN COATED, #2 AWG COPPER UNLESS

SING CLAMP-ON TESTER. TEST RESULTS AMPED/EMBEDDED.

RK, SHALL PROVIDE AS-BUILT DRAWINGS. CONTRACTOR FOR INCLUSION IN FINAL E OWNER.

ESTING TO THE COMPLETE GROUND


D INSPECTING AGENCY APPROVED BY ORDINATE ALL INSPECTIONS AND OBTAIN

ELAY INSTALLATION AND CONNECTIONS G FOR THAT EQUIPMENT IS NOT VOIDED.

> PROJECT NUMBER


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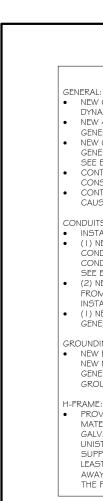


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- EXISTING ± I 20'-0" TALL MONOPOLE
- EXISTING ICE BRIDGE
- PROPOSED AT&T UNDERGROUND GENERATOR CONDUIT ROUTE. SEE DETAIL 2/S- I
- EXISTING AT&T ANTENNA CABLE(S) ICE BRIDGE
- EXISTING AT&T EQUIPMENT PROPOSED AT&T AUTOMATIC TRANSFER SWITCH ON PROPOSED EXTENSION TO EXISTING H-FRAME W/ 3' CLEARANCE IN FRONT. SEE SHEET E-3 FOR DETAILS.
- EXISTING AT&T PURCELL CABINET
- EXISTING AT&T CIRCUIT BREAKER PANEL ∉ CAMLOCK

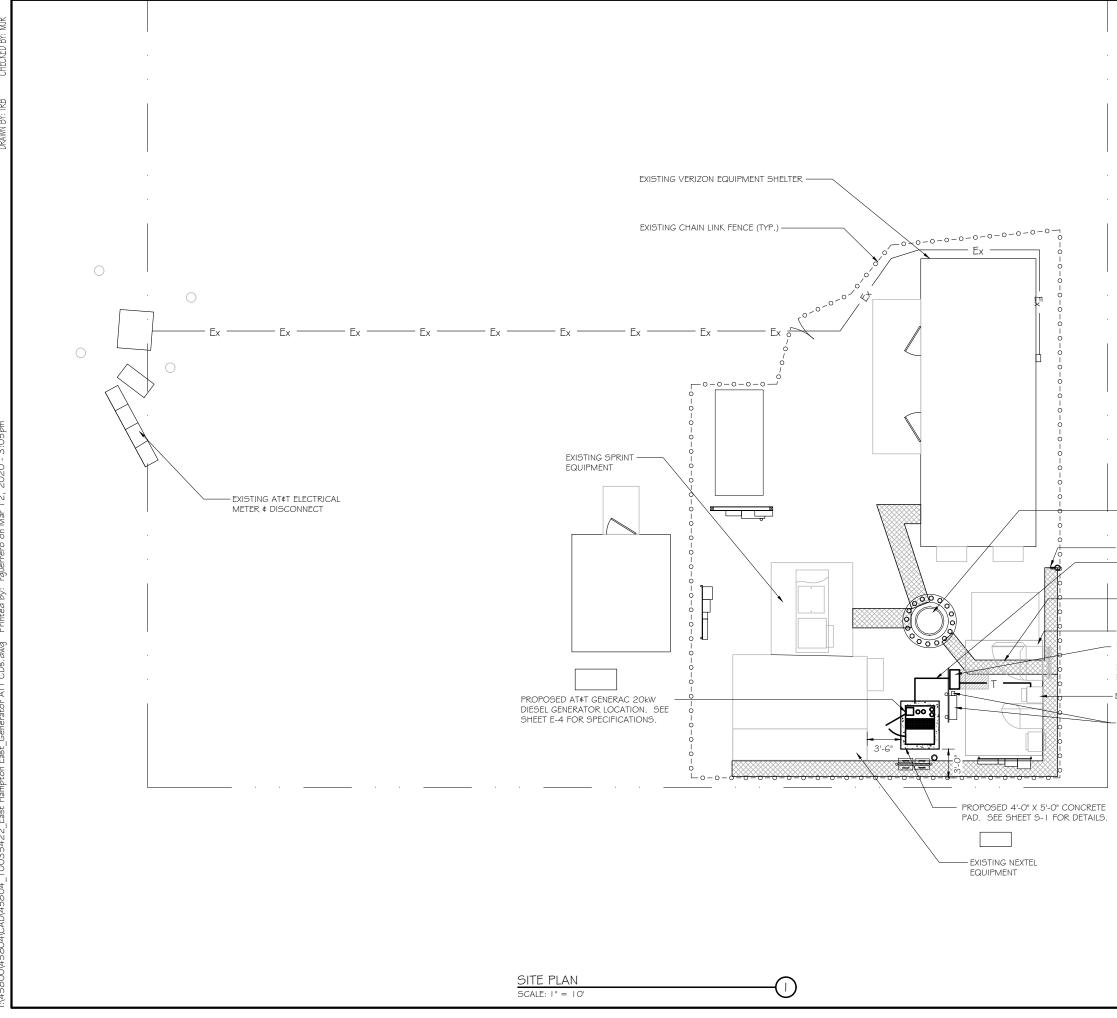


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- NEW GENERAC DIESEL GENERATOR PROVIDED BY GENERAL DYNAMICS ≰ INSTALLED BY GENERAL CONTRACTOR, SEE E-4.
- NEW 4'-0" X 5'-0" CONCRETE PAD PROVIDED ≰ INSTALLED BY GENERAL CONTRACTOR (AS REQUIRED) SEE S-1 NEW GENERAC AUTOMATIC TRANSFER SWITCH PROVIDED BY
- GENERAL DYNAMICS & INSTALLED BY CONTRACTOR (AS REQUIRED) SEE E-3 ∉ E-5.
- CONTRACTOR TO VERIFY ALL EXISTING UTILITIES PRIOR TO CONSTRUCTION
- CONTRACTOR SHALL RESTORE & REPAIR ANY DAMAGED AREAS CAUSED BY CONSTRUCTION TO ORIGINAL OR BETTER CONDITION

CONDUITS:

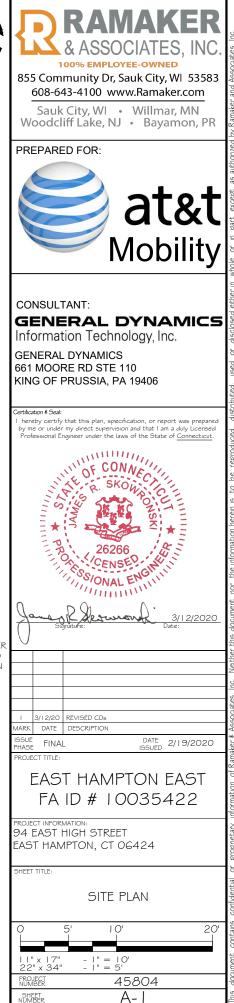
- INSTALL PULL STRING IN EACH CONDUIT
- (1) NEW 2" AND (1) NEW 1" ELECTRICAL CONDUITS WITH CONDUCTORS TO RUN FROM NEW GENERATOR TO NEW ATS. CONDUIT PROVIDED AND INSTALLED BY GENERAL CONTRACTOR. SEE E-1. E-2 ∉ E-3.
- (2) NEW I " ELECTRICAL CONDUIT WITH CONDUCTORS TO RUN FROM NEW GENERATOR TO AC PANEL. CONDUIT PROVIDED \ddagger INSTALLED BY GENERAL CONTRACTOR. SEE E-1, E-2 \ddagger E-3. (I) NEW I" ALARM CONDUIT & CABLING PROVIDED & INSTALLED BY
- GENERAL CONTRACTOR. SEE E-1, E-2 ∉ E-3.


GROUNDING:


NEW EXOTHERMIC CONNECTION FROM EXISTING GROUND RING TO NEW MECHANICAL CONNECTION AT GENERATOR CHASSIS. GENERAL CONTRACTOR TO VERIFY LOCATION IN FIELD. LOCATE GROUND RODS NO MORE THAN 8'-O" APART.

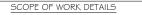H-FRAME:


 PROVIDE NEW H-FRAME IF REQUIRED, MATCH EXISTING H-FRAME MATERIAL FOR CONSTRUCTION OF NEW H-FRAME. USE ALL GALVANIZED COMPONENTS, WHITE PLASTIC END CAPS ON UNISTRUTS, WEATHER CAPS ON TOPS OF PIPE AND CONCRETE SUPPORTS BELOW FROST LINE. TOP OF FOOTING SHOULD BE AT LEAST 2" ABOVE EXISTING GROUND LEVEL. SLOPE THE GROUND AWAY FROM THE H-FRAME FOR POSITIVE WATER DRAINAGE OFF THE FORM

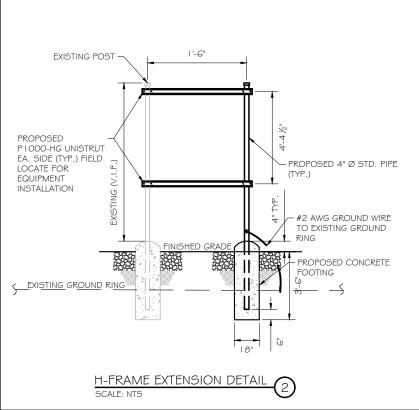


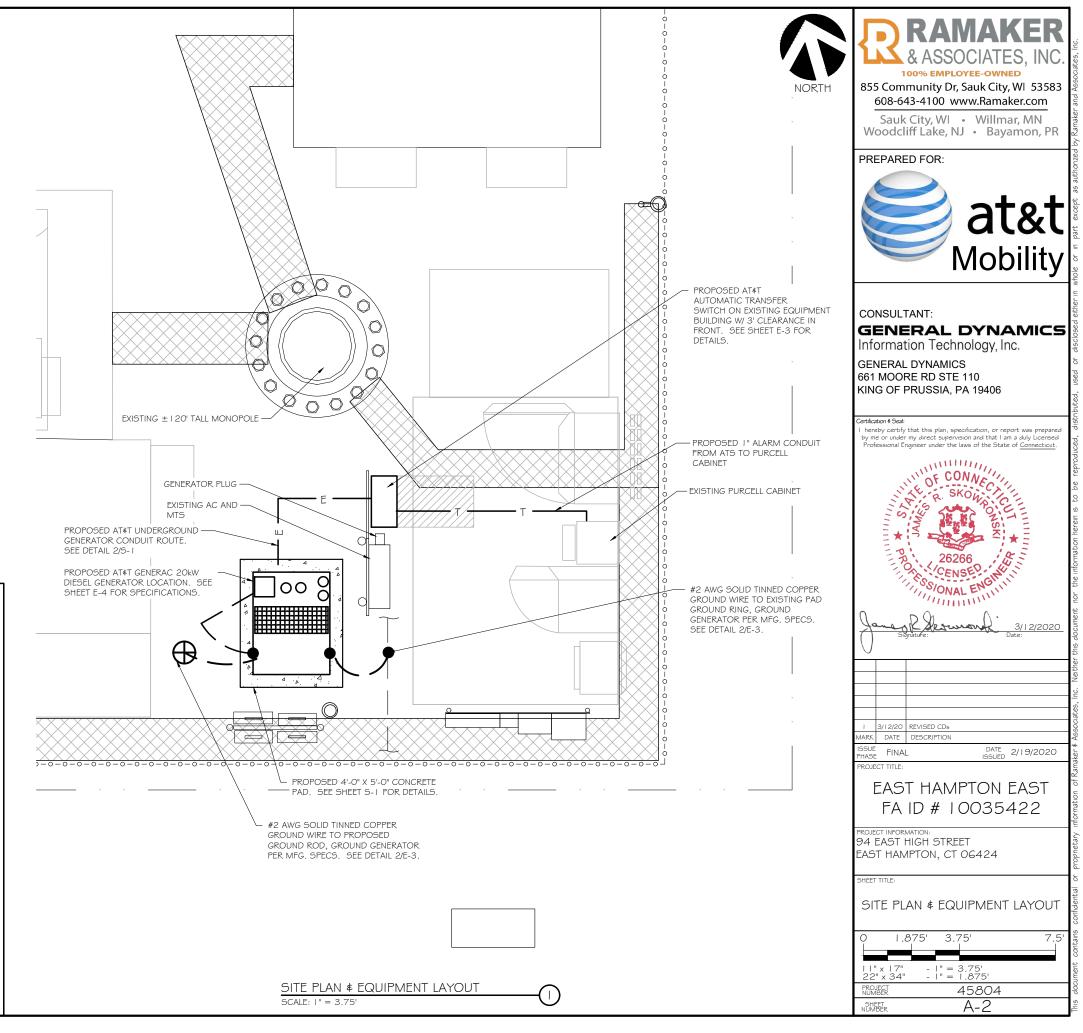


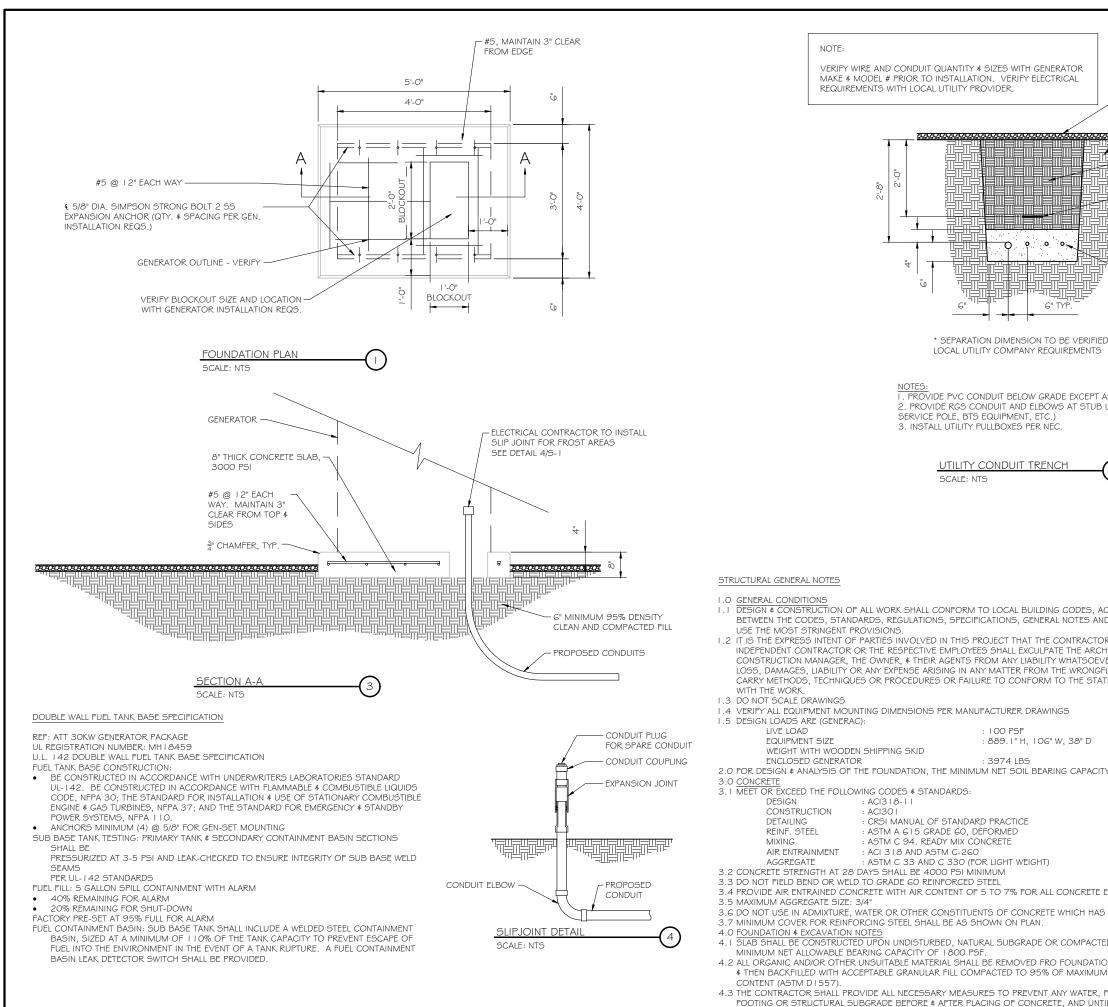

-RESTORE SURFACE TO MATCH ORIGINAL CONDITION - UNDISTURBED SOIL - UNDISTURBED SOIL - UNDISTURBED SOIL	C. 83
COMPACTED BACKFILL (SUITABLE ON SITE MATERIAL) G" WARNING TAPE	
ELECTRICAL CONDUIT(5) WHERE APPLICABLE * CONSULTANT:	y
D WITH AS NOTED BELOW. UP LOCATIONS (I.E. GENERAL DYNAMICS 661 MOORE RD STE 110 KING OF PRUSSIA, PA 19406	s
2	sed
CI 3 1 8-1 1. IN CASE OF CONFLICT D/OR MANUFACTURER'S REQUIREMENTS, R OR SUBCONTRACTOR OR HITECT, THE ENGINEER, TECH. /ER & HOLD THEM HARMLESS AGAINST UL OR NEGLIGENT ACT, OR FAILURE TO TE SCAFFOLDING ACT IN CONNECTIONS	20_
Y SHALL BE ASSUMED TO BE 2000 PSF. PROJECT TITLE: PROJECT TITLE: FINAL DATE DESCRIPTION DATE 2/19/202 PROJECT TITLE: EAST HAMPTON EAST FA ID # 10035422	
EXPOSED TO EARTH OR WEATHER.	
ED GRANULAR FILL WITH AN ASSUMED DN & SLAB SUBGRADE & BACKFILL AREAS, A DENSITY AT OPTIMUM MOISTURE	
FROST, OR ICE FROM PENETRATING ANY INSPECT 45804	

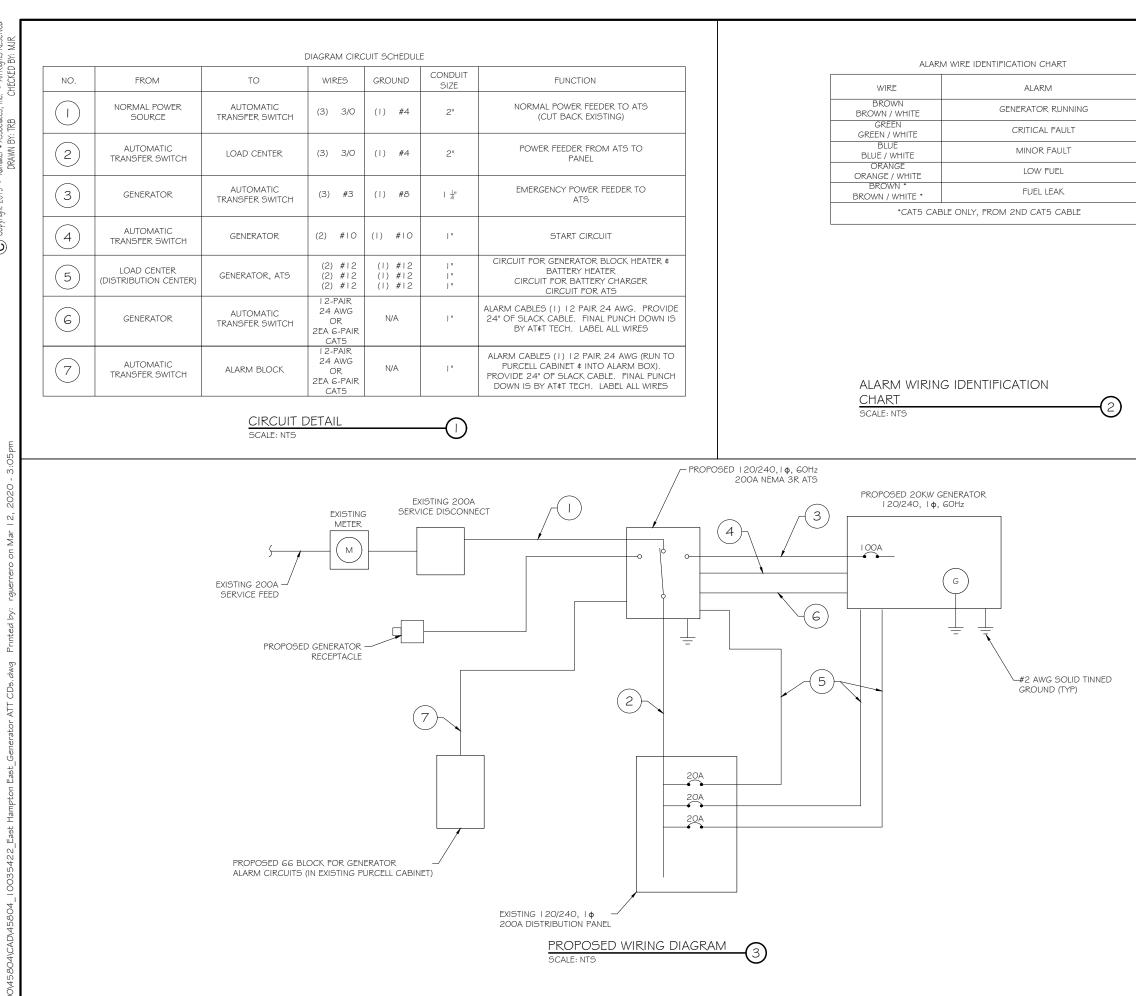

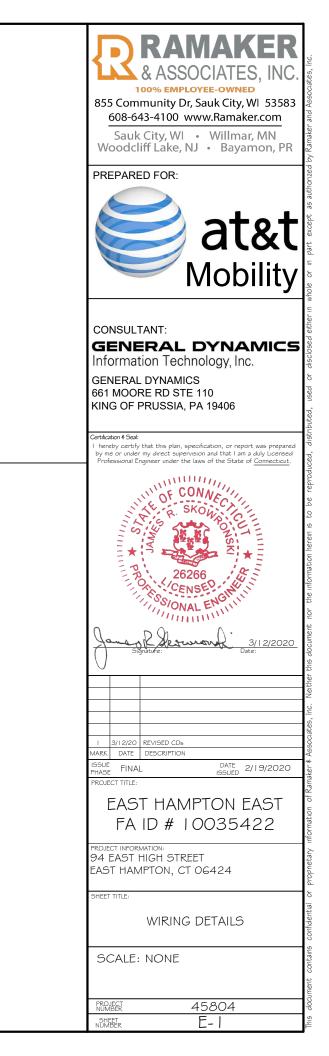

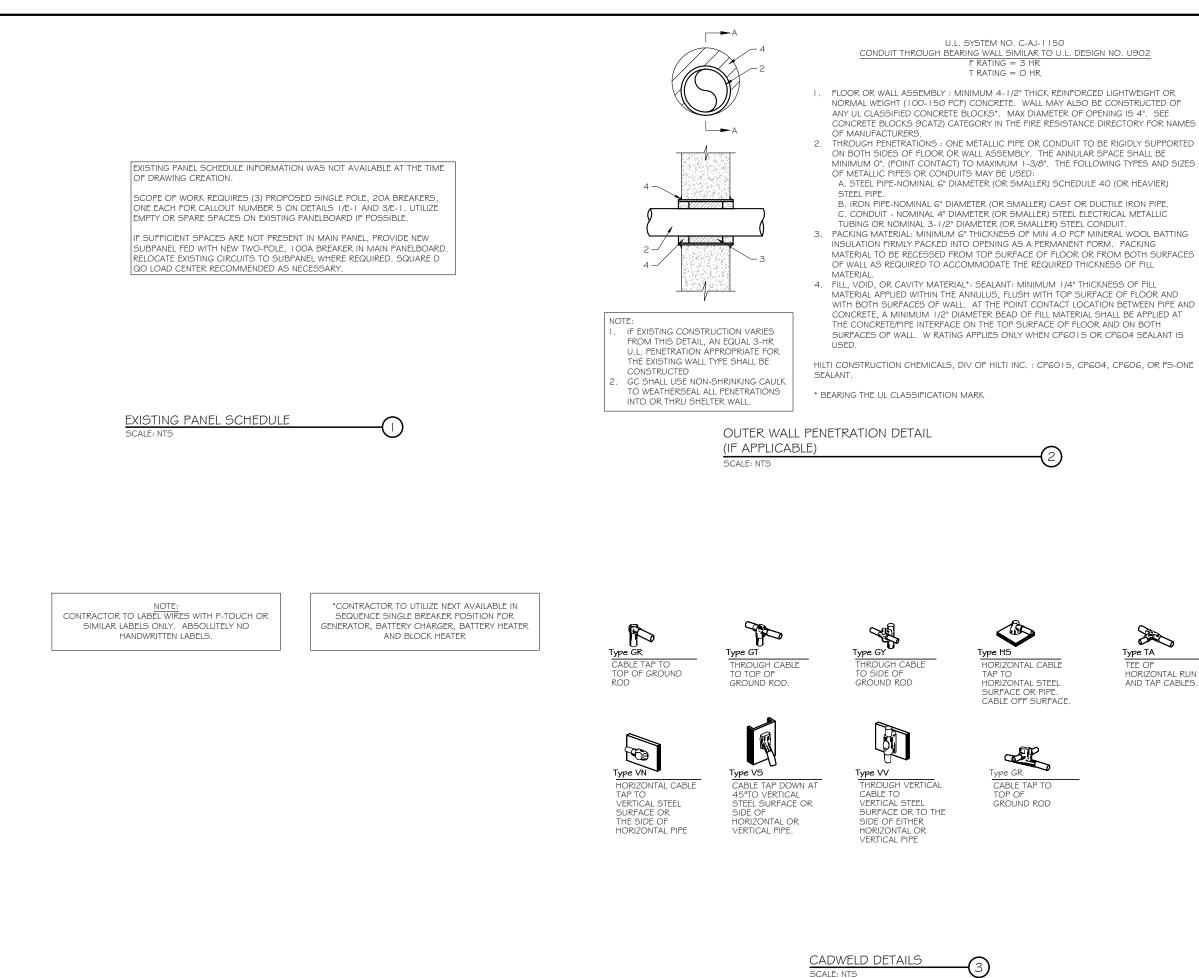



HORIZONTAL RUN AND TAP CABLES





CONDUIT (TYP)

(2)

(3)

(4)


BUTTERFLY CLAMP AS REQUIRED


) EXISTING WALL/CEILING

VERTICAL "UNISTRUT" PI 000 T SERIES LENGTH BASED ON NUMBER OF CONDUIT TO BE MOUNTED

WALL CONSTRUCTION TYPE	USE
HOLLOW	3/8" DIA. TOGGLE BOLT
HOLLOW, AT STUD	3/8" DIA. LAG SCREW
CONCRETE BLOCK (HOLLOW)	3/8" DIA. HILTI HY-20 WITH SCREEN, MINIMUM EMBEDMENT 2-1/2"
CONCRETE (SOLID)	3/8" DIA. HILTI HY-150 WITH SCREEN, MINIMUM EMBEDMENT 2-1/2"

NOTE: USE GALVANIZED OR STAINLESS STEEL HARDWARE FOR WALL MOUNT & CONNECTIONS OF CHANNELS SPACE UNITS @ 5'-0" O.C. LENGTH OF RUN

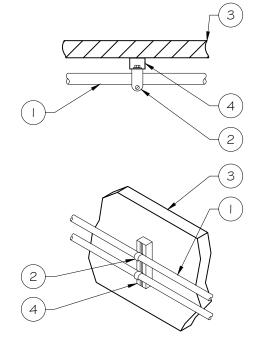

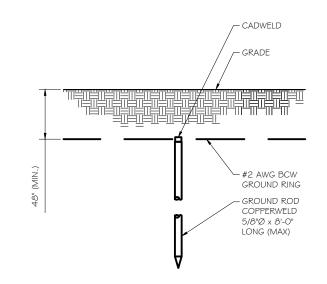


GROUND ROD DETAIL SCALE: NTS



WALL CONSTRUCTION TYPE	USE
HOLLOW	3/8" DIA. TOGGLE BOLT
HOLLOW, AT STUD	3/8" DIA. LAG SCREW
CONCRETE BLOCK (HOLLOW)	7/16" DIA. HILTI HY-20 WITH SCREEN MINIMUM EMBEDMENT 2-1/2"
CONCRETE (SOLID)	7/16" DIA. HILTI HY-150 WITH SCREEN MINIMUM EMBEDMENT 2-1/2"


NOTE:

- I. USE GALVANIZED OR STAINLESS STEEL HARDWARE FOR WALL
- MOUNT AND CONNECTION OF CHANNELS
- 2. GC SHALL USE NON-SHRINKING CAULK TO WEATHER SEAL
- ALL PENETRATIONS INTO OR THROUGH SHELTER WALL

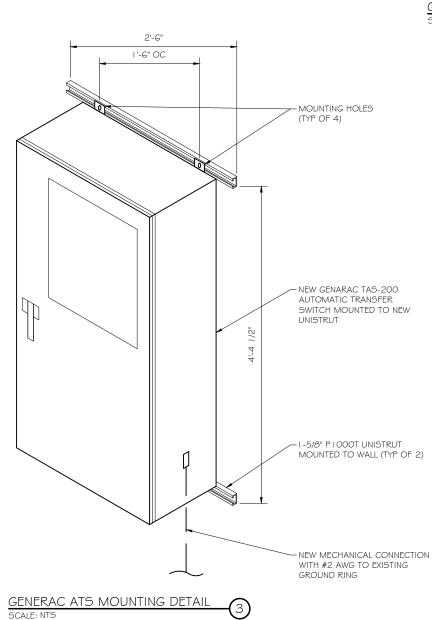

- NOTE: GROUND RODS MAY BE: - COPPER CLAD STEEL SOLID COPPER GROUND RODS SHALL HAVE A MAXIMUM SPACING TWICE THE LENGTH OF ROD 2 3. SEE RESISTIVITY REPORT FOR VERIFICATION AS AVAILABLE A LARGER CONDUCTOR 4 SHALL BE REQUIRED IN AREAS HIGHLY PRONE TO LIGHTNING AND/OR AREAS WITH HIGHLY ACIDIC SOIL GROUND RODS INSTALLED WITHIN CLOSE PROXIMITY TO TOWER OR WHEN SOIL IS AT OR BELOW 2,000 OHM-CM, SHALL BE GALVANIZED TO PREVENT GALVANIC CORROSION OF TOWER. (SEE ANSI/TIA-EIA-222-G) 6 PROVIDE (1) GROUND LEAD
- PROVIDE (1) GROUND LEAD TO EACH SIDE OF THE GENERATOR

2)

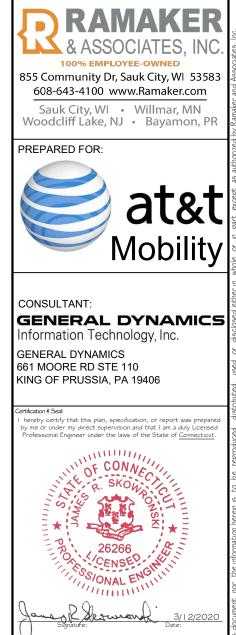

3/12/20 REVISED CDs IARK DATE DESCRIPTION SUE FINAL DATE 2/19/2020 1ASE ROJECT TITLE: EAST HAMPTON EAST FA ID # 10035422 94 EAST HIGH STREET EAST HAMPTON, CT 06424 SHEET TITLE: ATS, CONDUIT & GROUND ROD DETAILS SCALE: NONE PROJECT NUMBER 45804 SHEET E-3

SDC20 | 2.5L | 20 kW - AC **INDUSTRIAL DIESEL GENERATOR SET**

EPA Certified Stationary Emergency

Standby Power Rating 20 kW AC, 60 Hz

Codes and Standards



GENERAC[®] INDUSTRIAL

Model G007098-0 (Steel)



Powering Ahead

For over 50 years, Generac has provided innovative design and superior manufacturing.

Generac ensures superior quality by designing and manufacturing most of its generator components, including alternators, enclosures and base tanks, control systems and communications software

Generac gensets utilize a wide variety of options, configurations and arrangements, allowing us to meet the standby power needs of practically every application.

Generac searched globally to ensure the most reliable engines power our generators. We choose only engines that have already been proven in heavy-duty industrial applications under adverse conditions.

Generac is committed to ensuring our customers' service support continues after their generator purchase.

SDC20 | 2.5L | 20 kW - AC

INDUSTRIAL DIESEL GENERATOR SET EPA Certified Stationary Emergency

STANDARD FEATURES

ENGINE SYSTEM

- Oil Drain Extension
- · Air Cleaner with Service Indicator
- Fan Guard
- Stainless Steel Flexible Exhaust Connection Exhaust Silencer with Drain
- Factory Filled Oil & Coolant

Fuel System

Primary Fuel Filter

Cooling System

- 120V AC Coolant Heater
- Closed Coolant Recovery System
- UV/Ozone Resistant Hoses
- Factory-Installed Radiator
- 50/50 Ethylene Glycol Antifreeze
- Radiator Drain Extension

Electrical System

- Battery Charging Alternator
- AGM Spill Proof Battery Battery Cables
- Sealed/Rubber-Booted Engine Electrical Connec-
- tions
- Solenoid Activated Starter Motor
- Output Circuit Breaker

CONTROL SYSTEM

- Digital H Control Panel Dual 4x20 Display
- Programmable Crank Limiter
- 7-Day Programmable Exerciser
- Special Applications Programmable PLC
- RS-232/485 Communications • All-Phase Sensing Voltage Regulator
- Full System Status
- 2-Wire Start Compatible
- Power Output (kW)
- Power Factor
- kW Hours, Total & Last Run
- Real/Reactive/Apparent Power
- All Phase AC Voltage
- All Phase Currents
- Oil Pressure
- Coolant Temperature
- Coolant Level Engine Speed
- Battery Voltage

MODEL OPTIONS

CONTROL SYSTEM

- 21 Light Annunciator- Shipped Loose Kit and Field
- External E-Stop-Shipped Loose Kit and Field
- Installed

- TANKS
- Aluminum Enclosure O Extreme Cold Weather Kit - Shipped Loose Kit and Field Installed

- Conditions

- Customizable Alarms, Warnings, and Events Modbus protocol
- Predictive Maintenance Algorithm

• NFPA110 Level I and II (Programmable)

- Sealed Boards
- Password Parameter Adjustment Protection Single Point Ground Connections
- 15 Channel Data Logging

ALTERNATOR SYSTEM

Class H Insulation Material

Vented Rotor

Skewed Stator

Amortisseur Winding

Brushless Excitation

Rotor Dynamically Spin Balanced

Internal Genset Vibration Isolators

High Heat Wrapped Exhaust Piping

Silencer Enclosed Within Generator

• 12 Gallon System Spill Containment • 2.5 Gallon Fuel Fill Spill Containment

• Date/Time Fault History (Event Log)

Isochronous Governor Control

Waterproof/Sealed Connectors

· Audible Alarms and Shutdowns

E-Stop (Red Mushroom-Type)

• Not in Auto (Flashing Light)

Auto/Off/Manual Switch

Separation of Circuits- High/Low Voltage

Full Load Capacity Alternator

· Protective Thermal Shutdown

Sealed Bearings

GENERATOR SET

Single Side Service

Silencer Heat Shield

5 Year Extended Warranty

Extended Factory Testing

• Frequency

2/3 Pitch

· Alarm Information Automatically Comes Up On the Display

Alarms

ENCLOSURE

- - Installed

- 0.2 msec High Speed Data Logging



Model G007098-0 (Steel)

ENCLOSURE

- Serviceable Items Accessible Though Lift-Off Door High Performance Sound-Absorbing Material Gasketed Door Stamped Air-Intake Louvers
- Single Door Latch Lockable with Key & Padlock • Rhino Coat[™] - Textured Polyester Powder Coat • 150 MPH Wind Rating
- 36" Snow Rating

FUEL TANK

- UL 142 Compliant Double Wall Construction Factory Pressure Tested (5 psi) Rupture Basin Alarm · Fuel Level Gauge and Sender Check Valve in Supply Line • Rhino Coat[™] - Textured Polyester Powder Coat Stainless Steel Hardware Integrated Fork Pockets
- Generator Run- Dry Contact
- Major Alarm- Dry Contact
- Minor Alarm- Dry Contact
- Low Fuel Alarm- Dry Contact
- Rupture Basin Alarm- Dry Contact • Alarms & Warnings Time and Date Stamped
- Alarms & Warnings for Transient and Steady State
- Snap Shots of Key Operation Parameters During
- Alarms & Warnings Alarms and Warnings Spelled Out (No Alarm Codes)

External Fuel Vent- Shipped Loose Kit and Field

Realized in the second		
CONSULTANT: GENERAL DYNAMICS GENERAL DESCRIPTION ISUE 2/19/2020 PROJECT INFORMATION: 94 EAST HIGH STREET EAST HAMPTON, CT OG424 SHEET TITLE GENERAC 20KW GENERATOR SCALE: NONE INFORMATIONS SCALE: NONE		& ASSOCIATES, INC. 100% EMPLOYEE-OWNED 855 Community Dr, Sauk City, WI 53583 608-643-4100 www.Ramaker.com
GENERAL DYNAMICS Information Technology, Inc. GENERAL DYNAMICS 661 MOORE RD STE 110 KING OF PRUSSIA, PA 19406 Certication 4 Seal 1 hereby certify that this plan, specification, or report was prepared by me or under my direct supervision and that I am a duly Licensed Professional Engineer under the laws of the State of Connecticut. Image: Connecticut State of Connecticut State of Connecticut. Image: Connecticut State of Con		at&t
I hereby certify that the plan, specification, or report was prepared by me or under my direct supervision and that I am a duly lacensed Professional Engineer under the laws of the State of <u>Connectuul</u> . I hereby certify that the plan, specification, or report was prepared by me or under my direct supervision and that I am a duly lacensed Professional Engineer under the laws of the State of <u>Connectuul</u> . I hereby certify that the plan, specification, or report was prepared by me or under my direct supervision and that I am a duly lacensed Professional Engineer under the laws of the State of <u>Connectuul</u> . I hereby certify that the plan, specification, or report was prepared by the State of <u>Connectuul</u> . I hereby certify that the plan, specification, or report was prepared by the State of <u>Connectuul</u> . I hereby certify the the plan, specification, or the prepared by the State of <u>Connectuul</u> . I hereby certifies I syliphity/er		GENERAL DYNAMICS Information Technology, Inc. GENERAL DYNAMICS 661 MOORE RD STE 110
MARK DATE DESCRIPTION DATE 2/19/2020 PROJECT TITLE: EAST HAMPTON EAST FA ID # 10035422 PROJECT INFORMATION: 94 EAST HIGH STREET EAST HAMPTON, CT 06424 SHEET TITLE: GENERAC 20KW GENERATOR SPECIFICATIONS SCALE: NONE PROJECT 45804		by me or under my direct supervision and that I am a duly Licensed Professional Engineer under the laws of the State of <u>Connecticut</u> .
MARK DATE DESCRIPTION DATE 2/19/2020 PROJECT TITLE: EAST HAMPTON EAST FA ID # 10035422 PROJECT INFORMATION: 94 EAST HIGH STREET EAST HAMPTON, CT 06424 SHEET TITLE: GENERAC 20KW GENERATOR SPECIFICATIONS SCALE: NONE PROJECT A5804		
PROJECT INFORMATION: 94 EAST HIGH STREET 5 EAST HAMPTON, CT 06424 SHEET TITLE: GENERAC 20KW GENERATOR SPECIFICATIONS SCALE: NONE PROJECT 45804		MARK DATE DESCRIPTION ISSUE FINAL DATE 2/19/2020 PROJECT TITLE: EAST HAMPTON EAST
GENERAC 20KW GENERATOR SPECIFICATIONS SCALE: NONE 15804	5	PROJECT INFORMATION: 94 EAST HIGH STREET EAST HAMPTON, CT 06424
- · ·		GENERAC 20KW GENERATOR SPECIFICATIONS
		PROJECT 45804

SDC20 | 2.5L | 20 kW - AC **INDUSTRIAL DIESEL GENERATOR SET**

EPA Certified Stationary Emergency

APPLICATION AND ENGINEERING DATA

ENGINE SPECIFICATIONS

General

Make	Mitsubishi	
EPA Emissions Compliance	Interim Tier 4	
Cylinder #	4	
Туре	In-Line	
Displacement - L (Cu In)	2.5 (158)	
Bore - mm (in)	88 (3.5)	
Stroke - mm (in)	103 (4.1)	
Compression Ratio	22:1	
Intake Air Method	Naturally Aspirated	

Engine Governing

Governor	Electronic Isochronous
Frequency Regulation (Steady State)	± 0.25%

Lubrication System

Oil Pump Type	Trochoid Gear Pump
Oil Filter Type	Filtering Paper, Full Flow
Crankcase Capacity - L (qts)	6.5 (6.9)

GENERAC INDUSTRIAL

Model G007098-0 (Steel)

Cooling System

Cooling System Type Water Pump Type

Fan Type

Fan Speed (rpm)

Fuel System

Fuel Specifications

Fuel Filtering (microns)

Fuel Inject Pump Make

Fuel Supply Line - mm (in.)

Engine Electrical System

Battery Charger Alternator

Fuel Type

Injector Type

Engine Type

System Voltage

Battery Size Battery Group

Battery Voltage

Ground Polarity

Fan Diameter - mm (in) Coolant Heater Wattage

Coolant Heater Voltage

Forced Circulation

Centrifugal Pump

Ultra Low Sulfur Diesel #2

Engine Driven Gear

Pusher

2100 431.8 (17)

1000

120

ASTM

Bosch

Diesel

6.6 (0.26)

12 VDC

12V-50A

650 CCA

12 VDC

Negative

35

6

SDC20	Τ	2.5L	1	20	kW	- AC
	ΛĪΓ			סאדר		т

INDUSTRIAL DIESEL GENERATOR SEI EPA Certified Stationary Emergency

GENE

Model G007

Amps: 83

OPERATING DATA

POWER RATINGS

Single-Phase 120/240 VAC @1.0pf 20 kW Circuit Breaker Size 100A

FUEL CONSUMPTION RATES*

Dies	Diesel - gph (lph)		
Percent Load	Standby		
25%	0.74 (2.80)		
50%	0.99 (3.75)		
75%	1.41 (5.30)		
100%	1.90 (7.19)		
* Fuel supply installation must accommodate fuel consumption rates at 10			

COOLING

		Standby
Coolant Flow per Minute	gpm (lpm)	11.9 (45)
Coolant System Capacity	gal (L)	3.5 (13.2
Heat Rejection to Coolant	BTU/hr	238,200
Inlet Air	cfm (m ³ /min)	2365 (67
Max. Operating Ambient Temperature (Before Derate)	°F (°C)	77° (25°)
Maximum Radiator Backpressure	in H ₂ 0	0.50

COMBUSTION AIR REQUIREMENTS

				Standby	
			Flow at Rated Power cfm (m ³ /min)	88 (2.49)	
ENGINE EXHAUST		UST			
		Standby			
Rated Engine Speed	rpm	1800	Exhau	st Flow (Rated Output)	
Horsepower at Rated kW**	hp	33.5	Max. E	Backpressure (Post Silencer)	i
Piston Speed	ft/min	1220.47	Exhau	st Temp (Rated Output - Post Silencer)	
BMEP	psi	96.5			

ALTERNATOR SPECIFICATIONS Mecc Alte ECP 28-2L/4 Standard Model

Poles	4
Field Type	Revolving
Insulation Class - Rotor	Н
Insulation Class - Stator	Н
Total Harmonic Distortion	<5%
Telephone Interference Factor (TIF)	<45
Standard Excitation	Brushless

Bearings	Dual Sealed
Coupling	Belt, Pulley
Load Capacity - Standby	100%
Prototype Short Circuit Test	Yes
Voltage Regulator Type	Digital
Number of Sensed Phases	All
Regulation Accuracy (Steady State)	±0.5%

RATING DEFINITIONS

Standby - Applicable for a varying emergency load for the duration of a utility power outage with no overload capability.




** Refer to "Emissions Data Sheet" for maximum bHP for EPA and SCAQMD permitting purposes.

Deration – Operational characteristics consider maximum ambient conditions. Derate factors may apply under atypical site conditions. Please consult a Generac Power Systems Industrial Dealer for additional details. All performance ratings in accordance with ISO3046, E

GENERAC 20KW GENERATOR

SPECIFICATIONS SCALE: NTS

7098-0 (Steel)	RARACERS, INC. LOO% EMPLOYEE-OWNED S55 Community Dr, Sauk City, WI 53583 608-643-4100 www.Ramaker.com Sauk City, WI • Willmar, MN Woodcliff Lake, NJ • Bayamon, PR PREPARED FOR: PREPARED FOR: Attack of the second
	CONSULTANT: GENERAL DYNAMICS Information Technology, Inc. GENERAL DYNAMICS 661 MOORE RD STE 110 KING OF PRUSSIA, PA 19406
by 45) 00 67) 5°)	Cettification & Seal: I hereby certify that this plan, specification, or report was prepared by me or under my direct supervision and that I am a duly Licensed Professional Engineer under the laws of the State of <u>Connecticut</u> .
Standby cfm (m³/min) 193 (328) inHg (kPa) 1.38 (4.67) °F (°C) 928 (497.7)	Jane of Store States
	I 3/12/20 REVISED CDs MARK DATE DESCRIPTION ISSUE FINAL DATE 2/19/2020 PROJECT TITLE: EAST HAMPTON EAST FA ID # 10035422 PROJECT INFORMATION: 94 EAST HIGH STREET
BS5514, ISO8528 and DIN6271 standards.	4015 EAST HAMPTON, CT 06424 SHEET TITLE: GENERAC 20KW GENERATOR SPECIFICATIONS
	SCALE: NONE

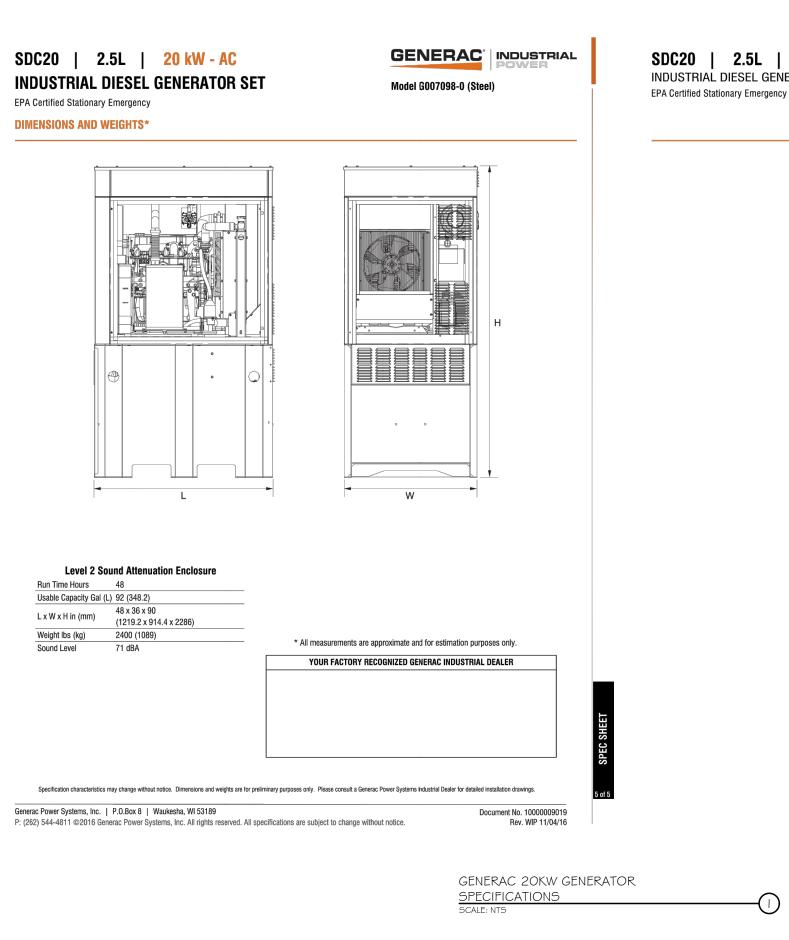

SDC20 | 2.5L | 20 kW - AC INDUSTRIAL DIESEL GENERATOR SET

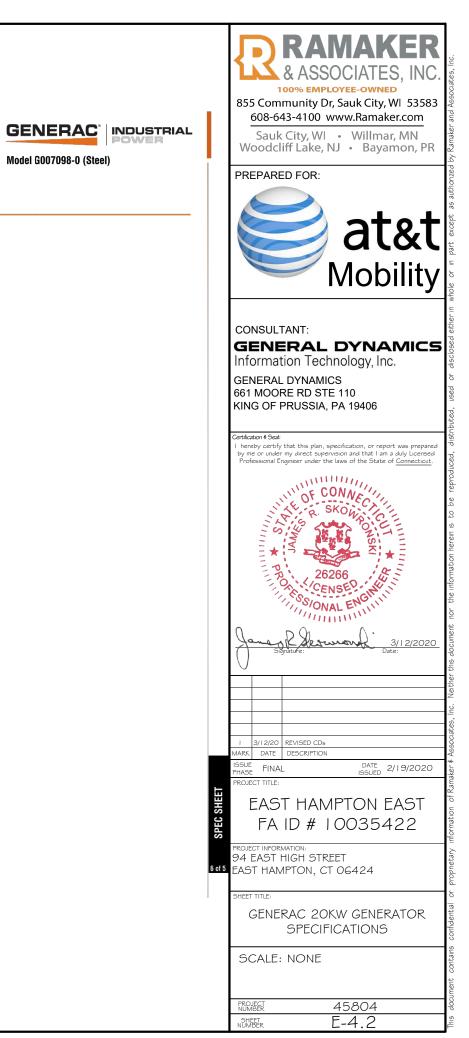




Image used for illustration purposes only.

Features

- STEEL CONSTRUCTION
- NEMA 3R ENCLOSURE WITH HINGED **"PADLOCKING" DOORS**
- STAINLESS STEEL HARDWARE
- CAMLOCK "QUICK CONNECT" CAPABILITY
- OPERATIONAL STATUS VIEW VIA **6 INCH TOUCH SCREEN**
- TEST FUNCTION FAST TEST & NORMAL TEST
- UL1008 LISTED FOR EMERGENCY SYSTEMS

Optional Features

- EXTENDED WARRANTY
- THREE-PHASE VOLTAGE CONFIGURATIONS

Codes and Standards

Generac products are designed to the following standards:



UL508, UL50, CSA C22.2 No. 178



NEC 700, 701 and 702

49,56 NEMA 250

Generator Annunciator Co
Alarm Terminal Board

Camlock Component	
Camlock Component	Shipped loose for multiple installation options
Dimensions	9" W x 9.4" D x 24.25" H
	Single-Phase: Black L1, Red L2, White-Neutral, Green-Grou
200A Camlock Generator Connection	3-Phase: Black L1, Red L2, Blue L3, White-Neutral, Green-Gr
	Uses 4 CH E1016 Male Connectors
	Mating Connector – CH E1016 Female

GENERAC ATS SPECIFICATIONS SCALE: NTS

Cabinet Specifications	
Dimensions	24"W x 12"D x 48"H
Weight	210 lbs.
	Single Chamber with Main Door
	Steel
	UL Type / NEMA 3R Rated
Construction	Powder Coat Finish for Corrosion Resistance
	C-UL-US Listed - Automatic Transfer Switch
	Stainless Steel Hardware
	3-Point Latching System with Pad-Lockable Handles
Mounting Options	Wall
	H-frame
Installed	Pre-wired alarm terminal strip


Electrical Specifications	
Voltage/Phase/Amps	120/240 Single-Phase, 200A 120/208 3-Phase, 200A 120/240 3-Phase, 200A
Breaker	Eaton 200 amp Utility Breaker
Dieanei	Eaton 200 amp Generator Breake
Maximum RMS Symmetrical Fault Current - Amps	25k AIC Rated
Protective Device Continuous Rating (Max) Amp	200
Input to Generator	350MCM - #6 AWG
Output to Site	350MCM - #6 AWG
Generator Annunciator Connector	Deutsch DTM04-12PA-L012
	Generator Run Alarm
	Generator Fail – Shutdown Alarm
Alarm Terminal Board	Generator Fail – Non Shutdown Ala
	Low Fuel Alarm
	Generator Theft Alarm
	AC Utility Fail Alarm

Application and Engineering Data

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n
arm





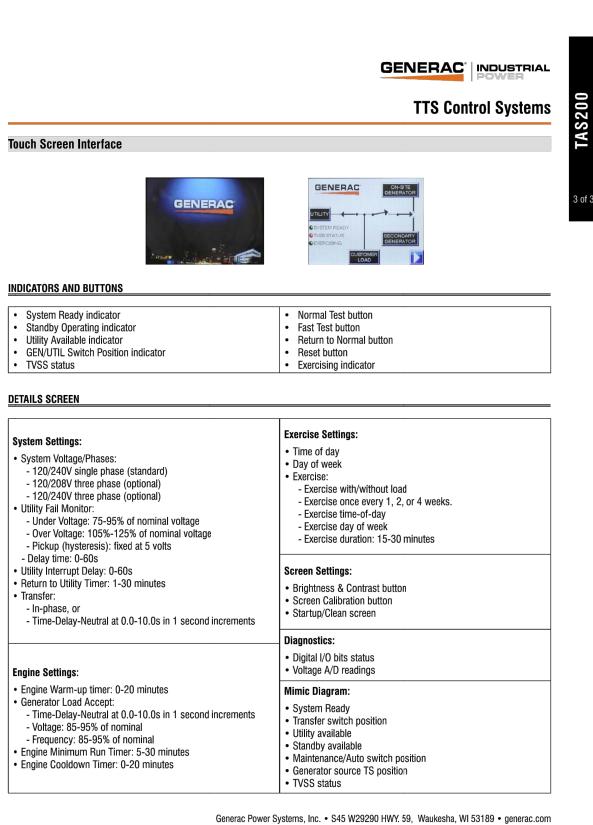

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GENERAC ATS SPECIFICATIONS SCALE: NTS



ATTACHMENT 2



STATE OF CONNECTICUT

CONNECTICUT SITING COUNCIL

Ten Franklin Square, New Britain, CT 06051 Phone: (860) 827-2935 Fax: (860) 827-2950 E-Mail: siting.council@ct.gov www.ct.gov/csc

February 21, 2014

Matt Burke TRM, Inc. 16 Chestnut Street Foxborough, MA 02035

RE: **EM-AT&T-042-140207** - American Telephone and Telegraph Company notice of intent to modify an existing telecommunications facility located at 94/96 East High Street, East Hampton, Connecticut.

Dear Mr. Burke:

The Connecticut Siting Council (Council) hereby acknowledges your notice to modify this existing telecommunications facility, pursuant to Section 16-50j-73 of the Regulations of Connecticut State Agencies with the following conditions:

- Any deviation from the proposed modification as specified in this notice and supporting materials with the Council shall render this acknowledgement invalid;
- Any material changes to this modification as proposed shall require the filing of a new notice with the Council;
- Within 45 days after completion of construction, the Council shall be notified in writing that construction has been completed;
- The validity of this action shall expire one year from the date of this letter; and
- The applicant may file a request for an extension of time beyond the one year deadline provided that such request is submitted to the Council not less than 60 days prior to the expiration.

The proposed modifications including the placement of all necessary equipment and shelters within the tower compound are to be implemented as specified here and in your notice dated February 7, 2014. The modifications are in compliance with the exception criteria in Section 16-50j-72 (b) of the Regulations of Connecticut State Agencies as changes to an existing facility site that would not increase tower height, extend the boundaries of the tower site, increase noise levels at the tower site boundary by six decibels, and increase the total radio frequencies electromagnetic radiation power density measured at the tower site boundary to or above the standard adopted by the State Department of Environmental Protection pursuant to General Statutes § 22a-162. This facility has also been carefully modeled to ensure that radio frequencies now used on this tower.

This decision is under the exclusive jurisdiction of the Council. Please be advised that the validity of this action shall expire one year from the date of this letter. Any additional change to this facility will require explicit notice to this agency pursuant to Regulations of Connecticut State Agencies Section 16-50j-73. Such notice shall include all relevant information regarding the proposed change with cumulative worst-case modeling of radio frequency exposure at the closest point of uncontrolled access to the tower base, consistent with Federal Communications Commission, Office of Engineering and Technology, Bulletin 65. Thank you for your attention and cooperation.



Very truly yours,

Melanie A. Bachman Acting Executive Director

MAB/CDM/cm

c: The Honorable Barbara Moore, Chairman Town Council, Town of East Hampton Michael Maniscalco, Town Manager, Town of East Hampton James Carey, Zoning Enforcement Officer, Town of East Hampton Crown Castle

ATTACHMENT 3

Fedex.

Shipment Receipt

Address Information	
Ship to:	Ship from:
Council Chairman Pete	Lucia Chiocchio, Esq.
Brown	
Town of East Hampton	Cuddy & Feder LLP
20 East High Street	445 Hamilton Avenue

EAST HAMPTON, CT 06424 US 914-761-1300 Cuddy & Feder LLP 445 Hamilton Avenue Suite 1400 White Plains, NY 10601 US 9147611300

Shipment Information:

Tracking no.: 770037530834 Ship date: 03/17/2020 Estimated shipping charges: 15.57 USD

Package Information

Pricing option: FedEx Standard Rate Service type: Priority Overnight Package type: FedEx Envelope Number of packages: 1 Total weight: 1 LBS Declared Value: 0.00 USD Special Services: Pickup/Drop-off: Use an already scheduled pickup at my location

Billing Information:

Bill transportation to: CuddyFeder-963 Your reference: 1844-3526 P.O. no.: Invoice no.: Department no.:

Thank you for shipping online with FedEx ShipManager at fedex.com.

Please Note

FedEx will not be responsible for any claim in excess of \$100 per package, whether the result of loss, damage, delay, non-delivery, misdelivery, or misinformation, unless you declare a higher value, pay an additional charge, document your actual loss and file a timely claim. Limitations found in the current FedEx Service Guide apply. Your right to recover from FedEx for any loss, including intrinsic value of the package, loss of sales, income interest, profit, attorney's fees, costs, and other forms of damage whether direct, incidental, consequential, or special is limited to the greater of \$100 or the authorized declared value. Recovery cannot exceed actual documented loss. Maximum for items of extraordinary value is \$1000, e.g., jeweiry, precious metals, negotiable instruments and other items listed in our Service Guide. Written claims must be filed within strict time limits; Consult the applicable FedEx Service Guide for details.

The estimated shipping charge may be different than the actual charges for your shipment. Differences may occur based on actual weight, dimensions, and other factors. Consult the applicable FedEx Service Guide or the FedEx Rate Sheets for details on how shipping charges are calculated.

Fedex.

Shipment Receipt

Address Information Ship to: CROWN CASTLE

2000 Corporate Dr. 11th Floor CANONSBURG, PA 15317 US 914-761-1300 Ship from: Lucia Chiocchio, Esq. Cuddy & Feder LLP 445 Hamilton Avenue Suite 1400 White Plains, NY 10601 US 9147611300

Shipment Information:

Tracking no.: 770037601966 Ship date: 03/17/2020 Estimated shipping charges: 13.11 USD

Package Information

Pricing option: FedEx Standard Rate Service type: Priority Overnight Package type: FedEx Envelope Number of packages: 1 Total weight: 1 LBS Declared Value: 0.00 USD Special Services: Pickup/Drop-off: Use an already scheduled pickup at my location

Billing Information:

Bill transportation to: CuddyFeder-963 Your reference: 1844-3526 P.O. no.: Invoice no.: Department no.:

Thank you for shipping online with FedEx ShipManager at fedex.com.

Please Note

FedEx will not be responsible for any claim in excess of \$100 per package, whether the result of loss, damage, delay, non-delivery, misdelivery, or misinformation, unless you declare a higher value, pay an additional charge, document your actual loss and file a timely claim. Limitations found in the current FedEx Service Guide apply. Your right to recover from FedEx for any loss, including intrinsic value of the package, loss of sales, income interest, profit, attorney's fees, costs, and other forms of damage whether direct, incidental, consequentilal, or special is limited to the greater of \$100 or the authorized declared value. Recovery cannot exceed actual documented loss. Maximum for items of extraordinary value is \$1000, e.g., jewelry, precious metals, negotiable instruments and other items listed in our Service Guide. Written claims must be filed within strict time limits; Consult the applicable FedEx Service Guide actual for details.

The estimated shipping charge may be different than the actual charges for your shipment. Differences may occur based on actual weight, dimensions, and other factors. Consult the applicable FedEx Service Guide or the FedEx Rate Sheets for details on how shipping charges are calculated.

Shipment Receipt

Address Information Ship to: PAULS + SANDYS TOO INC

Ship from: Lucia Chiocchio, Esq.

93 East High Street

EAST HAMPTON, CT 06424 US 914-761-1300 Cuddy & Feder LLP 445 Hamilton Avenue Suite 1400 White Plains, NY 10601 US 9147611300

Shipment Information:

Tracking no.: 770037672991 Ship date: 03/17/2020 Estimated shipping charges: 15.57 USD

Package Information

Pricing option: FedEx Standard Rate Service type: Priority Overnight Package type: FedEx Envelope Number of packages: 1 Total weight: 1 LBS Declared Value: 0.00 USD Special Services: Pickup/Drop-off: Use an already scheduled pickup at my location

Billing Information:

Bill transportation to: CuddyFeder-963 Your reference: 1844-3526 P.O. no.: Invoice no.: Department no.:

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