

# STATE OF CONNECTICUT CONNECTICUT SITING COUNCIL

Ten Franklin Square, New Britain, CT 06051 Phone: (860) 827-2935 Fax: (860) 827-2950

E-Mail: siting.council@ct.gov Web Site: portal.ct.gov/csc

### VIA ELECTRONIC MAIL

September 13, 2021

Victoria Masse Northeast Site Solutions 420 Main Street, Unit 2 Sturbridge, MA 01566 victoria@northeastsitesolutions.com

RE: EM-T-MOBILE-033-210701 – T-Mobile notice of intent to modify an existing

telecommunications facility located at 207 West Street, Cromwell, Connecticut.

Dear Ms. Masse:

The Connecticut Siting Council (Council) is in receipt of your correspondence of September 2, 2021 submitted in response to the Council's September 1, 2021 notification of an incomplete request for exempt modification with regard to the above-referenced matter.

The submission renders the request for exempt modification complete and the Council will process the request in accordance with the Federal Communications Commission 60-day timeframe.

Thank you for your attention and cooperation.

Sincerely,

Melanie Bachman Executive Director

MAB/FOC/laf

From: Deborah Chase <deborah@northeastsitesolutions.com>

Sent: Thursday, September 2, 2021 3:01 PM

**To:** CSC-DL Siting Council <Siting.Council@ct.gov>; Bachman, Melanie <Melanie.Bachman@ct.gov>; Mathews, Lisa A <Lisa.A.Mathews@ct.gov>; Fontaine, Lisa <Lisa.Fontaine@ct.gov>; Robidoux, Evan

<Evan.Robidoux@ct.gov>

**Cc:** victoria@northeastsitesolutions.com; Denise <denise@northeastsitesolutions.com>; Sheldon

Freincle <sheldon@northeastsitesolutions.com>

Subject: 2nd Incomplete for EM-T-MOBILE-033-210701 West Street, Cromwell

EXTERNAL EMAIL: This email originated from outside of the organization. Do not click any links or open any attachments unless you trust the sender and know the content is safe.

**Siting Council** 

Please see attached revised electronic version of the requested information per the attached incomplete letter.

I have also attached the correct Construction Drawings as well as mailing receipt for the hard copies that will go out via Priority Mail today.

Please let me know if you require any additional information for the incomplete exempt modification to be rendered complete and processed.

Thank you very much

### **Deborah Chase**

Senior Project Coordinator & Analyst

Mobile: 860-490-8839





Northeast Site Solutions Victoria Masse 420 Main Street, Unit 2 Sturbridge, MA 01566 860-306-2326 victoria@northeastsitesolutions.com

June 22, 2021

Members of the Siting Council Connecticut Siting Council Ten Franklin Square New Britain, CT 06051

RE: Notice of Exempt Modification 207 West Street, Cromwell CT 06416

> Latitude: 41.602208 Longitude: -72.67934

T-Mobile Site#: CTHA241C NHP

Dear Ms. Bachman:

T-Mobile currently maintains nine (9) antennas at the 50 and 41-foot levels of the existing 53-foot monopole tower at 207 West Street, Cromwell CT. The 53-foot tower and property are owned by The Stop & Shop Supermarket Company LLC. T-Mobile now intends to add a 25Kw generator to an extended concrete pad within an expanded fenced compound.

### Ground work only-Install New:

- (1) GENERAC RD 25 KW AC DIESEL GENERATOR 240-gallon double walled self-contained tank with fuel sensor. Requires two (2) 12-minute run cycles by-weekly.
- (1) Concrete Pad Extension
- (1) Fenced Area (89 S.F.)



This facility was approved by the CT Siting Council –on January 18, 2006- Petition No. 799. Please see attached approval.

Please accept this letter as notification pursuant to Regulations of Connecticut State Agencies § 16- SOj-73, for construction that constitutes an exempt modification pursuant to R.C.S.A. § 16-50j-72(b)(2). In accordance with R.C.S.A. § 16-SOj-73, a copy of this letter is being sent to Mayor Enzo Faienza, and Stuart B. Popper, Director of Planning and Development for the Town of Cromwell, as well as the property owner and the tower owner.

The planned modifications to the facility fall squarely within those activities explicitly provided for in R.C.S;A. § 16-50j-72(b)(2).

- 1. The proposed modifications will not result in an increase in the height of the existing structure.
- 2. The proposed modifications will not require the extension of the site boundary.
- 3. The proposed modifications will not increase noise levels at the facility by six decibels or more, or to levels that exceed state and local criteria.
- 4. The operation of the replacement antennas will not increase radio frequency emissions at the facility to a level at or above the Federal Communications Commission safety standard.
- 5. The proposed modifications will not cause a change or alteration in the physical or environmental characteristics of the site.
- 6. The existing structure and its foundation can support the proposed loading.

For the foregoing reasons, T-Mobile respectfully submits that the proposed modifications to the above referenced telecommunications facility constitute an exempt modification under R.C.S.A. § 16-50j-72(b)(2).

### Sincerely,

Victoria Masse

Mobile: 860-306-2326 Fax: 413-521-0558

Office: 420 Main Street, Unit 2, Sturbridge MA 01566

Email: victoria@northeastsitesolutions.com



Attachments cc: Mayor Enzo Faienza 41 West St Cromwell, CT 06416

Anthony J Salvatore- Town Manager 41 West St Cronwell, CT 06416

Stuart B. Popper, Director of Planning and Development 41 West St Cromwell, CT 06416

CNLVII SSCROCT LLC 195 North St Suite 100 Teterboro, NJ 07608

# Exhibit A



# STATE OF CONNECTICUT

# CONNECTICUT SITING COUNCIL

Ten Franklin Square, New Britain, CT 06051 Phone: (860) 827-2935 Fax: (860) 827-2950 E-Mail: siting.council@ct.gov Internet: ct.gov/csc

# CERTIFIED MAIL RETURN RECEIPT REQUESTED

January 22, 2007

H. Karina Fournier Zoning Department T-Mobile 30 Cold Spring Road Rocky Hill, CT 06067

RE: **PETITION NO. 799** - Omnipoint Communications, Inc. (T-Mobile) petition for a declaratory ruling that no Certificate of Environmental Compatibility and Public Need is required for the replacement of an existing gas station sign with a monopole at 207 West Street, Cromwell, Connecticut.

Dear Ms. Fournier:

At a public meeting held on January 18, 2007, the Connecticut Siting Council (Council) considered and ruled that this proposal would not have a substantial adverse environmental effect, and pursuant to General Statutes § 16-50k would not require a Certificate of Environmental Compatibility and Public Need with the following conditions:

- 1. The applicant shall prepare an erosion and sediment control checklist for use in the field.
- 2. The applicant shall notify the Development Compliance Officer and the Town Engineer prior to commencement of work.

This decision is under the exclusive jurisdiction of the Council and is not applicable to any other modification or construction. All work is to be implemented as specified in the petition, dated December 21, 2006.

Enclosed for your information is a copy of the staff report on this project.

Cause/

Very truly yours,

Daniel F. Caruso Chairman

DFC/MP/laf

c: The Honorable Paul C. Beaulieu, First Selectman, Town of Cromwell Frederic Curtin, Zoning Enforcement Officer, Town of Cromwell



# STATE OF CONNECTICUT

## CONNECTICUT SITING COUNCIL

Ten Franklin Square, New Britain, CT 06051 Phone: (860) 827-2935 Fax: (860) 827-2950 E-Mail: siting.council@ct.gov Internet: ct.gov/csc

Petition No. 799
Staff Report
T-Mobile
207 West Street, Cromwell
January 18, 2006

On December 21, 2006, the Connecticut Siting Council (Council) received a petition (Petition) from Omnipoint Communications, Inc. (T-Mobile) for a declaratory ruling that no Certificate of Environmental Compatibility and Public Need is required for the proposed replacement of a gas station sign with a monopole at 207 West Street, Cromwell. Specifically, T-Mobile seeks to remove an existing 54-foot high sign structure (that is not currently being used for any purpose) and replace it with a 54-foot monopole on the property of an Exxon Station on Route 372 (West Street). The existing sign structure does not meet the current wind load requirements for T-Mobile's proposed antennas.

The Petition was field reviewed by Council member Phil Ashton and Mike Perrone of the Council staff on January 8, 2007. Two representatives from T-Mobile: H. Karina Fournier, Zoning Department and Brian Paul, Construction Manager also attended the field review.

The monopole would have three flush-mounted panel antennas centered at the 51-foot level, so that the top of the antennas would be flush with the top of the tower. The proposed antennas would fill an existing coverage gap T-Mobile has in parts of Cromwell in the vicinity of Route 372.

T-Mobile would also install a 15-foot x 15-foot fenced compound which would contain equipment including three BTS cabinets on two 5-foot x 10-foot concrete pads. The proposed tower would be located in the same location as the existing sign. The compound would be separate from the tower.

To the south of the site, the surrounding area is wooded. To the north of the site is Route 372 with a commercial property across the street and one residential/commercial property diagonally across the street. To the east of the site is Stop and Shop Plaza. To the west of the site is commercial.

The nearest wetlands are approximately 55 feet to the south of the proposed compound. T-Mobile would install proper erosion and sedimentation controls. T-Mobile has received a permit from the Town of Cromwell Inland Wetlands and Watercourses Agency (Town IWWA). The Town IWWA granted the petition with the following general conditions:



- 1. The applicant shall prepare an erosion and sediment control checklist for use in the field.
- 2. The permit shall expire five years after the date of the issuance (if the project is not constructed).
- 3. All development shall be conducted as shown on plans submitted in connection with the application as amended to reflect any conditions of approval.
- 4. The Permittee shall notify the Development Compliance Officer and the Town Engineer prior to commencement of any work.

The tower would not be located in a flood zone. The equipment compound would be technically located in a 500-year flood zone; however, the chances of such a flood occurring are very remote (approximately 0.2 percent in a given year).

The proposed monopole would be the same height as the existing sign structure, but considerably narrower and more compact. As such, the visual impact is expected to decrease with T-Mobile's proposal. In addition, the equipment compound would be located behind an existing wood stockade fence, thus significantly blocking the view of the compound from Route 372. Utilities would run underground and would connect to an existing wood pole on Route 372.

The height of the proposed monopole is also not significantly higher than the existing 40 to 45 feet tall electric distribution poles on Route 372. The tower is well under 200 feet tall and there are no airports within 5 miles of the site, so FAA registration is not required. Also, the worst-case power density at the base of the tower would be 24.9% of the applicable limit.

The structural analysis takes into account the three antennas and also indicates that the tower would be capable of supporting a 9-foot by 9-foot sign on the top. However, there are no plans to install a sign as part of T-Mobile's proposal. Should the property owner decide to install a sign in the future, it would require a separate municipal review and approval. But if a sign is contemplated, Council staff notes that this could increase the visibility of the structure.

All abutters (including the properties across the street) and the property owner were notified by T-Mobile by letters and all were asked to contact S. Derek Phelps with any questions or concerns by January 16, 2006. No comments were received.

Staff suggests adopting the following conditions:

- 1. The applicant shall prepare an erosion and sediment control checklist for use in the field.
- 2. The applicant shall notify the Development Compliance Officer and the Town Engineer prior to commencement of any work.

# Exhibit B

04/06/2018 9:01:10PM **TOWN OF CROMWELL** Printed By: Shawna

207 WEST STREET Parcel ID: 00422500 Location:

17013

Map-Lot 21-6A

0

Last Revaluation - October 1, 2017

**Total Value** 

1,037,143

1,037,143

GeneralNotes

1,282,105 PURCHASE WAS FOR 36.8

swap antennas on cell tow

Outbuildings

100,000

100,000

Sale Verif

Other

0 Other

**Current Owner** Percent TA CROMWELL LLC 100 TA NEW MILFORD LLC

PO BOX 6500

Current \	/alue Information		Override
Use Code	Land Value	PA 490 Value	Building Value
201	652,600	0	284,543

Vol-Page

1474-120

1432-218

1338-242

1335-029

989-131

652,600

**Patriot** Properties Inc.

**Property Factors** 

5701 YES

Draviana Valua Information

**Sales Information** 

COLUMBIA PROPERTY INVES

GAS DEVELOPMENT CROMW

18378

TA CROMWELL LLC

TA CROMWELL LLC

CHOUDHRY TAHIR

**TOTAL** 

Grantee

Previous	value information
Tax Yr	Land Value
2019	652 600

1 1011045	Value IIIIoiiiiatie	/11			
Tax Yr	Land Value	Bldg Value	Outbuildings	Total Value	Total Assessmen
2018	652,600	252,800	464,300	1,369,700	958,790
2017	652,600	252,800	464,300	1,369,700	958,790
2016	537,650	317,140	87,480	942,270	659,600
2015	537,650	317,140	87,480	942,270	659,600
2014	537,650	317,140	87,480	942,270	659,600
2013	537,650	317,140	87,480	942,270	659,600

SalePrice

1,282,105

2,896,897

1,820,000

610,000

284,543

Total Assessmen	Flood:	YES
958,790	Торо:	
958,790	Street:	Paved
659,600	Dev. Map	ZZ-18
659,600	Dev. Map	
659,600	·	
659,600	Zo	ning

**Total Assessed** 

726,000

726,000

# **Zoning Data**

Desc. HB 100.00

# %

Census

	Utilities
2	Public Water
3	Public Sewer

**BAA** 

17G;07K

**General Notes** 

Previous Owner(s) TA CROMWELL LLC

CPI CROMWELL LLC

0

CARLISLE

STOP + SHOP GAS MART

Date

12/27/2017

09/11/2017

05/19/2017 09/20/2011

01/28/2011

11/18/2010

11/16/2010

10/25/2010

10/19/2010

10/19/2010

Permit- Miscellaneous

Permit- Miscellaneous

Activity Information									
Activity Information		Building Permit Information							
Results	Visited By	Date	Permit #	Description	Amount	% Comp	Visit Date	CO Date	GeneralNotes
Informal Review No Change	John Valente	09/13/2011	20141	Other	5,400	100	09/20/2011	09/20/2011	Rplc tank monitor, consul
Change - Value Change Company	John Valente	11/29/2010	19525	Sign	25,000	100	01/28/2011	01/01/2011	
No Change - Field Review	Dave Stannard	11/18/2010	19514	Other	0	100	11/18/2010		Inst dry chem fire suppre
Permit- Miscellaneous	AO								, , , , , , , , , , , , , , , , , , , ,
Permit- Miscellaneous	AO	11/16/2010	19498	Electric	0	100	11/16/2010		Install CCTV close circui
Permit- Miscellaneous	AO	10/25/2010	19445	Electric	0	100	10/25/2010		
Permit- Miscellaneous	AO	10/19/2010	19427	Other	565,000	100	10/19/2010	12/01/2010	Retrofit exisitng fuel fa
Permit- Miscellaneous	AO	10/19/2010	19428	Other	0	100	10/19/2010		Install burglar alarm

SaleDate

09/11/2013

10/17/2012

06/25/2010

05/26/2010

12/08/2003

Type

	Land Data										
			Unit			Special	Appraised	PA 490	Neigh		
Use	Description	Units	Tvpe	Neiah	Land Adjustments	Land Calc	Value	Asmt	Order		Notes
201	Commercial	51,836	SF	CL			652,600	0	1400	USE	

26,000

Total Area: 1.19

ΑO

ΑO

PA 490 Use Asmt: 0

06/01/2009

Total Appraised: 652,600

Other

Assessed Value: 456,820

100

01/27/2010

01/27/2010

ParceIID: 00422500

Bldg Seq 1 Of 1

Exterior Information

Building Type: Gas Mart

0

Story Ht: Living Units:

Foundation:

 Prim. Ext. Wall:
 Concrete
 50%

 Sec. Ext. Wall:
 Pre-finsh Me
 50%

 Roof Type:
 Flat

Ceram Clay T

1 Story

Roof Type: Flat Roof Cover: T&G/Rubber Avg. Wall Ht: 14.00

Color:

### Interior Information

Prime Wall: Drywall Sec. Wall:

Floor Type: Sec. Floor:

Heat Fuel: Gas Heat Type: Forced Air

Sec. Ht Type:

% A/C: 100 % Sprinkled: 0 Bsmt. Gar: 0

 Kitchens:
 0
 Add. Kit:
 0

 Fireplaces:
 0
 Gas:
 0

 Int. Condition:
 Typical

## **Room Count**

Total Rooms: Bedrooms:

### **Bath Features**

 Full Baths:
 0

 Addl. Full Baths:
 0

 Half Baths:
 0

 Addl. Half Baths:
 0

 Full Bths Below:
 0

 Half Bths Below:
 0

 Other Fixtures:
 0

 Total Baths:
 0

Location: 207 WEST STREET

### **Condo Information**

Name: Style: Location: Tot Units:

### **General Information**

 Year Blt:
 1973

 Grade:
 B 

 Remodeled Yr:
 2010

Rem. Kitchen Yr: Rem. Bath Yr:

De	preciation	

Phys Cond	Very Good	13.20
Func		0.00
Econ		0.00
Spec		0.00
ov		0.00

%

Total %Dep: 13.20

### Calculation

 Basic \$/SQ
 117.00

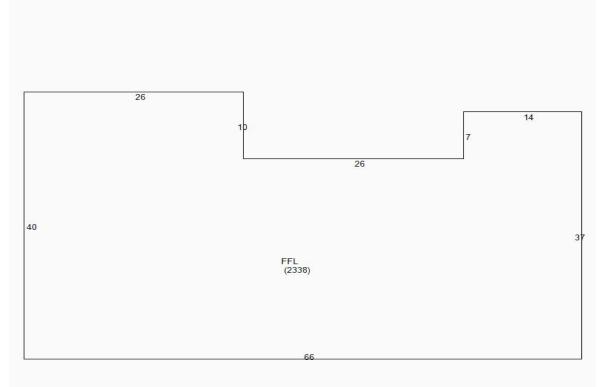
 Replacement Cost
 296,863

 Depreciation
 39,186

 Depreciated Value
 257,677

Final Total (Rounded) 257,700





Shawna


Printed By:

04/06/2018

9:01:10PM

Extra Features / Yard Items (1st 10 Lines Displayed)										
Code	Description	Qty	Size	Cond.	Year	Unit Price	Dep%	UndepValue	Appraised Value	Assessment
LT1	Light 1	1	3	AV	2002	1,000.00	13	3,600	3,100	2,170
LT2	Light 2	1	1	AV	2002	1,500.00	13	1,800	1,600	1,120
PAV1	Paving Asph.	1	12,900	AV	1973	3.00	35	46,440	30,200	21,140
PAV2	Paving Concr	1	4,370	AV	2002	5.00	13	26,220	22,800	15,960
TNK2	Tank 3K-10K	1	10,000	PR	2002	20.00	23	240,000	184,800	129,360
TNK3	Tank >10K	1	12,000	PR	2002	20.00	23	288,000	221,800	155,260
Total Sr	o. Features:		Tota	al Yard Ite	ms	464,300	Total Appra	aised: 464,300	Total Assessed Value	325,010

Sub Area Detail								
Code	Desc.	Living	Gross Area					
FFL	First Floor	2,338	2,338					
Total		2,338	2,338					

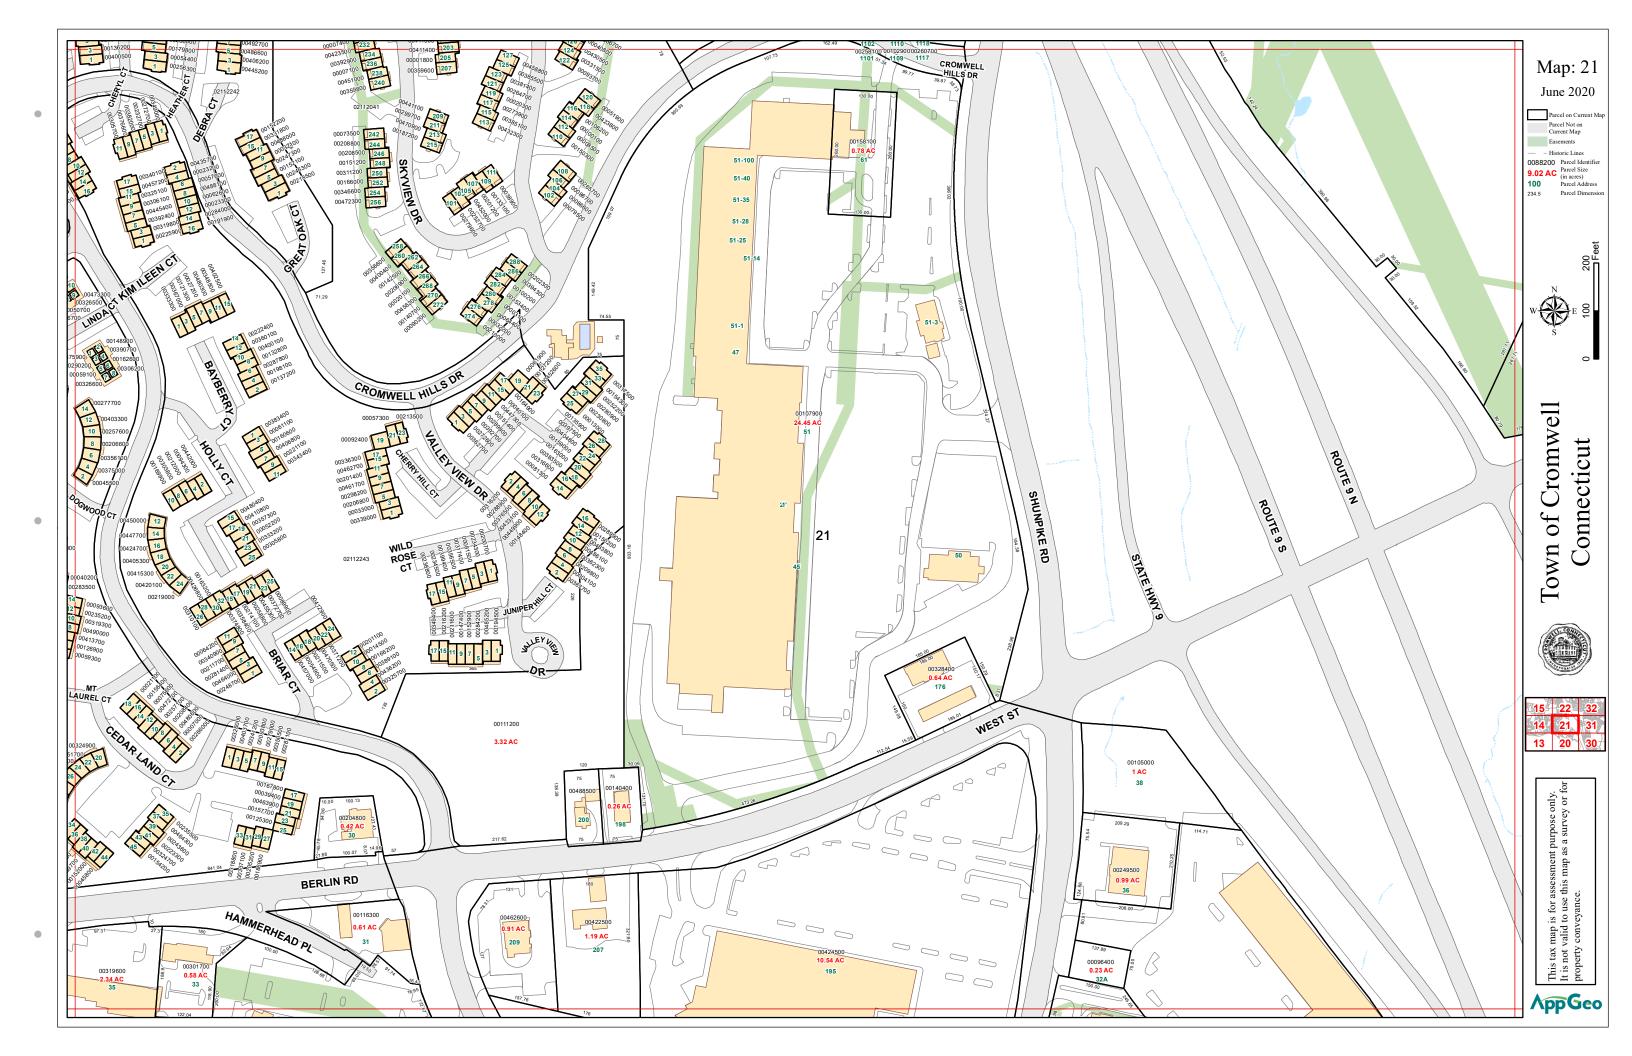

# Exhibit C

# MODIFICATION OF EXISTING WIRELESS FACILITY BY

# T··Mobile·

# T-MOBILE NORTHEAST LLC

PROJECT TITLE: NATIONAL HARDENING

SITE NUMBER: CTHA241C SITE NAME: HA241 / EXXON SIGN SITE ADDRESS: 207 WEST STREET CROMWELL, CT 06416

OCATION

\_OCATION

## **PROJECT NOTES:**

. THIS IS AN UNMANNED TELECOMMUNICATION FACILITY AND NOT FOR HUMAN HABITATION: HANDICAPPED ACCESS IS NOT REQUIRED.

SITE IMAGE:

SITE MAP:

- POTABLE WATER OR SANITARY SERVICE IS NOT REQUIRED. NO OUTDOOR STORAGE OR ANY SOLID WASTE RECEPTACLES REQUIRED.
- CONTRACTOR SHALL VERIFY ALL PLANS, EXISTING DIMENSIONS, AND CONDITIONS ON THE JOB SITE. CONTRACTOR SHALL IMMEDIATELY NOTIFY THE ARCHITECT/ENGINEER IN WRITING OF ANY DISCREPANCIES BEFORE PROCEEDING WITH THE WORK. FAILURE TO NOTIFY THE ARCHITECT/ENGINEER PLACES THE RESPONSIBILITY ON THE CONTRACTOR TO CORRECT THE DISCREPANCIES AT THE CONTRACTOR'S EXPENSE.
- DEVELOPMENT AND USE OF THE SITE WILL CONFORM TO ALL APPLICABLE CODES, ORDINANCES AND SPECIFICATIONS.

## **CODE COMPLIANCE:**

ALL WORK SHALL COMPLY WITH THE CURRENT NATIONAL AND CONNECTICUT STATE BUILDING AND LIFE SAFETY CODES, SUPPLEMENTS AND AMENDMENTS INCLUDING BUT NOT LIMITED TO THE LATEST EDITION OF:

CONNECTICUT STATE BUILDING CODE (CSBC).

ANSI/TIA-222-G STRUCTURAL STANDARD FOR ANTENNA SUPPORTING STRUCTURES AND ANTENNAS.

NATIONAL ELECTRICAL CODE (NEC) FOR POWER AND GROUNDING REQUIREMENTS.

OCCUPATIONAL SAFETY AND HEALTH ACT (OSHA).

NFPA - NATIONAL FIRE PROTECTION ASSOCIATION

811

Connecticut - Call Before You Dig

Minimum of 2 working days in advance, 922-4455 more than 30 days in advance

## **APPROVALS:**

FSA CM	DATE	
RF ENGINEER	DATE	
FOPS	DATE	
T-MOBILE ENGINEERING AND DEVELOPMENT	DATE	

DATE

DATE



THE PROPOSED PROJECT SCOPE WILL CONSIST OF INSTALLING A NEW GENERAC RD 25 KW AC DIESEL GENERATOR AND TANK FOR AN EXISTING TELECOM BASE STATION. NO SIGNIFICANT GRADING IS REQUIRED. ALL WORK IS CONTAINED WITHIN THE EXISTING T-MOBILE FENCED EQUIPMENT ARFA

## **PROJECT INFORMATION:**

ADDRESS:

207 WEST STREET CROMWELL, CT 06416

PARCEL ID: 00422500

ZONING DISTRICT: HI

COORDINATES: 41° 36' 07.94" N, 72° 40' 45.61" W

AVERAGE GROUND ELEV.: 23'± (AMSL)

## **PROJECT TEAM:**

APPLICANT:

T-MOBILE NORTHEAST, LLC. 35 GRIFFIN ROAD SOUTH BLOOMFIELD, CT 06002

860-692-7100

PROPERTY OWNER:

TA CROMWELL LLC TA NEW MILFORD LLC PO BOX 6500 CARLISLE, PA 17013

PROJECT MANAGER

NORTHEAST SITE SOLUTIONS 420 MAIN STREET, BLDG 4 STURBRIDGE, MA 01566

SHELDON FREINCLE
SHELDON@NORTHEASTSITESOLUTIONS COM

201-776-8521

ENGINEERING CONSULTANTS: FORESITE LLC

462 WALNUT ST NEWTON, MA 02460 SAEED MOSSAVAT SMOSSAVAT@FORESITELLC.COM

617-212-3123

## **SHEET INDEX:**

T-1: TITLE SHEET N-1: GENERAL NOTES

C-1: SITE POINT CLOUD
A-1: SITE PLAN

A-2: GENERATOR SPECIFICATIONS
A-3: GENERATOR SPECIFICATIONS

-4: AUTOMATIC TRANSFER SWITCH SPECIFICATIONS -1: ELECTRICAL DETAILS

1: GROUNDING DETAILS

T-MOBILE NORTHEAST LLC
35 GRIFFIN ROAD SOUTH

APPLICANT:

T - Mobile

35 GRIFFIN ROAD SOUTH BLOOMFIELD, CT 06002 860-692-7100

# PROJECT MANAGER (((+)))) NORTHEAST SITE SOLUTIONS Taraky Window Development 420 MAIN STREET, BLDG 4 STURBRIDGE MA 01566

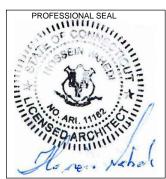
**CONSULTANT:** 

203-275-6669



Architects . Engineers . Surveyo

462 WALNUT STREET NEWTON, MA 02460 617-212-3123



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REV	DESCRIPTION	DATE
Α	PRELIMINARY	05/22/21
0	FINAL ISSUED	05/25/21
1	REVISED	08/13/21
		·

SITE NUMBER: CTHA241C SITE NAME: HA241 / EXXON SIGN SITE ADDRESS: 207 WEST STREET CROMWELL, CT 06416

SHEET TITLE:

T-1: TITLE SHEET

- 1. THE CONTRACTOR SHALL GIVE ALL NOTICES AND COMPLY WITH ALL LAWS, ORDINANCES, RULES, REGULATIONS AND LAWFUL ORDERS OF ANY PUBLIC AUTHORITY, MUNICIPAL AND UTILITY COMPANY SPECIFICATIONS, AND LOCAL AND STATE JURISDICTIONAL CODES BEARING ON THE PERFORMANCE OF THE WORK. THE WORK PERFORMED ON THE PROJECT AND THE MATERIALS INSTALLED SHALL BE IN STRICT ACCORDANCE WITH ALL APPLICABLE CODES, REGULATIONS, AND ORDINANCES.
- 2. THE ARCHITECT/ENGINEER HAS MADE EVERY EFFORT TO SET FORTH IN THE CONSTRUCTION AND CONTRACT DOCUMENTS THE COMPLETE SCOPE OF WORK. THE CONTRACTOR BIDDING THE JOB IS NEVERTHELESS CAUTIONED THAT MINOR OMISSIONS OR ERRORS IN THE DRAWINGS AND OR SPECIFICATIONS SHALL NOT EXCUSE SAID CONTRACTOR FROM COMPLETING THE PROJECT AND IMPROVEMENTS IN ACCORDANCE WITH THE INTENT OF THESE DOCUMENTS.
- 3. THE CONTRACTOR OR BIDDER SHALL BEAR THE RESPONSIBILITY OF NOTIFYING (IN WRITING) THE CLIENT'S REPRESENTATIVE OF ANY CONFLICTS, ERRORS, OR OMISSIONS PRIOR TO THE SUBMISSION OF CONTRACTOR'S PROPOSAL OR PERFORMANCE OF WORK.
- 5. THE CONTRACTOR SHALL VISIT THE JOB SITE PRIOR TO THE SUBMISSION OF BIDS OR PERFORMING WORK TO FAMILIARIZE HIMSELF WITH THE FIELD CONDITIONS AND TO VERIFY THAT THE PROJECT CAN BE CONSTRUCTED IN ACCORDANCE WITH THE CONSTRUCTION DOCUMENTS.
- 6. THE CONTRACTOR SHALL INSTALL ALL EQUIPMENT AND MATERIALS ACCORDING TO THE MANUFACTURER'S / VENDOR'S SPECIFICATIONS UNLESS NOTED OTHERWISE OR WHERE LOCAL CODES OR ORDINANCES TAKE PRECEDENCE.
- 7. THE CONTRACTOR SHALL MAKE NECESSARY PROVISIONS TO PROTECT EXISTING IMPROVEMENTS DURING CONSTRUCTION.
- 8. THE CONTRACTOR SHALL COMPLY WITH ALL PERTINENT SECTIONS OF THE BASIC STATE BUILDING CODE, LATEST EDITION, AND ALL OSHA REQUIREMENTS AS THEY APPLY TO THIS PROJEC
- 9. THE CONTRACTOR SHALL NOTIFY THE CLIENT'S REPRESENTATIVE IN WRITING WHERE A CONFLICT OCCURS ON ANY OF THE CONTRACT DOCUMENTS. THE CONTRACTOR IS NOT TO ORDER MATERIAL OR CONSTRUCT ANY PORTION OF THE WORK THAT IS IN CONFLICT UNTIL CONFLICT IS RESOLVED BY THE CLIENT'S REPRESENTATIVE.
- 10. THE WORK SHALL CONFORM TO THE CODES AND STANDARDS OF THE FOLLOWING AGENCIES AS FURTHER CITED HEREIN:
- A. ASTM: AMERICAN SOCIETY FOR TESTING AND MATERIALS, AS PUBLISHED IN "COMPILATION OF ASTM STANDARDS BUILDING CODES" OR LATEST EDITION.
- B. AWS: AMERICAN WELDING SOCIETY INC. AS PUBLISHED IN "STANDARD D1.1-08, STRUCTURAL WELDING CODE" OR LATEST EDITION.
- C. AISC: AMERICAN INSTITUTE FOR STEEL CONSTRUCTION AS PUBLISHED IN "CODE FOR STANDARD PRACTICE FOR STEEL BUILDINGS AND BRIDGES"; "SPECIFICATIONS FOR THE DESIGN, FABRICATION AND ERECTION OF STRUCTURAL STEEL FOR BUILDINGS" (LATEST EDITION).
- 11. BOLTING:
- A. BOLTS SHALL BE CONFORMING TO ASTM A325 HIGH STRENGTH, HOT DIP GALVANIZED WITH ASTM A153 HEAVY HEX TYPE NUTS.
- B. BOLTS SHALL BE 3/4"Ø MINIMUM (UNLESS OTHERWISE NOTED)
- C. ALL CONNECTIONS SHALL BE 2 BOLTS MINIMUM.
- 12. FABRICATION:
- A. FABRICATION OF STEEL SHALL CONFORM TO THE AISC AND AWS STANDARDS AND CODES (LATEST EDITION).
- B. ALL STRUCTURAL STEEL SHALL BE HOT-DIP GALVANIZED AFTER FABRICATION IN ACCORDANCE WITH ASTM A123 (LATEST EDITION), UNLESS OTHERWISE NOTED.
- 13. ERECTION OF STEEL:
- A. PROVIDE ALL ERECTION EQUIPMENT, BRACING, PLANKING, FIELD BOLTS, NUTS, WASHERS, DRIFT PINS, AND SIMILAR MATERIALS WHICH DO NOT FORM A PART OF THE COMPLETED CONSTRUCTION BUT ARE NECESSARY FOR ITS PROPER ERECTION.
- B. ERECT AND ANCHOR ALL STRUCTURAL STEEL IN ACCORDANCE WITH AISC REFERENCE STANDARDS. ALL WORK SHALL BE ACCURATELY SET TO ESTABLISHED LINES AND ELEVATIONS AND RIGIDLY FASTENED IN PLACE WITH SUITABLE ATTACHMENTS TO THE CONSTRUCTION OF THE BUILDING.
- C. TEMPORARY BRACING, GUYING AND SUPPORT SHALL BE PROVIDED TO KEEP THE STRUCTURE SAFE AND ALIGNED AT ALL TIMES DURING CONSTRUCTION, AND TO PREVENT DANGER TO PERSONS AND PROPERTY. CHECK ALL TEMPORARY LOADS AND STAY WITHIN SAFE CAPACITY OF ALL BUILDING COMPONENTS.
- 14. ANTENNA INSTALLATION
- A. INSTALL ANTENNAS AS INDICATED ON DRAWINGS AND CLIENT'S REPRESENTATIVE SPECIFICATIONS.
- B. INSTALL GALVANIZED STEEL ANTENNA MOUNTS AS INDICATED ON DRAWINGS.

- C. INSTALL COAXIAL / FIBER CABLES AND TERMINATIONS BETWEEN ANTENNAS AND EQUIPMENT PER MANUFACTURER'S RECOMMENDATIONS. WEATHERPROOF ALL CONNECTORS BETWEEN THE ANTENNA AND EQUIPMENT PER MANUFACTURER'S REQUIREMENTS.
- 15. ANTENNA AND COAXIAL / FIBER CABLE GROUNDING:
- A. ALL EXTERIOR #6 GREEN GROUND WIRE "DAISY CHAIN" CONNECTIONS ARE TO BE WEATHER SEALED WITH ANDREWS CONNECTOR/SPLICE WEATHERPROOFING KIT TYPE #221213 OR EQUAL.
- B. ALL COAXIAL / FIBER CABLE GROUNDING KITS ARE TO BE INSTALLED ON STRAIGHT RUNS OF COAXIAL / FIBER CABLE (NOT WITHIN BENDS).
- 16. RELATED WORK, FURNISH THE FOLLOWING WORK AS SPECIFIED UNDER CONSTRUCTION DOCUMENTS, BUT COORDINATE WITH OTHER TRADES PRIOR TO BID:
- A. FLASHING OF OPENING INTO OUTSIDE WALLS
- B. SEALING AND CAULKING ALL OPENINGS
- C. PAINTING
- D. CUTTING AND PATCHING
- 17. REQUIREMENTS OF REGULATORY AGENCIES:
- A. FURNISH U.L. LISTED EQUIPMENT WHERE SUCH LABEL IS AVAILABLE. INSTALL IN CONFORMANCE WITH U.L. STANDARDS WHERE APPLICABLE.
- B. INSTALL ANTENNA, ANTENNA CABLES, GROUNDING SYSTEM IN ACCORDANCE WITH DRAWINGS AND SPECIFICATION IN EFFECT AT PROJECT LOCATION AND RECOMMENDATIONS OF STATE AND LOCAL BUILDING CODES, AND SPECIAL CODES HAVING JURISDICTION OVER SPECIFIC PORTIONS OF WORK. THIS WORK INCLUDES BUT IS NOT LIMITED TO THE FOLLOWING:
- C. TIA-EIA 222 (LATEST EDITION). STRUCTURAL STANDARDS FOR STEEL ANTENNA TOWERS AND ANTENNA SUPPORTING STRUCTURES.
- D. FAA FEDERAL AVIATION ADMINISTRATION ADVISORY CIRCULAR AC 70/7460-IH, OBSTRUCTION MARKING AND LIGHTING.
- E. FCC FEDERAL COMMUNICATIONS COMMISSION RULES AND REGULATIONS FORM 715, OBSTRUCTION MARKING AND LIGHTING SPECIFICATION FOR ANTENNA STRUCTURES AND FORM 715A, HIGH INTENSITY OBSTRUCTION LIGHTING SPECIFICATIONS FOR ANTENNA STRUCTURES.
- F. AISC AMERICAN INSTITUTE OF STEEL CONSTRUCTION SPECIFICATION FOR STRUCTURAL JOINTS USING ASTM A325 BOLTS (LATEST EDITION).
- G. NEC NATIONAL ELECTRICAL CODE ON TOWER LIGHTING KITS.
- I. UL UNDERWRITER'S LABORATORIES APPROVED ELECTRICAL PRODUCTS.
- I. IN ALL CASES, PART 77 OF THE FAA RULES AND PARTS 17 AND 22 OF THE FCC RULES ARE APPLICABLE AND IN THE EVENT OF CONFLICT, SUPERSEDE ANY OTHER STANDARDS OR SPECIFICATIONS.
- J. 2018 LIFE SAFETY CODE NFPA 101.

APPLICANT:

# T - Mobile - T-Mobile - T-Mobile NORTHEAST LLC

35 GRIFFIN ROAD SOUTH BLOOMFIELD, CT 06002 860-692-7100

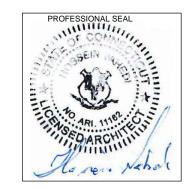


203-275-6669

**CONSULTANT:** 



462 WALNUT STREET NEWTON, MA 02460 617-212-3123




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1	REVISED	08/13/21

SITE NUMBER: CTHA241C SITE NAME: HA241 / EXXON SIGN SITE ADDRESS: 207 WEST STREET CROMWELL, CT 06416
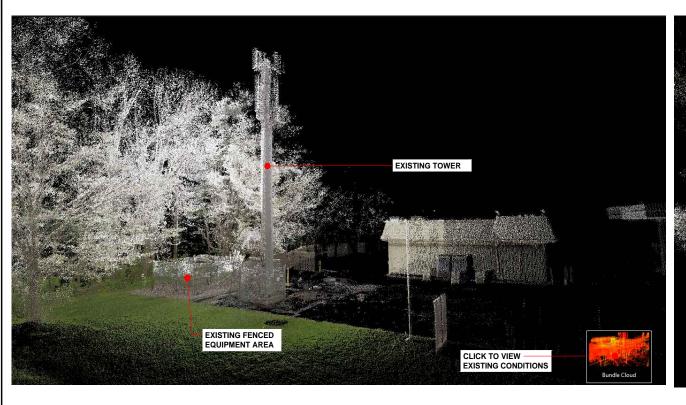
> SHEET TITLE: N-1: GENERAL NOTES









SITE POINT CLOUD N.T.S.



APPLICANT:

# T - • Mobile • T-MOBILE NORTHEAST LLC

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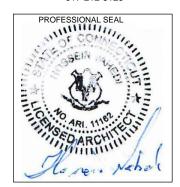


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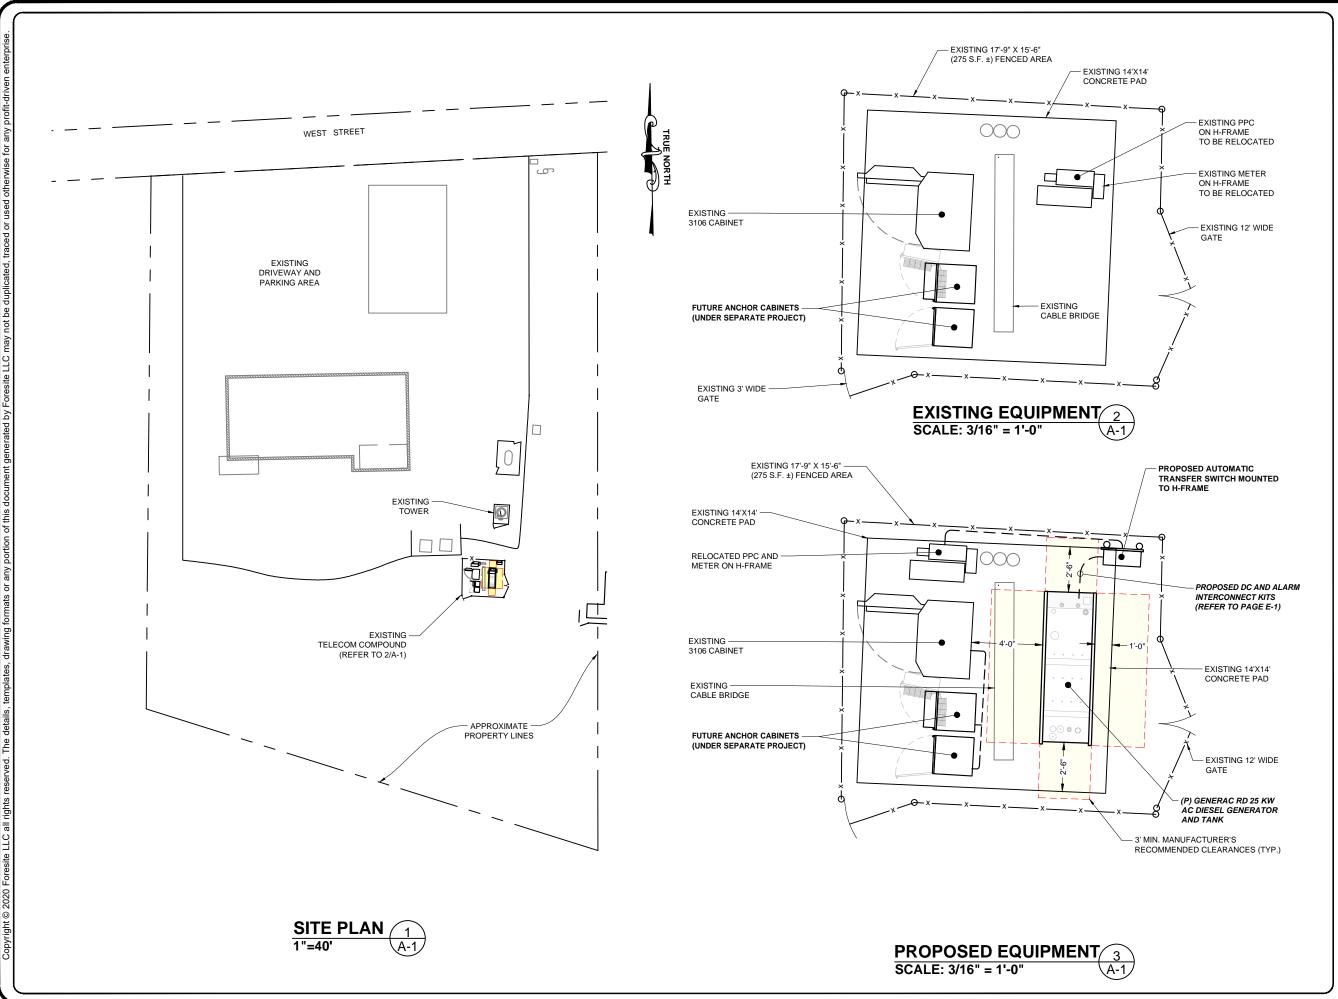
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> SHEET TITLE: A-1: SITE PLAN



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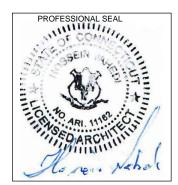
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### CONSULTANT:



Architects . Engineers . Survey

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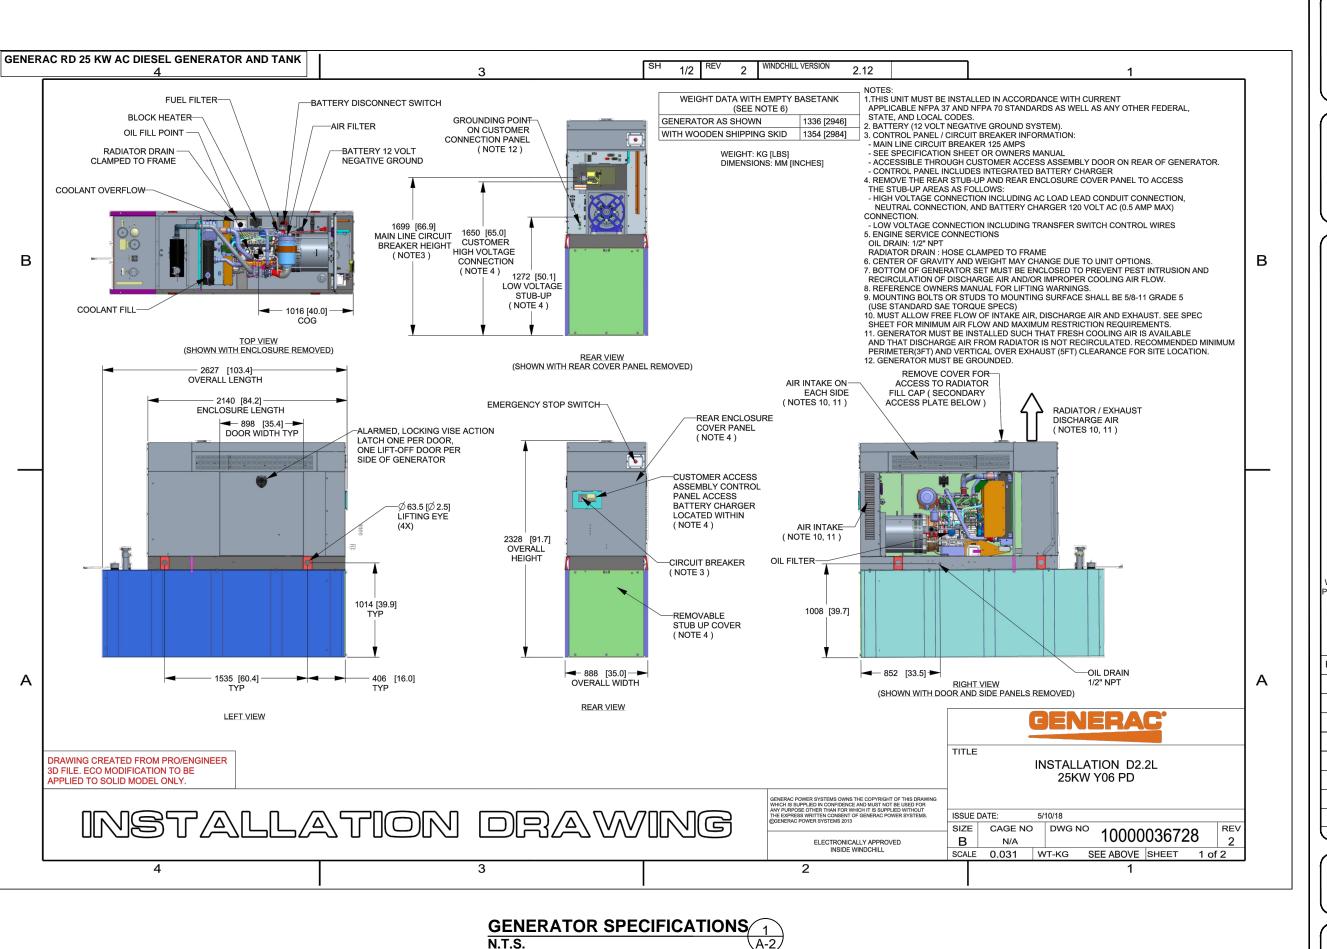


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> SHEET TITLE: A-1: SITE PLAN



APPLICANT:

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# PROJECT MANAGER (((4))) NORTHEAST SITE SOLUTIONS Turnbay Wirden Development


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**CONSULTANT:** 



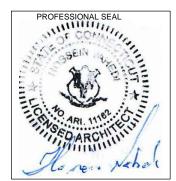Architects . Engineers . Surveyor:

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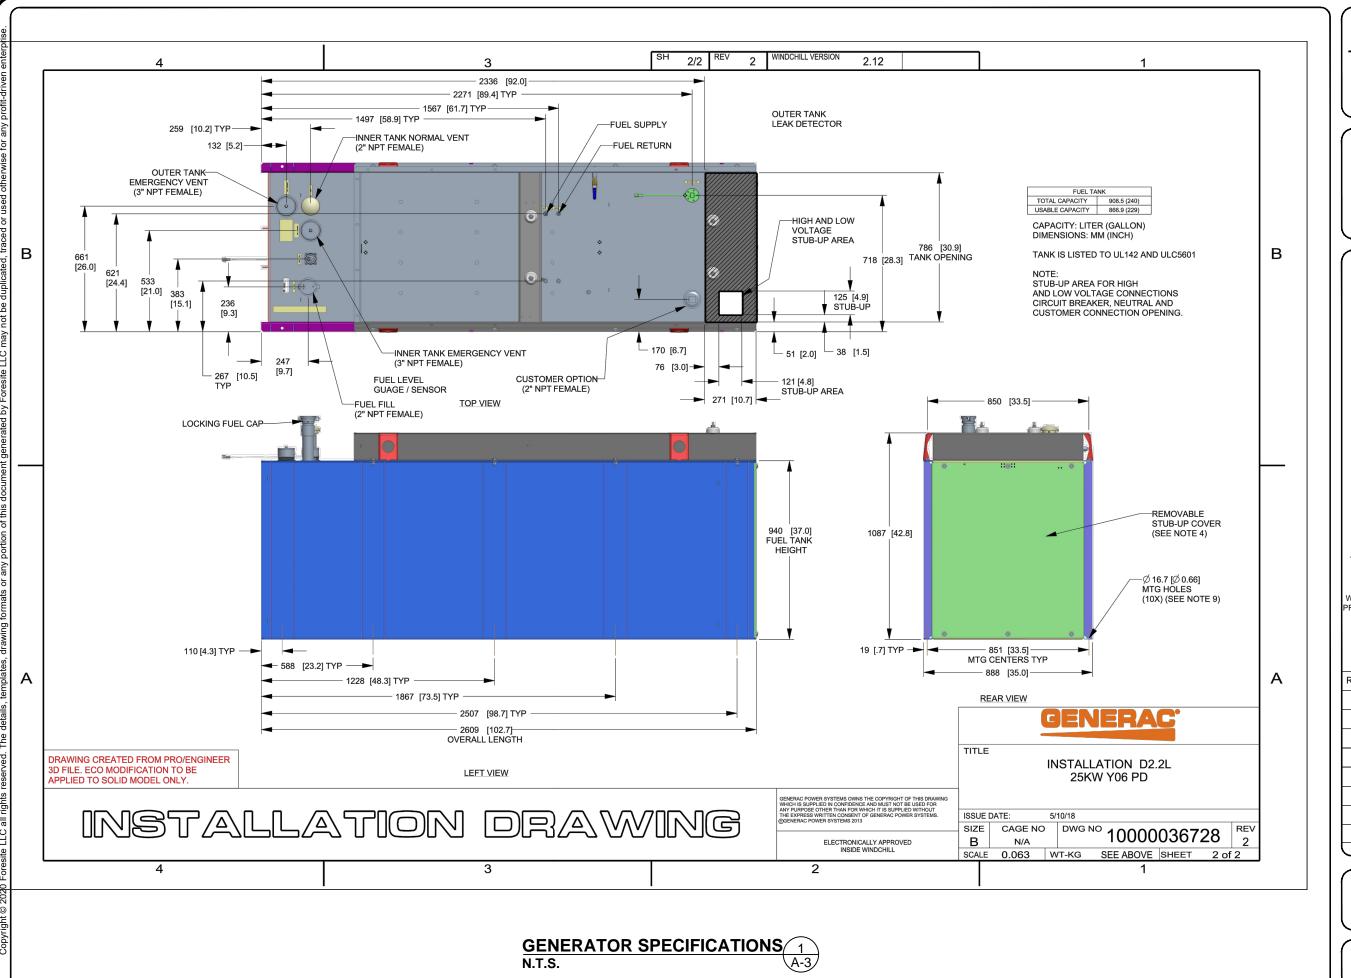
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SHEET TITLE:
A-2: GENERATOR SPECIFICATIONS



# APPLICANT: T • • Mobile • T-MOBILE NORTHEAST LLC

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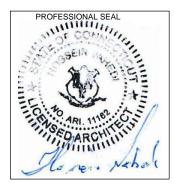
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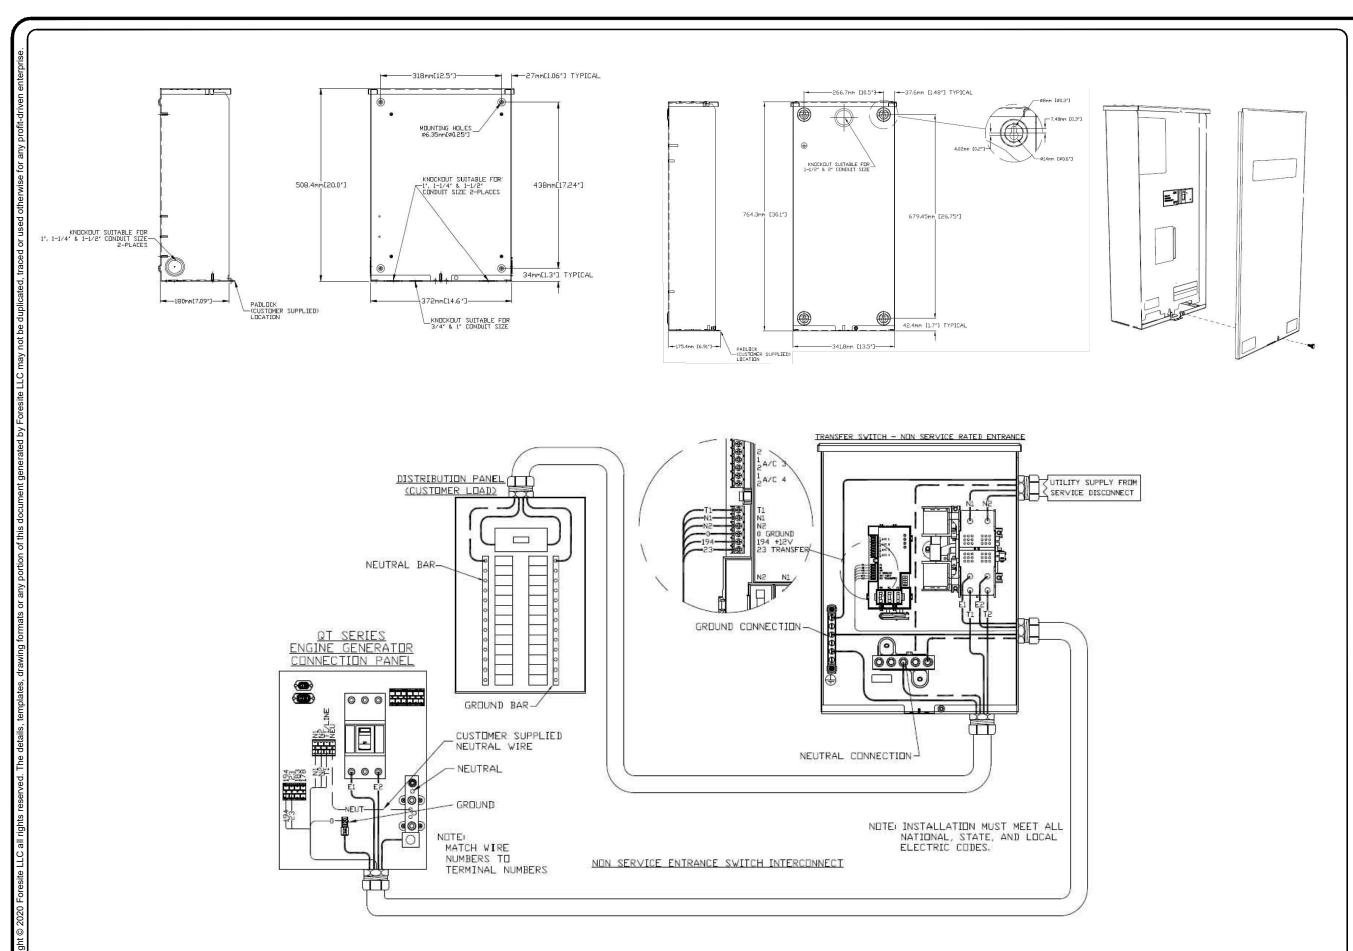


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SHEET TITLE:
A-3: GENERATOR SPECIFICATIONS



**AUTOMATIC TRANSFER SWITCH DETAILS** 

SCALE: N.T.S.

APPLICANT:

- Mobile

T-MOBILE NORTHEAST LLC

35 GRIFFIN ROAD SOUTH BLOOMFIELD, CT 06002 860-692-7100

PROJECT MANAGER

(((+)))

NORTHEAST
SITE SOLUTIONS
Turnley Wireless Development

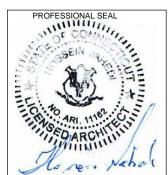
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**CONSULTANT:** 



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SHEET TITLE:

A-4: AUTOMATIC TRANSFER SWITCH DETAILS AND SPECIFICATIONS

### **GENERAL ELECTRICAL NOTES**

1. ALL ELECTRICAL WORK SHALL CONFORM TO THE REQUIREMENTS OF THE NATIONAL ELECTRICAL CODE (NEC) AS WELL AS APPLICABLE STATE AND LOCAL CODES INCLUDING LATEST EDITIONS OF:

NFPA - NATIONAL FIRE PROTECTION ASSOCIATION UL - UNDERWRITERS LABORATORIES NEC - 2017 NATIONAL ELECTRICAL CODE NEMA - NATIONAL ELECTRIC MANUFACTURERS ASSOCIATION OSHA - OCCUPATIONAL SAFETY AND HEALTH ACT IBC - 2015 INTERNATIONAL BUILDING CODE

- 2. ALL ELECTRICAL ITEMS SHALL BE U.L. APPROVED OR LISTED AND PRODUCED PER SPECIFICATION REQUIREMENTS.
- 3. THE ELECTRICAL WORK INCLUDES ALL LABOR AND MATERIAL DESCRIBED BY DRAWINGS AND SPECIFICATION INCLUDING INCIDENTAL WORK TO PROVIDE COMPLETE OPERATING AND APPROVED ELECTRICAL SYSTEM.
- 4. GENERAL CONTRACTOR SHALL PAY FEES FOR PERMITS, AND RESPONSIBLE FOR OBTAINING SAID PERMITS AND COORDINATION OF INSPECTIONS.
- 5. ELECTRICAL AND TELCO WIRING OUTSIDE A BUILDING AND EXPOSED TO WEATHER SHALL BE IN WATER TIGHT GALVANIZED RIGID STEEL CONDUITS OR SCHEDULE 80 PVC (AS PERMITTED BY CODE) ND WHERE REQUIRED IN LIQUID TIGHT FLEXIBLE METAL OR NONMETALLIC CONDUITS.
- 6. RIGID STEEL CONDUITS SHALL BE GROUNDED AT BOTH ENDS.
- 7. ELECTRICAL WIRING SHALL BE COPPER WITH TYPE XHHW, THWN, OR THIN INSULATION.
- 8. ALL EQUIPMENT LOCATED OUTSIDE SHALL HAVE NAME 3R ENCLOSURE.
- 9. GROUNDING SHALL COMPLY WITH NEC ART. 250.
- 10. GROUNDING COAX CABLE SHIELDS MINIMUM AT BOTH ENDS USING MANUFACTURES COAX CABLE GROUNDING KITS SUPPLIED BY PROJECT OWNER.
- 11. USE #6 COPPER STRANDED WIRE WITH GREEN COLOR INSTALLATION FOR ABOVE GRADE GROUNDING (UNLESS OTHERWISE SPECIFIED) AND #2 SOLID TINNED BARE COPPER WIRE FOR BELOW GRADE GROUNDING AS INDICATED ON THE GROUND
- 12. ALL GROUND CONNECTION TO BE BURNDY HYGROUND COMPRESSION TYPE CONNECTORS OR CADWELD EXOTHERMIC WELD. DO NOT ALLOW BARE COPPER WIRE TO BE IN CONTACT WITH GALVANIZED STEEL.
- 13. ROUTE GROUNDING CONDUCTORS ALONG THE SHORTEST AND STRAIGHTEST PATH POSSIBLE, EXCEPT AS OTHERWISE INDICATED. GROUNDING LEADS SHOULD NEVER BE BENT AS RIGHT ANGLE. ALWAYS MAKE AT LEAST 12" RADIUS BENDS. #6 WIRE CAN BE BENT AT 6" RADIUS WHEN NECESSARY BOND ANY METER OBJECTS WITHIN 7 FEET OF PROPOSED EQUIPMENT OR CABINET TO MASTER GROUND BAR.
- 14. CONNECTIONS TO MGB SHALL BE ARRANGED IN THREE MAIN GROUPS: SURGE PROCEDURES (COAXIAL CABLE GROUND KITS, TELCO AND POWER PANEL GROUND); (GROUNDING ELECTRODE RING OR BUILDING STEEL); NON-SURGING OBJECTS (EGB GROUND IN RBS UNIT).
- 15. CONNECTIONS TO GROUND BARS SHALL BE MADE WITH TWO HOLE COMPRESSION TYPE COPPER LUGS. APPLY OXIDE INHIBITING COMPOUND TO ALL LOCATIONS.
- 16. APPLY OXIDE INHIBITING COMPOUND TO ALL COMPRESSION TYPE GROUND CONNECTION.
- 17. TEST COMPLETED GROUND SYSTEM AND RECORD RESULTS FOR PROJECT CLOSE-OUT DOCUMENTATION.
- 18. BOND ANY METAL OBJECTS WITHIN 7 FEET OF PROPOSED EQUIPMENT OR CABINET TO MASTER GROUND BAR.
- 19. VERIFY PROPOSED SERVICE UPGRADE WITH LOCAL UTILITY COMPANY PRIOR TO CONSTRUCTION.
- 20. EXISTING UNDERGROUND UTILITY LOCATIONS ARE UNKNOWN. GENERAL CONTRACTOR SHALL HAND-EXCAVATE TO REQUIRED SUB-GRADE DEPTH, SUFFICIENT TEST HOLES OR AS DIRECTED / REQUIRED BY CONSTRUCTION MANAGER. ALL PROPOSED UNDERGROUND UTILITY TRENCHES SHALL BE HAND-EXCAVATE AS REQUIRED. GENERAL CONTRACTOR IS RESPONSIBLE FOR ANY REQUIRED SPECIAL TEMPORARY PROTECTION OF, PHYSICAL DAMAGE TO, OR REPAIR OF EXISTING UNDERGROUND CONDUIT INCLUDING RESTORATION OF SERVICE.
- 21. PROVIDE SLIP JOINS WHERE CONDUITS TRANSITION FROM UNDERGROUND TO ABOVE GROUND.

### NOTES:

DIAGRAM AS SHOWN, IS A GENERIC ROUTING SCHEMATIC BASED ON AVAILABLE INFORMATION AND MAY NOT REPRESENT ACTUAL FIELD CONDITIONS. CONTRACTOR SHOULD INSTALL THE GENERATOR, EQUIPMENT AND CONNECTIONS BASED ON VERIFIED ELECTRICAL AUDITS AND PER MANUFACTURER'S INSTALLATION GUIDELINES AS WELL AS ALL APPLICABLE LOCAL AND NATIONAL CODES AND REQUIREMENTS.

#### **GROUNDING NOTES:**

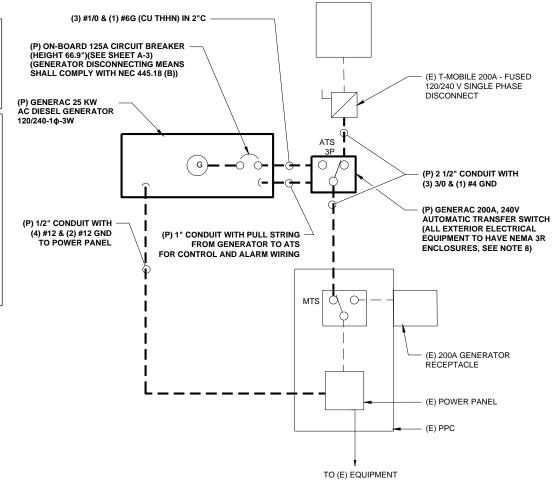
1. GROUNDING SHALL COMPLY WITH NEC ART. 250 AND MANUFACTURER'S RECOMMENDATIONS. TIE INTO THE EXISTING GROUNDING SYSTEM.

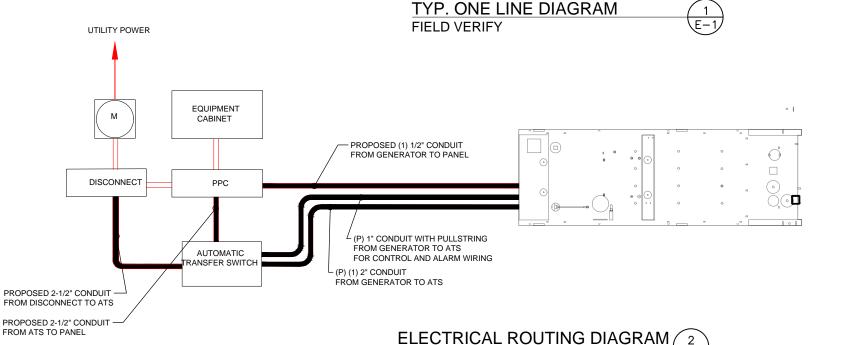
2. CONTRACTOR SHALL INSTALL GROUND RODS ON ALL UNDERGROUND GROUNDING RUNS LONGER THAN 10'. GROUND RODS WILL BE INSTALLED ON 20' CENTERS MAXIMUM.

3. ALL DOWN CONDUCTORS MUST GO DOWN PER NFPA 780.

4. CONTRACTOR SHALL NOTIFY THE CONSTRUCTION MANAGER WHEN THE GROUNDING SYSTEM IS COMPLETE. THE CONSTRUCTION MANAGER SHALL INSPECT THE GROUNDING SYSTEM PRIOR TO BACKFILLING.

5. CONTRACTOR MY USE EXISTING CONDUITS AND CONDUCTORS PROVIDED THEY ARE IN GOOD CONDITION AND ARE SUFFICIENTLY RATED.





SCALE: N.T.S

### APPLICANT:

# T - Mobile - T-Mobile - T-Mobile NORTHEAST LLC

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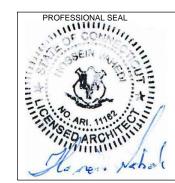
420 MAIN STREET, BLDG 4 STURBRIDGE, MA 01566 203-275-6669

### **CONSULTANT:**



Architects . Engineers . Surveyors

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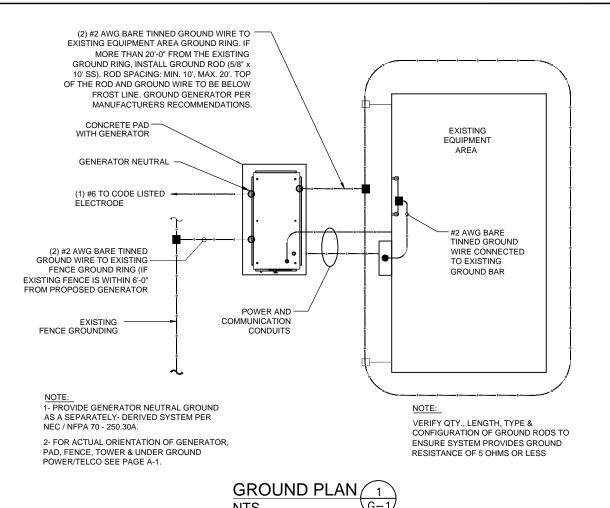
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SHEET TITLE:

E-1: ELECTRICAL DETAILS






## NOTES:

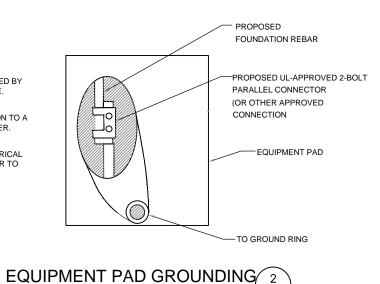- 1. CONNECTION SHALL BE COVERED BY NO LESS THAN 2" OF CONCRETE.
- 2. ATTEMPT TO MAKE CONNECTION TO A 6'-0" RUN OF REBAR OR GREATER.
- 3. APPLY HEAT SHRINK OR ELECTRICAL TAPE AROUND THE CONDUCTOR TO AVOID CORROSION.

NTS



PROPOSED SILICONE PROPOSED LIQUID TIGHT FLEXIBLE NON-METALLIC CONDUIT. NON-METALLIC CONDUIT

NOTE:

CONTRACTOR TO USE CLEAR OR GRAY SILICONE AS NECESSARY TO SEAL LIQUID

PROPOSED #2 SOLID

TINNED COPPER WIRE

GROUND WIRE WEATHERPROOFING 3

SITE NUMBER: CTHA241C SITE NAME: HA241 / EXXON SIGN SITE ADDRESS: 207 WEST STREET CROMWELL, CT 06416

APPLICANT: T - Mobile-

T-MOBILE NORTHEAST LLC

35 GRIFFIN ROAD SOUTH

BLOOMFIELD, CT 06002

860-692-7100

PROJECT MANAGER

STURBRIDGE, MA 01566 203-275-6669

CONSULTANT:

462 WALNUT STREET

NEWTON, MA 02460 617-212-3123

PROFESSIONAL SEAL

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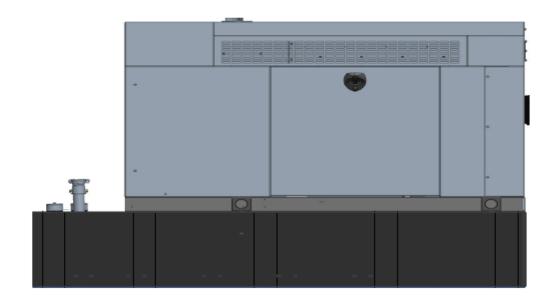
G-1: GROUNDING DETAILS

# Exhibit D

# T··Mobile· Engineering & Operations

# **Generac RD025 Design Document**

Diesel, AC, 25kW External Fill Tank Model#7192-0 SKU#33651



The following are responsible for this project document:

Kevin Smith SR. Engineer (770) 256-3594

Project Design Spec Revision	1.0	Last Date:08/23/2018	5/14/2018
Final doc URL (~Dnnnnn):			
Location	Use the InfoRouter Search (Advanced) putting the Document ID (nnnnnn without the D) to find the location of the master document.		
Template URL:	http://docs.eng.t-mobile.com/InfoRouter/docs/~D423750 Slightly updated 1/2011		



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Rev. 1.0 5/14/2018



# 1 Introduction / Project Summary

# 1.1 Purpose of Project

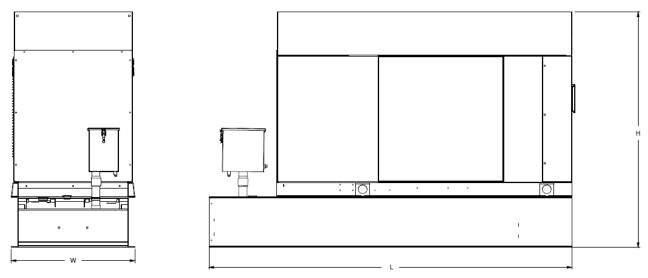
T-Mobile's nationwide cell site hardening plan is providing a refuellable backup power system capable of powering a site for a minimum of 48 hours before refueling is required. The purpose of this project is to give T-Mobile customers reliable service during power outages and provide a sufficient layer of coverage. This design document is for Generac's RD025 model#7192-0, which is a Diesel AC generator with a capacity of 25kW.

# 1.2 Feature Description

The Generac RD025 is a 25kW AC, diesel generator is one of the generators selected as part of the T-Mobile RFP in support of the nationwide cell site hardening plan. The RD025 has a Level 2 acoustic enclosure, 3 phase sensing, and +-0.25% digital voltage regulation. It is equipped with RS232, RS485 and canbus remote ports and Evolution control panel. It is also equipped with a automatic transfer switch, the RXSC200A3 (Automatic Transfer Switch) Controls the process of transferring commercial AC power and generator power. The RXSC200A3 is a 200Amp, switch that is programmed to perform engine test runs and also has adjustable engine run time capabilities. For RXSC200A3 Owners Manual and full feature descriptions LINK.

## 1.3 Dimensions

The dimensions of a level 2 Acoustic Enclosure L  $\times$  W  $\times$  H in inches 103.4  $\times$  35  $\times$  91.7. T-Mobile requires a 36-inch radius around the generator that will cover the 18" door swing on the generator.



Weights and Dimensions


U	nit Weight - Ibs	Unit Weight with Skid - lbs	Dimensions (L x W x H) - in
2,	,123	2,161	103.4 x 35.0 x 73.8

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# 2 Fuel Tanks

The RD025 has a 102.7" 240 Gallon Double-Wall UL142 Base tank to provide 98 hours of backup power at full load deployed on site. Below is the Install drawing for the 240-gallon tank for the RD025kW.



# 3 RXSC200A3 ATS/ Controller
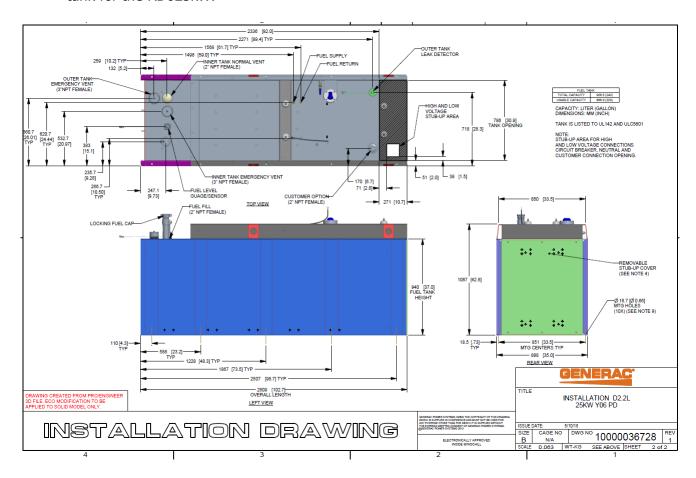
## 3.1 Hardware

The RD025 will come with a RXSC200A3 and an Evollution controller. The sites considered for the RD025 should not have a DC power consumption above 20kW

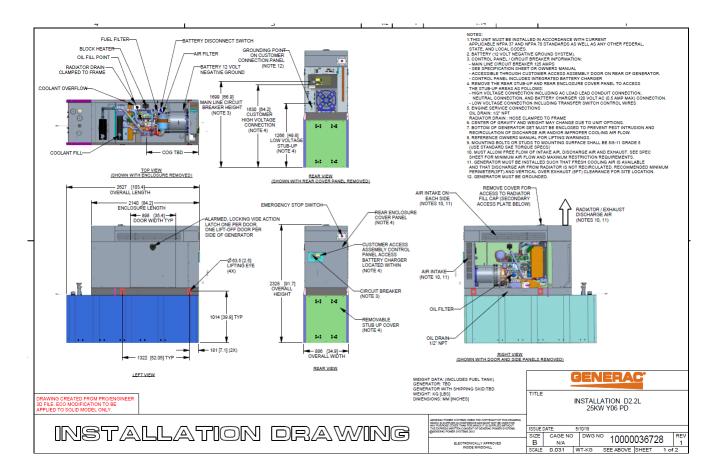


RXSC200A3 Link

RXSC200A3 install drawing Link

Evollution controller spec sheet Link

RD025 installation drawings and supporting documentation Link



## 3.2 RXSC200A3 Automatic Transfer Switch


The RXSC200A3 (Automatic Transfer Switch) is equiped with the following functions. Utility voltage drop-out <65%. Timer to Generator start: 10 second factory set, adjustable between 2-1500 seconds. Engine Warm up delay: 5 seconds. Standby Voltage Sensor: 65% for 5 seconds. Utility Voltage Pickup >80%. Re-Transfer Time Delay: 15 seconds. Engine Cool-Down Timer: 60 seconds. Exerciser: 5 or 12 minute adjustable weekly/by-weekly/monthly. The transfer switch can also be operated manually without power applied


Rev. 1.0 5/14/2018



# **RXSC200A3 Dimensions**

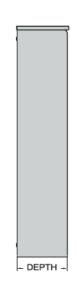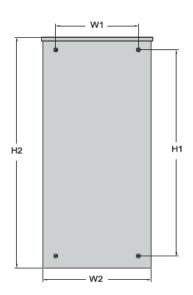Model		RXSC200A3
Height (in./mm)	HI	17.24/437.9
	H2	20/508
Width (in./mm)	WI	12.5/317.5
	W2	14.6/370.8
Depth (in./mm)		7.09/180.1
Weight (lbs./kilos)		20/9.07







# 4 Architecture/Alarms

## 4.1 Interfaces and Alarming

The generator will be monitored by external alarms, conduit and cat five cables have to be installed from the Evolution Controllers Low Voltage Box located in the Generac generator to the appropriate cell site equipment. Nokia FSEB or FSEE and in Ericsson the SAU.

At a Nokia site, this connection is at the FSEB or an FSEE module. For the wiring diagram and instructions for the FSEB click the <u>Link</u>. (The FSEE is the Nokia module that will be replacing the FSEB. For details on the FSEE contact: HQNokiaCellsiteDesigns@T-Moblie.com)

Ericsson sites will connect to the SAU module via OVP Expansion Kit for 8 External Alarms. Product number: UTOVP-ALM8EXP. For the wiring diagram and instructions for this click the link.

The RXSC200A3 has auxiliary contacts that will facilitate the *ATS in Emergency position* alarm and will be a Normally Closed contact. Below is the wiring schematic for this contact and it can be found in the RXSC200A3 owners manual.

# Auxiliary Contact

See *Figure 3-4*. If desired, there is one normally-closed Auxiliary Contact (A) on the transfer switch to operate customer accessories, remote advisory lights, or remote annunciator devices. A suitable power source must be connected to the common terminal. If needed, an extra auxiliary contact can be added.

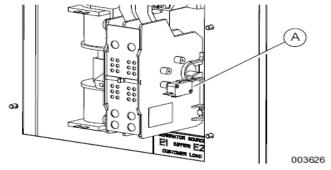


Figure 3-4. Auxiliary Contact

The auxiliary contact is normally closed when the transfer switch is in utility mode. The contacts will open when the transfer switch is in the standby power mode.

**NOTE:** Auxiliary Contact is rated 10 amps at 125 or 250 volts AC, and 0.6 amps at 125 volts DC.

# **▲**CAUTION

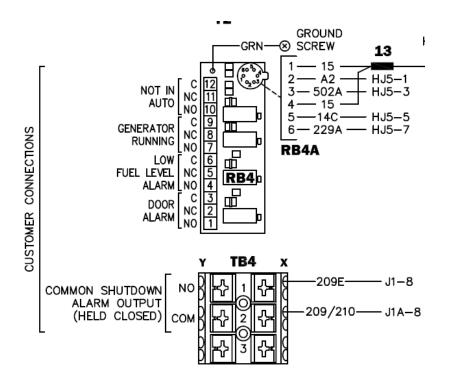
Equipment damage. Exceeding rated voltage and current will damage the auxiliary contacts. Verify that voltage and current are within specification before energizing this equipment. (000134a)

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T-Mobile has four relays available from the Generac controller that are user-defined. T-Mobile can have four-alarm categories and a limitless number of subcategories. T- Mobile will utilize Normally Closed (NC) dry contacts for alarms in Low Voltage Connection box in the spare outputs section. Ericsson cabinets need to be equipped with the alarm expansion kit (UTOVP-ALM8EXP) to handle external alarms.

## **Customer Connections Inside the RD025**



## **Ericsson UTOVP- ALM8EXP**





Evolution Controller Customer		
Connections	Nokia FSEB Alarm Connections 13-24	T-Mobile Standard Alarms
NC#8-Gen Running	NC 4110 grd 4111 pin 13	Generator Running
NC#11-Not In Auto	NC 4110 grd 4111 pin 14	Generator Alarm Critical
NC#2-Door Alarm	NC 4110 grd 4111 pin 15	Generator Alarm NSI
NC#5-Low Fuel	NC 4110 grd 4111 pin 16	Low Fuel
RXSC200A3-Auxiliary Contacts	NC 4110 grd 4111 pin 17	ATS in Emergency Position

Evolution Controller Customer		
Connections	Ericsson Alarm 8expConnections	T-Mobile Standard Alarms
NC#8- Gen. Running	NC - A5	Generator Running
NC#11-Not In Auto	NC - A6	Generator Alarm Critical
NC#2-Door Alarm	NC - A7	Generator Alarm NSI
NC#5-Low Fuel	NC - A8	Low Fuel
RXSC200A3-Auxiliary Contacts	NC - A9	ATS in Emergency Position

# **5** Regulatory Requirements

Level 2 Acoustic Enclosure provides a noise level of 67.5dBA. It is EPA certified and meets NFPA 99 and 110 requirements(NFPA National Fire Protection Association). The RD025 generator engines is a tier 4 engine and meets the EPA final standards.

# **6** Configuration/Diagrams

The physical configuration of the Generator and the RXSC200A3 is, ATS before the PPC to ensure overcurrent protection when commercial power is restored. The RD025 and the RXSC200A3 has to be wired to Commercial AC power.


Rev. 1.0 5/14/2018




# Commercial Power Connection Points On The RXSC200A3

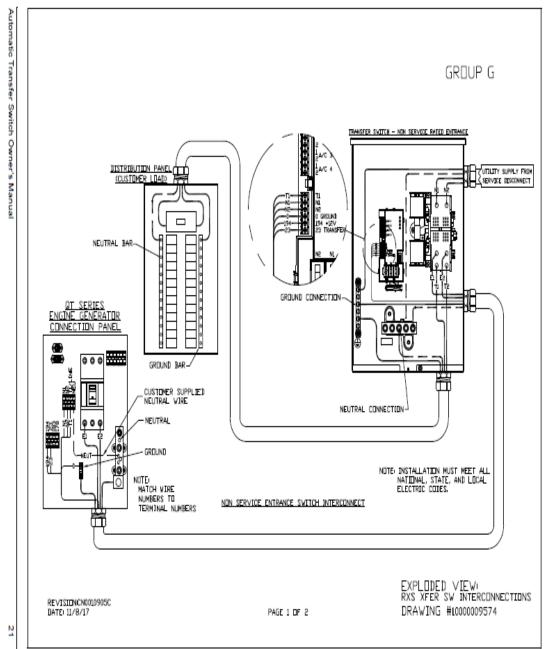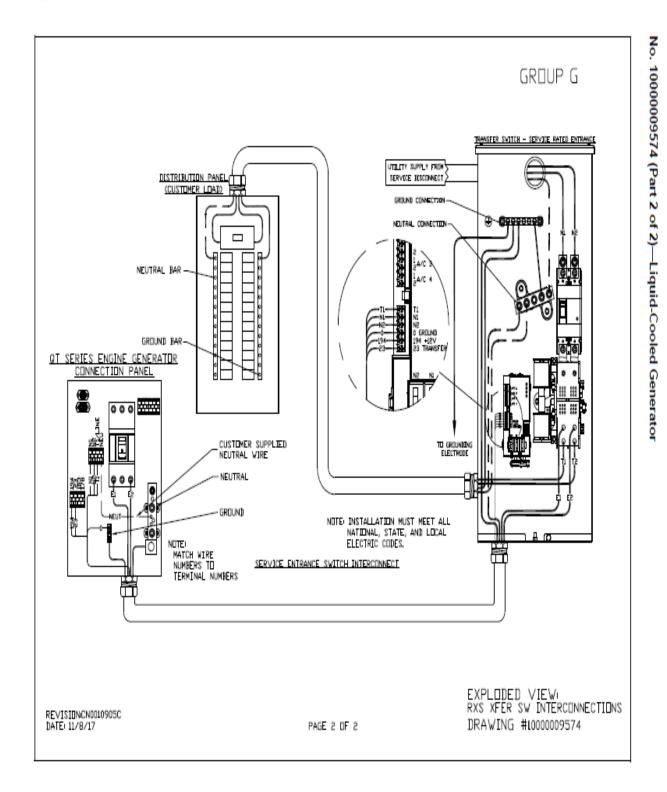Rev. 1.0 5/14/2018












### **Compound Diagram:**

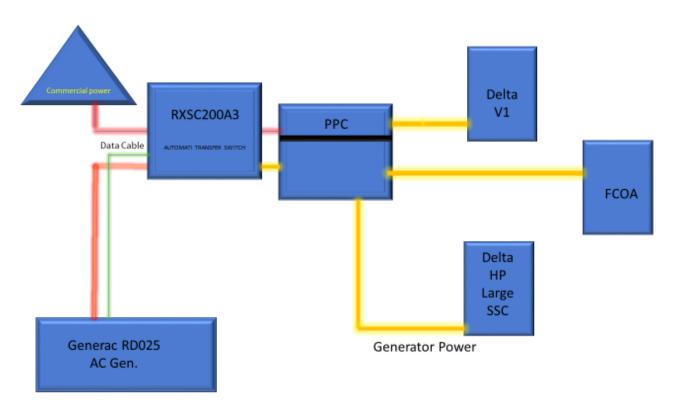

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#### 7 Maintenance

T-Mobile is recommending preventive maintenance to be performed every 250 hours of runtime or every 12 months, whichever comes first.

T-Mobile requires this minimum service checklist for the generator engine:

- Check engine mounts and support. Tighten fasteners.
- Check all the engine hoses and clamps for proper fit, and any signs of cracking and fatigue from wear.
- Inspect all belts for signs of cracking and fatigue from wear and adjust for proper tension.
- Inspect the exhaust system for leaks, burns and wet stacking. Drain exhaust line and tighten any clamps and flange bolts.
- Inspect silencer and plumbing for leaks, cracks or any other signs of wear.
- Inspect the system for fuel, oil and coolant leaks and signs of corrosion.
- Replace water separator.
- Replace water filter/ conditioner.
- Check Anti-Freeze (Spector-Analysis).
- Check coolant level and add, if needed.
- Inspect radiator mounting for signs or wear and cracking.
- Inspect/ clean air filter and change per manufacturer specifications.
- Inspect air intakes and outlets and tighten clamps and brackets, if applicable.

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- Replace fuel filter.
- Inspect the carburetor fuel injection system, fuel injection pump and choke, if equipped.
   Adjust to manufacturers specifications.
- Change engine oil, oil filter and record the date on the filter casing.
- Check engine heater operation, if equipped.
- Check and adjust the battery charger operations, and charge rate within the manufacturer's recommended operating specifications.




- Inspect the battery housing, hardware connections, and cables for corrosion and wear.
- Check the battery electrolyte levels and specific gravity levels.
- Load test generator battery.
- Check, adjust and record generator output voltage, as necessary.
- Check and record the alternator charge rate.
- During inspection run the generator for 30 minutes under load. During this time, and after the
  engine is at full operational speed and has reached engine operating temperature; determine
  and record the condition of all inspection points: oil pressure, water/ coolant temperature,
  Fuel pressure, generator gauge, indicator operations, generator battery.
- Check the engine timing and adjust to manufacturers specifications, if necessary.

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- Inspect, adjust and record governor and frequency, if necessary.
- Verify that the low fuel alarm is operational and configured correctly to trigger when the fuel tank reaches 50% of fuel tank capacity.

Check fuel level and refuel the generator during the preventive/ corrective maintenance visit.

# Exhibit E



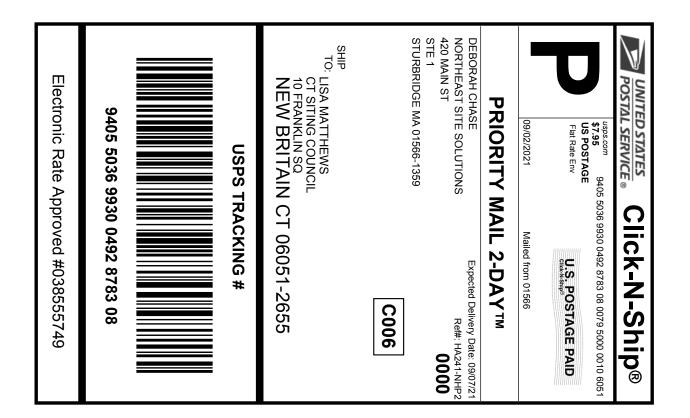

#### Instructions

- 1. Each Click-N-Ship® label is unique. Labels are to be used as printed and used only once. DO NOT PHOTO **COPY OR ALTER LABEL.**
- 2. Place your label so it does not wrap around the edge of the package.
- 3. Adhere your label to the package. A self-adhesive label is recommended. If tape or glue is used, DO NOT TAPE OVER BARCODE. Be sure all edges are secure.
- 4. To mail your package with PC Postage®, you may schedule a Package Pickup online, hand to your letter carrier, take to a Post Office™, or drop in a USPS collection box.
- 5. Mail your package on the "Ship Date" you selected when creating this label.

### Click-N-Ship® Label Record

#### **USPS TRACKING #:** 9405 5036 9930 0492 8783 08

542686276 09/02/2021 Trans. #: Print Date: Ship Date: 09/02/2021 09/07/2021 Delivery Date:

Priority Mail® Postage: Total:

\$7.95 \$7.95

Ref#: HA241-NHP2

From: DEBORAH CHASE

NORTHEAST SITE SOLUTIONS

420 MAIN ST

STE 1

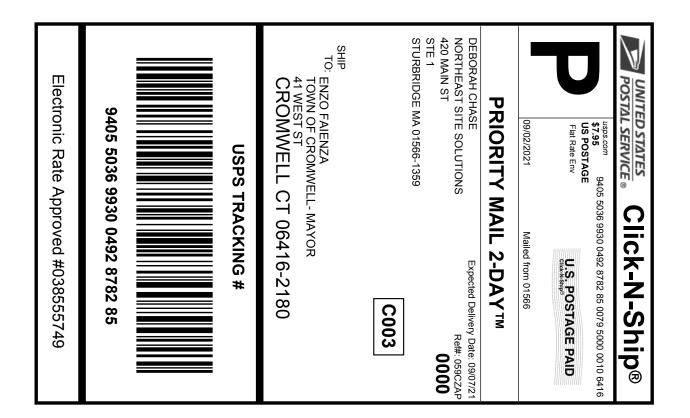
**STURBRIDGE MA 01566-1359** 

LISA MATTHEWS

CT SITING COUNCIL 10 FRANKLIN SQ

NEW BRITAIN CT 06051-2655

# Exhibit F





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- 3. Adhere your label to the package. A self-adhesive label is recommended. If tape or glue is used, DO NOT TAPE OVER BARCODE. Be sure all edges are secure.
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- 5. Mail your package on the "Ship Date" you selected when creating this label.

### Click-N-Ship® Label Record

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542686276 09/02/2021 Trans. #: Print Date: Ship Date: 09/02/2021 09/07/2021 Delivery Date:

Priority Mail® Postage: Total:

\$7.95 \$7.95

Ref#: 059CZAP

From: DEBORAH CHASE

NORTHEAST SITE SOLUTIONS

420 MAIN ST

STE 1

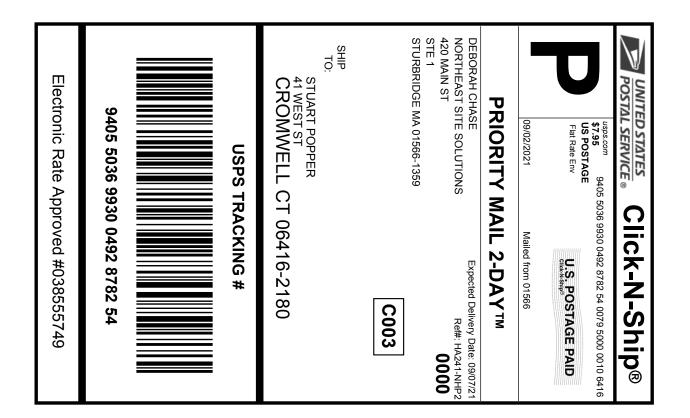
STURBRIDGE MA 01566-1359

**ENZO FAIENZA** 

TOWN OF CROMWELL- MAYOR

41 WEST ST

CROMWELL CT 06416-2180





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- 5. Mail your package on the "Ship Date" you selected when creating this label.

### Click-N-Ship® Label Record

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542686276 09/02/2021 Trans. #: Print Date: Ship Date: 09/02/2021 09/07/2021 Delivery Date:

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Ref#: HA241-NHP2

From: DEBORAH CHASE

NORTHEAST SITE SOLUTIONS

420 MAIN ST


STE 1

STURBRIDGE MA 01566-1359

STUART POPPER

41 WEST ST

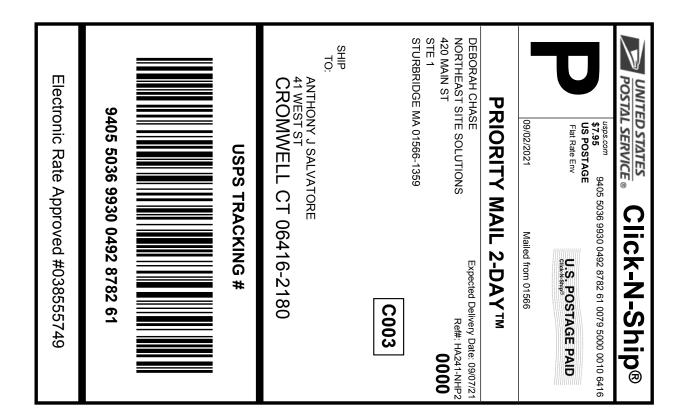CROMWELL CT 06416-2180





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- 3. Adhere your label to the package. A self-adhesive label is recommended. If tape or glue is used, DO NOT TAPE OVER BARCODE. Be sure all edges are secure.
- 4. To mail your package with PC Postage®, you may schedule a Package Pickup online, hand to your letter carrier, take to a Post Office™, or drop in a USPS collection box.
- 5. Mail your package on the "Ship Date" you selected when creating this label.

### Click-N-Ship® Label Record

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Priority Mail® Postage: \$7.95 \$7.95 Total:

From: DEBORAH CHASE Ref#: HA241-NHP2

NORTHEAST SITE SOLUTIONS

420 MAIN ST


STE 1

**STURBRIDGE MA 01566-1359** 

ANTHONY J SALVATORE

41 WEST ST

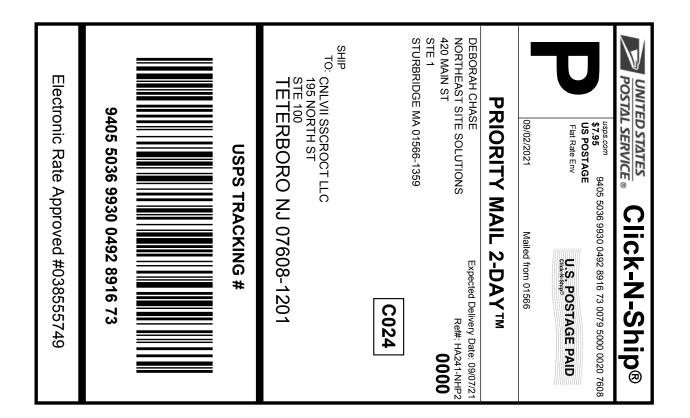CROMWELL CT 06416-2180





#### Instructions

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- 2. Place your label so it does not wrap around the edge of the package.
- 3. Adhere your label to the package. A self-adhesive label is recommended. If tape or glue is used, DO NOT TAPE OVER BARCODE. Be sure all edges are secure.
- 4. To mail your package with PC Postage®, you may schedule a Package Pickup online, hand to your letter carrier, take to a Post Office™, or drop in a USPS collection box.
- 5. Mail your package on the "Ship Date" you selected when creating this label.

### Click-N-Ship® Label Record

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542686611 09/02/2021 Trans. #: Print Date: Ship Date: 09/02/2021 09/07/2021 Delivery Date:

Priority Mail® Postage: \$7.95 \$7.95 Total:

From: DEBORAH CHASE Ref#: HA241-NHP2

NORTHEAST SITE SOLUTIONS

420 MAIN ST

STE 1

**STURBRIDGE MA 01566-1359** 

CNLVII SSCROCT LLC

195 NORTH ST **STE 100** 

TETERBORO NJ 07608-1201

### MODIFICATION OF EXISTING WIRELESS FACILITY BY

# T··Mobile·

### T-MOBILE NORTHEAST LLC

PROJECT TITLE: NATIONAL HARDENING

SITE NUMBER: CTHA241C SITE NAME: HA241 / EXXON SIGN SITE ADDRESS: 207 WEST STREET CROMWELL, CT 06416

\_OCATION

#### **PROJECT NOTES:**

- . THIS IS AN UNMANNED TELECOMMUNICATION FACILITY AND NOT FOR HUMAN HABITATION: HANDICAPPED ACCESS IS NOT REQUIRED.
- POTABLE WATER OR SANITARY SERVICE IS NOT REQUIRED. NO OUTDOOR STORAGE OR ANY SOLID WASTE RECEPTACLES REQUIRED.
- 2. CONTRACTOR SHALL VERIFY ALL PLANS, EXISTING DIMENSIONS, AND CONDITIONS ON THE JOB SITE. CONTRACTOR SHALL IMMEDIATELY NOTIFY THE ARCHITECT/ENGINEER IN WRITING OF ANY DISCREPANCIES BEFORE PROCEEDING WITH THE WORK. FAILURE TO NOTIFY THE ARCHITECT/ENGINEER PLACES THE RESPONSIBILITY ON THE CONTRACTOR TO CORRECT THE DISCREPANCIES AT THE CONTRACTOR'S EXPENSE.
- DEVELOPMENT AND USE OF THE SITE WILL CONFORM TO ALL APPLICABLE CODES, ORDINANCES AND SPECIFICATIONS.

#### **CODE COMPLIANCE:**

ALL WORK SHALL COMPLY WITH THE CURRENT NATIONAL AND CONNECTICUT STATE BUILDING AND LIFE SAFETY CODES, SUPPLEMENTS AND AMENDMENTS INCLUDING BUT NOT LIMITED TO THE LATEST EDITION OF:

CONNECTICUT STATE BUILDING CODE (CSBC).

ANSI/TIA-222-G STRUCTURAL STANDARD FOR ANTENNA SUPPORTING

NATIONAL ELECTRICAL CODE (NEC) FOR POWER AND GROUNDING

OCCUPATIONAL SAFETY AND HEALTH ACT (OSHA).

NFPA - NATIONAL FIRE PROTECTION ASSOCIATION Connecticut - Call Before You Dig

more than 30 days in advance

SITE MAP:

#### **APPROVALS:**

FSA CM	DATE	
RF ENGINEER	DATE	
FOPS	DATE	
T-MOBILE ENGINEERING AND DEVELOPMENT	DATE	

DATE

DATE



OCATION

THE PROPOSED PROJECT SCOPE WILL CONSIST OF INSTALLING A NEW GENERAC RD 25 KW AC DIESEL GENERATOR AND TANK FOR AN EXISTING TELECOM BASE STATION. NO SIGNIFICANT GRADING IS REQUIRED. ALL WORK IS CONTAINED WITHIN THE EXISTING T-MOBILE FENCED EQUIPMENT

#### **PROJECT INFORMATION:**

ADDRESS:

207 WEST STREET CROMWELL, CT 06416

PARCEL ID: 00422500

ZONING DISTRICT

COORDINATES: 41° 36' 07.94" N, 72° 40' 45.61" W

AVERAGE GROUND ELEV .: 23'± (AMSL)

#### **PROJECT TEAM:**

APPLICANT:

T-MOBILE NORTHEAST, LLC. 35 GRIFFIN ROAD SOUTH BLOOMFIELD, CT 06002

PROPERTY OWNER: TA CROMWELL LLC TA NEW MILFORD LLC

PO BOX 6500 CARLISLE, PA 17013

NORTHEAST SITE SOLUTIONS 420 MAIN STREET, BLDG 4 PROJECT MANAGER

STURBRIDGE, MA 01566 SHELDON FREINCLE

SHELDON@NORTHEASTSITESOLUTIONS COM

201-776-8521

ENGINEERING CONSULTANTS: FORESITE LLC 462 WALNUT ST

**NEWTON, MA 02460** SAEED MOSSAVAT

SMOSSAVAT@FORESITELLC.COM

617-212-3123

#### **SHEET INDEX:**

TITLE SHEET GENERAL NOTES SITE POINT CLOUD

SITE PLAN GENERATOR SPECIFICATIONS A-2:

GENERATOR SPECIFICATIONS A-3:

AUTOMATIC TRANSFER SWITCH SPECIFICATIONS

ELECTRICAL DETAILS

GROUNDING DETAILS

APPLICANT: T - Mobile T-MOBILE NORTHEAST LLC

> 35 GRIFFIN ROAD SOUTH BLOOMFIELD, CT 06002 860-692-7100

# PROJECT MANAGER

STURBRIDGE MA 01566

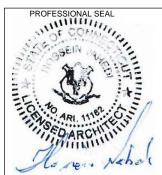
203-275-6669

**CONSULTANT:** 



462 WALNUT STREET

NEWTON, MA 02460 617-212-3123



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DATE

KEV	DESCRIPTION	DATE
Α	PRELIMINARY	05/22/21
0	FINAL ISSUED	05/25/21
1	REVISED	08/13/21
$\subseteq$		

DESCRIPTION

SITE NUMBER: CTHA241C SITE NAME: HA241 / EXXON SIGN SITE ADDRESS: 207 WEST STREET CROMWELL, CT 06416

SHEET TITLE:

T-1: TITLE SHEET

- 1. THE CONTRACTOR SHALL GIVE ALL NOTICES AND COMPLY WITH ALL LAWS, ORDINANCES, RULES, REGULATIONS AND LAWFUL ORDERS OF ANY PUBLIC AUTHORITY, MUNICIPAL AND UTILITY COMPANY SPECIFICATIONS, AND LOCAL AND STATE JURISDICTIONAL CODES BEARING ON THE PERFORMANCE OF THE WORK. THE WORK PERFORMED ON THE PROJECT AND THE MATERIALS INSTALLED SHALL BE IN STRICT ACCORDANCE WITH ALL APPLICABLE CODES, REGULATIONS, AND ORDINANCES.
- 2. THE ARCHITECT/ENGINEER HAS MADE EVERY EFFORT TO SET FORTH IN THE CONSTRUCTION AND CONTRACT DOCUMENTS THE COMPLETE SCOPE OF WORK. THE CONTRACTOR BIDDING THE JOB IS NEVERTHELESS CAUTIONED THAT MINOR OMISSIONS OR ERRORS IN THE DRAWINGS AND OR SPECIFICATIONS SHALL NOT EXCUSE SAID CONTRACTOR FROM COMPLETING THE PROJECT AND IMPROVEMENTS IN ACCORDANCE WITH THE INTENT OF THESE DOCUMENTS.
- 3. THE CONTRACTOR OR BIDDER SHALL BEAR THE RESPONSIBILITY OF NOTIFYING (IN WRITING) THE CLIENT'S REPRESENTATIVE OF ANY CONFLICTS, ERRORS, OR OMISSIONS PRIOR TO THE SUBMISSION OF CONTRACTOR'S PROPOSAL OR PERFORMANCE OF WORK.
- 5. THE CONTRACTOR SHALL VISIT THE JOB SITE PRIOR TO THE SUBMISSION OF BIDS OR PERFORMING WORK TO FAMILIARIZE HIMSELF WITH THE FIELD CONDITIONS AND TO VERIFY THAT THE PROJECT CAN BE CONSTRUCTED IN ACCORDANCE WITH THE CONSTRUCTION DOCUMENTS.
- 6. THE CONTRACTOR SHALL INSTALL ALL EQUIPMENT AND MATERIALS ACCORDING TO THE MANUFACTURER'S / VENDOR'S SPECIFICATIONS UNLESS NOTED OTHERWISE OR WHERE LOCAL CODES OR ORDINANCES TAKE PRECEDENCE.
- 7. THE CONTRACTOR SHALL MAKE NECESSARY PROVISIONS TO PROTECT EXISTING IMPROVEMENTS DURING CONSTRUCTION.
- 8. THE CONTRACTOR SHALL COMPLY WITH ALL PERTINENT SECTIONS OF THE BASIC STATE BUILDING CODE, LATEST EDITION, AND ALL OSHA REQUIREMENTS AS THEY APPLY TO THIS PROJEC
- 9. THE CONTRACTOR SHALL NOTIFY THE CLIENT'S REPRESENTATIVE IN WRITING WHERE A CONFLICT OCCURS ON ANY OF THE CONTRACT DOCUMENTS. THE CONTRACTOR IS NOT TO ORDER MATERIAL OR CONSTRUCT ANY PORTION OF THE WORK THAT IS IN CONFLICT UNTIL CONFLICT IS RESOLVED BY THE CLIENT'S REPRESENTATIVE.
- 10. THE WORK SHALL CONFORM TO THE CODES AND STANDARDS OF THE FOLLOWING AGENCIES AS FURTHER CITED HEREIN:
- A. ASTM: AMERICAN SOCIETY FOR TESTING AND MATERIALS, AS PUBLISHED IN "COMPILATION OF ASTM STANDARDS BUILDING CODES" OR LATEST EDITION.
- B. AWS: AMERICAN WELDING SOCIETY INC. AS PUBLISHED IN "STANDARD D1.1-08, STRUCTURAL WELDING CODE" OR LATEST EDITION.
- C. AISC: AMERICAN INSTITUTE FOR STEEL CONSTRUCTION AS PUBLISHED IN "CODE FOR STANDARD PRACTICE FOR STEEL BUILDINGS AND BRIDGES"; "SPECIFICATIONS FOR THE DESIGN, FABRICATION AND ERECTION OF STRUCTURAL STEEL FOR BUILDINGS" (LATEST EDITION).
- 11. BOLTING:
- A. BOLTS SHALL BE CONFORMING TO ASTM A325 HIGH STRENGTH, HOT DIP GALVANIZED WITH ASTM A153 HEAVY HEX TYPE NUTS.
- B. BOLTS SHALL BE 3/4"Ø MINIMUM (UNLESS OTHERWISE NOTED)
- C. ALL CONNECTIONS SHALL BE 2 BOLTS MINIMUM.
- 12. FABRICATION:
- A. FABRICATION OF STEEL SHALL CONFORM TO THE AISC AND AWS STANDARDS AND CODES (LATEST EDITION).
- B. ALL STRUCTURAL STEEL SHALL BE HOT-DIP GALVANIZED AFTER FABRICATION IN ACCORDANCE WITH ASTM A123 (LATEST EDITION), UNLESS OTHERWISE NOTED.
- 13. ERECTION OF STEEL:
- A. PROVIDE ALL ERECTION EQUIPMENT, BRACING, PLANKING, FIELD BOLTS, NUTS, WASHERS, DRIFT PINS, AND SIMILAR MATERIALS WHICH DO NOT FORM A PART OF THE COMPLETED CONSTRUCTION BUT ARE NECESSARY FOR ITS PROPER ERECTION.
- B. ERECT AND ANCHOR ALL STRUCTURAL STEEL IN ACCORDANCE WITH AISC REFERENCE STANDARDS. ALL WORK SHALL BE ACCURATELY SET TO ESTABLISHED LINES AND ELEVATIONS AND RIGIDLY FASTENED IN PLACE WITH SUITABLE ATTACHMENTS TO THE CONSTRUCTION OF THE BUILDING.
- C. TEMPORARY BRACING, GUYING AND SUPPORT SHALL BE PROVIDED TO KEEP THE STRUCTURE SAFE AND ALIGNED AT ALL TIMES DURING CONSTRUCTION, AND TO PREVENT DANGER TO PERSONS AND PROPERTY. CHECK ALL TEMPORARY LOADS AND STAY WITHIN SAFE CAPACITY OF ALL BUILDING COMPONENTS.
- 14. ANTENNA INSTALLATION
- A. INSTALL ANTENNAS AS INDICATED ON DRAWINGS AND CLIENT'S REPRESENTATIVE SPECIFICATIONS.
- B. INSTALL GALVANIZED STEEL ANTENNA MOUNTS AS INDICATED ON DRAWINGS.

- C. INSTALL COAXIAL / FIBER CABLES AND TERMINATIONS BETWEEN ANTENNAS AND EQUIPMENT PER MANUFACTURER'S RECOMMENDATIONS. WEATHERPROOF ALL CONNECTORS BETWEEN THE ANTENNA AND EQUIPMENT PER MANUFACTURER'S REQUIREMENTS.
- 15. ANTENNA AND COAXIAL / FIBER CABLE GROUNDING:
- A. ALL EXTERIOR #6 GREEN GROUND WIRE "DAISY CHAIN" CONNECTIONS ARE TO BE WEATHER SEALED WITH ANDREWS CONNECTOR/SPLICE WEATHERPROOFING KIT TYPE #221213 OR EQUAL.
- B. ALL COAXIAL / FIBER CABLE GROUNDING KITS ARE TO BE INSTALLED ON STRAIGHT RUNS OF COAXIAL / FIBER CABLE (NOT WITHIN BENDS).
- 16. RELATED WORK, FURNISH THE FOLLOWING WORK AS SPECIFIED UNDER CONSTRUCTION DOCUMENTS, BUT COORDINATE WITH OTHER TRADES PRIOR TO BID:
- A. FLASHING OF OPENING INTO OUTSIDE WALLS
- B. SEALING AND CAULKING ALL OPENINGS
- C PAINTING
- D. CUTTING AND PATCHING
- 17. REQUIREMENTS OF REGULATORY AGENCIES:
- A. FURNISH U.L. LISTED EQUIPMENT WHERE SUCH LABEL IS AVAILABLE. INSTALL IN CONFORMANCE WITH U.L. STANDARDS WHERE APPLICABLE.
- B. INSTALL ANTENNA, ANTENNA CABLES, GROUNDING SYSTEM IN ACCORDANCE WITH DRAWINGS AND SPECIFICATION IN EFFECT AT PROJECT LOCATION AND RECOMMENDATIONS OF STATE AND LOCAL BUILDING CODES, AND SPECIAL CODES HAVING JURISDICTION OVER SPECIFIC PORTIONS OF WORK. THIS WORK INCLUDES BUT IS NOT LIMITED TO THE FOLLOWING:
- C. TIA-EIA 222 (LATEST EDITION). STRUCTURAL STANDARDS FOR STEEL ANTENNA TOWERS AND ANTENNA SUPPORTING STRUCTURES.
- D. FAA FEDERAL AVIATION ADMINISTRATION ADVISORY CIRCULAR AC 70/7460-IH, OBSTRUCTION MARKING AND LIGHTING.
- E. FCC FEDERAL COMMUNICATIONS COMMISSION RULES AND REGULATIONS FORM 715, OBSTRUCTION MARKING AND LIGHTING SPECIFICATION FOR ANTENNA STRUCTURES AND FORM 715A, HIGH INTENSITY OBSTRUCTION LIGHTING SPECIFICATIONS FOR ANTENNA STRUCTURES.
- F. AISC AMERICAN INSTITUTE OF STEEL CONSTRUCTION SPECIFICATION FOR STRUCTURAL JOINTS USING ASTM A325 BOLTS (LATEST EDITION).
- G. NEC NATIONAL ELECTRICAL CODE ON TOWER LIGHTING KITS.
- H. UL UNDERWRITER'S LABORATORIES APPROVED ELECTRICAL PRODUCTS.
- I. IN ALL CASES, PART 77 OF THE FAA RULES AND PARTS 17 AND 22 OF THE FCC RULES ARE APPLICABLE AND IN THE EVENT OF CONFLICT, SUPERSEDE ANY OTHER STANDARDS OR SPECIFICATIONS.
- J. 2018 LIFE SAFETY CODE NFPA 101.

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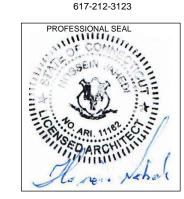


**CONSULTANT:** 

203-275-6669



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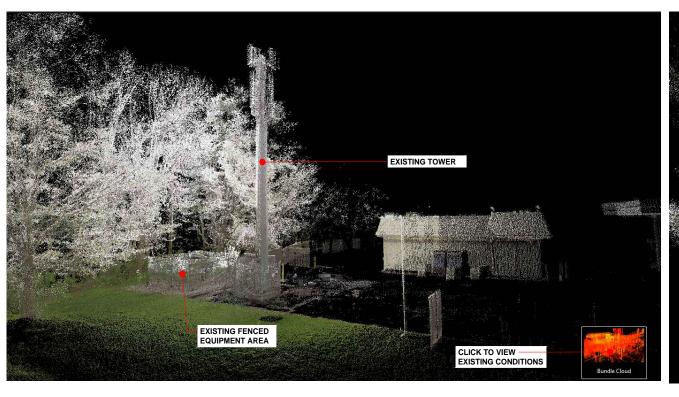


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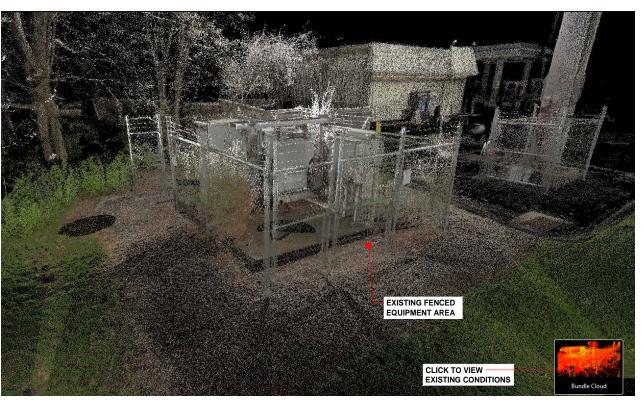
SITE NUMBER: CTHA241C SITE NAME: HA241 / EXXON SIGN SITE ADDRESS: 207 WEST STREET CROMWELL, CT 06416

> SHEET TITLE: N-1: GENERAL NOTES









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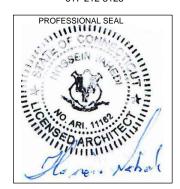


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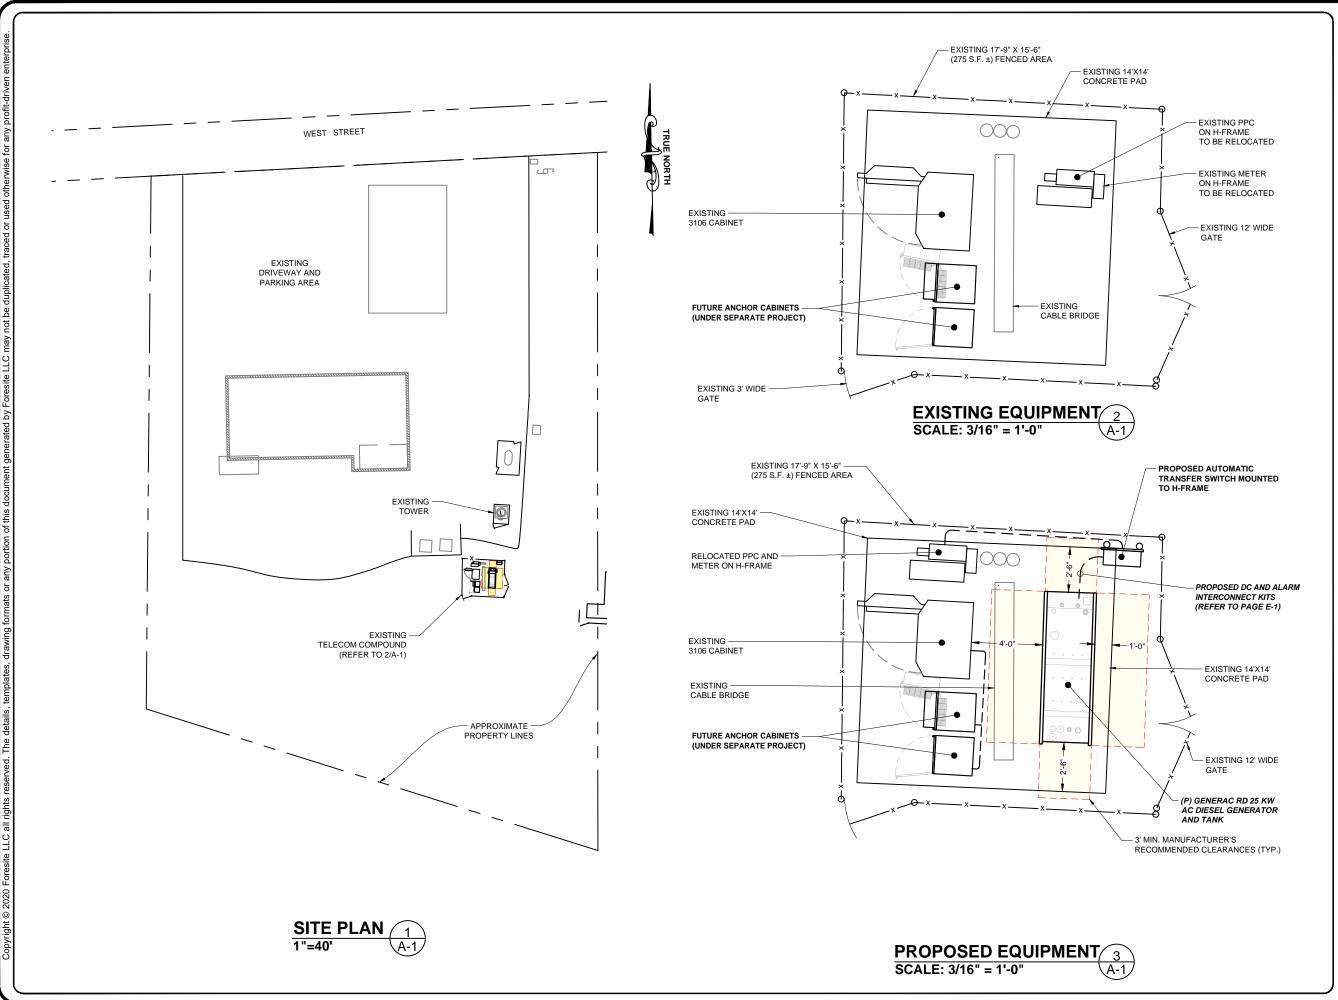
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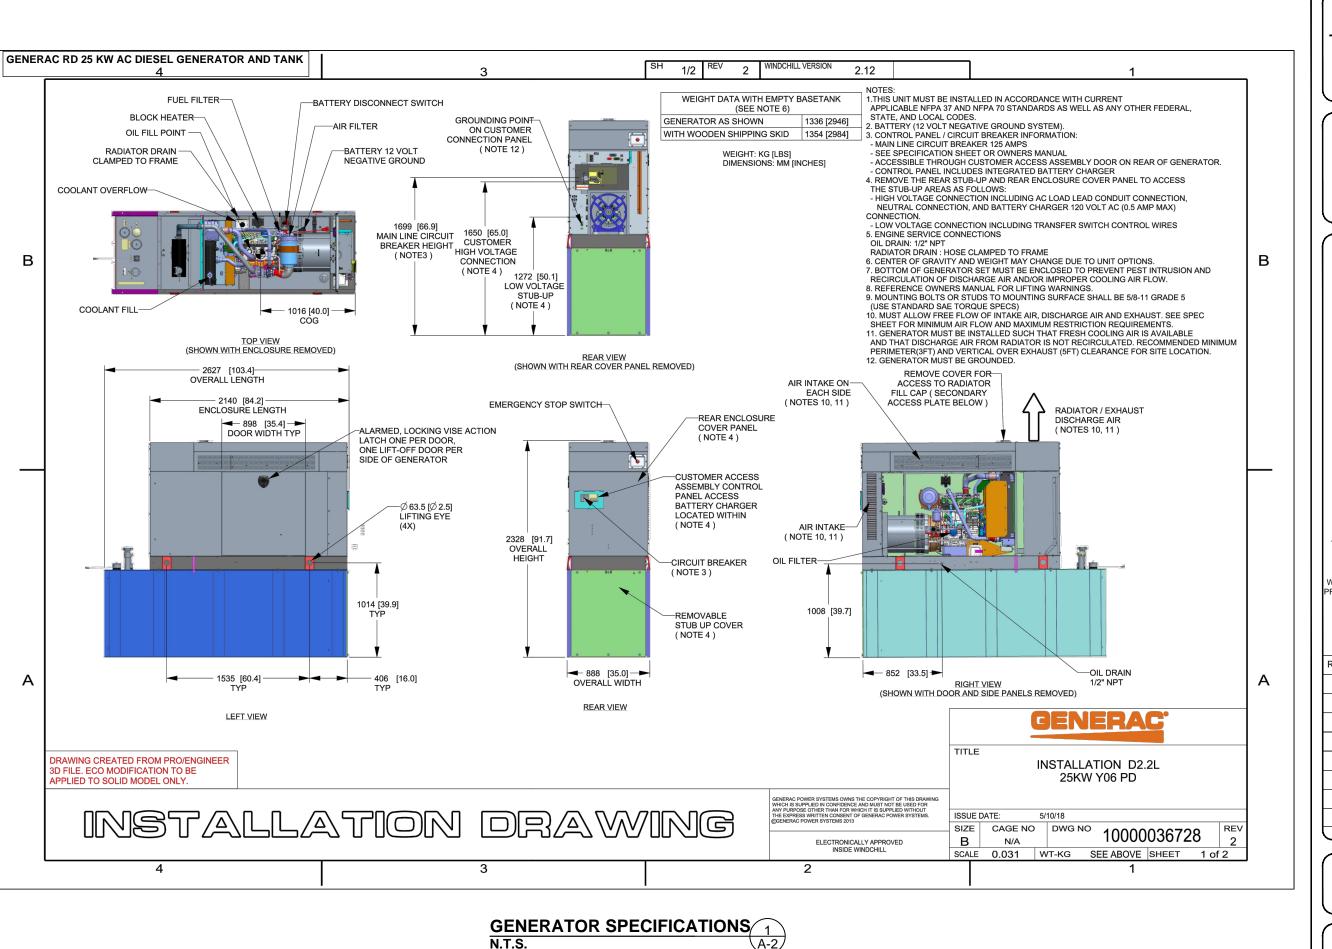


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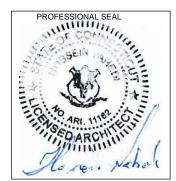
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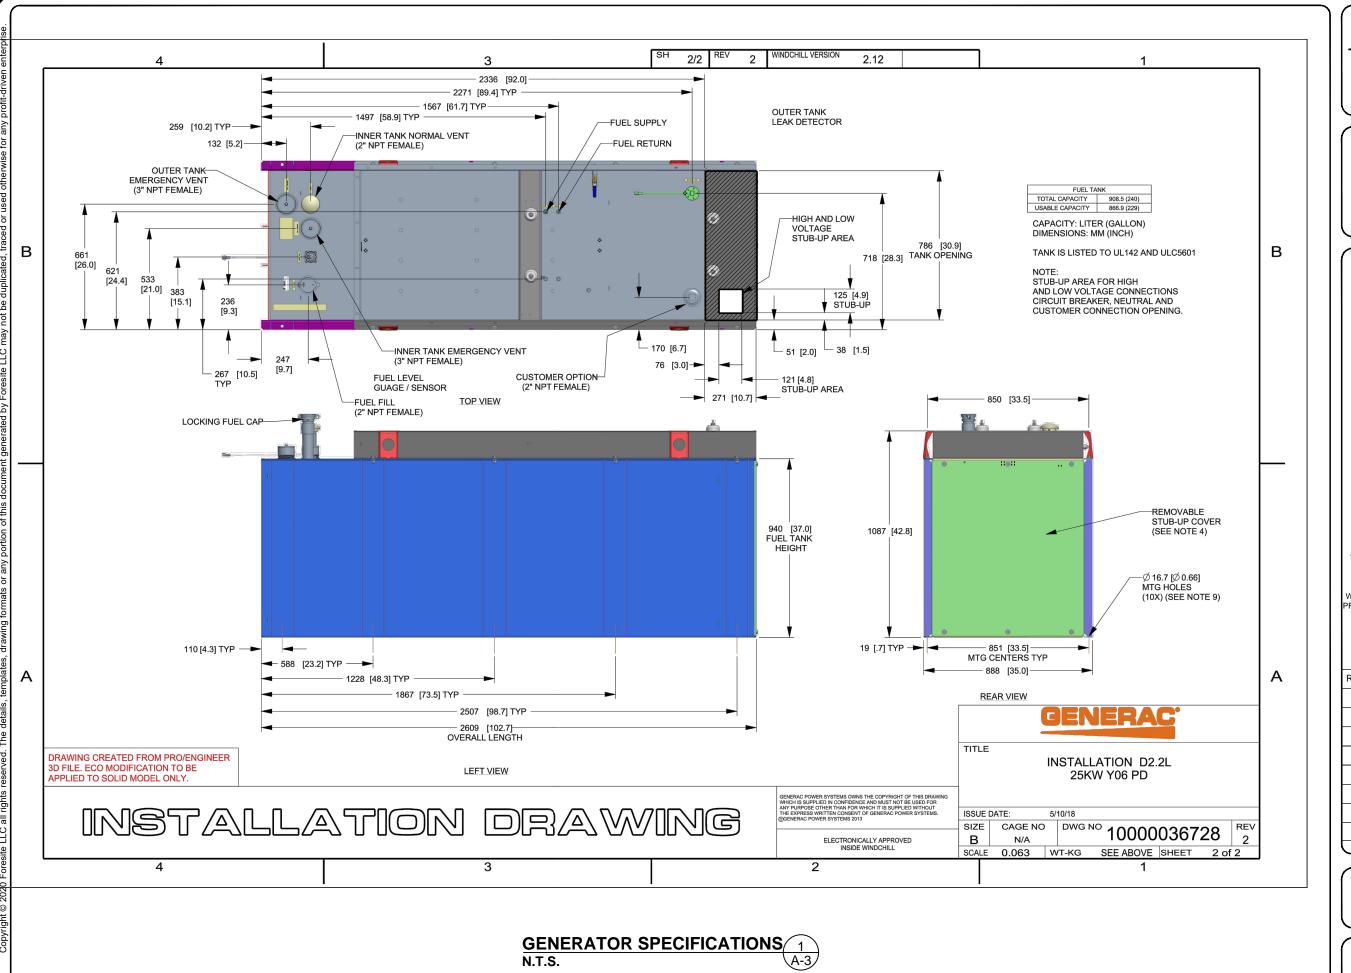


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SHEET TITLE:
A-2: GENERATOR SPECIFICATIONS



# T-MObile T-MOBILE NORTHEAST LLC

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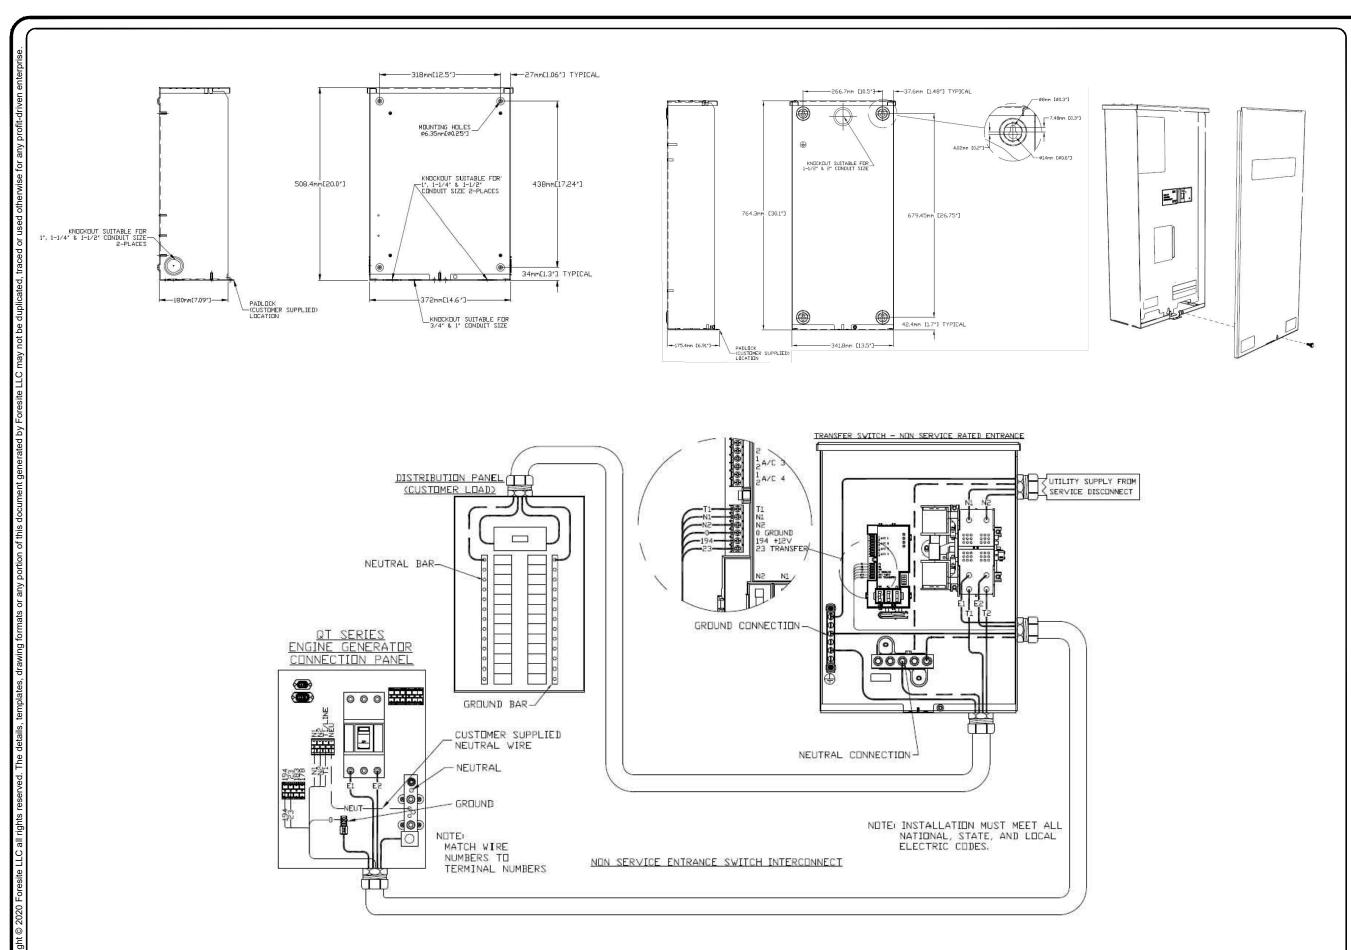


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SHEET TITLE:
A-3: GENERATOR SPECIFICATIONS



**AUTOMATIC TRANSFER SWITCH DETAILS** 

SCALE: N.T.S.

APPLICANT:

- Mobile

T-MOBILE NORTHEAST LLC

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PROJECT MANAGER

(((+))) NORTHEAST SITE SOLUTIONS
Threader Window Development

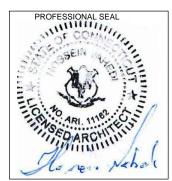
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SHEET TITLE:

A-4: AUTOMATIC TRANSFER SWITCH DETAILS AND SPECIFICATIONS

#### **GENERAL ELECTRICAL NOTES**

1. ALL ELECTRICAL WORK SHALL CONFORM TO THE REQUIREMENTS OF THE NATIONAL ELECTRICAL CODE (NEC) AS WELL AS APPLICABLE STATE AND LOCAL CODES INCLUDING LATEST EDITIONS OF:

NFPA - NATIONAL FIRE PROTECTION ASSOCIATION UL - UNDERWRITERS LABORATORIES NEC - 2017 NATIONAL ELECTRICAL CODE NEMA - NATIONAL ELECTRIC MANUFACTURERS ASSOCIATION OSHA - OCCUPATIONAL SAFETY AND HEALTH ACT IBC - 2015 INTERNATIONAL BUILDING CODE

- 2. ALL ELECTRICAL ITEMS SHALL BE U.L. APPROVED OR LISTED AND PRODUCED PER SPECIFICATION REQUIREMENTS.
- 3. THE ELECTRICAL WORK INCLUDES ALL LABOR AND MATERIAL DESCRIBED BY DRAWINGS AND SPECIFICATION INCLUDING INCIDENTAL WORK TO PROVIDE COMPLETE OPERATING AND APPROVED ELECTRICAL SYSTEM.
- 4. GENERAL CONTRACTOR SHALL PAY FEES FOR PERMITS, AND RESPONSIBLE FOR OBTAINING SAID PERMITS AND COORDINATION OF INSPECTIONS.
- 5. ELECTRICAL AND TELCO WIRING OUTSIDE A BUILDING AND EXPOSED TO WEATHER SHALL BE IN WATER TIGHT GALVANIZED RIGID STEEL CONDUITS OR SCHEDULE 80 PVC (AS PERMITTED BY CODE) ND WHERE REQUIRED IN LIQUID TIGHT FLEXIBLE METAL OR NONMETALLIC CONDUITS.
- 6. RIGID STEEL CONDUITS SHALL BE GROUNDED AT BOTH ENDS.
- 7. ELECTRICAL WIRING SHALL BE COPPER WITH TYPE XHHW, THWN, OR THIN INSULATION.
- 8. ALL EQUIPMENT LOCATED OUTSIDE SHALL HAVE NAME 3R ENCLOSURE.
- 9. GROUNDING SHALL COMPLY WITH NEC ART. 250.
- 10. GROUNDING COAX CABLE SHIELDS MINIMUM AT BOTH ENDS USING MANUFACTURES COAX CABLE GROUNDING KITS SUPPLIED BY PROJECT OWNER.
- 11. USE #6 COPPER STRANDED WIRE WITH GREEN COLOR INSTALLATION FOR ABOVE GRADE GROUNDING (UNLESS OTHERWISE SPECIFIED) AND #2 SOLID TINNED BARE COPPER WIRE FOR BELOW GRADE GROUNDING AS INDICATED ON THE GROUND
- 12. ALL GROUND CONNECTION TO BE BURNDY HYGROUND COMPRESSION TYPE CONNECTORS OR CADWELD EXOTHERMIC WELD. DO NOT ALLOW BARE COPPER WIRE TO BE IN CONTACT WITH GALVANIZED STEEL.
- 13. ROUTE GROUNDING CONDUCTORS ALONG THE SHORTEST AND STRAIGHTEST PATH POSSIBLE, EXCEPT AS OTHERWISE INDICATED. GROUNDING LEADS SHOULD NEVER BE BENT AS RIGHT ANGLE. ALWAYS MAKE AT LEAST 12" RADIUS BENDS. #6 WIRE CAN BE BENT AT 6" RADIUS WHEN NECESSARY BOND ANY METER OBJECTS WITHIN 7 FEET OF PROPOSED EQUIPMENT OR CABINET TO MASTER GROUND BAR.
- 14. CONNECTIONS TO MGB SHALL BE ARRANGED IN THREE MAIN GROUPS: SURGE PROCEDURES (COAXIAL CABLE GROUND KITS, TELCO AND POWER PANEL GROUND); (GROUNDING ELECTRODE RING OR BUILDING STEEL); NON-SURGING OBJECTS (EGB GROUND IN RBS UNIT).
- 15. CONNECTIONS TO GROUND BARS SHALL BE MADE WITH TWO HOLE COMPRESSION TYPE COPPER LUGS. APPLY OXIDE INHIBITING COMPOUND TO ALL LOCATIONS.
- 16. APPLY OXIDE INHIBITING COMPOUND TO ALL COMPRESSION TYPE GROUND CONNECTION.
- 17. TEST COMPLETED GROUND SYSTEM AND RECORD RESULTS FOR PROJECT CLOSE-OUT DOCUMENTATION.
- 18. BOND ANY METAL OBJECTS WITHIN 7 FEET OF PROPOSED EQUIPMENT OR CABINET TO MASTER GROUND BAR.
- 19. VERIFY PROPOSED SERVICE UPGRADE WITH LOCAL UTILITY COMPANY PRIOR TO CONSTRUCTION
- 20. EXISTING UNDERGROUND UTILITY LOCATIONS ARE UNKNOWN. GENERAL CONTRACTOR SHALL HAND-EXCAVATE TO REQUIRED SUB-GRADE DEPTH, SUFFICIENT TEST HOLES OR AS DIRECTED / REQUIRED BY CONSTRUCTION MANAGER. ALL PROPOSED UNDERGROUND UTILITY TRENCHES SHALL BE HAND-EXCAVATE AS REQUIRED. GENERAL CONTRACTOR IS RESPONSIBLE FOR ANY REQUIRED SPECIAL TEMPORARY PROTECTION OF, PHYSICAL DAMAGE TO, OR REPAIR OF EXISTING UNDERGROUND CONDUIT INCLUDING RESTORATION OF SERVICE.
- 21. PROVIDE SLIP JOINS WHERE CONDUITS TRANSITION FROM UNDERGROUND TO ABOVE GROUND.

#### NOTES:

DIAGRAM AS SHOWN, IS A GENERIC ROUTING SCHEMATIC BASED ON AVAILABLE INFORMATION AND MAY NOT REPRESENT ACTUAL FIELD CONDITIONS. CONTRACTOR SHOULD INSTALL THE GENERATOR, EQUIPMENT AND CONNECTIONS BASED ON VERIFIED ELECTRICAL AUDITS AND PER MANUFACTURER'S INSTALLATION GUIDELINES AS WELL AS ALL APPLICABLE LOCAL AND NATIONAL CODES AND REQUIREMENTS.

#### **GROUNDING NOTES:**

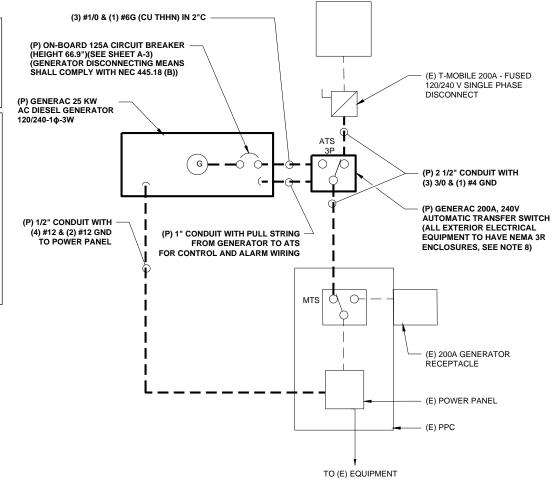
1. GROUNDING SHALL COMPLY WITH NEC ART. 250
AND MANUFACTURER'S RECOMMENDATIONS. TIE INTO THE EXISTING
GROUNDING SYSTEM

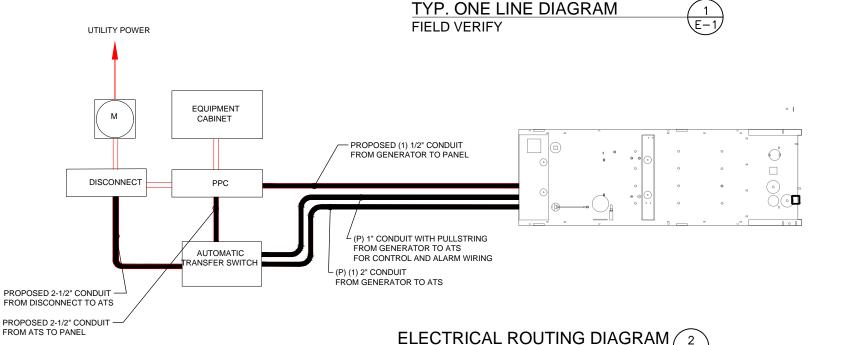
2. CONTRACTOR SHALL INSTALL GROUND RODS ON ALL UNDERGROUND GROUNDING RUNS LONGER THAN 10'. GROUND RODS WILL BE INSTALLED ON 20' CENTERS MAXIMUM.

3. ALL DOWN CONDUCTORS MUST GO DOWN PER NFPA 780.

4. CONTRACTOR SHALL NOTIFY THE CONSTRUCTION MANAGER WHEN THE GROUNDING SYSTEM IS COMPLETE. THE CONSTRUCTION MANAGER SHALL INSPECT THE GROUNDING SYSTEM PRIOR TO BACKFILLING.

5. CONTRACTOR MY USE EXISTING CONDUITS AND CONDUCTORS PROVIDED THEY ARE IN GOOD CONDITION AND ARE SUFFICIENTLY RATED.





SCALE: N.T.S

#### APPLICANT:

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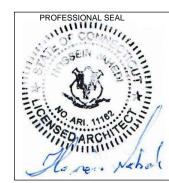
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#### **CONSULTANT:**



Architects , Engineers , Surveyo

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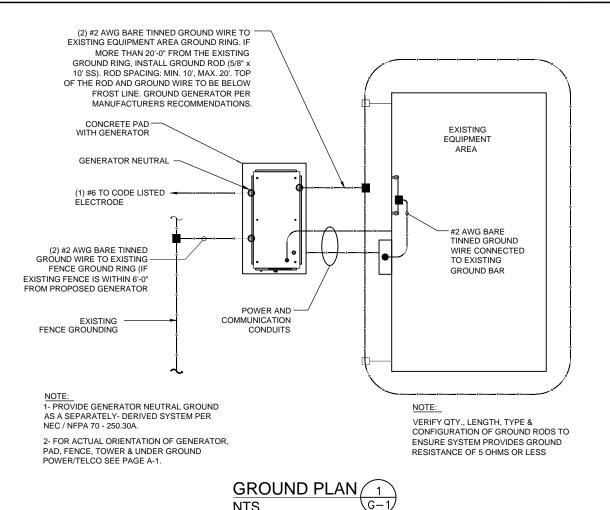
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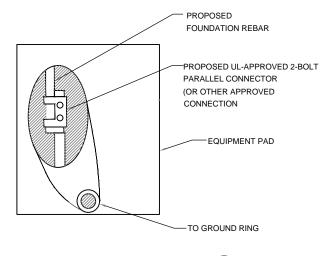
E-1: ELECTRICAL DETAILS





#### NOTES:

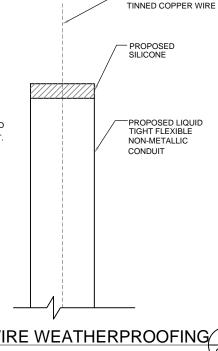
- 1. CONNECTION SHALL BE COVERED BY NO LESS THAN 2" OF CONCRETE.
- 2. ATTEMPT TO MAKE CONNECTION TO A 6'-0" RUN OF REBAR OR GREATER.
- 3. APPLY HEAT SHRINK OR ELECTRICAL TAPE AROUND THE CONDUCTOR TO AVOID CORROSION.



EQUIPMENT PAD GROUNDING 2 NTS

NOTE:

CONTRACTOR TO USE CLEAR OR GRAY SILICONE AS NECESSARY TO SEAL LIQUID TIGHT FLEXIBLE NON-METALLIC CONDUIT.



PROPOSED #2 SOLID

GROUND WIRE WEATHERPROOFING 3

APPLICANT:

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PROJECT MANAGER




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G-1: GROUNDING DETAILS


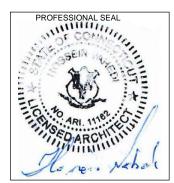
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