



STATE OF CONNECTICUT
CONNECTICUT SITING COUNCIL

Ten Franklin Square, New Britain, CT 06051

Phone: (860) 827-2935 Fax: (860) 827-2950

E-Mail: siting.council@ct.gov

Web Site: portal.ct.gov/csc

VIA ELECTRONIC MAIL

January 27, 2022

David DePinto
Site Acquisition Specialist
Transcend Wireless
10 Industrial Avenue, Suite 3
Mahwah, NJ 07430
ddepinto@transcendwireless.com

RE: EM-T-MOBILE-028-211221 – T-Mobile notice of intent to modify an existing telecommunications facility located at 355 New London Road (a/k/a State Route 85), Connecticut.

Dear Mr. DePinto:

The Connecticut Siting Council (Council) is in receipt of your correspondence of January 26, 2022 submitted in response to the Council's January 25, 2022 notification of an incomplete request for exempt modification with regard to the above-referenced matter.

The submission renders the request for exempt modification complete and the Council will process the request in accordance with the Federal Communications Commission 60-day timeframe.

Thank you for your attention and cooperation.

Sincerely,

Melanie A. Bachman
Executive Director

MAB/FOC/emr



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January 25, 2022

David DePinto
Site Acquisition Agent
Transcend Wireless
10 Industrial Ave Suite 3
Mahwah, NJ 07430
ddepinto@transcendwireless.com

RE: **EM-T-MOBILE-028-211221** - T-Mobile notice of intent to modify an existing telecommunications facility located at 355 New London Road (a/k/a State Route 85), Colchester, Connecticut.

Dear Mr. DePinto:

The Connecticut Siting Council (Council) received a notice of intent to modify the above-referenced facility on December 21, 2021.

According to Section 16-50j-71 of the Regulations of Connecticut State Agencies, "...any modification, as defined in Section 16-50j-2a of the Regulations of Connecticut State Agencies, to an existing tower site, except as specified in Sections 16-50j-72 and 16-50j-88 of the Regulations of Connecticut State Agencies, may have a substantial adverse environmental effect."

Staff has reviewed this exempt modification request for completeness and has identified a deficiency in the submittal. The Construction Drawings (CD) prepared by Colliers Engineering and Design dated October 29, 2021 (Rev 1) and provided with the request does not include a stamp/signature of a Professional Engineer licensed in the State of Connecticut.

Therefore, the exempt modification request is incomplete at this time. The Council recommends that Transcend Wireless provide a CD that is stamped and signed by a Professional Engineer licensed in the State of Connecticut on or before February 25, 2022. If additional time is needed to gather the requested information, please submit a written request for an extension of time prior to February 25, 2022. **Please provide an electronic version and one hard copy of the response for the incomplete request to be rendered complete and processed. Please include the Council's exempt modification identification number referenced above with the submittal.**

This notice of incompleteness shall have the effect of tolling the Federal Communications Commission (FCC) 60-day timeframe in accordance with Paragraph 217 of the FCC Wireless Infrastructure Report and Order issued on October 21, 2014 (FCC 14-153).

Thank you for your attention to this matter. Should you have any questions, please feel free to contact me at 860-827-2951.

Sincerely,

Melanie Bachman
Executive Director
MAB/FOC/emr




VICINITY MAP



AMERICAN TOWER®

ATC SITE NAME: COLCHESTER CT 6
 ATC SITE NUMBER: 302465
 SPRINT SITE NAME: CTHA359A
 SPRINT SITE NUMBER: CTHA359A
 SITE ADDRESS: 355 ROUTE 85
 COLCHESTER, CT 06415

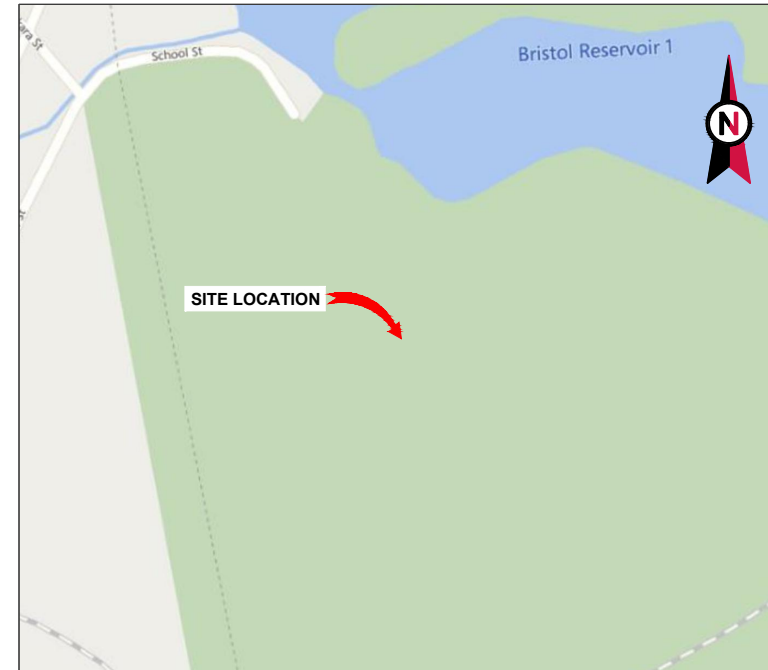

LOCATION MAP

**SPRINT SPRINT RETAIN ANTENNA AMENDMENT PLAN
 67E5A998E 6160 CONFIGURATION**

COMPLIANCE CODE	PROJECT SUMMARY	PROJECT DESCRIPTION	SHEET INDEX				
ALL WORK SHALL BE PERFORMED AND MATERIALS INSTALLED IN ACCORDANCE WITH THE CURRENT EDITIONS OF THE FOLLOWING CODES AS ADOPTED BY THE LOCAL GOVERNMENT AUTHORITIES. NOTHING IN THESE PLANS IS TO BE CONSTRUED TO PERMIT WORK NOT CONFORMING TO THESE CODES. 1. 2018 CONNECTICUT STATE BUILDING CODE, INCORPORATING THE 2015 IBC 2. 2017 NATIONAL ELECTRICAL CODE - NFPA 70 3. LOCAL BUILDING CODE 4. CITY/COUNTY ORDINANCES	<u>SITE ADDRESS:</u> 355 ROUTE 85 COLCHESTER, CT 06415 COUNTY: NEW LONDON <u>GEOGRAPHIC COORDINATES:</u> LATITUDE: 41.54481944 LONGITUDE: -72.30489167 GROUND ELEVATION: 559' AMSL	THE PROPOSED PROJECT INCLUDES MODIFYING GROUND BASED AND TOWER MOUNTED EQUIPMENT AS INDICATED PER BELOW: <u>TOWER WORK:</u> REMOVE (6) ANTENNA(s), (12) RRH(s), AND (6) COAX CABLE(s) AND (2) HYBRID CABLE(s) INSTALL (1) PLATFORM MOUNT(s), (9) ANTENNA(s), (6) RRH(s), AND (3) HYBRID CABLE(s) <u>GROUND WORK:</u> INSTALL (1) ENCLOSURE 6160 AND (1) B160 REMOVE ALL SHELTER EQUIPMENT AND (1) GENERIC CABINET(s)	SHEET NO:	DESCRIPTION:	REV:	DATE:	BY:
	<u>PROJECT TEAM</u> <u>TOWER OWNER:</u> AMERICAN TOWER 10 PRESIDENTIAL WAY WOBURN, MA 01801 <u>APPLICANT:</u> T-MOBILE <u>ENGINEER:</u> COLLIER'S ENGINEERING & DESIGN CT, P.C. 135 NEW ROAD MADISON, CT 06443 PROJECT #: 21904284A <u>PROPERTY OWNER:</u> M & J AUTO RECYCLING INC 355 ROUTE 85 COLCHESTER, CT 06415	<u>PROJECT NOTES</u> 1. THE FACILITY IS UNMANNED. 2. A TECHNICIAN WILL VISIT THE SITE APPROXIMATELY ONCE A MONTH FOR ROUTINE INSPECTION AND MAINTENANCE. 3. THE PROJECT WILL NOT RESULT IN ANY SIGNIFICANT LAND DISTURBANCE OR EFFECT OF STORM WATER DRAINAGE. 4. NO SANITARY SEWER, POTABLE WATER OR TRASH DISPOSAL IS REQUIRED. 5. HANDICAP ACCESS IS NOT REQUIRED. 6. THE PROJECT DEPICTED IN THESE PLANS QUALIFIES AS AN ELIGIBLE FACILITIES REQUEST ENTITLED TO EXPEDITED REVIEW UNDER 47 U.S.C. § 1455(A) AS A MODIFICATION OF AN EXISTING WIRELESS TOWER THAT INVOLVES THE COLLOCATION, REMOVAL, AND/OR REPLACEMENT OF TRANSMISSION EQUIPMENT THAT IS NOT A SUBSTANTIAL CHANGE UNDER CFR § 1.61000 (B)(7).	G-001	TITLE SHEET	1	10/29/21	DEH
<u>UTILITY COMPANIES</u> POWER COMPANY: EVER SOURCE PHONE: (877) 659-6326 TELEPHONE COMPANY: FRONTIER COMMUNICATIONS PHONE: (800) 376-6843		<u>PROJECT LOCATION DIRECTIONS</u> FROM NEW LONDON, TAKE I 395 NORTH TO RT 2 WEST. FOLLOW RT WEST TO RT 85 SOUTH. FOLLOW RT 2 SOUTH TO DUTTON RD. TURN ON TO DUTTON RD AND ROAD GATE ON RIGHT.	G-002	GENERAL NOTES	1	10/29/21	DEH
			C-101	DETAILED SITE PLAN	1	10/29/21	DEH
			C-201	TOWER ELEVATION	1	10/29/21	DEH
			C-401	ANTENNA INFORMATION & SCHEDULE	1	10/29/21	DEH
			C-501	CONSTRUCTION DETAILS	1	10/29/21	DEH
			E-501	GROUNDING DETAILS	1	10/29/21	DEH
			E-502	ELECTRICAL DETAILS	1	10/29/21	DEH
			R-601	SUPPLEMENTAL			
			R-602	SUPPLEMENTAL			
			R-603	SUPPLEMENTAL			
			R-604	SUPPLEMENTAL			
			R-605	SUPPLEMENTAL			
			R-606	SUPPLEMENTAL			



Colliers Engineering & Design
 www.colliersengineering.com
 Doing Business as MASER CONSULTING
 MADISON
 135 New Road
 Madison, CT 06443
 Phone: 860.395.0055
 COLLIER'S ENGINEERING & DESIGN CT, P.C.
 DOING BUSINESS AS MASER CONSULTING

REV.	DESCRIPTION	BY	DATE
A	PRELIM	DEH	08/12/21
0	FOR CONSTRUCTION	RMD	09/10/21
1	FOR CONSTRUCTION	RMD	10/29/21

ATC SITE NUMBER:
302465

 ATC SITE NAME:
COLCHESTER CT 6

 SPRINT SITE NAME:
CTHA359A
 SITE ADDRESS:
355 ROUTE 85
COLCHESTER, CT 06415

SEAL:

 Digitally signed by Eric Anderson
 Date: 2021.10.29 11:48:56-04'00'
 COA: JPC.0000131

T-Mobile
 DATE DRAWN: 08/12/21
 ATC JOB NO: 13711921_G3
 CUSTOMER ID: CTHA359A
 CUSTOMER #: CTHA359A

TITLE SHEET
 SHEET NUMBER: G-001
 REVISION: 1

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GENERAL CONSTRUCTION NOTES:

1. OWNER FURNISHED MATERIALS, SPRINT "THE COMPANY" WILL PROVIDE AND THE CONTRACTOR WILL INSTALL
 - A. BTS EQUIPMENT FRAME (PLATFORM) AND ICEBRIDGE SHELTER (GROUND BUILD/CO-LOCATE ONLY)
 - B. AC/TELCO INTERFACE BOX (PPC)
 - C. ICE BRIDGE (CABLE TRAY WITH COVER) (GROUND BUILD/CO-LOCATE ONLY, GC TO FURNISH AND INSTALL FOR ROOFTOP INSTALLATION)
 - D. TOWERS, MONOPOLES
 - E. TOWER LIGHTING
 - F. GENERATORS & LIQUID PROPANE TANK
 - G. ANTENNA STANDARD BRACKETS, FRAMES AND PIPES FOR MOUNTING
 - H. ANTENNAS (INSTALLED BY OTHERS)
 - I. TRANSMISSION LINE
 - J. TRANSMISSION LINE JUMPERS
 - K. TRANSMISSION LINE CONNECTORS WITH WEATHERPROOFING KITS
 - L. TRANSMISSION LINE GROUND KITS
 - M. HANGERS
 - N. HOISTING GRIPS
 - O. BTS EQUIPMENT
2. THE CONTRACTOR IS RESPONSIBLE TO PROVIDE ALL OTHER MATERIALS FOR THE COMPLETE INSTALLATION OF THE SITE INCLUDING, BUT NOT LIMITED TO, SUCH MATERIALS AS FENCING, STRUCTURAL STEEL SUPPORTING SUB-FRAME FOR PLATFORM, ROOFING LABOR AND MATERIALS, GROUNDING RINGS, GROUNDING WIRES, COPPER-CLAD OR XIT CHEMICAL GROUND ROD(S), BUSS BARS, TRANSFORMERS AND DISCONNECT SWITCHES WHERE APPLICABLE, TEMPORARY ELECTRICAL POWER, CONDUIT, LANDSCAPING COMPOUND STONE, CRANES, CORE DRILLING, SLEEPERS AND RUBBER MATTING, REBAR, CONCRETE CAISSONS, PADS AND/OR AUGER MOUNTS, MISCELLANEOUS FASTENERS, CABLE TRAYS, NON-STANDARD ANTENNA FRAMES AND ALL OTHER MATERIAL AND LABOR REQUIRED TO COMPLETE THE JOB ACCORDING TO THE DRAWINGS AND SPECIFICATIONS. IT IS THE POSITION OF SPRINT TO APPLY FOR PERMITTING AND CONTRACTOR RESPONSIBLE FOR PICKUP AND PAYMENT OF REQUIRED PERMITS.
3. ALL WORK SHALL CONFORM TO ALL CURRENT APPLICABLE FEDERAL, STATE, AND LOCAL CODES, INCLUDING ANSI/EIA/TIA-222, AND COMPLY WITH ATC CONSTRUCTION SPECIFICATIONS.
4. CONTRACTOR SHALL CONTACT LOCAL 811 FOR IDENTIFICATION OF UNDERGROUND UTILITIES PRIOR TO START OF CONSTRUCTION.
5. CONTRACTOR SHALL BE RESPONSIBLE FOR COORDINATING ALL REQUIRED INSPECTIONS.
6. ALL DIMENSIONS TO, OF, AND ON EXISTING BUILDINGS, DRAINAGE STRUCTURES, AND SITE IMPROVEMENTS SHALL BE VERIFIED IN FIELD BY CONTRACTOR WITH ALL DISCREPANCIES REPORTED TO THE ENGINEER.
7. DO NOT CHANGE SIZE OR SPACING OF STRUCTURAL ELEMENTS.
8. DETAILS SHOWN ARE TYPICAL; SIMILAR DETAILS APPLY TO SIMILAR CONDITIONS UNLESS OTHERWISE NOTED.
9. THESE DRAWINGS DO NOT INCLUDE NECESSARY COMPONENTS FOR CONSTRUCTION SAFETY WHICH SHALL BE THE SOLE RESPONSIBILITY OF THE CONTRACTOR.
10. CONTRACTOR SHALL BRACE STRUCTURES UNTIL ALL STRUCTURAL ELEMENTS NEEDED FOR STABILITY ARE INSTALLED. THESE ELEMENTS ARE AS FOLLOWS: LATERAL BRACING, ANCHOR BOLTS, ETC.
11. CONTRACTOR SHALL DETERMINE EXACT LOCATION OF EXISTING UTILITIES, GROUNDS DRAINS, DRAIN PIPES, VENTS, ETC. BEFORE COMMENCING WORK.
12. INCORRECTLY FABRICATED, DAMAGED, OR OTHERWISE MISFITTING OR NONCONFORMING MATERIALS OR CONDITIONS SHALL BE REPORTED TO THE SPRINT REP PRIOR TO REMEDIAL OR CORRECTIVE ACTION. ANY SUCH REMEDIAL ACTION SHALL REQUIRE WRITTEN APPROVAL BY THE SPRINT REP PRIOR TO PROCEEDING.
13. EACH CONTRACTOR SHALL COOPERATE WITH THE SPRINT REP, AND COORDINATE HIS WORK WITH THE WORK OF OTHERS.
14. CONTRACTOR SHALL REPAIR ANY DAMAGE CAUSED BY CONSTRUCTION OF THIS PROJECT TO MATCH EXISTING PRE-CONSTRUCTION CONDITIONS TO THE SATISFACTION OF THE SPRINT CONSTRUCTION MANAGER.
15. ALL CABLE/CONDUIT ENTRY/EXIT PORTS SHALL BE WEATHERPROOFED DURING INSTALLATION USING A SILICONE SEALANT.
16. WHERE EXISTING CONDITIONS DO NOT MATCH THOSE SHOWN IN THIS PLAN SET, CONTRACTOR SHALL NOTIFY THE SPRINT REP AND ENGINEER OF RECORD IMMEDIATELY.
17. CONTRACTOR SHALL ENSURE ALL SUBCONTRACTORS ARE PROVIDED WITH A COMPLETE AND CURRENT SET OF DRAWINGS AND SPECIFICATIONS FOR THIS PROJECT.
18. CONTRACTOR SHALL REMOVE ALL RUBBISH AND DEBRIS FROM THE SITE AT THE END OF EACH DAY.
19. CONTRACTOR SHALL COORDINATE WORK SCHEDULE WITH AMERICAN TOWER CORPORATION (ATC) AND TAKE PRECAUTIONS TO MINIMIZE IMPACT AND DISRUPTION OF OTHER OCCUPANTS OF THE FACILITY.
20. CONTRACTOR SHALL FURNISH SPRINT AND AMERICAN TOWER CORPORATION (ATC) WITH A PDF MARKED UP AS-BUILT SET OF DRAWINGS UPON COMPLETION OF WORK.
21. PRIOR TO SUBMISSION OF BID, CONTRACTOR SHALL COORDINATE WITH SPRINT REP TO DETERMINE WHAT, IF ANY, ITEMS WILL BE PROVIDED. ALL ITEMS NOT PROVIDED SHALL BE PROVIDED AND INSTALLED BY THE CONTRACTOR. CONTRACTOR WILL INSTALL ALL ITEMS PROVIDED.

22. PRIOR TO SUBMISSION OF BID, CONTRACTOR SHALL COORDINATE WITH SPRINT REP TO DETERMINE IF ANY PERMITS WILL BE OBTAINED BY CONTRACTOR. ALL REQUIRED PERMITS NOT OBTAINED BY SPRINT MUST BE OBTAINED, AND PAID FOR, BY THE CONTRACTOR.
23. CONTRACTOR SHALL INSTALL ALL SITE SIGNAGE IN ACCORDANCE WITH SPRINT SPECIFICATIONS AND REQUIREMENTS.
24. CONTRACTOR SHALL SUBMIT ALL SHOP DRAWINGS TO SPRINT FOR REVIEW AND APPROVAL PRIOR TO FABRICATION.
25. ALL EQUIPMENT SHALL BE INSTALLED ACCORDING TO MANUFACTURER'S SPECIFICATIONS AND LOCATED ACCORDING TO SPRINT SPECIFICATIONS, AND AS SHOWN IN THESE PLANS.
26. THE CONTRACTOR SHALL SUPERVISE AND DIRECT THE PROJECT DESCRIBED HEREIN. THE CONTRACTOR SHALL BE SOLELY RESPONSIBLE FOR ALL THE CONSTRUCTION MEANS, METHODS, TECHNIQUES, SEQUENCES AND PROCEDURES AND FOR COORDINATING ALL PORTIONS OF THE WORK UNDER THE CONTRACT.
27. CONTRACTOR SHALL NOTIFY SPRINT REP A MINIMUM OF 48 HOURS IN ADVANCE OF POURING CONCRETE OR BACKFILLING ANY UNDERGROUND UTILITIES, FOUNDATIONS OR SEALING ANY WALL, FLOOR OR ROOF PENETRATIONS FOR ENGINEERING REVIEW AND APPROVAL.
28. CONTRACTOR SHALL BE RESPONSIBLE FOR SITE SAFETY INCLUDING COMPLIANCE WITH ALL APPLICABLE OSHA STANDARDS AND RECOMMENDATIONS AND SHALL PROVIDE ALL NECESSARY SAFETY DEVICES INCLUDING PPE AND PPM AND CONSTRUCTION DEVICES SUCH AS WELDING AND FIRE PREVENTION, TEMPORARY SHORING, SCAFFOLDING, TRENCH BOXES/SLOPING, BARRIERS, ETC.
29. THE CONTRACTOR SHALL PROTECT AT HIS OWN EXPENSE, ALL EXISTING FACILITIES AND SUCH OF HIS NEW WORK LIABLE TO INJURY DURING THE CONSTRUCTION PERIOD. ANY DAMAGE CAUSED BY NEGLIGENCE ON THE PART OF THIS CONTRACTOR OR HIS REPRESENTATIVES, OR BY THE ELEMENTS DUE TO NEGLIGENCE ON THE PART OF THIS CONTRACTOR OR HIS REPRESENTATIVES, EITHER TO THE EXISTING WORK, OR TO HIS WORK OR THE WORK OF ANY OTHER CONTRACTOR, SHALL BE REPAIRED AT HIS EXPENSE TO THE OWNER'S SATISFACTION.
30. ALL WORK SHALL BE INSTALLED IN A FIRST CLASS, NEAT AND WORKMANLIKE MANNER BY MECHANICS SKILLED IN THE TRADE INVOLVED. THE QUALITY OF WORKMANSHIP SHALL BE SUBJECT TO THE APPROVAL OF THE SPRINT REP. ANY WORK FOUND BY THE SPRINT REP TO BE OF INFERIOR QUALITY AND/OR WORKMANSHIP SHALL BE REPLACED AND/OR REWORKED AT CONTRACTOR EXPENSE UNTIL APPROVAL IS OBTAINED.
31. IN ORDER TO ESTABLISH STANDARDS OF QUALITY AND PERFORMANCE, ALL TYPES OF MATERIALS LISTED HEREINAFTER BY MANUFACTURER'S NAMES AND/OR MANUFACTURER'S CATALOG NUMBER SHALL BE PROVIDED BY THESE MANUFACTURERS AS SPECIFIED.
32. SPRINT FURNISHED EQUIPMENT SHALL BE PICKED-UP AT THE SPRINT WAREHOUSE, NO LATER THAN 48HR AFTER BEING NOTIFIED INSURED, STORED, UNCRATE, PROTECTED AND INSTALLED BY THE CONTRACTOR WITH ALL APPURTENANCES REQUIRED TO PLACE THE EQUIPMENT IN OPERATION, READY FOR USE. THE CONTRACTOR SHALL BE RESPONSIBLE FOR THE EQUIPMENT AFTER PICKING IT UP.
33. SPRINT OR HIS ARCHITECT/ENGINEER RESERVES THE RIGHT TO REJECT ANY EQUIPMENT OR MATERIALS WHICH, IN HIS OWN OPINION ARE NOT IN COMPLIANCE WITH THE CONTRACT DOCUMENTS, EITHER BEFORE OR AFTER INSTALLATION AND THE EQUIPMENT SHALL BE REPLACED WITH EQUIPMENT CONFORMING TO THE REQUIREMENTS OF THE CONTRACT DOCUMENTS BY THE CONTRACTOR AT NO COST TO SPRINT OR THEIR ARCHITECT/ENGINEER.

SPECIAL CONSTRUCTION

ANTENNA INSTALLATION NOTES:

1. WORK INCLUDED:
 - A. ANTENNA AND COAXIAL CABLES ARE FURNISHED BY SPRINT UNDER A SEPARATE CONTRACT. THE CONTRACTOR SHALL ASSIST ANTENNA INSTALLATION CONTRACTOR IN TERMS OF COORDINATION AND SITE ACCESS. ERECTION SUBCONTRACTOR SHALL BE RESPONSIBLE FOR THE PROTECTION OF PERSONNEL AND
 - B. INSTALL ANTENNA AS INDICATE ON DRAWINGS AND SPRINT SPECIFICATIONS.
 - C. INSTALL GALVANIZED STEEL ANTENNA MOUNTS AS INDICATED ON DRAWINGS
 - D. INSTALL FURNISHED GALVANIZED STEEL OR ALUMINUM WAVEGUIDE AND PROVIDE PRINTOUT OF THAT TEST.
 - E. CONTRACTOR SHALL PROVIDE FOUR (4) SETS OF SWEEP TESTS USING ANRITZU-PACKARD 8713B RF SCALAR NETWORK ANALYZER. SUBMIT FREQUENCY DOMAIN REFLECTOMETER(FDR) TESTS RESULTS TO THE PROJECT MANAGER. SWEEP TESTS SHALL BE AS PER ATTACHED RFS "MINIMUM FIELD TESTING RECOMMENDED FOR ANTENNA AND HELIAX COAXIAL CABLE SYSTEMS" DATED 10/5/93. TESTING SHALL BE PERFORMED BY AN INDEPENDENT TESTING SERVICE AND BE BOUND AND SUBMITTED WITHIN ONE WEEK OF WORK COMPLETION.
 - F. INSTALL COAXIAL CABLES AND TERMINATING BETWEEN ANTENNAS AND EQUIPMENT PER MANUFACTURER'S RECOMMENDATIONS. WEATHERPROOF ALL CONNECTIONS BETWEEN THE ANTENNA AND EQUIPMENT PER MANUFACTURER'S REQUIREMENTS. TERMINATE ALL COAXIAL CABLE THREE (3) FEET IN EXCESS OF ENTRY PORT LOCATION UNLESS OTHERWISE STATED.
 - G. ANTENNA AND COAXIAL CABLE GROUNDING:
2. ALL EXTERIOR #6 GREED GROUND WIRE "DAISY CHAIN" CONNECTIONS ARE TO BE WEATHER SEALED WITH RFS CONNECTORS/SPLICE WEATHERPROOFING KIT #22123 OR EQUAL.
3. ALL COAXIAL CABLE GROUNDING KITS ARE TO BE INSTALLED ON STRAIGHT RUNS OF

COAXIAL CABLE (NOT WITHIN BENDS)

ELECTRICAL NOTES:

1. ELECTRICAL DESIGN SHALL BE PERFORMED BY ELECTRICAL CONTRACTOR. STRUCTURAL DESIGN SHALL BE PERFORMED BY GENERAL CONTRACTOR. ELECTRICAL CONTRACTOR SHALL ENSURE THAT ALL WORK COMPLIES WITH ALL APPLICABLE LOCAL AND STATE CODES AND NATIONAL ELECTRICAL CODE.
2. ALL SUGGESTED ELECTRICAL ELEMENTS (SUCH AS BREAKER SIZES, WIRE SIZES, CONDUITS SIZES ARE FOR ZONING PURPOSES ONLY. IT IS THE RESPONSIBILITY TO OF THE ELECTRICAL CONTRACTOR TO CONFIRM COMPLIANCE WITH LOCAL ELECTRICAL CODES AND PASS ALL APPLICABLE AND NECESSARY INSPECTIONS. IN SOME EVENTS, IT MAY BE NECESSARY TO PERFORM AN ELECTRICAL LOAD STUDY TO VERIFY THE CAPACITY OF THE EXISTING SERVICE. THIS IS NOT THE RESPONSIBILITY OF CONCORDIA. IT IS THE RESPONSIBILITY OF THE ELECTRICAL CONTRACTOR.
3. CONTRACTOR SHALL FIELD LOCATE ALL BELOW GRADE GROUND LINES AND UTILITY LINES PRIOR TO CONSTRUCTION. CONTRACTOR IS RESPONSIBLE FOR RELOCATION OF ALL UTILITIES AND GROUND LINES THAT MAY BECOME DISTURBED OR CONFLICTING IN THE COURSE OF CONSTRUCTION.

ALL DISCREPANCIES FROM WHAT IS SHOWN ON THESE CONSTRUCTION DRAWINGS SHALL BE COMMUNICATED TO ATC ENGINEERING IMMEDIATELY FOR CORRECTION OR RE-DESIGN. FAILURE TO COMMUNICATE DIRECTLY WITH ATC ENGINEERING OR ANY CHANGES FROM THE DESIGN CONDUCTED WITHOUT PRIOR APPROVAL FROM ATC ENGINEERING SHALL BE THE SOLE RESPONSIBILITY OF THE GENERAL CONTRACTOR.



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 MADISON
 135 New Road
 Madison, CT 06443
 Phone: 860.395.0055
 COLLIER'S ENGINEERING & DESIGN CT, P.C.
 DOING BUSINESS AS MASER CONSULTING

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REV.	DESCRIPTION	BY	DATE
A	PRELIM	DEH	08/12/21
0	FOR CONSTRUCTION	RMD	09/10/21
1	FOR CONSTRUCTION	RMD	10/29/21

ATC SITE NUMBER:
302465

ATC SITE NAME:
COLCHESTER CT 6

SPRINT SITE NAME:
CTHA359A

SITE ADDRESS:
355 ROUTE 85
COLCHESTER, CT 06415

SEAL:



COA: JPC.0000131



DATE DRAWN:	08/12/21
ATC JOB NO:	13711921_G3
CUSTOMER ID:	CTHA359A
CUSTOMER #:	CTHA359A

GENERAL NOTES

SHEET NUMBER:
G-002

REVISION:
1


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SITE PLAN NOTES:

1. THIS SITE PLAN REPRESENTS THE BEST PRESENT KNOWLEDGE AVAILABLE TO THE ENGINEER AT THE TIME OF THIS DESIGN. THE CONTRACTOR SHALL VISIT THE SITE PRIOR TO CONSTRUCTION AND VERIFY ALL EXISTING CONDITIONS RELATED TO THE SCOPE OF WORK FOR THIS PROJECT.
2. ICE BRIDGE, CABLE LADDER, COAX PORT, AND COAX CABLE ARE SHOWN FOR REFERENCE ONLY. CONTRACTOR SHALL CONFIRM THE EXACT LOCATION OF ALL PROPOSED AND EXISTING EQUIPMENT AND STRUCTURES DEPICTED ON THIS PLAN. BEFORE UTILIZING EXISTING CABLE SUPPORTS, COAX PORTS, INSTALLING NEW PORTS OR ANY OTHER EQUIPMENT, CONTRACTOR SHALL VERIFY ALL ASPECTS OF THE COMPONENTS MEET THE ATC SPECIFICATIONS.
3. IT IS THE RESPONSIBILITY OF THE CONTRACTOR TO COORDINATE WITH THE SPRINT REPRESENTATIVE AND LOCAL UTILITY COMPANY FOR THE INSTALLATION OF CONDUITS, CONDUCTORS, BREAKERS, DISCONNECTS, OR ANY OTHER EQUIPMENT REQUIRED FOR ELECTRICAL SERVICE. ALL ELECTRICAL WORK SHALL BE PERFORMED IN ACCORDANCE WITH LATEST EDITION OF THE STATE AND NATIONAL CODES, ORDINANCES AND REGULATIONS APPLICABLE TO THIS PROJECT.


LEGEND	
⊗	GROUNDING TEST WELL
ATS	AUTOMATIC TRANSFER SWITCH
B	BOLLARD
CSC	CELL SITE CABINET
D	DISCONNECT
E	ELECTRICAL
F	FIBER
GEN	GENERATOR
G	GENERATOR RECEPTACAL
HH, V	HAND HOLE, VAULT
IB	ICE BRIDGE
K	KENTROX BOX
LC	LIGHTING CONTROL
M	METER
PB	PULL BOX
PP	POWER POLE
T	TELCO
TRN	TRANSFORMER
x	CHAINLINK FENCE

- PROPOSED CABLE LENGTH:**
1. ESTIMATED LENGTH OF PROPOSED CABLE IS **210'**. ESTIMATED LENGTH OF CABLE WAS PROVIDED BY CUSTOMER OR CALCULATED BY ADDING THE RAD CENTER AND THE DISTANCE FROM THE SHELTER ENTRY PLATE TO THE TOWER (ALONG THE ICE BRIDGE) AND A SAFETY FACTOR MEASUREMENT OF 15% (OF THE TWO PREVIOUS VALUES). CDS DEFER TO GREATEST CABLE LENGTH.
 2. ROUTE PROPOSED CABLES ALONG SAME PATH AS EXISTING CABLES AND IN ACCORDANCE WITH STRUCTURAL ANALYSIS. WHERE POSSIBLE UTILIZE EXISTING CABLE SUPPORT STRUCTURES AS PROVIDED FOR CARRIER TO ADEQUATELY SECURE CABLES, USING EITHER APPROPRIATELY SIZED STAINLESS STEEL SNAP-INS OR MOUNTING HARDWARE AND BRACKETS AS SPECIFIED BY CABLE MANUFACTURER. OTHERWISE, ATTACH CABLES TO HORIZONTAL OR DIAGONAL TOWER MEMBERS USING PROPOSED STAINLESS STEEL ADAPTERS (DO NOT ATTACH TO TOWER LEG).

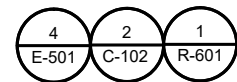


EXISTING T-MOBILE EQUIPMENT ON A 9' X 20' CONCRETE PAD (MODIFIED AS REQUIRED FOR UPGRADE FROM SPRINT TO T-MOBILE 67E5A998E 6160 CONFIGURATION)

PROPOSED (3) T-MOBILE 1.99" 6/24 4AWG HYBRID CABLES
 (6) SPRINT 1-5/8" COAX CABLES AND (2) SPRINT 1-1/4" HYBRID CABLES (TO BE REMOVED)

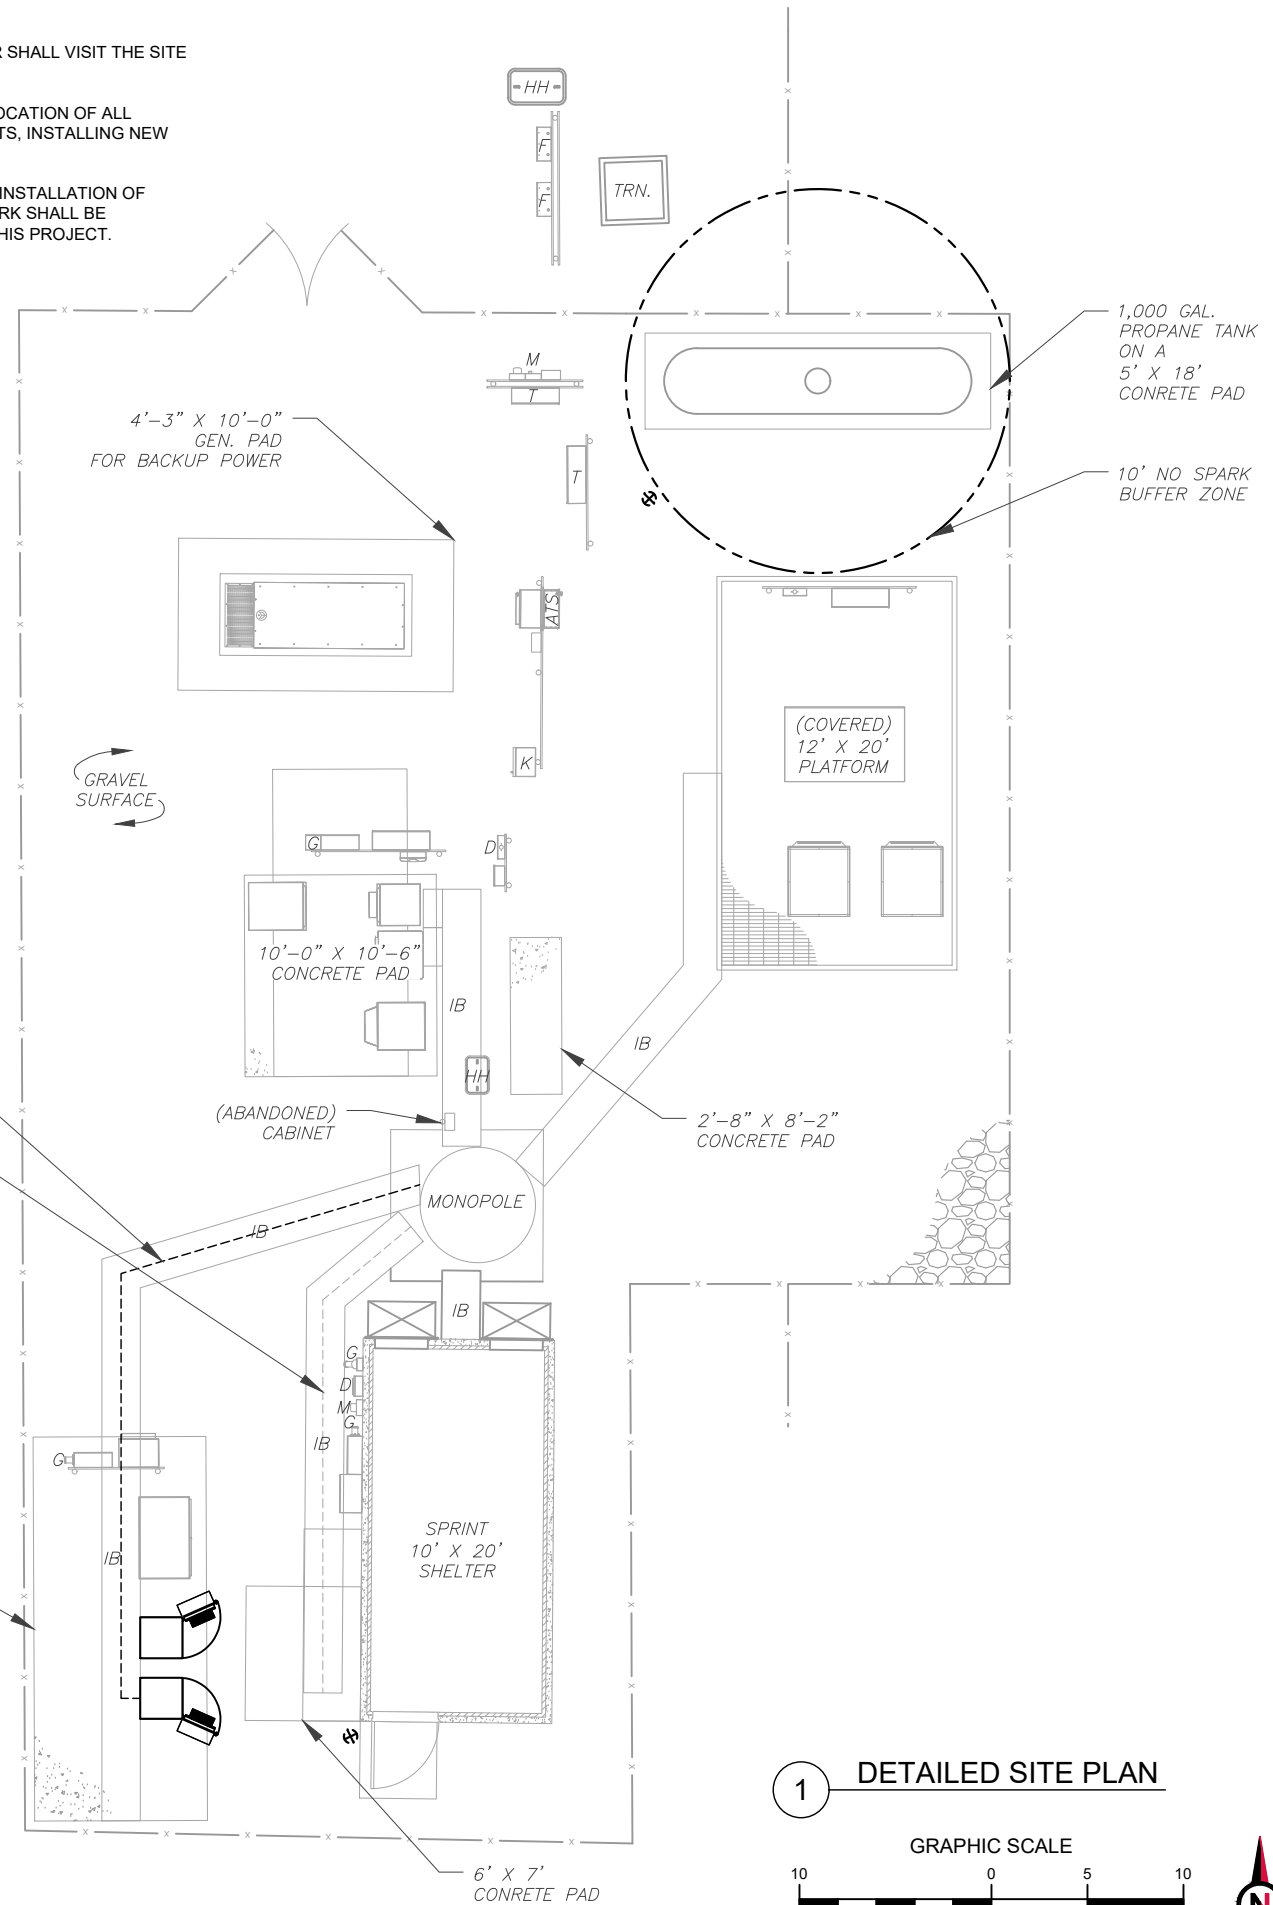

1 DETAILED SITE PLAN

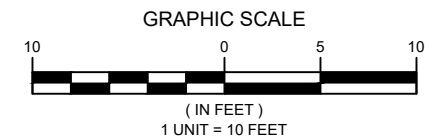

Colliers Engineering & Design
 www.colliersengineering.com
 Doing Business as **MASER CONSULTING**
 MADISON
 135 New Road
 Madison, CT 06443
 Phone: 860.395.0055
 COLLIERS ENGINEERING & DESIGN CT, P.C.
 DOING BUSINESS AS MASER CONSULTING

REV.	DESCRIPTION	BY	DATE
A	PRELIM	DEH	08/12/21
0	FOR CONSTRUCTION	RMD	09/10/21
1	FOR CONSTRUCTION	RMD	10/29/21

ATC SITE NUMBER:
302465
 ATC SITE NAME:
COLCHESTER CT 6
 SPRINT SITE NAME:
CTHA359A
 SITE ADDRESS:
 355 ROUTE 85
 COLCHESTER, CT 06415

SEAL:

 Eric Anderson
 32224
 LICENSED PROFESSIONAL ENGINEER
 Digitally signed by Eric Anderson
 Date: 2021.10.29 11:49:01-04'00'
 COA: JPC.0000131

T-Mobile


DATE DRAWN:	08/12/21
ATC JOB NO:	13711921_G3
CUSTOMER ID:	CTHA359A
CUSTOMER #:	CTHA359A

DETAILED SITE PLAN	
SHEET NUMBER: C-101	REVISION: 1


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SITE PLAN NOTES:


1. CONTRACTOR TO VERIFY THERE IS NO LIVE AAV FIBER RUNNING THROUGH EXISTING DEAD EQUIPMENT. IF SO, THIS WILL NEED TO BE RERUN THROUGH CONDUIT PRIOR TO REMOVING DEAD 2G (6201 CABS) EQUIPMENT.
2. REMOVE EXISTING 2G CABINETS, AND POWER / TELCO WHIPS ASSOCIATED WITH THE DEAD EQUIPMENT IF APPLICABLE.
3. ALL OPEN PORTS NEED TO BE SEALED / WEATHERPROOFED PROPERLY
4. ALL UNNEEDED / EXCESS EQUIPMENT AND GARBAGE TO BE REMOVED FROM EQUIPMENT AREA. DISPOSE OF MATERIALS PROPERLY OFF SITE.

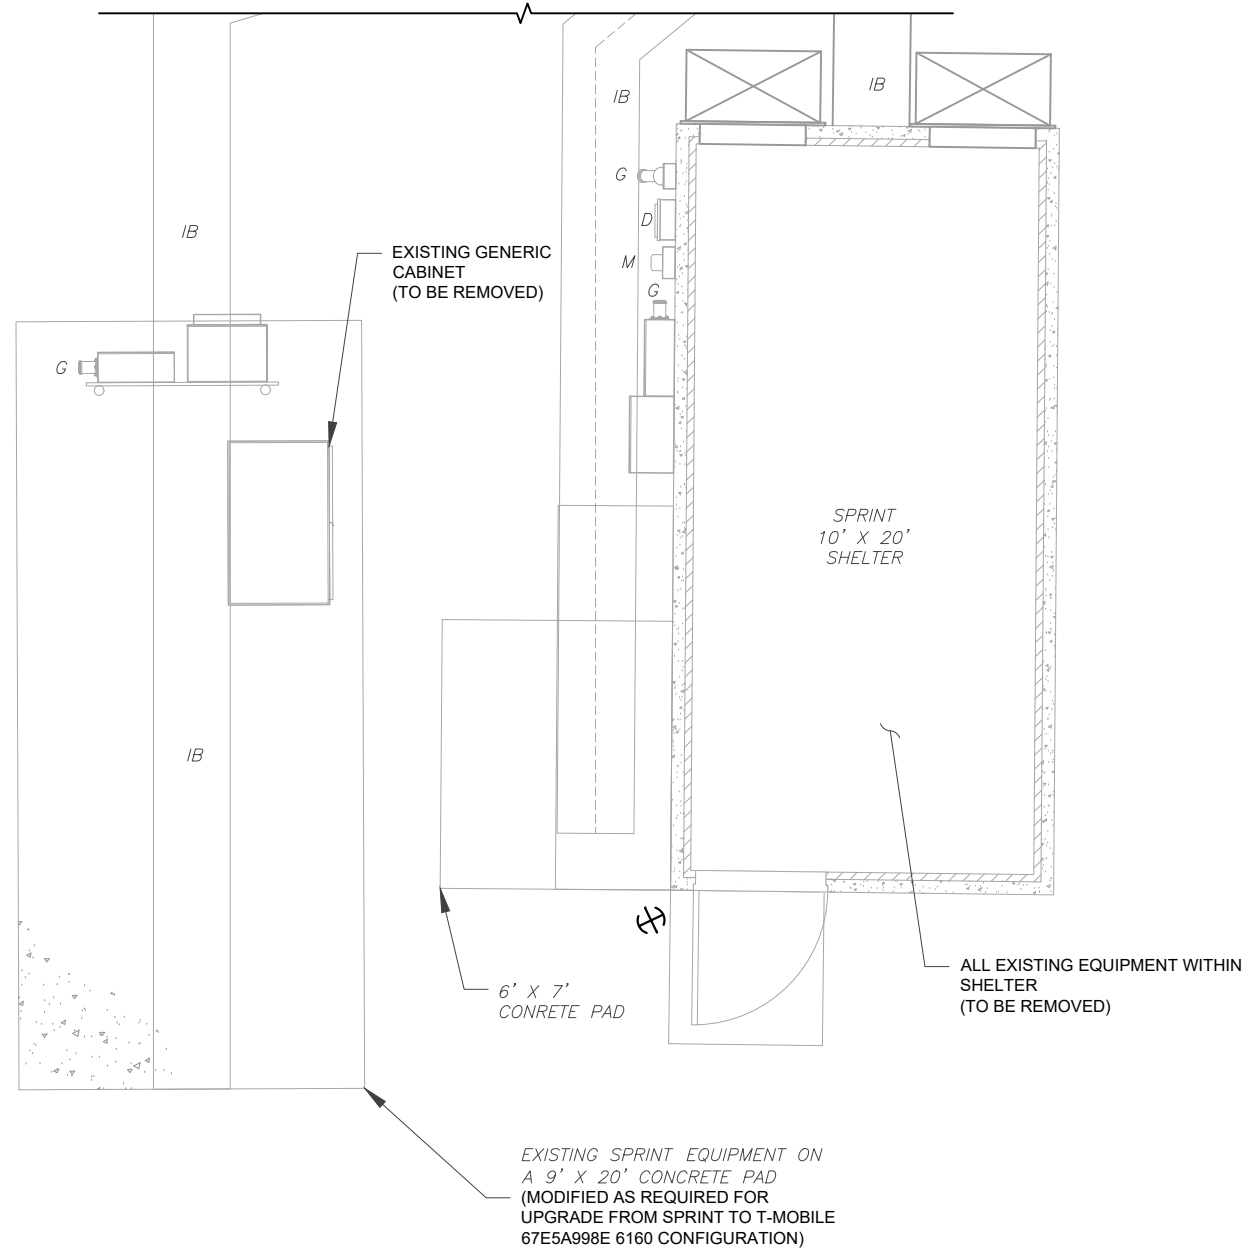

T-MOBILE CM APPROVAL REQUIRED BEFORE INSTALLING CABINETS

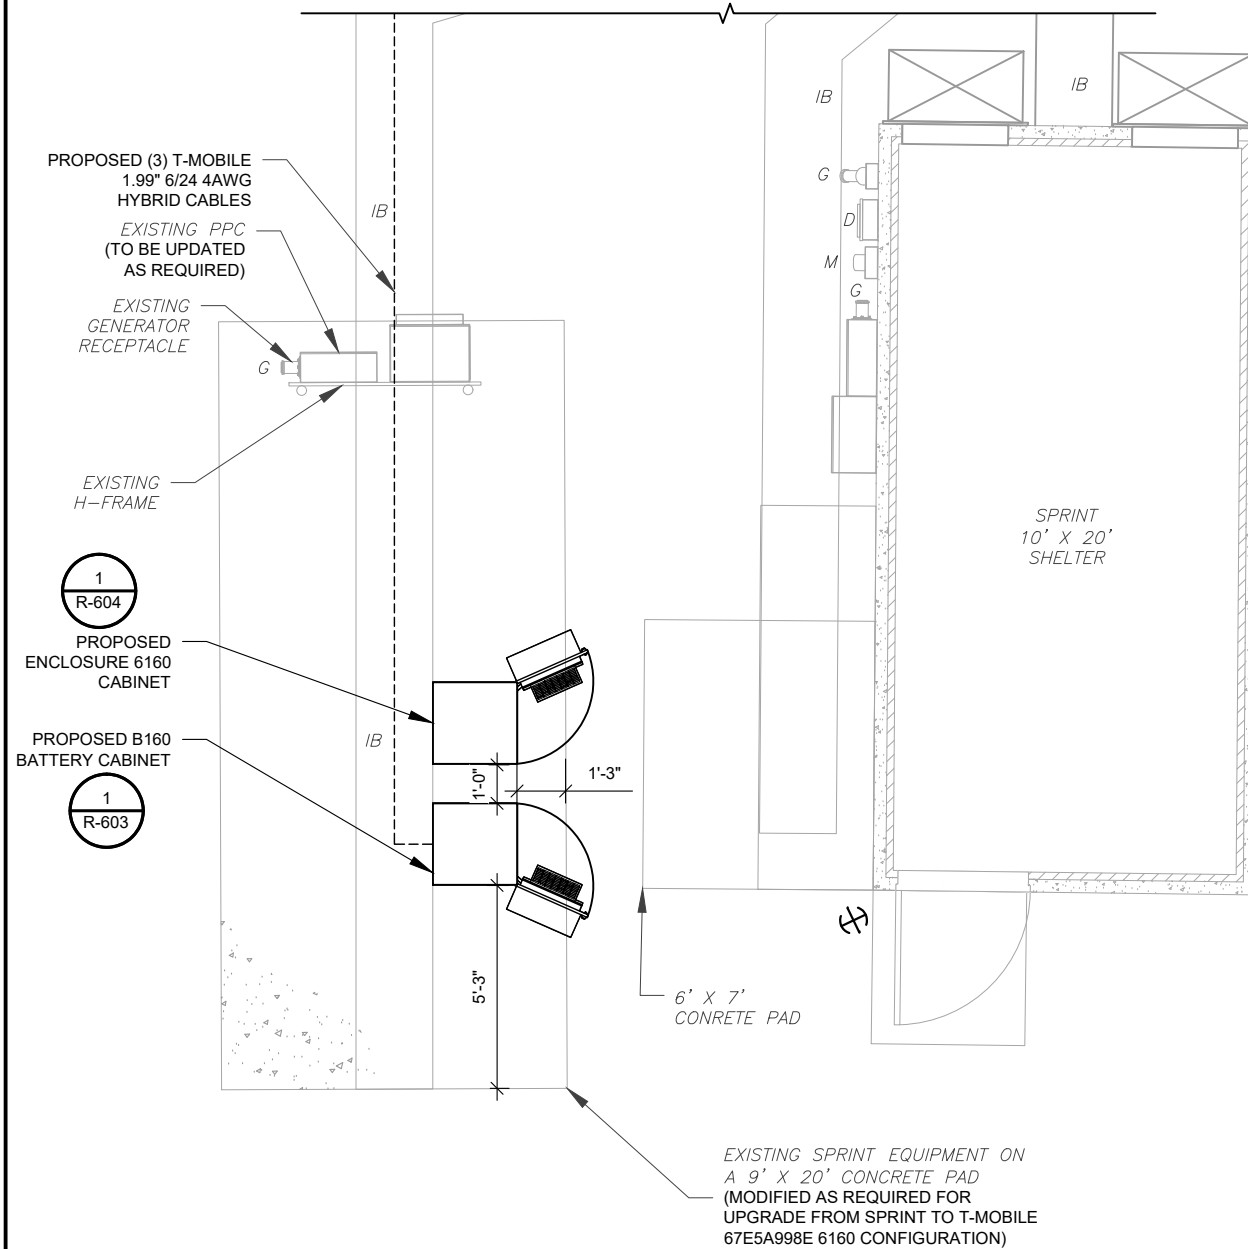

1 EXISTING GROUND EQUIPMENT LAYOUT

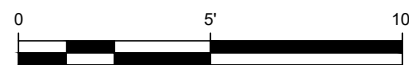

SCALE: 1"=5' (11X17)
1"=2.5' (22X34)



2 PROPOSED GROUND EQUIPMENT LAYOUT



SCALE: 1"=5' (11X17)
1"=2.5' (22X34)



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REV.	DESCRIPTION	BY	DATE
A	PRELIM	DEH	08/12/21
0	FOR CONSTRUCTION	RMD	09/10/21
1	FOR CONSTRUCTION	RMD	10/29/21

ATC SITE NUMBER:
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ATC SITE NAME:
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SPRINT SITE NAME:
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SITE ADDRESS:
355 ROUTE 85
COLCHESTER, CT 06415

SEAL:



COA: JPC.0000131




DATE DRAWN:	08/12/21
ATC JOB NO:	13711921_G3
CUSTOMER ID:	CTHA359A
CUSTOMER #:	CTHA359A

DETAILED GROUND PLAN

SHEET NUMBER:	REVISION:
C-102	1

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PER MOUNT ANALYSIS COMPLETED BY AMERICAN TOWER CORPORATION, DATED 10/25/21, THE PROPOSED MOUNT CAN ADEQUATELY SUPPORT THE PROPOSED LOADING.

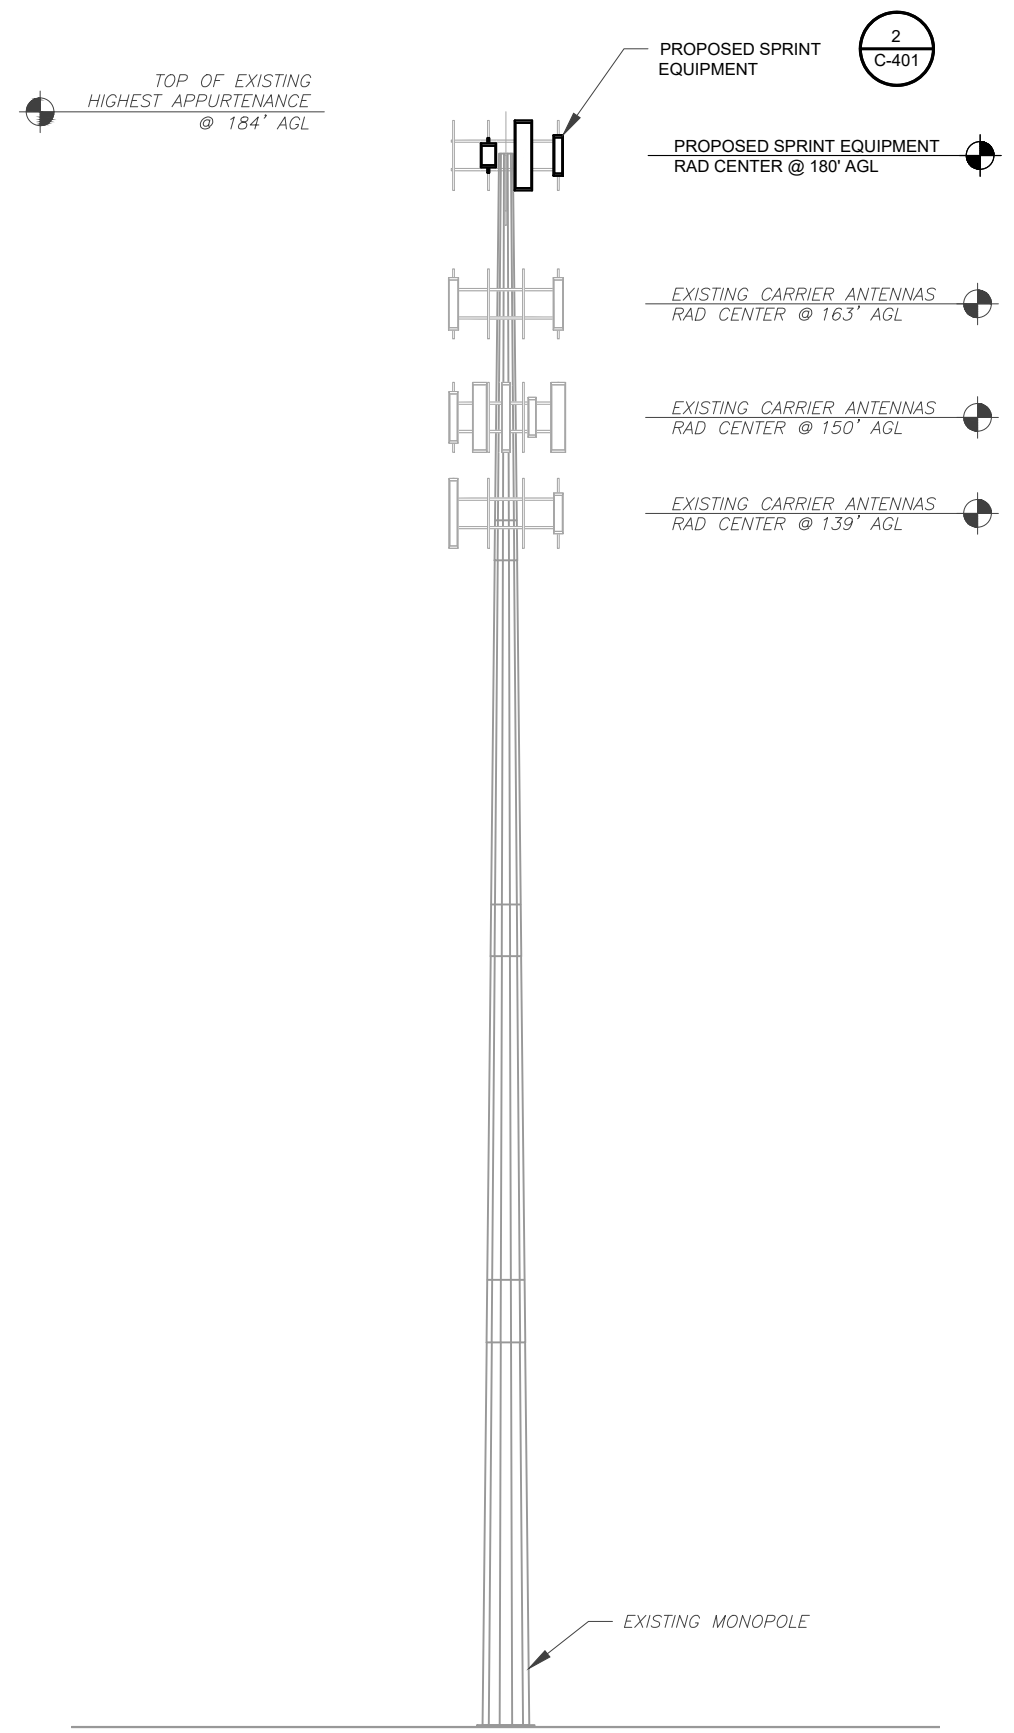1 TOWER ELEVATION
SCALE: N.T.S.

TOWER NOTE:

- IT IS THE CONTRACTOR'S RESPONSIBILITY TO CONFIRM WITH THE PROJECT MANAGER THAT THEY HAVE THE MOST RECENT VERSION OF THE STRUCTURAL ANALYSIS BEFORE COMMENCING WORK. EXISTING AND PROPOSED TOWER APPURTENANCES, MOUNTS, AND ANTENNAS ARE SHOWN BASED ON THE STRUCTURAL ANALYSIS.
- WHERE APPLICABLE, ALL NEW ANTENNAS, EQUIPMENT, MOUNTS, CABLING, ETC. SHALL BE PAINTED/SOCKED TO MATCH EXISTING EQUIPMENT IN ACCORDANCE WITH FAA, JURISDICTION, AND/OR OTHER LOCAL REQUIREMENTS.
- ROUTE PROPOSED CABLES ALONG SAME PATH AS EXISTING CABLES AND IN ACCORDANCE WITH STRUCTURAL ANALYSIS. IF ADEQUATE SPACE EXISTS, ROUTE CABLES THROUGH ENTRY PORT HOLE, UP INSIDE OF MONOPOLE, AND THROUGH EXIT PORT HOLE. IF ROUTING OUTSIDE THE MONOPOLE, ATTACH CABLES USING STAND-OFF ADAPTERS MOUNTED TO TOWER USING STAINLESS STEEL BANDING. ADEQUATELY SECURE CABLES USING EITHER APPROPRIATELY SIZED STAINLESS STEEL SNAP-INS OR MOUNTING HARDWARE AND BRACKETS AS SPECIFIED BY CABLE MANUFACTURER.
- TOWER ELEVATIONS ARE MEASURED FROM TOP OF BASE PLATE TO MATCH STRUCTURAL ANALYSIS. ELEVATIONS DO NOT REFLECT TRUE ABOVE GROUND LEVEL (A.G.L.)



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REV.	DESCRIPTION	BY	DATE
A	PRELIM	DEH	03/30/20
0	FOR CONSTRUCTION	RMD	09/10/21
1	FOR CONSTRUCTION	RMD	10/29/21

ATC SITE NUMBER:
302465

ATC SITE NAME:
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SITE ADDRESS:
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COLCHESTER, CT 06415

SEAL:

Eric Anderson
32224
PROFESSIONAL ENGINEER

Digitally signed by Eric Anderson
Date: 2021.10.29 11:49:07-04'00'

COA: JPC.0000131




DATE DRAWN:	08/12/21
ATC JOB NO:	13711921_G3
CUSTOMER ID:	CTHA359A
CUSTOMER #:	CTHA359A

TOWER ELEVATION


SHEET NUMBER: **C-201** REVISION: **1**

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1 EXISTING ANTENNA PLAN
SCALE: N.T.S.

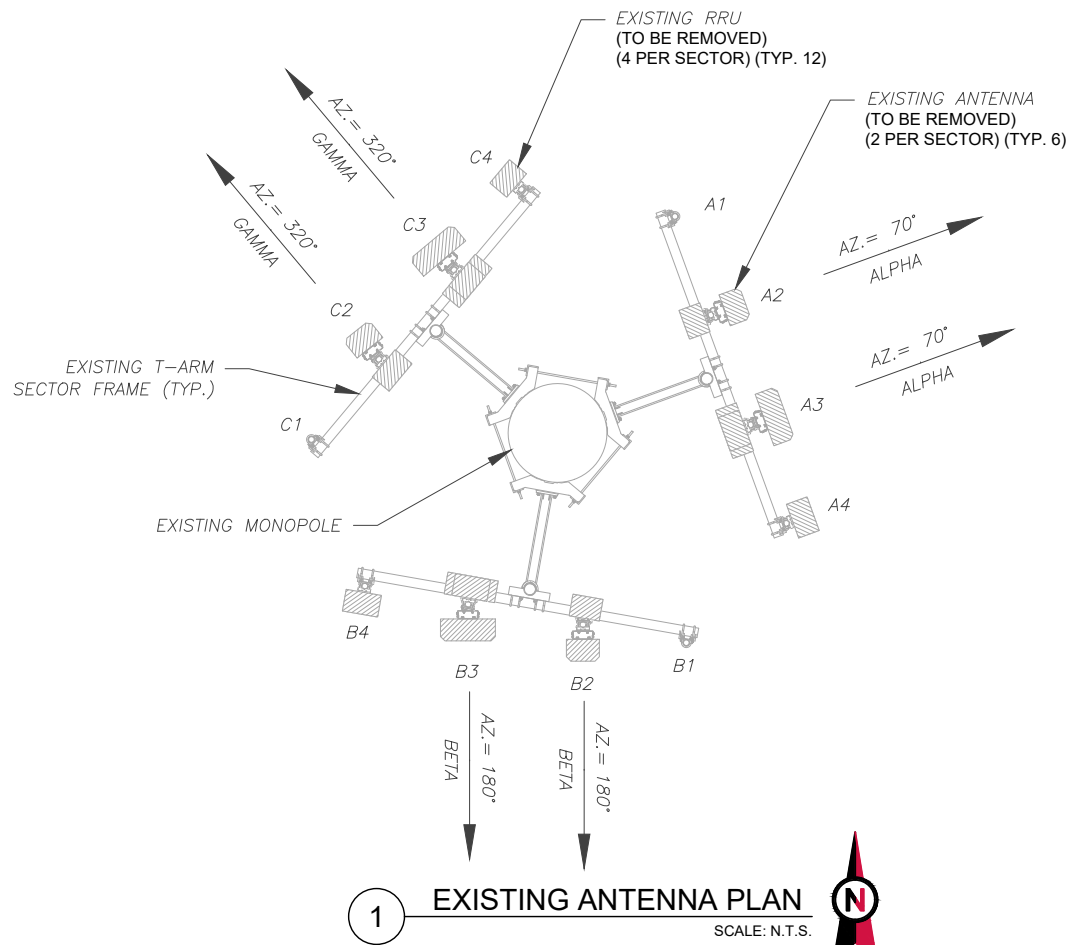PER MOUNT ANALYSIS COMPLETED BY AMERICAN TOWER CORPORATION, DATED 10/25/21, THE PROPOSED MOUNT CAN ADEQUATELY SUPPORT THE PROPOSED LOADING.



2 FINAL ANTENNA PLAN
SCALE: N.T.S.

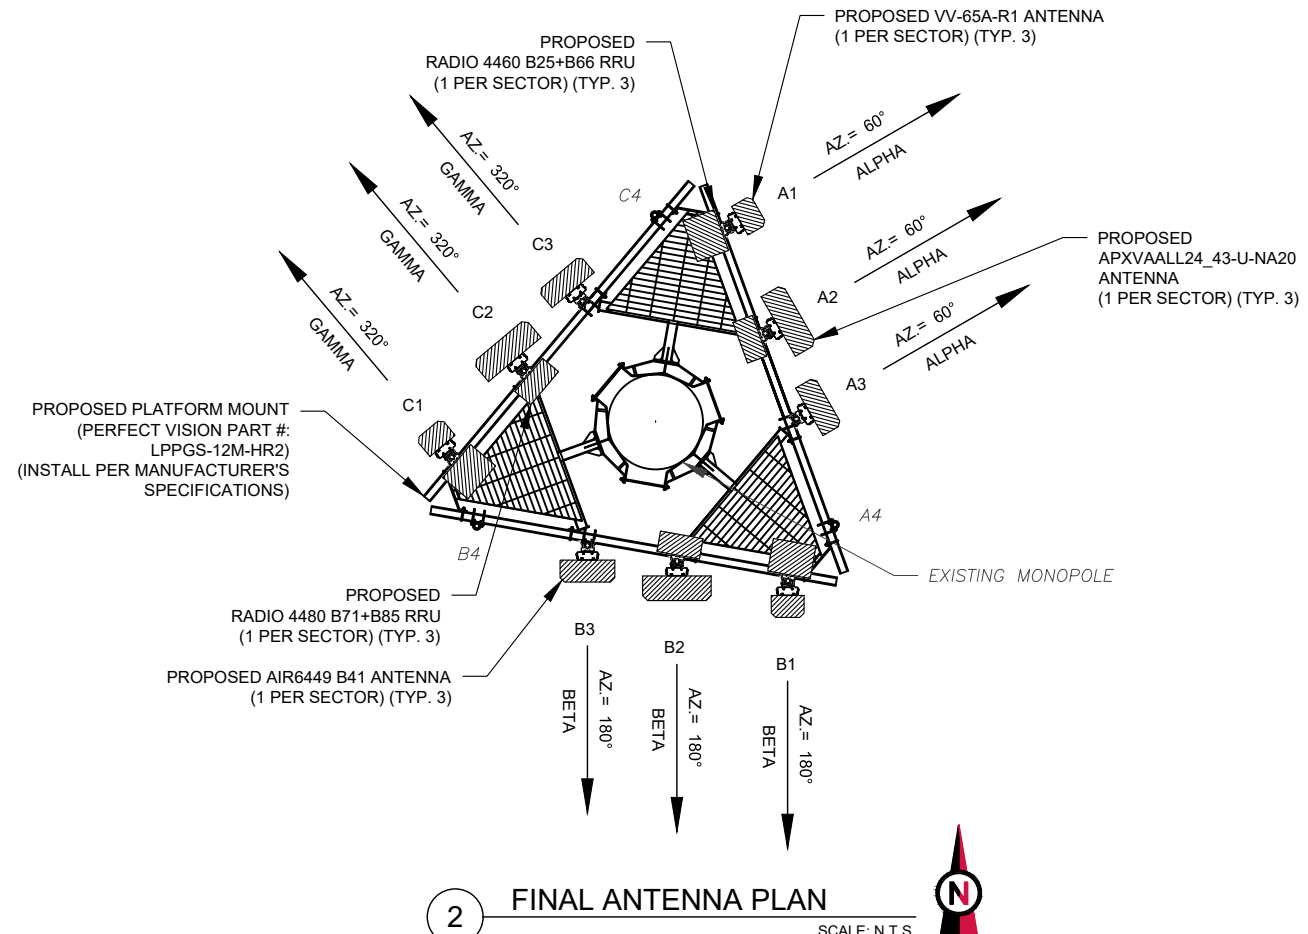EXISTING ANTENNA SCHEDULE									
LOCATION			ANTENNA SUMMARY				NON ANTENNA SUMMARY		
SECTOR	RAD	AZ	POS	ANTENNA	BAND	MECH/ELEC D-TILT	STATUS	ADDITIONAL TOWER MOUNTED EQUIPMENT	STATUS
ALPHA	180°	70°	A1	-	-	-	-	-	-
			A2	APXVTM14-ALU-120	LTE	0/0	RMV	1900 MHz 4X45 RRH	RMV
			A3	NNV-65B-R4	LTE	0/0	RMV	RRH2x50-08 TD-RRH8x20-25 w/ Solar Shield	RMV
			A4	-	-	-	-	RRH2x50-08	RMV
BETA	180°	180°	B1	-	-	-	-	-	
			B2	APXVTM14-ALU-120	LTE	0/0	RMV	1900 MHz 4X45 RRH	RMV
			B3	NNV-65B-R4	LTE	0/0	RMV	RRH2x50-08 TD-RRH8x20-25 w/ Solar Shield	RMV
			B4	-	-	-	-	RRH2x50-08	RMV
GAMMA	180°	320°	C1	-	-	-	-	-	
			C2	APXVTM14-ALU-120	LTE	0/0	RMV	1900 MHz 4X45 RRH	RMV
			C3	NNV-65B-R4	LTE	0/0	RMV	RRH2x50-08 TD-RRH8x20-25 w/ Solar Shield	RMV
			C4	-	-	-	-	RRH2x50-08	RMV

NOTES

- CONFIRM WITH SPRINT REP FOR APPLICABLE UPDATES/REVISIONS AND MOST RECENT RFDS FOR NSN CONFIGURATION (CONFIG). GC TO CAP ALL UNUSED PORTS.
- CONFIRM SPACING OF PROPOSED EQUIP DOES NOT CAUSE TOWER CONFLICTS NOR IMPEDE TOWER CLIMBING PEGS.

STATUS ABBREVIATIONS

RMV: TO BE REMOVED
RMN: TO REMAIN
REL: TO BE RELOCATED
ADD: TO BE ADDED

CABLE LENGTHS FOR JUMPERS

JUNCTION BOX TO RRU: 15'
RRU TO ANTENNA: 10'

FINAL ANTENNA SCHEDULE									
LOCATION			ANTENNA SUMMARY				NON ANTENNA SUMMARY		
SECTOR	RAD	AZ	POS	ANTENNA	BAND	MECH/ELEC D-TILT	STATUS	ADDITIONAL TOWER MOUNTED EQUIPMENT	STATUS
ALPHA	180°	60°	A1	VV-65A-R1	L2100/L1900/G1900	0/2/2	ADD	Radio 4460 B25+B66	ADD
			A2	APXVAALL24 43-U-NA20	L700/L600/N600	0/2/2/2/2	ADD	Radio 4480 B71+B85A	ADD
			A3	Air6449 B41	L2500/N2500	0/2/2	ADD	-	-
			A4	-	-	-	-	-	-
BETA	180°	180°	B1	VV-65A-R1	L2100/L1900/G1900	0/2/2	ADD	Radio 4460 B25+B66	ADD
			B2	APXVAALL24 43-U-NA20	L700/L600/N600	0/2/2/2/2	ADD	Radio 4480 B71+B85A	ADD
			B3	Air6449 B41	L2500/N2500	0/2/2	ADD	-	-
			B4	-	-	-	-	-	-
GAMMA	180°	320°	C1	VV-65A-R1	L2100/L1900/G1900	0/2/2	ADD	Radio 4460 B25+B66	ADD
			C2	APXVAALL24 43-U-NA20	L700/L600/N600	0/2/2/2/2	ADD	Radio 4480 B71+B85A	ADD
			C3	Air6449 B41	L2500/N2500	0/2/2	ADD	-	-
			C4	-	-	-	-	-	-

EXISTING FIBER DISTRIBUTION/OVP BOX		EXISTING CABLING SUMMARY		
MODEL NUMBER	STATUS	COAX	HYBRID	STATUS
-	-	(6) 1-5/8"	(2) 1-1/4"	RMV

3 EQUIPMENT SCHEDULES

FINAL FIBER DISTRIBUTION / OVP BOX		FINAL CABLING SUMMARY		
MODEL NUMBER	STATUS	COAX	HYBRID	STATUS
-	-	-	(3) 1.99" 6/24 4AWG	ADD



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REV.	DESCRIPTION	BY	DATE
A	PRELIM	DEH	08/12/21
0	FOR CONSTRUCTION	RMD	09/10/21
1	FOR CONSTRUCTION	RMD	10/29/21

ATC SITE NUMBER:
302465

ATC SITE NAME:
COLCHESTER CT 6

SPRINT SITE NAME:
CTHA359A

SITE ADDRESS:
355 ROUTE 85
COLCHESTER, CT 06415

SEAL:

Eric Anderson
32224
PROFESSIONAL ENGINEER

Digitally signed by Eric Anderson
Date: 2021.10.29 11:49:09-04'00'

COA: JPC.0000131




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ATC JOB NO:	13711921_G3
CUSTOMER ID:	CTHA359A
CUSTOMER #:	CTHA359A


ANTENNA INFORMATION & SCHEDULE

SHEET NUMBER: C-401	REVISION: 1
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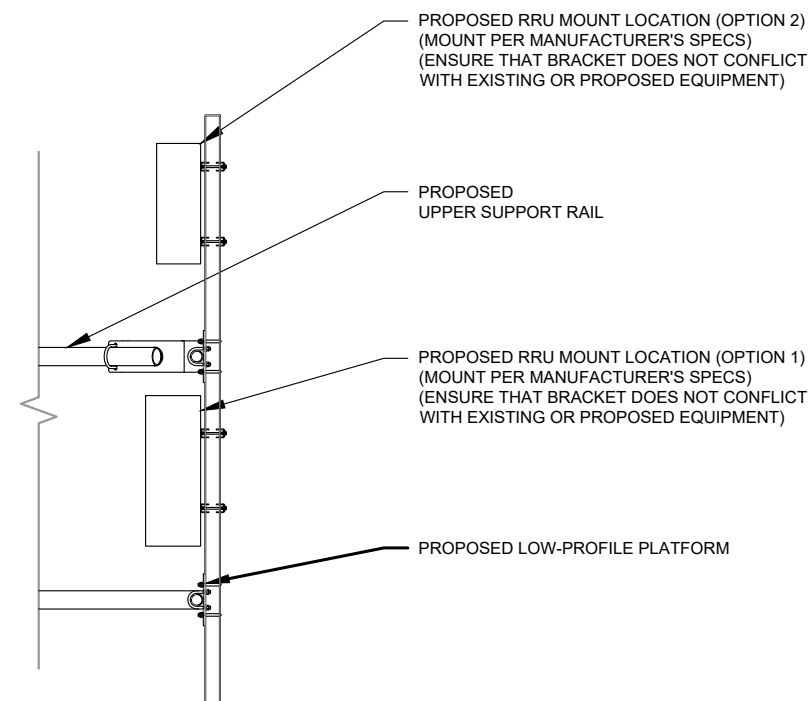
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1 PROPOSED ANTENNA MOUNTING DETAIL - TYPICAL
SCALE: NOT TO SCALE

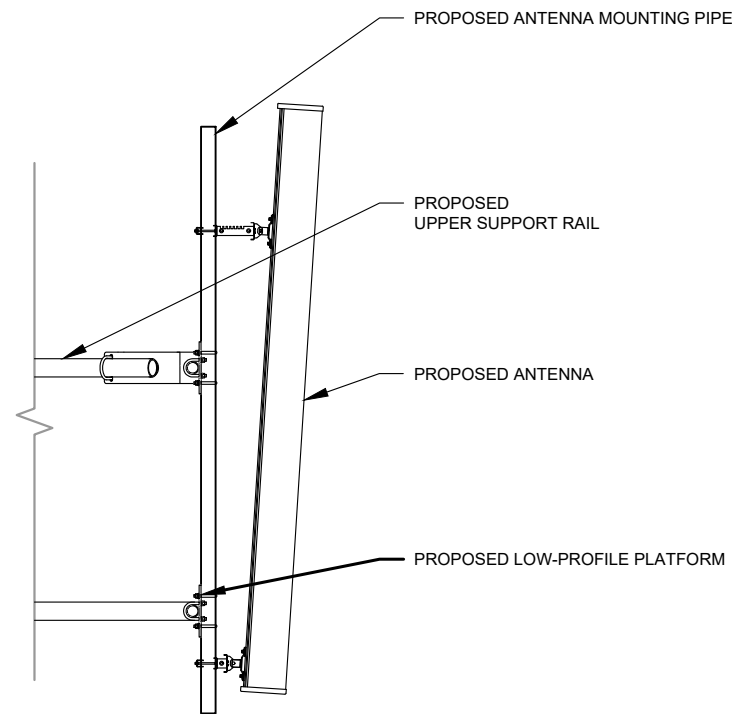

2 PROPOSED 5G ANTENNA MOUNTING DETAIL - TYPICAL
SCALE: N.T.S.

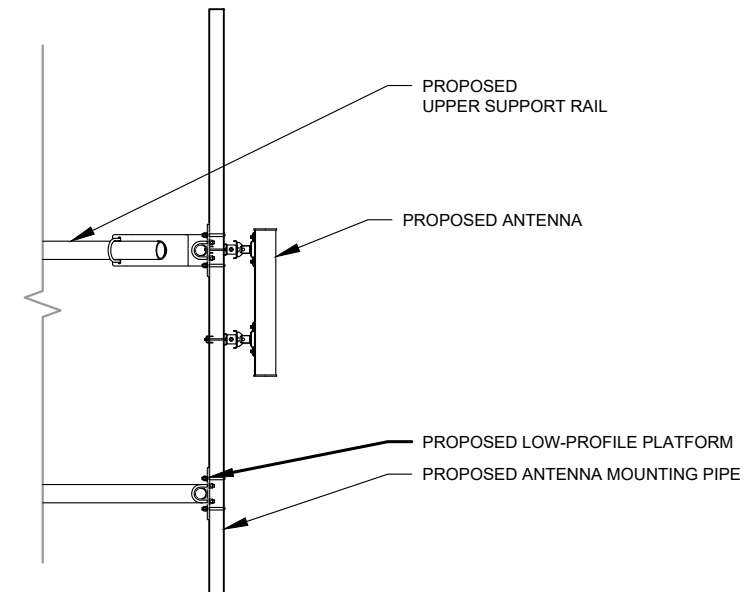

3 PROPOSED RRU MOUNTING DETAIL - TYPICAL
SCALE: N.T.S.



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REV.	DESCRIPTION	BY	DATE
A	PRELIM	DEH	08/12/21
0	FOR CONSTRUCTION	RMD	09/10/21
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COLCHESTER CT 6

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355 ROUTE 85
COLCHESTER, CT 06415

SEAL:



COA: JPC.0000131




DATE DRAWN:	08/12/21
ATC JOB NO:	13711921_G3
CUSTOMER ID:	CTHA359A
CUSTOMER #:	CTHA359A

CONSTRUCTION
DETAILS

SHEET NUMBER:	REVISION:
C-501	1


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NOTES:

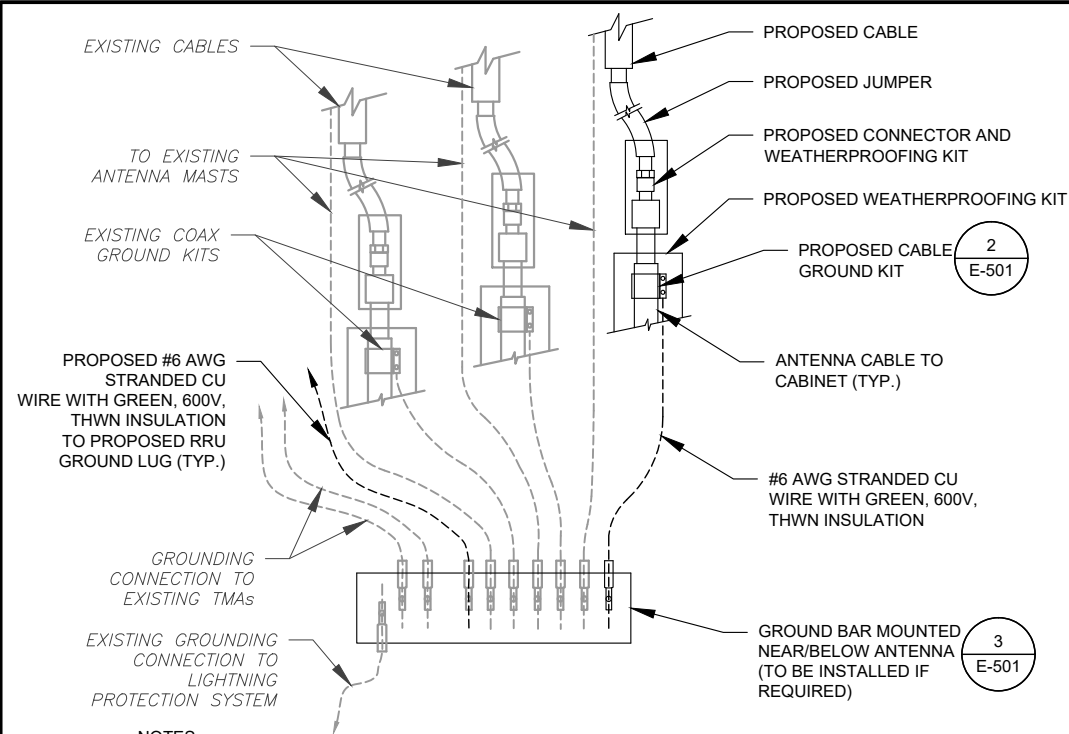1. THIS DETAIL IS INTENDED TO SHOW THE GENERAL GROUNDING REQUIREMENTS. SLIGHT ADJUSTMENTS MAY BE REQUIRED BASED ON EXISTING SITE CONDITIONS. THE CONTRACTOR SHALL MAKE FIELD ADJUSTMENTS AS NEEDED AND INFORM THE CONSTRUCTION MANAGER OF ANY CONFLICTS.
2. SITE GROUNDING SHALL COMPLY WITH SPRINT GROUNDING STANDARDS, LATEST EDITION, AND COMPLY WITH SPRINT GROUNDING CHECKLIST, LATEST VERSION. WHEN NATIONAL AND LOCAL GROUNDING CODES ARE MORE STRINGENT THEY SHALL GOVERN.


1 TYPICAL ANTENNA GROUNDING DIAGRAM
SCALE: N.T.S.



GROUND KIT NOTES:

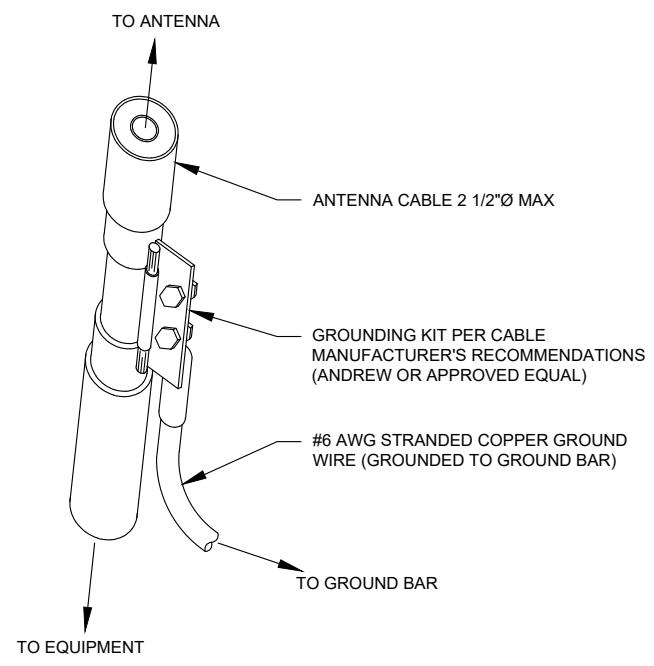1. DO NOT INSTALL CABLE GROUND KIT AT A BEND AND ALWAYS DIRECT GROUND WIRE DOWN TO GROUND BAR.
2. CONTRACTOR SHALL PROVIDE WEATHERPROOFING KIT (ANDREW PART NUMBER 221213) AND INSTALL/TAPE PER MANUFACTURER'S SPECIFICATIONS.

2 CABLE GROUND KIT CONNECTION DETAIL
SCALE: N.T.S.

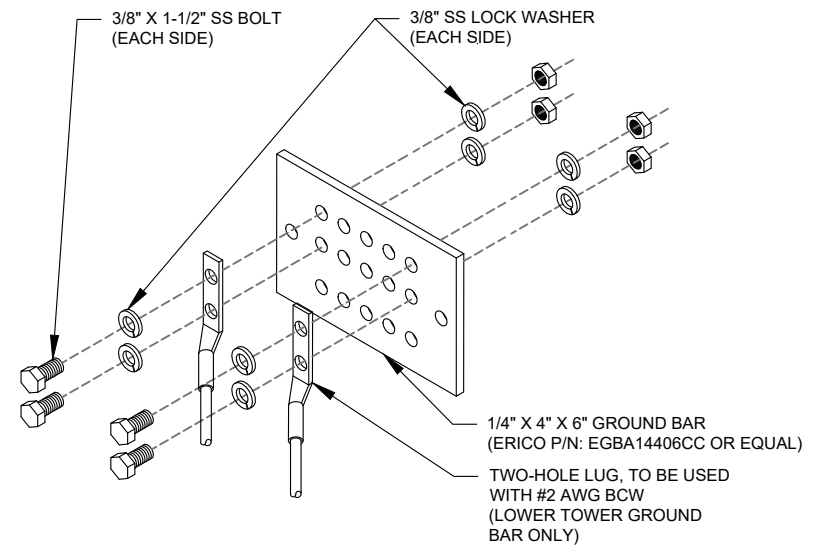

GROUND BAR NOTES:


1. GROUND BAR KITS COME WITH ALL HARDWARE, NUTS, BOLTS, WASHERS, ETC. EXCEPT THE STRUCTURAL MOUNTING MEMBER(S).
2. GROUND BAR TO BE BONDED DIRECTLY TO TOWER.

3 TOWER GROUND BAR DETAIL
SCALE: N.T.S.

ELECTRICAL NOTES:

1. IT IS THE RESPONSIBILITY OF THE CONTRACTOR TO COORDINATE WITH THE T-MOBILE REPRESENTATIVE AND LOCAL UTILITY COMPANY FOR THE INSTALLATION OF CONDUITS, CONDUCTORS, BREAKERS, DISCONNECTS, OR ANY OTHER EQUIPMENT REQUIRED FOR ELECTRICAL SERVICE. ALL ELECTRICAL WORK SHALL BE PERFORMED IN ACCORDANCE WITH LATEST EDITION OF THE STATE AND NATIONAL CODES, ORDINANCES AND REGULATIONS APPLICABLE TO THIS PROJECT.
2. ATC HAS NOT VERIFIED ANY EXISTING T-MOBILE GROUND EQUIPMENT OR ELECTRICAL LOADING. PROPOSED WORK BASED ON INSTALLATION CONFIGURATION PROVIDED BY T-MOBILE. CONTRACTOR TO VERIFY EXISTING T-MOBILE PANEL HAS SUFFICIENT SPACE FOR PROPOSED BREAKER. PROPOSED CABLE AND CONDUIT SHALL BE MINIMUM SIZE PER BELOW IN CHART.
3. FOR SPECIFIC CABINET / ANCILLARY EQUIPMENT WIRING REQUIREMENTS, THE T-MOBILE CONTRACTOR SHOULD REFERENCE DESIGN DOCUMENTS PROVIDED BY T-MOBILE FOR THIS CURRENT PROJECT CONFIGURATION, IN ACCORDANCE WITH LOCAL JURISDICTION REQUIREMENTS & NEC STANDARDS & PRACTICES.

OCPD SIZE	WIRE SIZE	GROUND SIZE	CONDUIT SIZE
80A/2P	2#3 AWG	#8 AWG	1-1/4"
100/2P	2#2 AWG	#8 AWG	1-1/4"
125A/2P	2#1 AWG	#8 AWG	1-1/2"
150A/2P	2#1/0 AWG	#8 AWG	1-1/2"

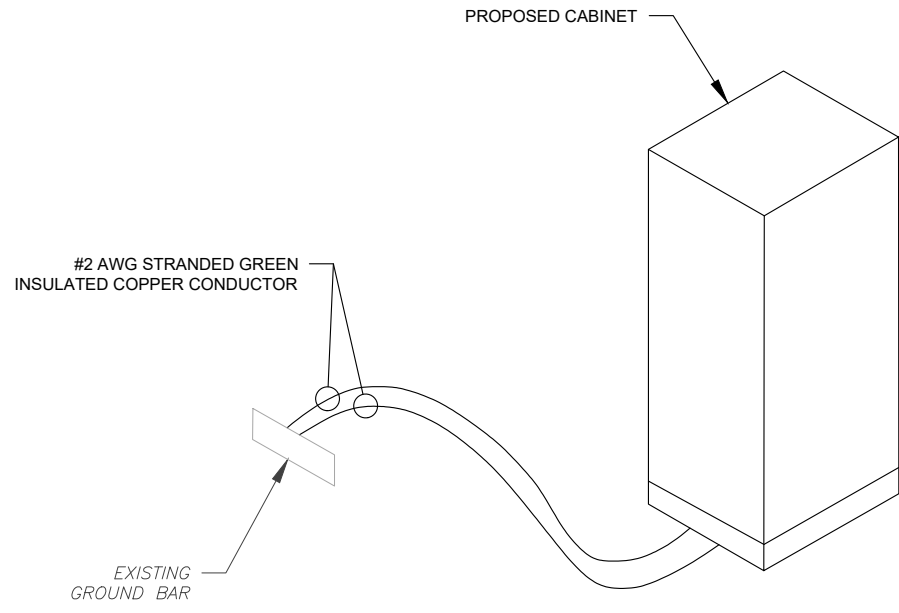

4 CABINET GROUNDING DETAIL
SCALE: N.T.S.



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A	PRELIM	DEH	08/12/21
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COLCHESTER, CT 06415

SEAL:



COA: JPC.0000131



DATE DRAWN:	08/12/21
ATC JOB NO:	13711921_G3
CUSTOMER ID:	CTHA359A
CUSTOMER #:	CTHA359A


GROUNDING DETAILS

SHEET NUMBER:
E-501

REVISION:
1

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- NOTES:
1. ALL ELECTRICAL WORK SHALL CONFORM TO THE REQUIREMENTS OF THE 2017 EDITION OF NATIONAL ELECTRICAL CODE (NEC), NATIONAL ELECTRICAL SAFETY CODE, NAPA, NETA, OSHA, AND ALL OTHER EXISTING CODES AND REGULATIONS OF AUTHORITIES WHICH WOULD HAVE JURISDICTION.
 2. ALL NEW WIRING SHALL BE WITH THWN-2 OR XHHW-2 INSULATION AND RATED FOR 75 DEG CELSIUS.
 3. ALL UNDERGROUND CONDUIT SHALL BE PVC SCH40. ALL ABOVE GROUND CONDUIT SHALL BE PVC SCH80 OR RMC.

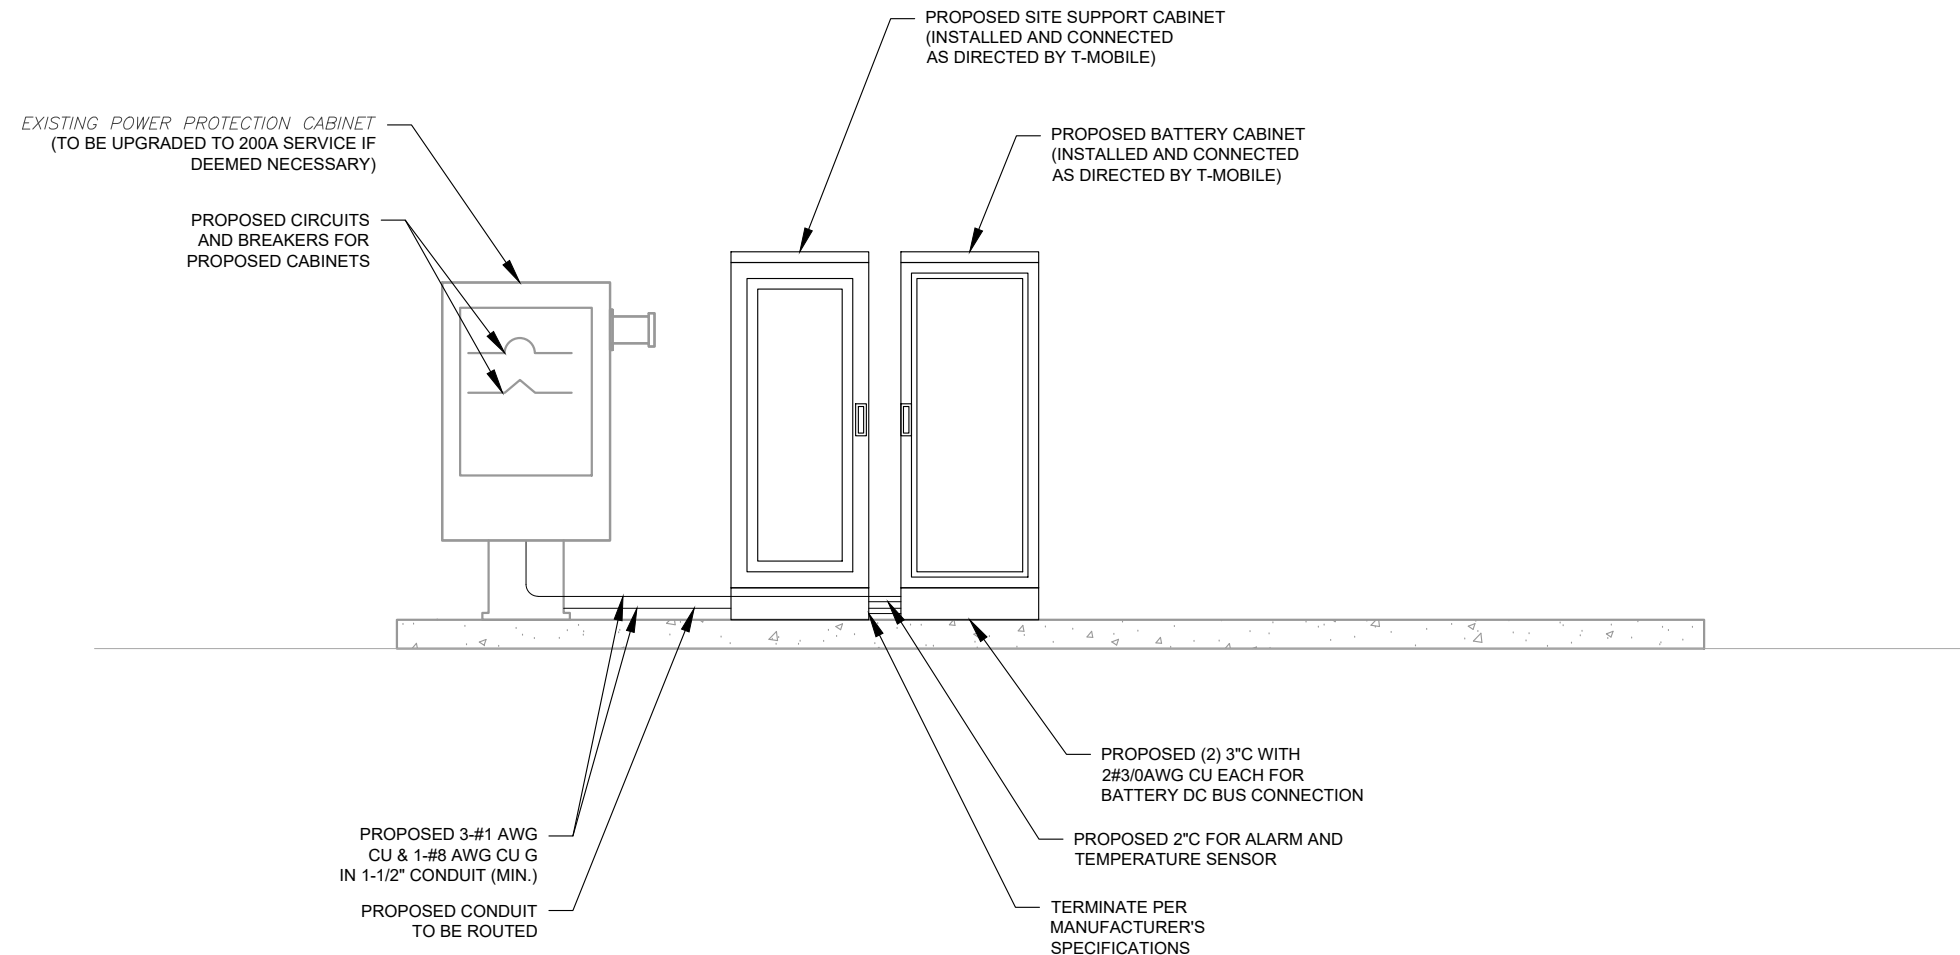

- ELECTRICAL NOTES:
1. THIS DIAGRAM REPRESENTS THE BEST PRESENT KNOWLEDGE AVAILABLE TO THE ENGINEER AT THE TIME OF THIS DESIGN. THE CONTRACTOR SHALL VISIT THE SITE PRIOR TO CONSTRUCTION AND VERIFY ALL EXISTING CONDITIONS RELATED TO THE SCOPE OF WORK FOR THIS PROJECT.
 2. IT IS THE RESPONSIBILITY OF THE CONTRACTOR TO COORDINATE WITH THE SPRINT REPRESENTATIVE AND LOCAL UTILITY COMPANY FOR THE INSTALLATION OF CONDUITS, CONDUCTORS, BREAKERS, DISCONNECTS, OR ANY OTHER EQUIPMENT REQUIRED FOR ELECTRICAL SERVICE. ALL ELECTRICAL WORK SHALL BE PERFORMED IN ACCORDANCE WITH LATEST EDITION OF THE STATE AND NATIONAL CODES, ORDINANCES AND REGULATIONS APPLICABLE TO THIS PROJECT.
 3. ATC HAS NOT YET VERIFIED ANY EXISTING SPRINT GROUND EQUIPMENT OR ELECTRICAL LOADING. PROPOSED WORK BASED ON INSTALLATION CONFIGURATION PROVIDED BY SPRINT. CONTRACTOR TO VERIFY EXISTING SPRINT PANEL HAS SUFFICIENT SPACE FOR PROPOSED BREAKER.

1 ELECTRICAL UPGRADE DIAGRAM
SCALE: NOT TO SCALE



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SEAL:

Eric Anderson
32224
PROFESSIONAL ENGINEER

Digitally signed by Eric Anderson
Date: 2021.10.29 11:49:17-0400

COA: JPC.0000131



DATE DRAWN:	08/12/21
ATC JOB NO:	13711921_G3
CUSTOMER ID:	CTHA359A
CUSTOMER #:	CTHA359A

ELECTRICAL DETAILS

SHEET NUMBER: E-502	REVISION: 1
-------------------------------	-----------------------

6/16/2021

CTHA359A_Sprint Retain_1_draft_2021-06-16

RAN Template: 67E5A998E 6160
 A&L Template: 67E5998E_1xAIR+1OP+1QP

CTHA359A_Sprint Retain_1_draft

Print Name: Standard

Section 5 - RAN Equipment

Existing RAN Equipment

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Proposed RAN Equipment


Template: 67E5A998E 6160

Enclosure	1	2	3
Enclosure Type	Enclosure 6160	RBS 6601	B160
Baseband	BB 6648 L700 L600 N600	BB 6648 L2500 N2500	BB 6648 L2100 L1900
Transport System	CSR IXRe V2 (Gen2)	DUG20 G1900	
Functionality Groups	Ericsson Hybrid Trunk 6/24 4AWG *Select Length* (x 3)		

RAN Scope of Work:

CT73XC017
 Existing azimuth 70/180/320
 New azimuth 60/180/320
 Existing 200A
 Previous TMO unfinished NSD CTHA059

67E5A998E.JPG

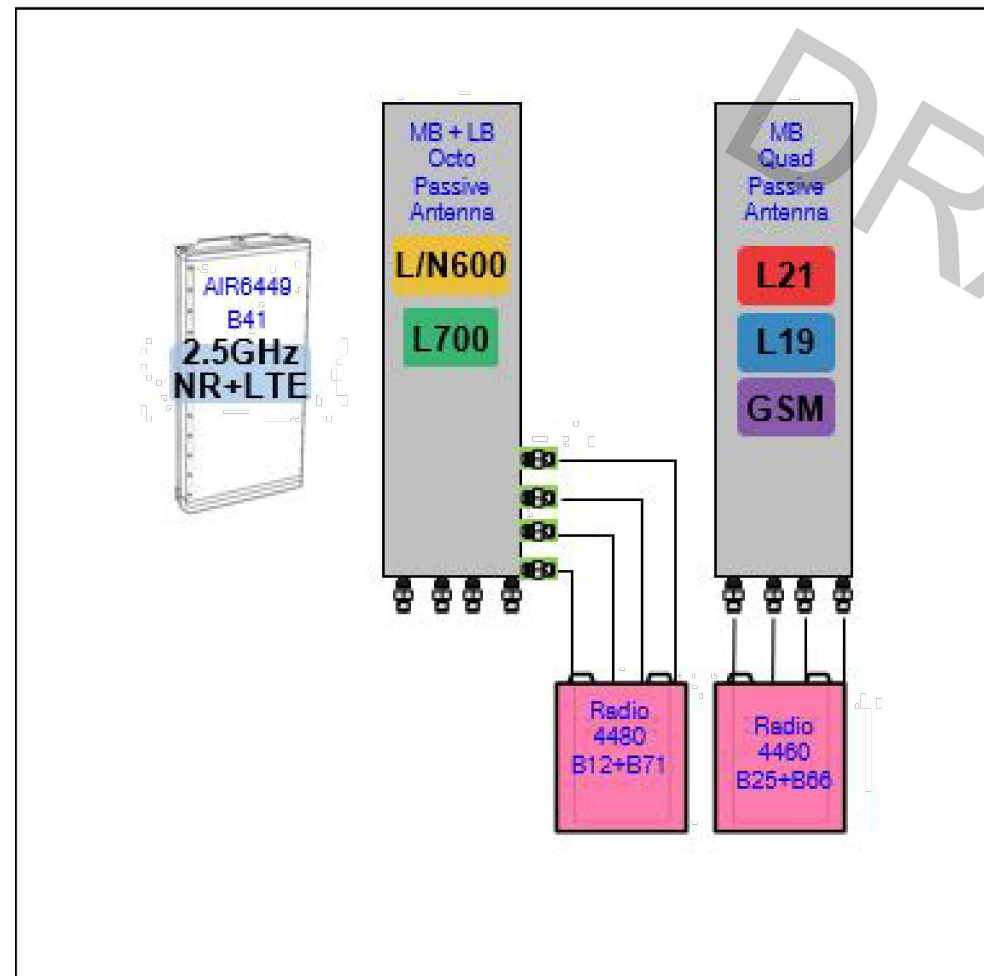


Notes:

2 ANTENNA CONFIGURATION
 SCALE: NOT TO SCALE


SUPPLEMENTAL

SHEET NUMBER: R-601 REVISION: -

NOTE: THIS SHEET CREATED BY OTHERS AND PROVIDED BY REQUEST OF CUSTOMER WITHOUT EDIT.

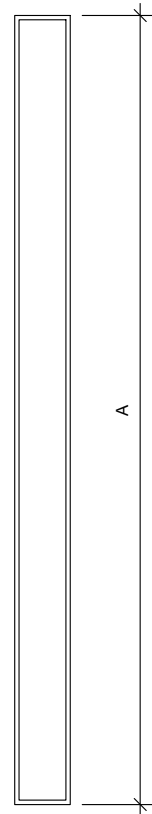


FRONT VIEW

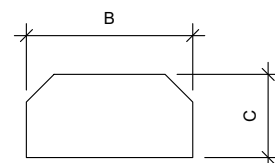


TOP VIEW

1 ANTENNA SPECIFICATIONS
FOR ILLUSTRATIVE PURPOSES ONLY - NOT TO SCALE

ANTENNA SPECIFICATIONS				
ANTENNA MODEL	A	B	C	WEIGHT (LBS)
AIR6449 B41	33.1"	20.6"	8.6"	104.0
VV-65A-R1	54.7"	12.1"	4.6"	23.8
APXVAALL24_43-U-NA20	95.9"	24.0"	8.5"	122.8

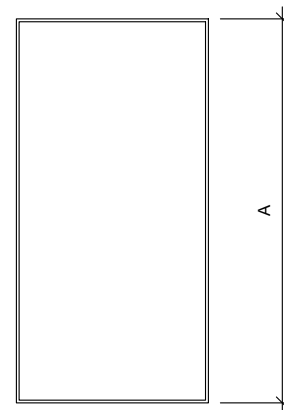

FRONT VIEW

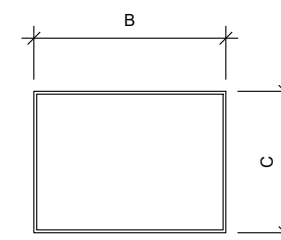

TOP VIEW


2 RRU SPECIFICATIONS
FOR ILLUSTRATIVE PURPOSES ONLY - NOT TO SCALE

RRU SPECIFICATIONS				
RRU MODEL	A	B	C	WEIGHT (LBS)
RADIO 4460 B25+B66	19.6"	15.7"	12.1"	75.0
RADIO 4480 B71+B85	16.5"	13.4"	5.9"	46


SUPPLEMENTAL

SHEET NUMBER: **R-602** REVISION: -


Enclosure B160

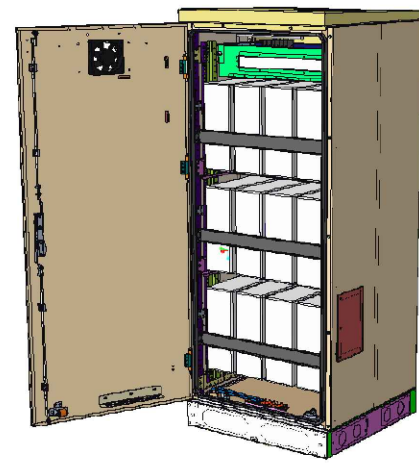

Enclosure B160
AirCon + VRLA

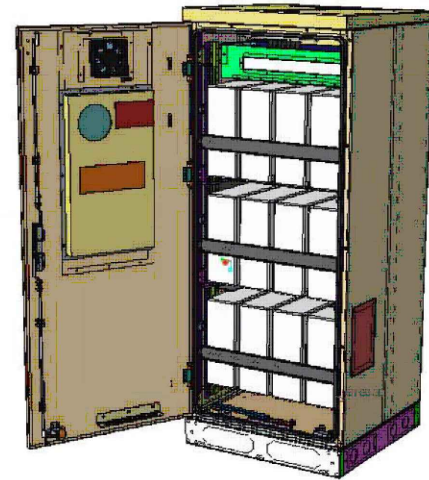

Enclosure B160
AirCon + Li-Ion

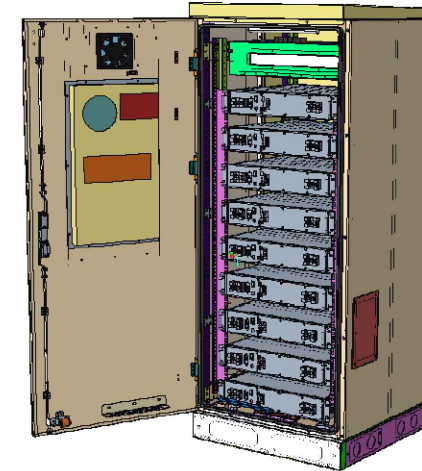

Enclosure B160
Convection Cooling
+ VRLA

PA1 | 2019-02-03 | Ericsson Confidential | Page 1

Enclosure B160

Capacity

- VRLA 12V: 100Ah / 150Ah / 170Ah / 190Ah / 210Ah
- Li-Ion: 24U 19" / 23"
- Sodium-Nickel: 3x FIAMM

Electrical specification

- DC Output: -48VDC/200A
- Battery breakers: 2x 125/2p
- Alarms: Door open, Climate failure, MCB Connection

Mechanical specification

- Weight: 134kg
- Dimensions: 63 x 26 x 26 in. (incl. Base frame)
- Base frame height: 6 in.
- Material: Galvanized steel (180g/m²)
- Color: Powder paint NCS 2002-B
- Door: Front access
- Locking type: Pad lock / cylinder

Environmental specification

- Ingress protection: VRLA/Sodium IP44
Li-Ion IP55
 - Relative humidity: 15-100%
- ## Climate system
- Air Conditioner
 - Fan type: DC
 - Cooling capacity: 500W @L35/L35
 - Convection cooling
 - Emergency fan

PA1 | 2019-02-03 | Ericsson Confidential | Page 2

SUPPLEMENTAL

SHEET NUMBER:

R-603

REVISION:

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Enclosure 6160 AC

The Enclosure 6160 is a multi-purpose site cabinet designed to support a multitude of equipment such as ERS Baseband, Transport, Li-Ion battery and 3PP vendor equipment. It also provides a highly capable power system and battery back-up - all in a streamlined design and minimized footprint to support cost efficient expansion of mobile broadband.

Being an all-in-one enclosure, the Enclosure 6160 is a very fitting choice for all types of sites where the capacity need is large or room for future expansion is needed. It is ideally used for modernizing existing sites or in greenfield scenarios to match both current and future needs.

With a robust design, IP65 compliance and a sealed Heat Exchanger (HEX) climate system the Enclosure 6160 ensures optimal environmental protection of the active equipment - enabling them for a long-lasting service. The complete system is also integrated and verified for the entire Ericsson Radio System and ensures best-in-class service.

The power system offers 31,5kW of power in total and provides 24kW of -48V DC power for both internal and external consumers.

The equipment space allows 19U of rack space ensuring well enough capacity for existing need and future expansion.

One of the main advantages of the Enclosure 6160 is its default integration with ENM - allowing for advanced remote monitoring and control such as fault management (alarms), inventory management and performance measurements. The cabinet also provides an open O&M interface for integration to 3PP O&M systems.



Preliminary technical specification for Enclosure 6160 AC

CAPACITY

Rack space user equipment	19U (19" rack)
Hardware capabilities	Power and CPRI support for multi-standard remote radios (RRU or AIR) ERS Baseband and Transport units Li-Ion batteries 3PP equipment Additional power feed available as option

MECHANICAL SPECIFICATION

Weight	145 kg (excluding active equipment) 320 lbs (excluding active equipment)
Dimension (H x W x D)	1600 x 650 x 650 mm (incl. Base frame) 63 x 26 x 26 in. (incl. Base frame)
Base frame height	150 mm 6 in.
Mounting position	Ground
Enclosure material	Aluminum
Color	Power paint NCS 2002-B
Door	Front access
Rack type	19" (IEC 60297-3-100)
Locking type	Pad lock or Cylinder

POWER SYSTEM

Input voltage	3P+N+PE: 346/200-415/240 VAC 2P+N+PE: 208/120-220/127 VAC 1P+N+PE: 200-250 VAC
Input power	<33kW
Output load (-48VDC)	24kW
Total capacity (-48VDC)	31.5kW
AC SPD	Class 2/Type 2
DC SPD	Class 2/Type 2
PSU Slots	9x
Service outlet	Optional
Priority load	8x Circuit Breaker
LLVD 1	6x Circuit Breaker
LLVD 2	6x Circuit Breaker
CB ratings	3A / 5A / 10A / 15A / 20A / 25A / 30A / 40A / 50A / 60A / 80A / 100A
Battery Interface	2x Circuit Breaker
Battery Circuit Breaker rating	125A 2pol (200A)
PSU capacity	3500W

SUPPLEMENTAL

SHEET NUMBER:

R-604

REVISION:

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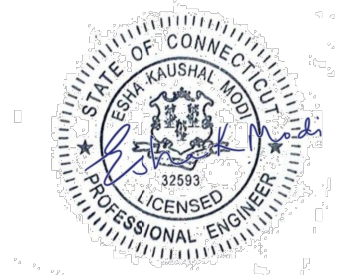
Eng. Number 13711921_C8_07
 October 25, 2021
 Page 2

Mount Analysis Report

ATC Site Name : Colchester CT 6, CT
ATC Site Number : 302465
Engineering Number : 13711921_C8_07
Mount Elevation : 180 ft
Carrier : Sprint Nextel
Carrier Site Name : CTHA359A
Carrier Site Number : CTHA359A
Site Location : 355 Route 85
 Colchester, CT 06415-1825
 41.54481944 , -72.30489167
County : New London
Date : October 25, 2021
Max Usage : 52%
Result : Pass

Prepared By:
 Jayon Woodard
 Structural Engineer

Reviewed By:



Authorized by "EOR"
 27 Oct 2021 04:52:10

COA: PEC.0001553

Application Loading

Mount Centerline (ft)	Equipment Centerline (ft)	Qty	Equipment Manufacturer & Model
180.0	180.0	3	Commscope VV-65A-R1
		3	Ericsson Air6449 B41
		3	RFS APXVAALL24 43-U-NA20
		3	Ericsson Radio 4480 B71+B85A
		3	Ericsson Radio 4460 B25+B66

Structure Usages

Structural Component	Controlling Usage	Pass/Fail
Horizontals	32%	Pass
Mount Pipes	52%	Pass




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SUPPLEMENTAL

SHEET NUMBER: R-605	REVISION: -
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PV-LPPGS MONOPOLE GUARDIAN MOUNT

SEE SHEET 2 - TABLE 1 FOR FULL CONFIGURATION DETAILS



SHEET	THIRD ANGLE PROJECTION	CATEGORY	9	ACC1 REPLACE ACC2, PV-CMX-CG-BO REPLACE	3/16/21	PERFECT VISION
1 OF 16		02_Monopole	9	115-242		
4/27/2021	SCALE 1:36	SERIES	8	KKGS UPDATE	2/2/21	MONOPOLE GUARDIAN MOUNT
		01_Triangular	8			
		TYPE	7	REPLACED PKBK WITH PV-KKRS	11/11/20	DOCUMENT NUMBER
		BY	6	ADDED ALL THREAD NOTE TO COLLARS	7/27/20	LPPGS-ENG-01-R9
		CHECKED	5	ADDED HR2-AP3 CONFIGS	1/20/20	REV
		STATUS	APPROVED	REV	DESCRIPTION	DATE
DIMENSIONS ARE IN INCHES TOLERANCES U.N.O. HOLES: +1/16", -1/32" ANGULAR: PROFILE ±1/4", BEND ±2° ALL OTHERS: ±1/16"						9

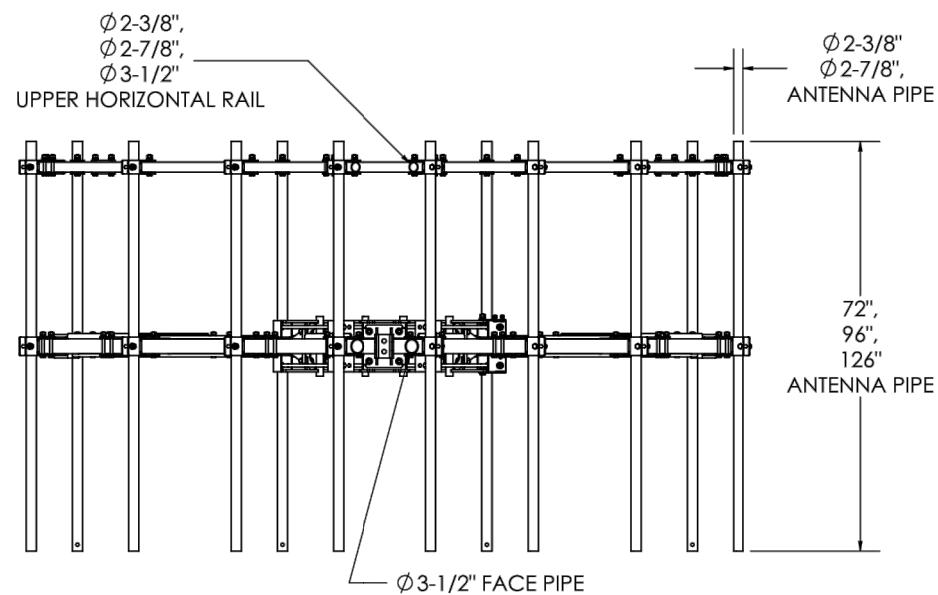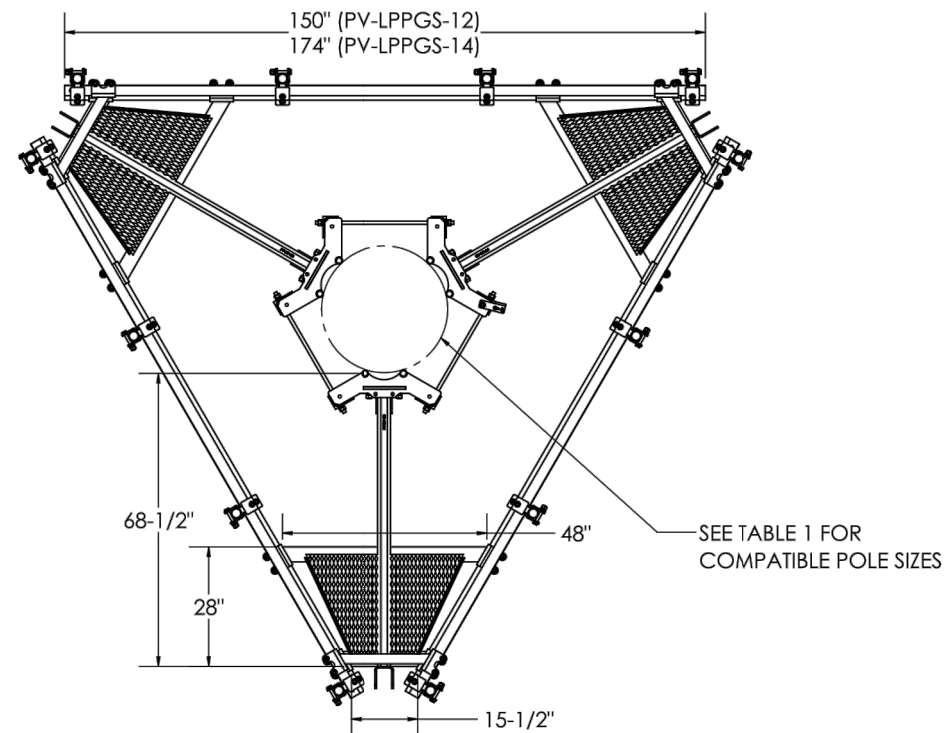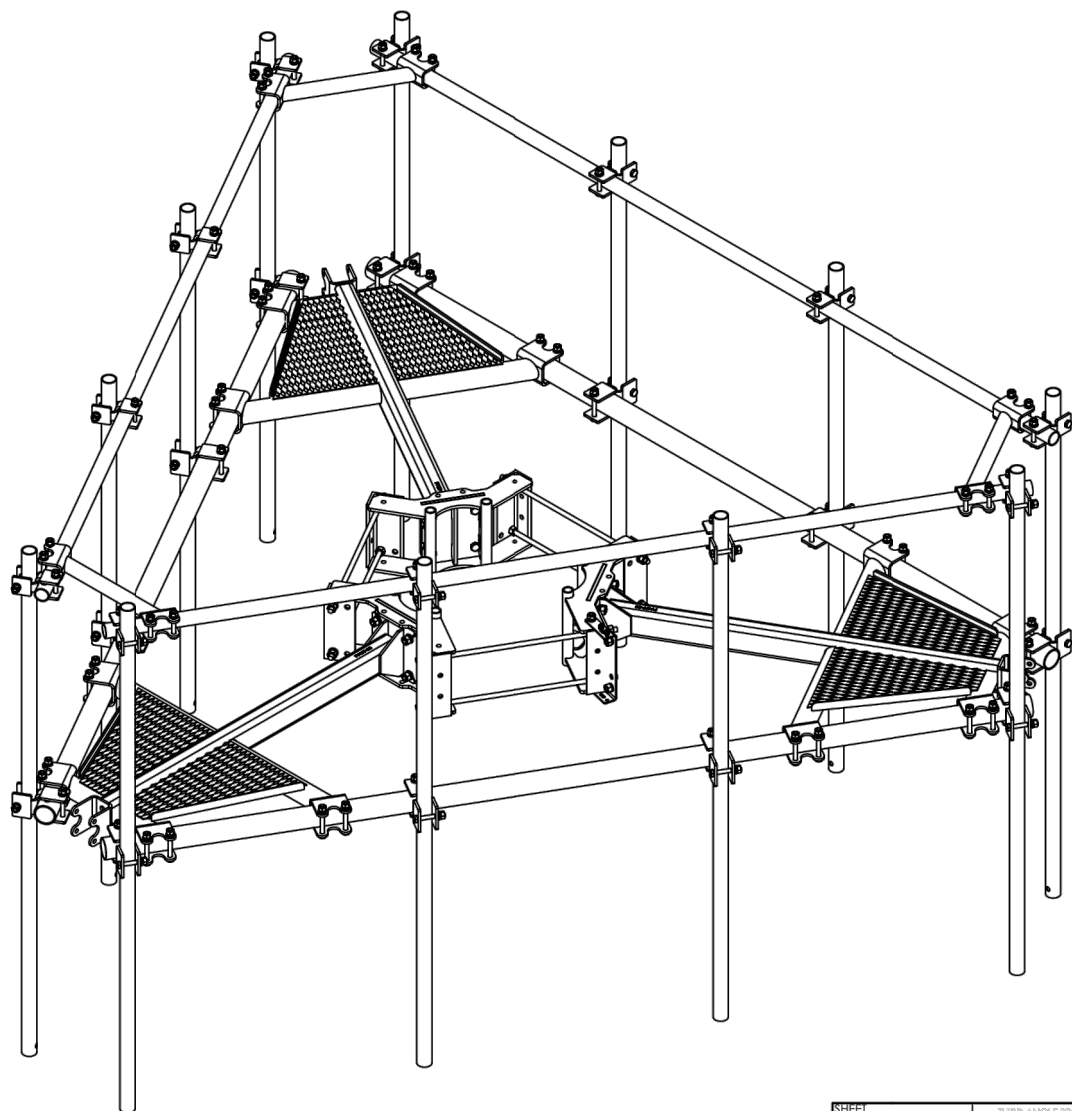C:\PVA\Steel\Catalog_SW Working Files\Engineering Details\

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1 MOUNT SPECIFICATIONS

SUPPLEMENTAL

SHEET NUMBER:
R-606

REVISION:
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