

Daniel F. Caruso
Chairman

STATE OF CONNECTICUT

CONNECTICUT SITING COUNCIL

Ten Franklin Square, New Britain, CT 06051

Phone: (860) 827-2935 Fax: (860) 827-2950

E-Mail: siting.council@ct.gov

Internet: ct.gov/csc

April 30, 2009

Steven L. Levine
Real Estate Consultant
New Cingular Wireless PCS, LLC
500 Enterprise Drive
Rocky Hill, CT 06067-3900

RE: **EM-CING-019-090403** - New Cingular Wireless PCS LLC notice of intent to modify an existing telecommunications facility located at 50 Tiffany Road, Brooklyn, Connecticut.

Dear Mr. Levine:

The Connecticut Siting Council (Council) hereby acknowledges your notice to modify this existing telecommunications facility, pursuant to Section 16-50j-73 of the Regulations of Connecticut State Agencies with the following conditions:

- The reinforcements recommended in the structural analysis dated April 2, 2009 shall be performed prior to the antenna swap;
- The water tank shall not exceed 100 percent of its post-construction structural rating; and
- A signed letter from a Professional Engineer duly licensed in the State of Connecticut shall be submitted to the Council to certify that the reinforcements were properly completed and the water tank does not exceed 100 percent of its post-construction structural rating.


The proposed modifications are to be implemented as specified here and in your notice dated April 3, 2009, including the placement of all necessary equipment and shelters within the tower compound. The modifications are in compliance with the exception criteria in Section 16-50j-72 (b) of the Regulations of Connecticut State Agencies as changes to an existing facility site that would not increase tower height, extend the boundaries of the tower site, increase noise levels at the tower site boundary by six decibels, and increase the total radio frequencies electromagnetic radiation power density measured at the tower site boundary to or above the standard adopted by the State Department of Environmental Protection pursuant to General Statutes § 22a-162. This facility has also been carefully modeled to ensure that radio frequency emissions are conservatively below State and federal standards applicable to the frequencies now used on this tower.

This decision is under the exclusive jurisdiction of the Council. Please be advised that the validity of this action shall expire one year from the date of this letter. Any additional change to this facility will require explicit notice to this agency pursuant to Regulations of Connecticut State Agencies Section 16-50j-73. Such notice shall include all relevant information regarding the proposed change with cumulative worst-case modeling of radio frequency exposure at the closest point of uncontrolled access to the tower base, consistent with Federal Communications Commission, Office of Engineering and Technology, Bulletin 65.

Any deviation from this format may result in the Council implementing enforcement proceedings pursuant to General Statutes § 16-50u including, without limitation, imposition of expenses resulting from such failure and of civil penalties in an amount not less than one thousand dollars per day for each day of construction or operation in material violation.

Thank you for your attention and cooperation.


Very truly yours,

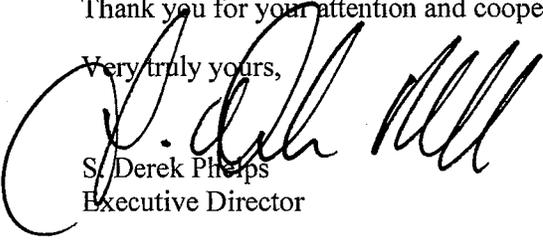

S. Derek Phelps
Executive Director

SDP/MP/laf

c: The Honorable Roger Engle, First Selectman, Town of Brooklyn
Chester Dobrowski, Zoning Enforcement Officer, Town of Brooklyn
Mark Yellin

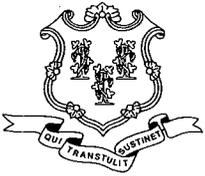

STATE OF CONNECTICUT

CONNECTICUT SITING COUNCIL

Ten Franklin Square, New Britain, CT 06051

Phone: (860) 827-2935 Fax: (860) 827-2950

E-Mail: siting.council@ct.gov

www.ct.gov/csc

April 6, 2009

The Honorable Roger Engle
First Selectman
Town of Brooklyn
Town Hall
P. O. Box 356
Brooklyn, CT 06234-0356

RE: **EM-CING-019-090403** - New Cingular Wireless PCS LLC notice of intent to modify an existing telecommunications facility located at 50 Tiffany Road, Brooklyn, Connecticut.


Dear Mr. Engle:

The Connecticut Siting Council (Council) received this request to modify an existing telecommunications facility, pursuant to Regulations of Connecticut State Agencies Section 16-50j-72.

If you have any questions or comments regarding this proposal, please call me or inform the Council by April 20, 2009.

Thank you for your cooperation and consideration.

Very truly yours,

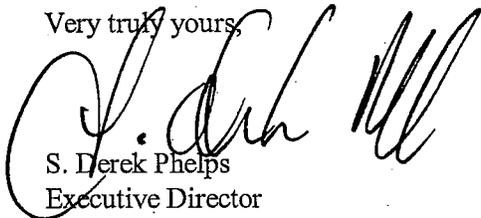

S. Derek Phelps
Executive Director

SDP/jb

Enclosure: Notice of Intent

c: Chester Dobrowski, Zoning Enforcement Officer, Town of Brooklyn

EM-CING-019-090403



Cingular Wireless PCS, LLC
500 Enterprise Drive
Rocky Hill, Connecticut 06067-3900
Phone: (860) 513-7636
Fax: (860) 513-7190

Steven L. Levine
Real Estate Consultant

HAND DELIVERED

April 3, 2009

ORIGINAL

RECEIVED
APR - 3 2009

CONNECTICUT
SITING COUNCIL

Honorable Daniel F. Caruso, Chairman,
and Members of the Connecticut Siting Council
Connecticut Siting Council
10 Franklin Square
New Britain, Connecticut 06051

Re: New Cingular Wireless PCS, LLC notice of intent to modify an existing tele-communications facility located at 50 Tiffany Road, Brooklyn (owner, Mark Yellin)

Dear Chairman Caruso and Members of the Council:

In order to accommodate technological changes, implement Uniform Mobile Telecommunications System ("UMTS") capability, and enhance system performance in the State of Connecticut, New Cingular Wireless PCS, LLC ("AT&T") plans to modify the equipment configurations at many of its existing cell sites. Please accept this letter and attachments as notification, pursuant to R.C.S.A. Section 16-50j-73, of construction which constitutes an exempt modification pursuant to R.C.S.A. Section 16-50j-72(b)(2). In compliance with R.C.S.A. Section 16-50j-73, a copy of this letter and attachments is being sent to the chief elected official of the municipality in which the affected cell site is located.

UMTS technology offers services to mobile computer and phone users anywhere in the world. Based on the Global System for Mobile (GSM) communication standard, UMTS is the planned worldwide standard for mobile users. UMTS, fully implemented, gives computer and phone users high-speed access to the Internet as they travel. They have the same capabilities even when they roam, through both terrestrial wireless and satellite transmissions.

Attached is a summary of the planned modifications, including power density calculations reflecting the change in AT&T's operations at the site. Also included is documentation of the structural sufficiency of the tower to accommodate the revised antenna configuration.

The changes to the facility do not constitute modifications as defined in Connecticut General Statutes ("C.G.S.") Section 16-50i(d) because the general physical characteristics of the facility will not be significantly changed or altered. Rather, the planned changes to the facility fall

squarely within those activities explicitly provided for in R.C.S.A. Section 16-50j-72(b)(2).

1. The height of the overall structure will be unaffected.
2. The proposed changes will not extend the site boundaries. There will be no effect on the site compound other than some enlarged equipment pads as may be noted in the attachments.
3. The proposed changes will not increase the noise level at the existing facility by six decibels or more.
4. Radio frequency power density may increase due to use of one or more GSM channel for UMTS transmissions. However, the changes will not increase the calculated "worst case" power density for the combined operations at the site to a level at or above the applicable standard for uncontrolled environments as calculated for a mixed frequency site.

For the foregoing reasons, New Cingular Wireless respectfully submits that the proposed changes at the referenced site constitute exempt modifications under R.C.S.A. Section 16-50j-72(b)(2).

Please feel free to call me at (860) 513-7636 with questions concerning this matter. Thank you for your consideration.

Sincerely,



Steven L. Levine
Real Estate Consultant

Attachments

**NEW CINGULAR WIRELESS
Equipment Modification**

50 Tiffany Road, Brooklyn
Site Number 2139
Local P&Z Approvals 6/98 (see attached documentation)

Tower Owner/Manager: Mark Yellin
Geographic Coordinates: N41° 47' 51" and W71° 53' 12" (see attached location map)
Equipment Configuration: Water Tank (dry)

Current and/or Approved: Nine panel antennas @ 131 ft AGL
Six 1¼ inch coax cables
Equipment Shelter

Planned Modifications: Remove all existing antennas & mounting poles
Install new mounting poles per structural analysis and CD's
Install six Powerwave 7770 antennas @ 131 ft
Install six TMA's and six diplexers @ 131 ft
Install three additional runs 1¼ inch coax

Power Density:

Worst-case calculations for existing wireless operations at the site indicate a radio frequency electromagnetic radiation power density, measured at ground level beside the tower, of approximately 14.8 % of the standard adopted by the FCC. As depicted in the second table below, the total radio frequency electromagnetic radiation power density following proposed modifications would be approximately 18 % of the standard.

Existing

Company	Centerline Ht (feet)	Frequency (MHz)	Number of Channels	Power Per Channel (Watts)	Power Density (mW/cm ²)	Standard Limits (mW/cm ²)	Percent of Limit
Other Users *							10.18
Cingular GSM	121	1900 Band	2	427	0.0210	1.0000	2.10
Cingular GSM	121	880 - 894	2	296	0.0145	0.5867	2.48
Total							14.8%

* Sum of conservative standard values for T-Mobile and Sprint-Nextel.

Proposed

Company	Centerline Ht (feet)	Frequency (MHz)	Number of Channels	Power Per Channel (Watts)	Power Density (mW/cm ²)	Standard Limits (mW/cm ²)	Percent of Limit
Other Users *							10.18
Cingular UMTS	131	880 - 894	1	500	0.0105	0.5867	1.79
Cingular GSM	131	1900 Band	2	427	0.0179	1.0000	1.79
Cingular GSM	131	880 - 894	4	296	0.0248	0.5867	4.23
Total							18.0%

* Sum of conservative standard values for T-Mobile and Sprint-Nextel.

Structural information:

The attached structural analysis demonstrates that the water tank will have sufficient structural capacity to accommodate the proposed equipment modifications providing that antenna mounting pipes are replaced as recommended (structural analysis by Hudson Design Group, 4/2/09; and construction drawings by Hudson Design Group, 4/1/09).

PLANNING AND ZONING COMMISSION

TOWN OF BROOKLYN

CONNECTICUT 06234

Legal Notice to be Published:

One time only, Tuesday, May 12, 1998.

LEGAL NOTICE

**TOWN OF BROOKLYN
Planning and Zoning Commission**

At the Regular Meeting of the Brooklyn Planning and Zoning Commission held on May 6, 1998, the following decisions were rendered:

APPROVED - SPR-98-03 Springwich Cellular Ltd. Partnership, 50 Tiffany Street, Antenna Installation and Related Building.

APPROVED - SD-98-2 Corner Properties, Corner of Mason Road and Route 169, Two-Lot Subdivision.


Bruce Parsons 

Bruce Parsons
Chairman

(Please bill to Account # 10089300. Any questions/problems contact Maureen at 779-3411 before 2:00 p.m.)
Thank you! 



April 2, 2009

Tim Burks
AT&T
500 Enterprise Drive, Suite 3A
Rocky Hill, CT 06067

RE: Structural Assessment
Site Number: 2139
Site Name: Brooklyn Tank

Dear Mr. Burks:

Hudson Design Group LLC (HDG) has been authorized by AT&T to assess the structural capability of this referenced site with regard to the existing structure's ability to support the following field changes: **1.) remove nine existing antennas and replace with six new Powerwave 7770 antennas, TMA's and Diplexers.**

Hudson Design Group performed a visual survey of the above structure and has completed a review of photos. The existing equipment locations are referenced in HDG's drawings dated 11-19-2008 (attached).

Based on our evaluation, we have determined that the existing pipe masts are **NOT ADEQUATE TO SUPPORT THE ABOVE FIELD CHANGES**. HDG recommends replacing the existing 2" sch. 40 pipe masts with 2" sch. 160 (XXH) pipe masts at 7'-0" tall. HDG recommends utilizing the existing diagonal steel kicker braces for lateral support. All details will be designed and furnished in the construction drawings. This evaluation is based on the requirements of the requirements of the TIA/EIA-222-F in conjunction with the International Building Code, with the 2005 Connecticut Supplement. Calculations and referenced documents submitted upon request.

This determination was based on the following limitations and assumptions:

1. Equipment and locations should not deviate from the construction drawings without written approval of the engineer.
2. HDG is not responsible for any modifications completed prior to and hereafter which HDG was not directly involved.
3. The roof of the existing water tank structure in the location of the mounts is free from damage at this time.


If you have any questions about this project, please contact our office.

Respectfully Submitted,
Hudson Design Group LLC

Derek Creaser
Sr. Project Manager

Approved by:
Hudson Design Group LLC

Daniel F. Hamm, P.E.
Principal

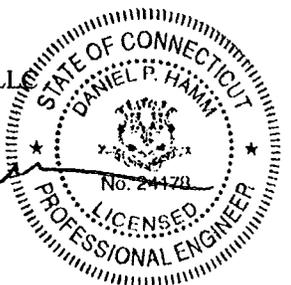



New Cingular Wireless PCS, LLC
500 Enterprise Drive
Rocky Hill, Connecticut 06067-3900
Phone: (860) 513-7636
Fax: (860) 513-7190

Steven L. Levine
Real Estate Consultant

April 3, 2009

Honorable Roger Engle
1st Selectman, Town of Brooklyn
Town Hall 4 Wolf Den Rd.
Brooklyn, Connecticut 06234-0356

Re: Telecommunications Facility – 50 Tiffany Road, Brooklyn

Dear Mr. Engle:

In order to accommodate technological changes, implement Uniform Mobile Telecommunications System (“UMTS”) capability, and enhance system performance in the State of Connecticut, New Cingular Wireless PCS, LLC (“Cingular”) will be changing its equipment configuration at certain cell sites.

As required by Regulations of Connecticut State Agencies (“R.C.S.A.”) Section 16-50j-73, the Connecticut Siting Council has been notified of the changes and will review Cingular’s proposal. Please accept this letter as notification under Section 16-50j-73 of construction which constitutes an exempt modification pursuant to R.C.S.A. Section 16-50j-72(b)(2).

The accompanying letter to the Siting Council fully describes Cingular’s proposal for the referenced cell site. However, if you have any questions or require any further information on our plans or the Siting Council’s procedures, please call me at (860) 513-7636 or Mr. Derek Phelps, Executive Director, Connecticut Siting Council at (860) 827-2935.

Sincerely,

Steven L. Levine
Real Estate Consultant

Enclosure

PROJECT INFORMATION

SCOPE OF WORK: UNMANNED TELECOMMUNICATIONS FACILITY MODIFICATIONS
 SITE ADDRESS: 50 TIFFANY ST.
 BROOKLYN, CT 06239
 LATITUDE: 41° 47' 50.7" N
 LONGITUDE: -71° 53' 12.1" W
 JURISDICTION: NATIONAL, STATE & LOCAL CODES OR ORDINANCES
 CURRENT USE: TELECOMMUNICATIONS FACILITY
 PROPOSED USE: TELECOMMUNICATIONS FACILITY
 NOC# 866-915-5600



SITE NUMBER: 2139
SITE NAME: BROOKLYN TANK


DRAWING INDEX

REV

- T-1 TITLE SHEET
- GN-1 GENERAL NOTES
- A-1 COMPOUND PLAN & EQUIPMENT PLAN
- A-2 ANTENNA LAYOUT AND ELEVATION
- G-1 GROUNDING, ONE-LINE DIAGRAM & DETAILS

VICINITY MAP

DIRECTION TO SITE:
 FROM ENTERPRISE DR. ROCKY HILL GOINS TOWARDS CAPITOL BLDG. - TURN LEFT ON CAPITOL BLDG. TURN LEFT ON WEST ST. TURN LEFT TO TAKE RAMP ONTO I-91 N TOWARD HARTFORD - TAKE EXIT #25-28/GLASTONBURY/OLD WETHERSFIELD ONTO CT-3 N TOWARD #25/GLASTONBURY - TAKE THE NORWICH EXIT ONTO CT-2 E - TAKE EXIT #28N/PROVIDENCE ONTO I-385 N - TAKE EXIT #91/DANIELSON/HARTFORD ONTO PROVIDENCE PIKE (US-6 W) - CONTINUE TO FOLLOW US-6 W. TURN LEFT ON A LOCAL ROAD. TURN LEFT ON S MAIN ST. TURN RIGHT ON TIFFANY ST. - ARRIVE AT 50 TIFFANY ST. BROOKLYN, ON THE LEFT

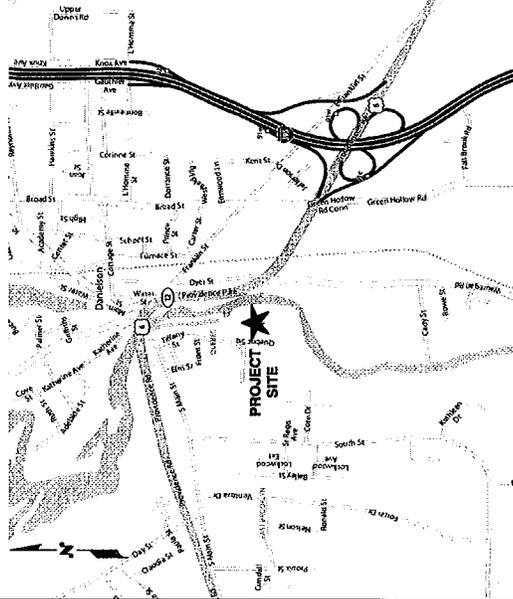

GENERAL NOTES

1. THIS DOCUMENT IS THE CREATION, DESIGN, PROPERTY AND COPYRIGHTED WORK OF AT&T. ANY DUPLICATION OR USE WITHOUT EXPRESS WRITTEN CONSENT IS STRICTLY PROHIBITED. DUPLICATION AND USE BY GOVERNMENT AGENCIES FOR THE PURPOSES OF CONDUCTING THEIR LAWFULLY AUTHORIZED REGULATORY AND ADMINISTRATIVE FUNCTIONS IS SPECIFICALLY ALLOWED.
2. THE FACILITY IS AN UNMANNED, PRIVATE AND SECURED EQUIPMENT INSTALLATION. IT IS ONLY ACCESSIBLE BY MAINTENANCE PERSONNEL FOR PERFORMANCE OF MAINTENANCE. THEREFORE DOES NOT REQUIRE ANY WATER OR SANITARY SEWER SERVICE. THE FACILITY IS NOT GOVERNED BY REGULATIONS REQUIRING PUBLIC ACCESS PER ADA REQUIREMENTS.
3. CONTRACTOR SHALL VERIFY ALL PLANS AND EXISTING DIMENSIONS AND CONDITIONS ON THE JOB SITE AND SHALL IMMEDIATELY NOTIFY THE AT&T REPRESENTATIVE IN WRITING OF ANY DISCREPANCIES BEFORE PROCEEDING WITH THE WORK OR BE RESPONSIBLE FOR SAME.

CALL



BEFORE YOU DIG



CALL TOLL FREE 800-922-4455

UNDERGROUND SERVICE ALERT




22 KEEWAYDIN DRIVE
 SALEM, NH 03079



SITE NUMBER: 2139
SITE NAME: BROOKLYN TANK
 50 TIFFANY ST.
 BROOKLYN, CT 06239
 WINDHAM COUNTY




500 ENTERPRISE DRIVE, SUITE 3A
 ROCKY HILL, CT 06067

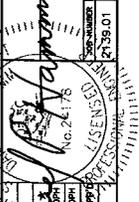

NO.	DATE	REVISIONS
1	4/20/09	CONSTRUCTION REVISED
0	2/19/09	ISSUED FOR CONSTRUCTION

SCALE: AS SHOWN
 DESIGNED BY: DC
 CHECKED BY: AP

AT&T
 TITLE SHEET
 UNITS
 DRAWING NUMBER
 1

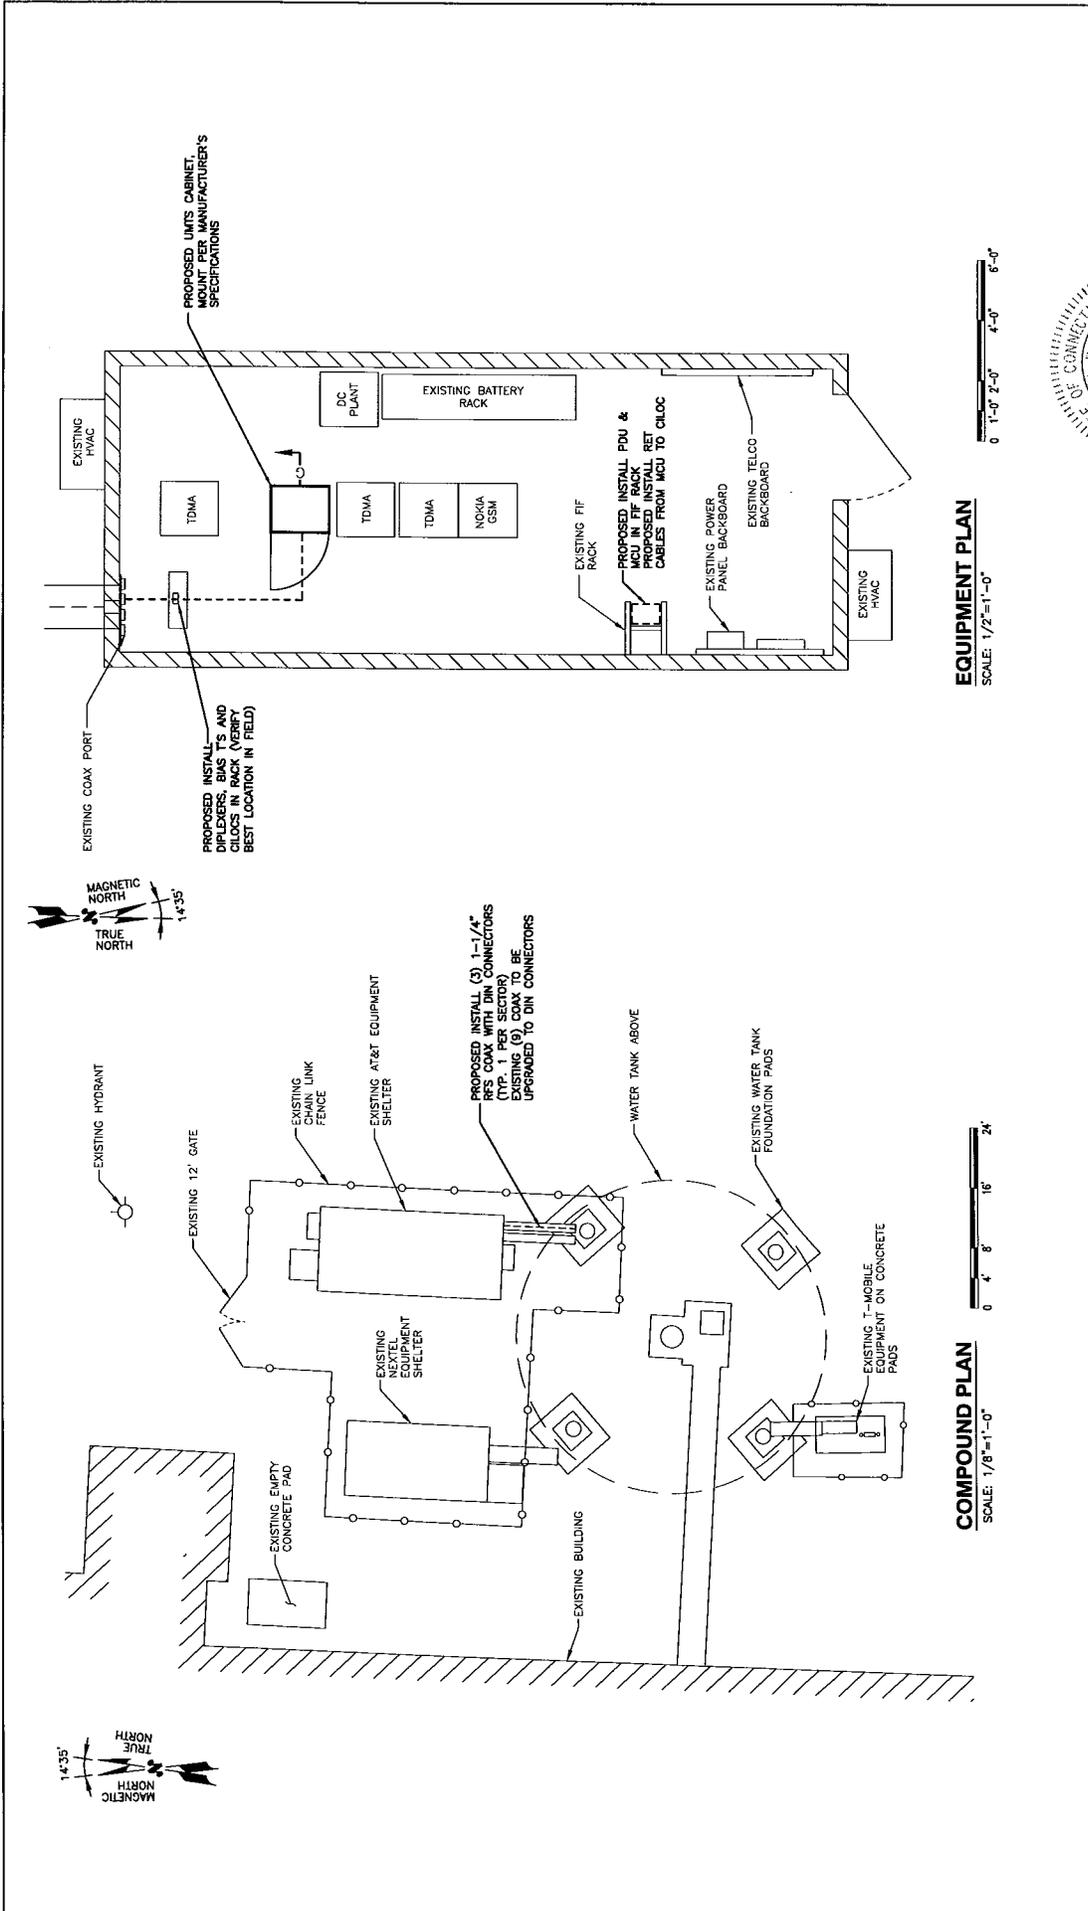


 HUDSON DESIGN GROUP 100 WASHINGTON STREET, 3RD FLOOR N. ANDOVER, MA 01861 TEL: (978) 652-5533 FAX: (978) 652-5588		 SIAT COMMUNICATIONS 22 KEEMAYON DRIVE SALEM, NH 03079		 500 ENTERPRISE DRIVE, SUITE 3A ROCKY HILL, CT 06067	
SITE NUMBER: 2199 SITE NAME: BROOKLYN TANK 50 TIFFANY ST BROOKLYN, CT 06239 WINDHAM COUNTY		AT&T COMPOUND PLAN & EQUIPMENT PLAN		PROJECT NUMBER: 2199.01 DRAWING NUMBER: A-1	
1 2/27/09 CONSTRUCTION REVISED BY: JCH/DPH	2 2/19/09 ISSUED FOR CONSTRUCTION BY: JCH/DPH	3 2/19/09 REVISIONS BY: JCH/DPH	4 2/19/09 REVISIONS BY: JCH/DPH	5 2/19/09 REVISIONS BY: JCH/DPH	6 2/19/09 REVISIONS BY: JCH/DPH
SCALE: AS SHOWN DESIGNED BY: DC		SCALE: AS SHOWN DESIGNED BY: DC		SCALE: AS SHOWN DESIGNED BY: DC	


RF TABLE									
SECTOR	SECTOR NAME	ANTENNA MAKE & MODEL	ANTENNA COUNT	RAD CENTER AZIMUTH	RAD CENTER	MECHANICAL DOWNTILT	DUALBAND TMA COUNT	DIPLEXER COUNT	# OF COAX CABLES
1	ALPHA	POWERWAVE 7770	2 PROPOSED 0 EXISTING	149°*	131'±	0*	2 PROPOSED 0 EXISTING	2 PROPOSED 0 EXISTING	1 PROPOSED 3 EXISTING
2	BETA	POWERWAVE 7770	2 PROPOSED 0 EXISTING	269°*	131'±	0*	2 PROPOSED 0 EXISTING	2 PROPOSED 0 EXISTING	1 PROPOSED 3 EXISTING
3	GAMMA	POWERWAVE 7770	2 PROPOSED 0 EXISTING	23°*	131'±	0*	2 PROPOSED 0 EXISTING	2 PROPOSED 0 EXISTING	1 PROPOSED 3 EXISTING

NOTE:
AN ANALYSIS FOR THE CAPACITY OF THE EXISTING STRUCTURES TO SUPPORT THE PROPOSED ANTENNAS HAS BEEN DETERMINED PRIOR TO CONSTRUCTION.


NOTE:*
REFER TO THE FINAL RF DATA FOR THE FINAL ANTENNA SETTINGS.

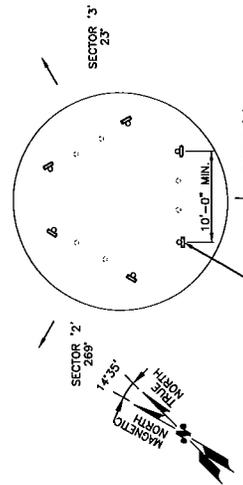


ANTENNA PLAN
SCALE: N.T.S.

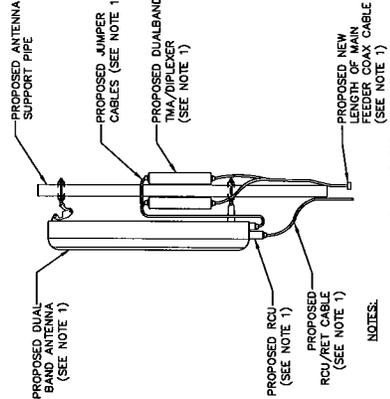


PROPOSED ANTENNA DETAIL
SCALE: N.T.S.

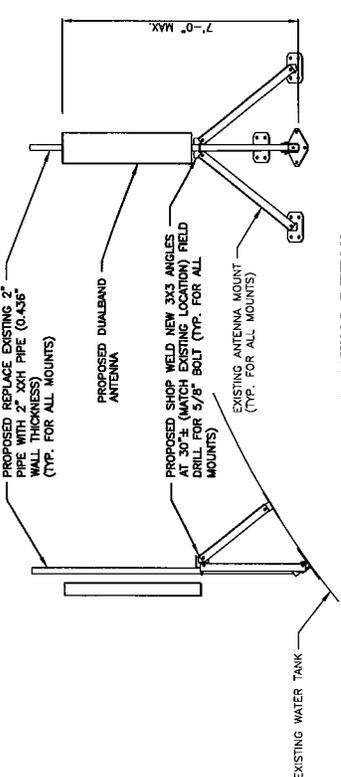

MOUNTING DETAIL
SCALE: 1/2"=1'-0"

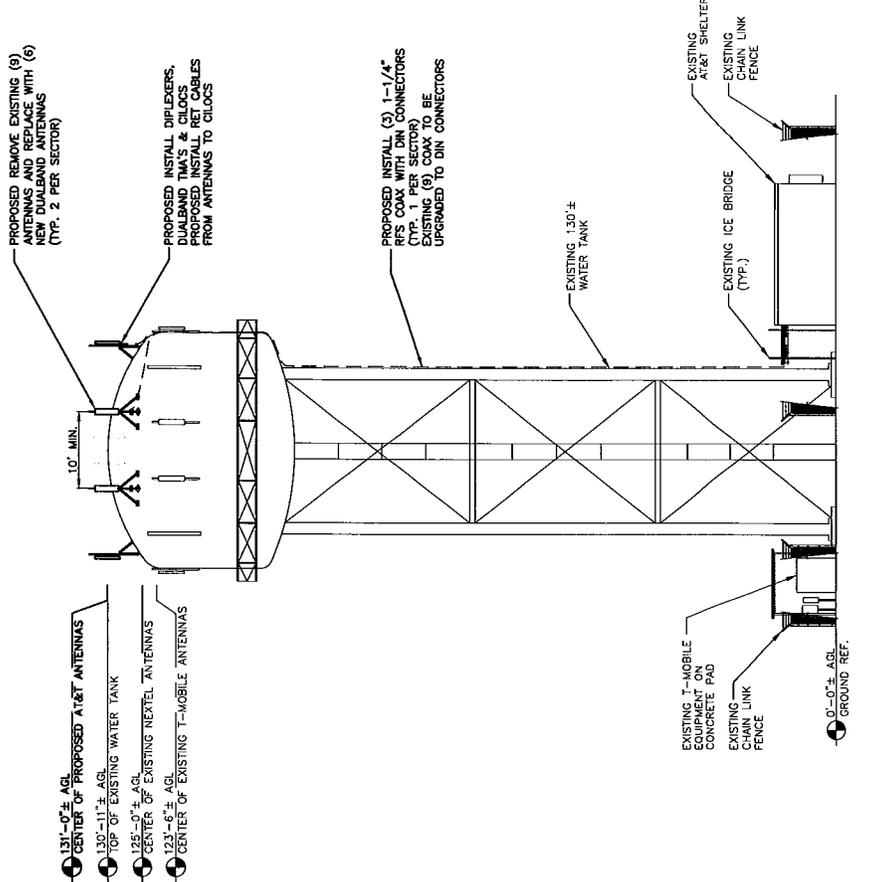

EAST ELEVATION
SCALE: 3/32"=1'-0"

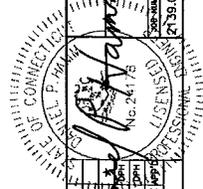

500 ENTERPRISE DRIVE, SUITE 3A
ROCKY HILL, CT 06067

SITE NUMBER: 2139
SITE NAME: BROOKLYN TANK
50 TIFFANY ST.
BROOKLYN, CT 06239
WINDHAM COUNTY




22 KEENEYDIN DRIVE
SALEM, NH 03079




180 DODD STREET, SUITE 2-101
N. ANDOVER, MA 01850
TEL: 978.655.6533
FAX: 978.655.6536

AT&T	
ANTENNA LAYOUT AND ELEVATION	
NO.	DATE
1	4/20/09
0	2/10/09
CONSTRUCTION REVISED	ISSUED FOR CONSTRUCTION
DESIGNED BY: DC	DRAWN BY: AP
SCALE: AS SHOWN	DATE: 2/19/01
DATE OF CONNECTION: 2/19/01	DRAWING NUMBER: A-2
REV	1

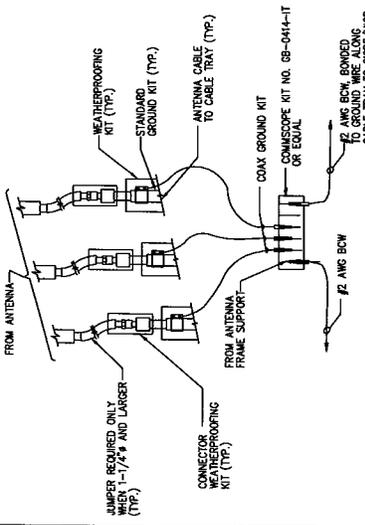


NOTE:
 1. DO NOT INSTALL CABLE GROUND KIT AT A BEND AND ALWAYS DIRECT GROUND WIRE DOWN TO GROUND.

GROUND WIRE TO GROUND BAR CONNECTION DETAIL
 1. N.T.S.

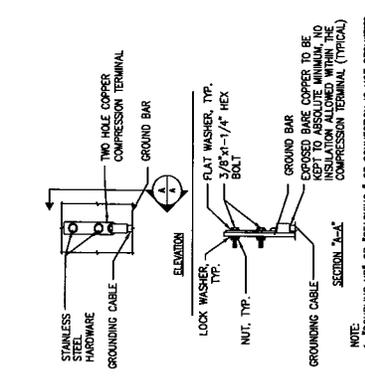


NOTE:
 1. "DOUBLE UP" OR "STACKING" OF CONNECTION IS NOT PERMITTED.
 2. CODE INHIBITING COMPOUND TO BE USED AT ALL LOCATIONS.
 3. CAMEL DOWNLEADS FROM UPPER EGR, LOWER EGR, AND MGR.

TYPICAL GROUND BAR CONNECTION DETAIL
 3. N.T.S.

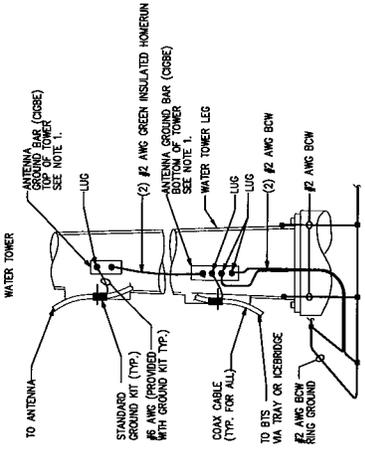

NOTE:
 1. NUMBER OF GROUND BARS MAY VARY DEPENDING ON THE TYPE OF TOWER, ANTENNA LOCATION AND CONNECTION ANTENNA LOCATION.
 2. A SEPARATE GROUND BAR TO BE USED FOR GPS ANTENNA IF REQUIRED.


ANTENNA CABLE GROUNDING
 4. N.T.S.

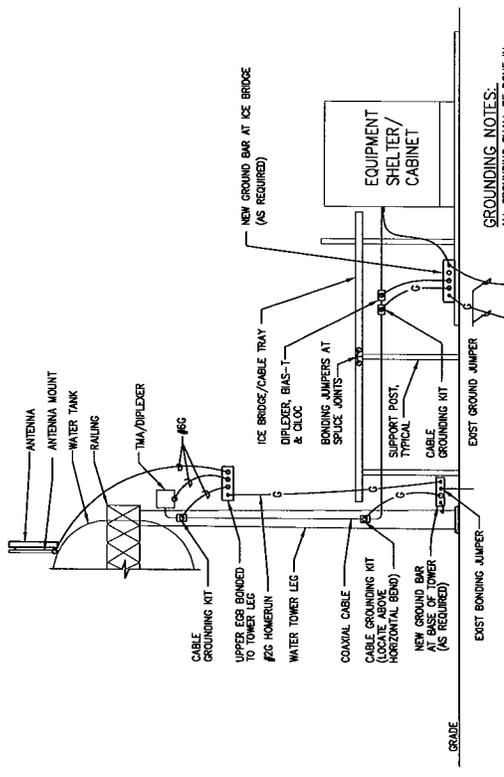

GROUNDING NOTES:
 ALL GROUNDING SHALL BE DONE IN ACCORDANCE WITH THE AT&T GROUNDING GUIDE.

GROUNDING ONE LINE DIAGRAM
 2. N.T.S.

WIRELESS SOLUTIONS INC.	
NO.	DESCRIPTION
1	HUBS-0420-IS SQUID END BAR (20"x4"x1/4")
2	WALL MTC. BRKT.
3	INSULATORS
4	5/8"-11x1" H.H.C.S.
5	5/8" LOCKWASHER

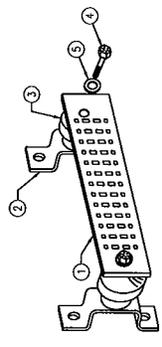

GROUND BAR - DETAIL
 5. N.T.S.

EACH GROUND CONDUCTOR TERMINATING ON ANY GROUND BAR SHALL HAVE AN IDENTIFICATION TAG ATTACHED AT EACH END THAT WILL IDENTIFY ITS ORIGIN AND DESTINATION.

SECTION "T" - SURGE PRODUCERS
 CABLE ENTRY PORTS (HATCH PLATES) (#2)
 GENERATOR FRAMEWORK (IF AVAILABLE) (#2)
 COMMERCIAL POWER COMMON NEUTRAL/GROUND BOND (#2)
 +24V POWER SUPPLY RETURN BAR (#2)
 -48V POWER SUPPLY RETURN BAR (#2)
 RECTIFIER FRAMES.

SECTION "A" - SURGE ABSORBERS
 INTERIOR GROUND RING (#2)
 EXTERNAL EARTH GROUND FIELD (BURIED GROUND RING) (#2)
 METALLIC COLD WATER PIPE (IF AVAILABLE) (#2)
 BUILDING STEEL (IF AVAILABLE) (#2)

Hudson Design Group
 1000 BROADWAY
 BUILDING 2000, SUITE 2101
 NEW YORK, NY 10004
 TEL: 878-557-6553
 FAX: 878-344-8881

SIAD communications
 22 KEENAVOIN DRIVE
 SALEM, NH 03079

at&t
 500 ENTERPRISE DRIVE, SUITE 3A
 ROCKY HILL, CT 06067

AT&T
 PROJECT NO. 01-1138-01
 SHEET NO. 1
 DATE: 12/19/09
 DRAWN BY: AP
 CHECKED BY: DC
 DESIGNED BY: DC
 SCALE: AS SHOWN
 REVISIONS:
 NO. DATE BY
 1 4/20/09 CONSTRUCTION REVISED AP DC JPH
 2 5/21/09 ISSUED FOR CONSTRUCTION AP DC JPH