



ATC SITE NAME: BRST - BRISTOL

ATC SITE NUMBER: 302500

VERIZON SITE NAME: BRISTOL SW CT

VERIZON SITE NUMBER: 5000917346 (780529)

VERIZON FUZE PID: 17060569

SITE ADDRESS: 790 WILLIS STREET

BRISTOL, CT 06010-7269



# **LOCATION MAP**

# **VERIZON COLLOCATION PLAN**

COMPLIANCE CODE	PROJECT S	UMMARY	PROJECT DESCRIPTION		SHEET INDEX			
ALL WORK SHALL BE PERFORMED AND MATERIALS INSTALLED IN ACCORDANCE WITH THE CURRENT EDITIONS OF THE	CCORDANCE WITH THE CURRENT EDITIONS OF THE  LOWING CODES AS ADOPTED BY THE LOCAL VERNMENT AUTHORITIES. NOTHING IN THESE PLANS IS BE CONSTRUED TO PERMIT WORK NOT CONFORMING TO  COUNTY, HARDTORD		THE PROPOSED PROJECT INCLUDES PLACING EQUIPMENT 790 WILLIS STREET CABINETS ON A PROPOSED CONCRETE PAD INSIDE A 12'x30' BRISTOL. CT 06010-7269 (360 SQ FT) GROUND SPACE WITHIN THE EXISTING COMPOUND,	SHEET NO:	DESCRIPTION:	REV:	DATE:	BY:
GOVERNMENT AUTHORITIES. NOTHING IN THESE PLANS IS				G-001	TITLE SHEET	1	01/22/24	VL
THESE CODES.			AND PLACING NEW ANTENNAS ON PROPOSED SECTOR FRAMES MOUNTED TO THE EXISTING TOWER.	G-002	GENERAL NOTES	1	01/22/24	VL
2022 CONNECTICUT STATE BUILDING CODE-AMENDMENTS     TO IBC 2021	GEOGRAPHIC CO	OORDINATES:		C-001	OVERALL SITE PLAN	1	01/22/24	VL
2. INTERNATIONAL BUILDING CODE 2015, INTERNATIONAL	LATITUDE: 41			C-101	DETAILED SITE PLAN	1	01/22/24	VL
CODE COUNCIL 3. TIA-222-G-4, STRUCTURAL STANDARD FOR ANTENNA	LONGITUDE: -7 GROUND ELEVATION			C-201	TOWER ELEVATION	1	01/22/24	VL
SUPPORTING STRUCTURES AND ANTENNAS				C-401	ANTENNA INFORMATION & SCHEDULE	1	01/22/24	VL
ASCE 7-10 MINIMUM DESIGN LOADS FOR BUILDINGS AND OTHER STRUCTURES, AMERICAN SOCIETY OF CIVIL			PROJECT NOTES	C-501	MOUNT DETAILS	1	01/22/24	VL
ENGINEERS  5. STEEL CONSTRUCTION MANUAL 14TH EDITION, AMERICAN			THE FACILITY IS UNMANNED.	C-502	CONSTRUCTION DETAILS	1	01/22/24	VL
INSTITUTE OF STEEL CONSTRUCTION			A TECHNICIAN WILL VISIT THE SITE APPROXIMATELY ONCE     A MONTH FOR ROUTINE INSPECTION AND MAINTENANCE.	C-503	CONSTRUCTION DETAILS	1	01/22/24	VL
6. CITY/COUNTY ORDINANCES	PROJECT	TEAM	<ol> <li>THE PROJECT WILL NOT RESULT IN ANY SIGNIFICANT LAND DISTURBANCE OR EFFECT OF STORM WATER DRAINAGE.</li> </ol>	C-504	CONSTRUCTION DETAILS	1	01/22/24	VL
	TOWER OWNER: APPLICANT:	<ol> <li>NO SANITARY SEWER, POTABLE WATER OR TRASH DISPOSAL IS REQUIRED.</li> </ol>	C-505	CONSTRUCTION DETAILS	1	01/22/24	VL	
	AMERICAN TOWER	AMERICAN TOWER VERIZON WIRELESS 5. HANDICAP ACCESS IS NOT REQUIRED.  6. THE PROJECT DEPICTED IN THESE PLANS QUALIFIES AS	HANDICAP ACCESS IS NOT REQUIRED.     THE PROJECT DEPICTED IN THESE PLANS QUALIFIES AS	E-101	GROUNDING PLAN & NOTES	1	01/22/24	VL
	10 PRESIDENTIAL WAY WOBURN, MA 01801	51 ALDER STREET MEDWAY, MA 02053	AN ELIGIBLE FACILITIES REQUEST ENTITLED TO EXPEDITED REVIEW UNDER 47 U.S.C. § 1455(A) AS A	E-102	ONE-LINE & PANEL SCHEDULE	1	01/22/24	VL
	ENGINEER:		MODIFICATION OF AN EXISTING WIRELESS TOWER THAT INVOLVES THE COLLOCATION, REMOVAL, AND/OR	E-501	GROUNDING DETAILS	1	01/22/24	VL
	DEWBERRY ENGINEERS INC.		REPLACEMENT OF TRANSMISSION EQUIPMENT THAT IS NOT A SUBSTANTIAL CHANGE UNDER CFR § 1.61000 (B)(7).	E-502	GROUNDING DETAILS	1	01/22/24	VL
UTILITY COMPANIES	99 SUMMER STREET SUITE 700		PROJECT LOCATION DIRECTIONS	R-601	SUPPLEMENTAL			
POWER COMPANY: UNKNOWN	BOSTON, MA 02110		TROSECT ECCATION BIRECTIONS	R-602	SUPPLEMENTAL			
PHONE: N/A	PHONE: 617.695.3400 FAX: 617.695.3310			R-603	SUPPLEMENTAL			
TELEPHONE COMPANY: UNKNOWN PHONE: N/A	PROPERTY OWNER:		FROM HARTFORD TAKE I-84 WEST TO RT 72 WEST. FOLLOW TO					
<b>811.</b>	THE CONNECTICUT LIGHT AND POWER CO 790 WILLIS STREET BRISTOL, CT 06010-7269		END. GO STRAIGHT AT END OF RAMP AND AT NEXT STREET TAKE A RIGHT. GO STRAIGHT FOR A FEW MILES UNTIL MEMORIAL SCHOOL IS ON RIGHT. AT THIS INTERSECTION TURN RIGHT ON WILLIS. GO UP HILL TO TOP, ACCESS ROAD IS JUST AFTER # 760.					



# **Dewberry**®

Dewberry Engineers Inc. 99 SUMMER STREET SUITE 700 BOSTON, MA 02110 PHONE: 617.695.3400 FAX: 617.695.3310

REV.	DESCRIPTION	BY	DATE
<u> </u>	PRELIM	HMP	08/07/23
<u>B</u>	PRELIM	VL	08/30/23
<u></u>	FINAL	VL	12/21/23
<u> </u>	FINAL	VL	01/22/24
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### **BRISTOL SW CT**

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CUSTOMER #: 5000917346 (780529)

CUSTOMER ID: BRISTOL SW CT

TITLE SHEET

G-001

#### **GENERAL CONSTRUCTION NOTES:**

- OWNER FURNISHED MATERIALS, VERIZON "THE COMPANY" WILL PROVIDE AND THE CONTRACTOR WILL INSTALL
- BTS EQUIPMENT FRAME (PLATFORM) AND ICEBRIDGE SHELTER (GROUND
  - BUILD/CO-LOCATE ONLY) AC/TELCO INTERFACE BOX (PPC)
  - C. ICE BRIDGE (CABLE TRAY WITH COVER) (GROUND BUILD/CO-LOCATE ONLY, GC TO FURNISH AND INSTALL FOR ROOFTOP INSTALLATION)
- D. TOWERS, MONOPOLES
- TOWER LIGHTING
- GENERATORS & LIQUID PROPANE TANK
- ANTENNA STANDARD BRACKETS, FRAMES AND PIPES FOR MOUNTING
- ANTENNAS (INSTALLED BY OTHERS)
- TRANSMISSION LINE
- TRANSMISSION LINE JUMPERS
- TRANSMISSION LINE CONNECTORS WITH WEATHERPROOFING KITS
- TRANSMISSION LINE GROUND KITS
- HANGERS
- HOISTING GRIPS
- O. BTS EQUIPMENT
- THE CONTRACTOR IS RESPONSIBLE TO PROVIDE ALL OTHER MATERIALS FOR THE COMPLETE INSTALLATION OF THE SITE INCLUDING, BUT NOT LIMITED TO, SUCH MATERIALS AS FENCING, STRUCTURAL STEEL SUPPORTING SUB-FRAME FOR PLATFORM, ROOFING LABOR AND MATERIALS GROUNDING RINGS GROUNDING WIRES COPPER-CLAD OR XIT CHEMICAL GROUND ROD(S), BUSS BARS, TRANSFORMERS AND DISCONNECT SWITCHES WHERE APPLICABLE, TEMPORARY ELECTRICAL POWER, CONDUIT LANDSCAPING COMPOUND STONE, CRANES, CORE DRILLING, SLEEPERS AND RUBBER MATTING, REBAR, CONCRETE CAISSONS, PADS AND/OR AUGER MOUNTS, MISCELLANEOUS FASTENERS, CABLE TRAYS, NON-STANDARD ANTENNA FRAMES AND ALL OTHER MATERIAL AND LABOR REQUIRED TO COMPLETE THE JOB ACCORDING TO THE DRAWINGS AND SPECIFICATIONS. IT IS THE POSITION OF VERIZON TO APPLY FOR PERMITTING AND CONTRACTOR RESPONSIBLE FOR PICKUP AND PAYMENT OF REQUIRED
- ALL WORK SHALL CONFORM TO ALL CURRENT APPLICABLE FEDERAL, STATE, AND LOCAL CODES, INCLUDING ANSI/EIA/TIA-222, AND COMPLY WITH ATC CONSTRUCTION
- CONTRACTOR SHALL CONTACT LOCAL 811 FOR IDENTIFICATION OF UNDERGROUND UTILITIES PRIOR TO START OF CONSTRUCTION.
- CONTRACTOR SHALL BE RESPONSIBLE FOR COORDINATING ALL REQUIRED INSPECTIONS.
- ALL DIMENSIONS TO, OF, AND ON EXISTING BUILDINGS, DRAINAGE STRUCTURES, AND SITE IMPROVEMENTS SHALL BE VERIFIED IN FIELD BY CONTRACTOR WITH ALL DISCREPANCIES REPORTED TO THE ENGINEER.
- DO NOT CHANGE SIZE OR SPACING OF STRUCTURAL ELEMENTS
- DETAILS SHOWN ARE TYPICAL: SIMILAR DETAILS APPLY TO SIMILAR CONDITIONS UNLESS
- THESE DRAWINGS DO NOT INCLUDE NECESSARY COMPONENTS FOR CONSTRUCTION SAFETY WHICH SHALL BE THE SOLE RESPONSIBILITY OF THE CONTRACTOR
- CONTRACTOR SHALL BRACE STRUCTURES UNTIL ALL STRUCTURAL ELEMENTS NEEDED FOR STABILITY ARE INSTALLED. THESE ELEMENTS ARE AS FOLLOWS: LATERAL BRACING,
- CONTRACTOR SHALL DETERMINE EXACT LOCATION OF EXISTING UTILITIES. GROUNDS DRAINS, DRAIN PIPES, VENTS, ETC, BEFORE COMMENCING WORK
- INCORRECTLY FABRICATED, DAMAGED, OR OTHERWISE MISFITTING OR NONCONFORMING MATERIALS OR CONDITIONS SHALL BE REPORTED TO THE VERIZON REP PRIOR TO REMEDIAL OR CORRECTIVE ACTION, ANY SUCH REMEDIAL ACTION SHALL REQUIRE WRITTEN APPROVAL BY THE VERIZON REP PRIOR TO PROCEEDING.
- EACH CONTRACTOR SHALL COOPERATE WITH THE VERIZON REP, AND COORDINATE HIS WORK WITH THE WORK OF OTHERS.
- CONTRACTOR SHALL REPAIR ANY DAMAGE CAUSED BY CONSTRUCTION OF THIS PROJECT TO MATCH EXISTING PRE-CONSTRUCTION CONDITIONS TO THE SATISFACTION
- ALL CABLE/CONDUIT ENTRY/EXIT PORTS SHALL BE WEATHERPROOFED DURING 15. INSTALLATION LISING A SILICONE SEALANT
- WHERE EXISTING CONDITIONS DO NOT MATCH THOSE SHOWN IN THIS PLAN SET. CONTRACTOR SHALL NOTIFY THE VERIZON REP AND ENGINEER OF RECORD
- CONTRACTOR SHALL ENSURE ALL SUBCONTRACTORS ARE PROVIDED WITH A COMPLETE AND CURRENT SET OF DRAWINGS AND SPECIFICATIONS FOR THIS PROJECT.
- CONTRACTOR SHALL REMOVE ALL RUBBISH AND DEBRIS FROM THE SITE AT THE END OF
- CONTRACTOR SHALL COORDINATE WORK SCHEDULE WITH AMERICAN TOWER CORPORATION (ATC) AND TAKE PRECAUTIONS TO MINIMIZE IMPACT AND DISRUPTION OF OTHER OCCUPANTS OF THE FACILITY.
- CONTRACTOR SHALL FURNISH VERIZON AND AMERICAN TOWER CORPORATION (ATC) NITH A PDF MARKED UP AS-BUILT SET OF DRAWINGS UPON COMPLETION OF WORK
- PRIOR TO SUBMISSION OF BID, CONTRACTOR SHALL COORDINATE WITH VERIZON REP TO DETERMINE WHAT, IF ANY, ITEMS WILL BE PROVIDED. ALL ITEMS NOT PROVIDED SHALL BE PROVIDED AND INSTALLED BY THE CONTRACTOR. CONTRACTOR WILL INSTALL

- 22. PRIOR TO SUBMISSION OF BID. CONTRACTOR SHALL COORDINATE WITH VERIZON REP TO DETERMINE IF ANY PERMITS WILL BE OBTAINED BY CONTRACTOR. ALL REQUIRED PERMITS NOT OBTAINED BY VERIZON MUST BE OBTAINED, AND PAID FOR, BY THE
- CONTRACTOR SHALL INSTALL ALL SITE SIGNAGE IN ACCORDANCE WITH VERIZON SPECIFICATIONS AND REQUIREMENTS.
- CONTRACTOR SHALL SUBMIT ALL SHOP DRAWINGS TO VERIZON FOR REVIEW AND 24. APPROVAL PRIOR TO FABRICATION
- ALL EQUIPMENT SHALL BE INSTALLED ACCORDING TO MANUFACTURER'S SPECIFICATIONS AND LOCATED ACCORDING TO VERIZON SPECIFICATIONS, AND AS SHOWN IN THESE PLANS
- 26. THE CONTRACTOR SHALL SUPERVISE AND DIRECT THE PROJECT DESCRIBED HEREIN THE CONTRACTOR SHALL BE SOLELY RESPONSIBLE FOR ALL THE CONSTRUCTION MEANS, METHODS, TECHNIQUES, SEQUENCES AND PROCEDURES AND FOR COORDINATING ALL PORTIONS OF THE WORK UNDER THE CONTRACT.
- CONTRACTOR SHALL NOTIFY VERIZON REP A MINIMUM OF 48 HOURS IN ADVANCE OF POURING CONCRETE OR BACKFILLING ANY UNDERGROUND UTILITIES, FOUNDATIONS OR SEALING ANY WALL, FLOOR OR ROOF PENETRATIONS FOR ENGINEERING REVIEW AND
- CONTRACTOR SHALL BE RESPONSIBLE FOR SITE SAFETY INCLUDING COMPLIANCE WITH ALL APPLICABLE OSHA STANDARDS AND RECOMMENDATIONS AND SHALL PROVIDE ALL NECESSARY SAFETY DEVICES INCLUDING PPE AND PPM AND CONSTRUCTION DEVICES SUCH AS WELDING AND FIRE PREVENTION, TEMPORARY SHORING, SCAFFOLDING, TRENCH BOXES/SLOPING, BARRIERS, ETC.
- THE CONTRACTOR SHALL PROTECT AT HIS OWN EXPENSE, ALL EXISTING FACILITIES AND SPECIAL CONSTRUCTION SUCH OF HIS NEW WORK LIABLE TO INJURY DURING THE CONSTRUCTION PERIOD. ANY DAMAGE CAUSED BY NEGLECT ON THE PART OF THIS CONTRACTOR OR HIS REPRESENTATIVES, OR BY THE ELEMENTS DUE TO NEGLECT ON THE PART OF THIS CONTRACTOR OR HIS REPRESENTATIVES, EITHER TO THE EXISTING WORK, OR TO HIS WORK OF ANY OTHER CONTRACTOR, SHALL BE REPAIRED AT HIS EXPENSE TO THE OWNER'S SATISFACTION.
- ALL WORK SHALL BE INSTALLED IN A FIRST CLASS, NEAT AND WORKMANLIKE MANNER BY MECHANICS SKILLED IN THE TRADE INVOLVED. THE QUALITY OF WORKMANSHIP SHALL BE SUBJECT TO THE APPROVAL OF THE VERIZON REP. ANY WORK FOUND BY THE VERIZON REP TO BE OF INFERIOR QUALITY AND/OR WORKMANSHIP SHALL BE REPLACED AND/OR REWORKED AT CONTRACTOR EXPENSE UNTIL APPROVAL IS
- 31. IN ORDER TO ESTABLISH STANDARDS OF QUALITY AND PERFORMANCE, ALL TYPES OF MATERIALS LISTED HEREINAFTER BY MANUFACTURER'S NAMES AND/OR
  MANUFACTURER'S CATALOG NUMBER SHALL BE PROVIDED BY THESE MANUFACTURERS AS SPECIFIED.
- VERIZON FURNISHED EQUIPMENT SHALL BE PICKED-UP AT THE VERIZON WAREHOUSE AND INSTALLED BY THE CONTRACTOR WITH ALL APPURTENANCES REQUIRED TO PLACE THE EQUIPMENT IN OPERATION, READY FOR USE. THE CONTRACTOR SHALL BE RESPONSIBLE FOR THE EQUIPMENT AFTER PICKING IT UP
- VERIZON OR HIS ARCHITECT/ENGINEER RESERVES THE RIGHT TO REJECT ANY FOLIPMENT OR MATERIALS WHICH IN HIS OWN OPINION ARE NOT IN COMPLIANCE WITH THE CONTRACT DOCUMENTS, EITHER BEFORE OR AFTER INSTALLATION AND THE EQUIPMENT SHALL BE REPLACED WITH EQUIPMENT CONFORMING TO THE REQUIREMENTS OF THE CONTRACT DOCUMENTS BY THE CONTRACTOR AT NO COST TO VERIZON OR THEIR ARCHITECT/ENGINEER

#### STRUCTURAL STEEL NOTES:

- STRUCTURAL STEEL SHALL CONFORM TO THE LATEST EDITION OF THE AISC "SPECIFICATION FOR THE DESIGN, FABRICATION AND ERECTION OF STRUCTURAL STEEL
- STRUCTURAL STEEL ROLLED SHAPES, PLATES AND BARS SHALL CONFORM TO THE FOLLOWING ASTM DESIGNATIONS:
  - A. ASTM A-572, GRADE 50 ALL W SHAPES, UNLESS NOTED OR A992 OTHERWISE
  - B. ASTM A-36 ALL OTHER ROLLED SHAPES, PLATES AND BARS UNLESS NOTED
  - C. ASTM A-500, GRADE B HSS SECTION (SQUARE, RECTANGULAR, AND ROUND)
  - D. ASTM A-325, TYPE SC OR N ALL BOLTS FOR CONNECTING STRUCTURAL
  - E. ASTM F-1554 07 ALL ANCHOR BOLTS, UNLESS NOTED OTHERWISE
- ALL EXPOSED STRUCTURAL STEEL MEMBERS SHALL BE HOT-DIPPED GALVANIZED AFTER FABRICATION PER ASTM A123. EXPOSED STEEL HARDWARE AND ANCHOR BOLTS SHALL BE GALVANIZED PER ASTM A153 OR B695
- ALL FIELD CUT SURFACES, FIELD DRILLED HOLES AND GROUND SURFACES WHERE EXISTING PAINT OR GALVANIZATION REMOVAL WAS REQUIRED SHALL BE REPAIRED WITH (2) BRUSHED COATS OF ZRC GALVILITE COLD GALVANIZING COMPOUND PER ASTM A780 AND MANUFACTURER'S RECOMMENDATIONS
- DO NOT DRILL HOLES THROUGH STRUCTURAL STEEL MEMBERS EXCEPT AS SHOWN AND DETAILED ON STRUCTURAL DRAWINGS.
- CONNECTIONS:
  - A. ALL WELDING TO BE PERFORMED BY AWS CERTIFIED WELDERS AND CONDUCTED IN ACCORDANCE WITH THE LATEST EDITION OF THE AWS WELDING CODE D1.1.

- ALL WELDS SHALL BE INSPECTED VISUALLY. 25% OF WELDS SHALL BE INSPECTED WITH DYE PENETRANT OR MAGNETIC PARTICLE TO MEET THE ACCEPTANCE CRITERIA OF AWS D1 1 REPAIR ALL WELDS AS NECESSARY
- C. INSPECTION SHALL BE PERFORMED BY AN AWS CERTIFIED WELD INSPECTOR.
- D. IT IS THE CONTRACTORS RESPONSIBILITY TO PROVIDE BURNING/WELDING PERMITS AS REQUIRED BY LOCAL GOVERNING AUTHORITY AND IF REQUIRED SHALL HAVE FIRE DEPARTMENT DETAIL FOR ANY WELDING ACTIVITY.
- E. ALL ELECTRODES TO BE LOW HYDROGEN, MATCHING FILLER METAL, PER AWS D1.1, UNLESS NOTED OTHERWISE
- F. MINIMUM WELD SIZE TO BE 0.1875 INCH FILLET WELDS, UNLESS NOTED
- G PRIOR TO FIELD WELDING GALVANIZING MATERIAL CONTRACTOR SHALL GRIND OFF GALVANIZING ½" BEYOND ALL FIELD WELD SURFACES. AFTER WELD AND WELD INSPECTION IS COMPLETE, REPAIR ALL GROUND AND WELDED SURFACES WITH ZRC GALVILITE COLD GALVANIZING COMPOUND PER ASTM A780 AND MANUFACTURERS RECOMMENDATIONS.
- THE CONTRACTOR SHALL PROVIDE ADEQUATE SHORING AND/OR BRACING WHERE REQUIRED DURING CONSTRUCTION UNTIL ALL CONNECTIONS ARE
- ANY FIELD CHANGES OR SUBSTITUTIONS SHALL HAVE PRIOR APPROVAL FROM THE ENGINEER, AND VERIZON PROJECT MANAGER IN WRITING

# ANTENNA INSTALLATION NOTES:

- WORK INCLUDED:
  - ANTENNA AND COAXIAL CABLES ARE FURNISHED BY VERIZON UNDER A SEPARATE CONTRACT. THE CONTRACTOR SHALL ASSIST ANTENNA INSTALLATION CONTRACTOR IN TERMS OF COORDINATION AND SITE ACCESS ERECTION SUBCONTRACTOR SHALL BE RESPONSIBLE FOR THE PROTECTION OF
  - B. INSTALL ANTENNAS AS INDICATED ON DRAWINGS AND VERIZON SPECIFICATIONS.
  - C. INSTALL GALVANIZED STEEL ANTENNA MOUNTS AS INDICATED ON DRAWINGS.
  - D. INSTALL FURNISHED GALVANIZED STEEL OR ALUMINUM WAVEGUIDE AND PROVIDE PRINTOUT OF THAT TEST
  - F CONTRACTOR SHALL PROVIDE FOLIR (4) SETS OF SWEEP TESTS LISING ANRITZU-PACKARD 8713B RF SCALAR NETWORK ANALYZER. SUBMIT FREQUENCY DOMAIN REFLECTOMETER(FDR) TESTS RESULTS TO THE PROJECT MANAGER. SWEEP TESTS SHALL BE AS PER ATTACHED RES "MINIMUM FIELD TESTING RECOMMENDED FOR ANTENNA AND HELIAX COAXIAL CABLE SYSTEMS" DATED 10/5/93, TESTING SHALL BE PERFORMED BY AN INDEPENDENT TESTING SERVICE AND BE BOUND AND SUBMITTED WITHIN ONE WEEK OF WORK COMPLETION.
  - INSTALL COAXIAL CABLES AND TERMINATING BETWEEN ANTENNAS AND EQUIPMENT PER MANUFACTURER'S RECOMMENDATIONS. WEATHERPROOF ALL CONNECTIONS BETWEEN THE ANTENNA AND EQUIPMENT PER MANUFACTURER'S REQUIREMENTS. TERMINATE ALL COAXIAL CABLE THREE (3) FEET IN EXCESS OF ENTRY PORT LOCATION UNLESS OTHERWISE STATED.
  - G. ANTENNA AND COAXIAL CABLE GROUNDING:
- ALL EXTERIOR #6 GREEN GROUND WIRE "DAISY CHAIN" CONNECTIONS ARE TO BE WEATHER SEALED WITH RFS CONNECTORS/SPLICE WEATHERPROOFING KIT #221213 OR
- ALL COAXIAL CABLE GROUNDING KITS ARE TO BE INSTALLED ON STRAIGHT RUNS OF COAXIAL CABLE (NOT WITHIN BENDS).

### CONCRETE AND REINFORCING STEEL NOTES:

- DESIGN AND CONSTRUCTION OF ALL CONCRETE ELEMENTS SHALL CONFORM TO THE LATEST EDITIONS OF ALL APPLICABLE CODES INCLUDING: ACI 301 "SPECIFICATIONS FOR STRUCTURAL CONCRETE FOR BUILDINGS", ACI 117 "SPECIFICATIONS FOR TOLERANCES FOR CONCRETE CONSTRUCTION AND MATERIALS", AND ACI 318 "BUILDING CODE REQUIREMENTS FOR REINFORCED CONCRETE.'
- 2. MIX DESIGN SHALL BE APPROVED BY VERIZON, REP PRIOR TO PLACING CONCRETE
- CONCRETE SHALL BE NORMAL WEIGHT, 6 % AIR ENTRAINED (+/- 1.5%) WITH A SLUMP RANGE OF 3-6" AND HAVE A MINIMUM 28-DAY COMPRESSIVE STRENGTH OF 4500 PSI UNLESS OTHERWISE NOTED.
- THE FOLLOWING MATERIALS SHALL BE USED: PORTLAND CEMENT: ASTM C150, TYPE 2

REINFORCEMENT: ASTM A185 PLAIN STEEL WELDED WIRE FARRIC

REINFORCEMENT BARS: ASTM A615, GRADE 60, DEFORMED

NORMAL WEIGHT AGGREGATE: ASTM C33 WATER: ASTM C 94/C 94M

-AIR-ENTERING AGENT:

WELDED WIRE FABRIC ASTM A185 ADMIXTURES: -WATER-REDUCING AGENT: ASTM C 494/C 494M, TYPE A

> -SUPERPLASTICIZER: ASTM C494, TYPE F OR TYPE G -RETARDING: ASTM C 494/C 494M, TYPE B

ASTM C 260/C 260M

- MINIMUM CONCRETE COVER FOR REINFORCING STEEL SHALL BE NO LESS THAN 3".
- A 3/4" CHAMFER SHALL BE PROVIDED AT ALL EXPOSED EDGES OF CONCRETE IN ACCORDANCE WITH ACI 301 SECTION 4.2.4 LINLESS NOTED OTHERWISE
- INSTALLATION OF CONCRETE EXPANSION/WEDGE ANCHOR SHALL BE PER MANUFACTURER'S WRITTEN RECOMMENDED PROCEDURE. THE ANCHOR BOLT, DOWEL OR ROD SHALL CONFORM TO MANUFACTURER'S RECOMMENDATION FOR EMBEDMENT DEPTH OR AS SHOWN ON THE DRAWINGS. NO REBAR SHALL BE CUT WITHOUT PRIOR APPROVAL FROM AN ATC ENGINEER WHEN DRILLING HOLES IN CONCRETE
- ADMIXTURES SHALL CONFORM TO THE APPROPRIATE ASTM STANDARD AS REFERENCED IN "METHOD 1" OF ACI 301.
- DO NOT WELD OR TACK WELD REINFORCING STEEL.
- ALL DOWELS, ANCHOR BOLTS, EMBEDDED STEEL, ELECTRICAL CONDUITS, PIPE SLEEVES, GROUNDS AND ALL OTHER EMBEDDED ITEMS AND FORMED DETAILS SHALL BE IN PLACE BEFORE START OF CONCRETE PLACEMENT.
- REINFORCEMENT SHALL BE COLD BENT WHENEVER BENDING IS REQUIRED.
- 12. DO NOT PLACE CONCRETE IN WATER, ICE, OR ON FROZEN GROUND.
- FOR COLD-WEATHER (ACI 306) AND HOT-WEATHER (ACI 301M) CONCRETE PLACEMENT, CONFORM TO APPLICABLE ACI CODES AND RECOMMENDATIONS. IN EITHER CASE, MATERIALS CONTAINING CHLORIDE, CALCIUM, SALTS, ETC. SHALL NOT BE USED. PROTECT FRESH CONCRETE FROM WEATHER FOR 7 DAYS, MINIMUM.
- ALL CONCRETE SHALL HAVE A "SMOOTH FORM FINISH."
- SPLICING OF REINFORCEMENT IS PERMITTED ONLY AT LOCATIONS SHOWN IN THE CONTRACT DRAWINGS OR AS ACCEPTED BY THE ENGINEER. UNLESS OTHERWISE SHOWN OR NOTED REINFORCING STEEL SHALL BE SPLICED TO DEVELOP ITS FULL TENSILE CAPACITY (CLASS A) IN ACCORDANCE WITH ACI 318.
- DETAILING OF REINFORCING STEEL SHALL CONFORM TO "ACI MANUAL OF STANDARD PRACTICE FOR DETAILING REINFORCED CONCRETE STRUCTURES" (ACI 315)
- ALL SLAB CONSTRUCTION SHALL BE CAST MONOLITHICALLY WITHOUT HORIZONTAL CONSTRUCTION JOINTS, UNLESS SHOWN IN THE CONTRACT DRAWINGS.
- LOCATION OF ALL CONSTRUCTION JOINTS ARE SUBJECT TO THE REQUIREMENTS OF THE CONTRACT DOCUMENTS, CONFORMANCE WITH ACI 318, AND ACCEPTANCE OF THE ENGINEER. DRAWINGS SHOWING LOCATION OF DETAILS OF THE PROPOSED CONSTRUCTION JOINTS SHALL BE SUBMITTED WITH REINFORCING STEEL PLACEMENT
- SPLICES OF WWF, AT ALL SPLICED EDGES, SHALL BE SUCH THAT THE OVERLAP MEASURED BETWEEN OUTERMOST CROSS WIRES OF EACH FABRIC SHEET IS NOT LESS THAN THE SPACING OF THE CROSS WIRE PLUS 2 INCHES. NOR LESS THAN 6".
- BAR SUPPORTS SHALL BE ALL-GALVANIZED METAL WITH PLASTIC TIPS
- ALL REINFORCEMENT SHALL BE SECURELY TIED IN PLACE TO PREVENT DISPLACEMENT BY CONSTRUCTION TRAFFIC OR CONCRETE. TIE WIRE SHALL BE OF SUFFICIENT STRENGTH FOR INTENDED PURPOSE, BUT NOT LESS THAN NO. 18 GAUGE.
- SLAB ON GROUND: COMPACT STRUCTURAL FILL TO 95% DENSITY AND THEN PLACE 6"

#### **ELECTRICAL NOTES:**

- ELECTRICAL WORK SHALL BE PERFORMED BY ELECTRICAL CONTRACTOR. ELECTRICAL CONTRACTOR SHALL ENSURE THAT ALL WORK COMPLIES WITH ALL APPLICABLE LOCAL AND STATE CODES AND NATIONAL ELECTRICAL CODE.
- ALL SUGGESTED ELECTRICAL ELEMENTS (SUCH AS BREAKER SIZES, WIRE SIZES, CONDUITS SIZES) ARE FOR ZONING PURPOSES ONLY. IT IS THE RESPONSIBILITY TO OF THE ELECTRICAL CONTRACTOR TO CONFIRM COMPLIANCE WITH LOCAL ELECTRICAL CODES AND PASS ALL APPLICABLE AND NECESSARY INSPECTIONS. IN SOME EVENTS, IT MAY BE NECESSARY TO PERFORM AN ELECTRICAL LOAD STUDY TO VERIFY THE CAPACITY OF THE EXISTING SERVICE. THIS IS NOT THE RESPONSIBILITY OF ATC. IT IS THE RESPONSIBILITY OF THE ELECTRICAL CONTRACTOR.
- CONTRACTOR SHALL FIELD LOCATE ALL BELOW GRADE GROUNDING CABLES AND UTILITY LINES PRIOR TO CONSTRUCTION. CONTRACTOR IS RESPONSIBLE FOR RELOCATION OF ALL UTILITIES AND GROUNDING LINES THAT MAY BECOME DISTURBED OR CONFLICTING IN THE COURSE OF CONSTRUCTION.

ALL DISCREPANCIES FROM WHAT IS SHOWN ON THESE CONSTRUCTION DRAWINGS SHALL BE COMMUNICATED TO ATC ENGINEERING IMMEDIATELY FOR CORRECTION OR RE-DESIGN. FAILURE TO COMMUNICATE DIRECTLY WITH ATC ENGINEERING OR ANY CHANGES FROM THE DESIGN CONDUCTED WITHOUT PRIOR APPROVAL FROM ATC ENGINEERING SHALL BE THE SOLE RESPONSIBILITY OF THE GENERAL CONTRACTOR.





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SITE ADDRESS: 790 WILLIS STREET BRISTOL, CT 06010-7269

SEAL





CUSTOMER #: 5000917346 (780529)

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GENERAL NOTES

SHEET NUMBER:

G-002



- DEWBERRY HAS NOT BEEN CONTRACTED TO PERFORM AN BOUNDARY AND TOPOGRAPHIC SURVEY AT THIS SITE.
- 2. SURVEY INFORMATION OBTAINED FROM SURVEY PROVIDED BY ATC, PREPARED FOR SPECTRASITE COMUNICATIONS, ON 01/28/03





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<u>B</u>	PRELIM	VL	08/30/23
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<u>/1</u>	FINAL	VL	01/22/24
$\wedge$			

ATC SITE NUMBER: 302500 ATC SITE NAME:

**BRST - BRISTOL** 

VERIZON SITE NAME:

### **BRISTOL SW CT**

SITE ADDRESS: 790 WILLIS STREET BRISTOL, CT 06010-7269





ATC JOB NO:

PROFESSIONAL AND SURVEYO

CUSTOMER ID: BRISTOL SW CT


CUSTOMER #: 5000917346 (780529)

**OVERALL SITE PLAN** 

SHEET NUMBER:

C-001

REVISION

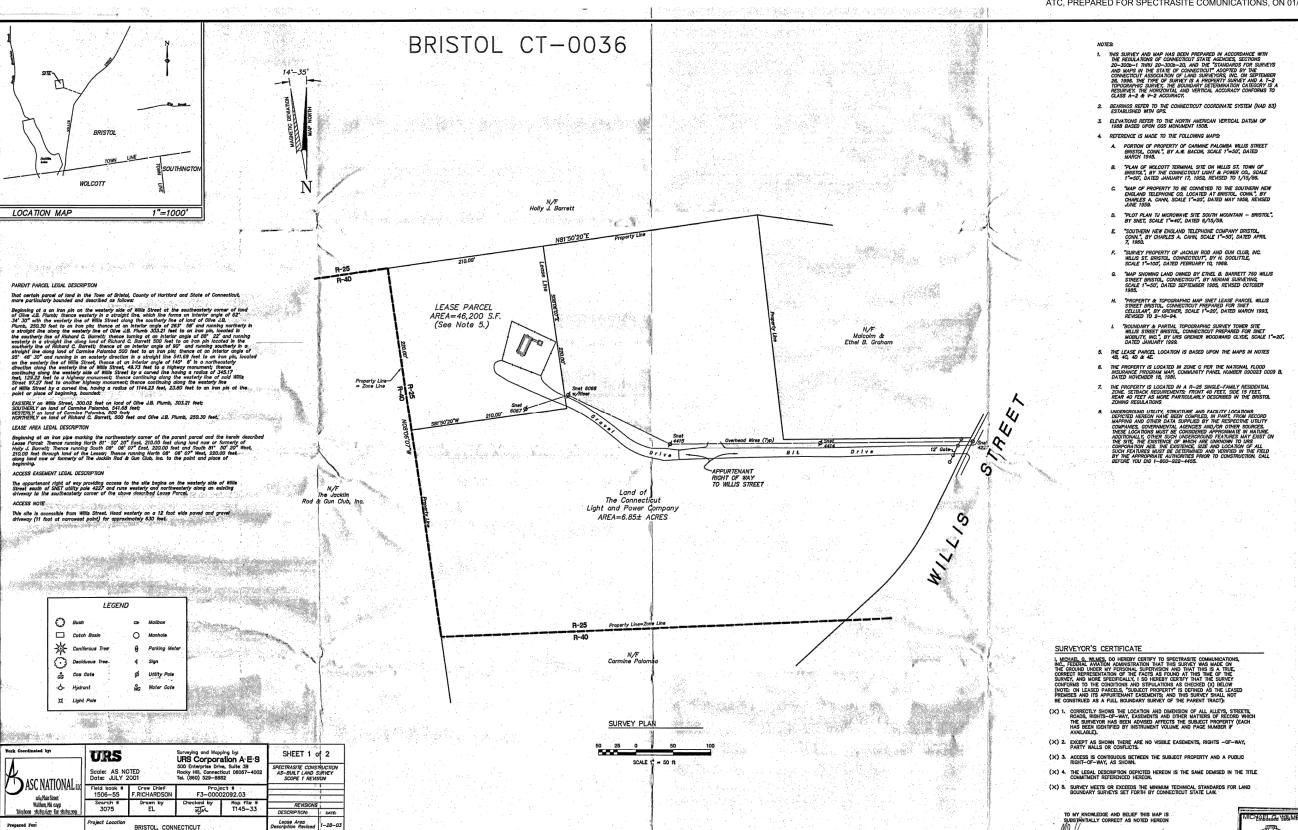

SPECTRASITE COMMUNICATIONS



- KNOWLEDGE AVAILABLE TO THE ENGINEER AT THE TIME OF THIS DESIGN. THE CONTRACTOR SHALL VISIT THE SITE PRIOR TO CONSTRUCTION AND VERIFY ALL EXISTING CONDITIONS RELATED TO THE SCOPE OF WORK FOR THIS PROJECT.
- ICE BRIDGE, CABLE LADDER, COAX PORT, AND COAX CABLE ARE SHOWN FOR REFERENCE ONLY. CONTRACTOR SHALL CONFIRM THE EXACT LOCATION OF ALL PROPOSED AND EXISTING EQUIPMENT AND STRUCTURES DEPICTED ON THIS PLAN. BEFORE UTILIZING EXISTING CABLE SUPPORTS, COAX PORTS, INSTALLING NEW PORTS OR ANY OTHER EQUIPMENT, CONTRACTOR SHALL VERIFY ALL ASPECTS OF THE COMPONENTS MEET THE ATC SPECIFICATIONS.
- IT IS THE RESPONSIBILITY OF THE CONTRACTOR TO COORDINATE WITH THE VERIZON REPRESENTATIVE AND LOCAL UTILITY COMPANY FOR THE INSTALLATION OF CONDUITS CONDUCTORS, BREAKERS, DISCONNECTS, OR ANY OTHER EQUIPMENT REQUIRED FOR ELECTRICAL SERVICE. ALL ELECTRICAL WORK SHALL BE PERFORMED IN ACCORDANCE WITH LATEST EDITION OF THE STATE AND NATIONAL CODES, ORDINANCES AND REGULATIONS APPLICABLE TO THIS PROJECT.
- CONTRACTOR TO PROVIDE STRUCTURAL FILL AS REQUIRED TO LEVEL COMPOUND FOR PROPOSED PAD. REFER TO SHEET C-505, DETAIL 3 FOR BACKFILL REQUIREMENTS.

#### LEGEND

GROUNDING TEST WELL AUTOMATIC TRANSFER SWITCH ATS BOLLARD CELL SITE CABINET CSC

DISCONNECT ELECTRICAL FIBER

GEN **GENERATOR** GENERATOR RECEPTACLE HH, V HAND HOLE, VAULT


ICE BRIDGE KENTROX BOX

LIGHTING CONTROL METER PULL BOX

POWER POLE TELCO TRN TRANSFORMER

> CHAINLINK FENCE PROPOSED CABLE NOTES:

- ESTIMATED LENGTH OF PROPOSED CABLE IS <u>181</u>'. ESTIMATED LENGTH OF CABLE WAS PROVIDED BY CUSTOMER OR CALCULATED BY ADDING THE RAD CENTER AND THE DISTANCE FROM THE SHELTER ENTRY PLATE TO THE TOWER (ALONG THE ICE BRIDGE) AND A SAFETY FACTOR MEASUREMENT OF 15% (OF THE TWO PREVIOUS VALUES), CDS DEFER TO GREATEST CABLE LENGTH.
- ROUTE PROPOSED CABLES ALONG SAME PATH AS EXISTING CABLES AND IN ACCORDANCE WITH STRUCTURAL ANALYSIS. IF ADEQUATE SPACE EXISTS, ROUTE CABLES THROUGH ENTRY PORT HOLE, UP INSIDE OF MONOPOLE, AND THROUGH EXIT PORT HOLE. IF ROUTING OUTSIDE THE MONOPOLE, ATTACH CABLES USING STAND-OFF ADAPTERS MOUNTED TO TOWER USING STAINLESS STEEL BANDING. ADEQUATELY SECURE CABLES USING EITHER APPROPRIATELY SIZED STAINLESS STEEL SNAP-INS OR MOUNTING HARDWARE AND BRACKETS AS SPECIFIED BY CABLE MANUFACTURER.

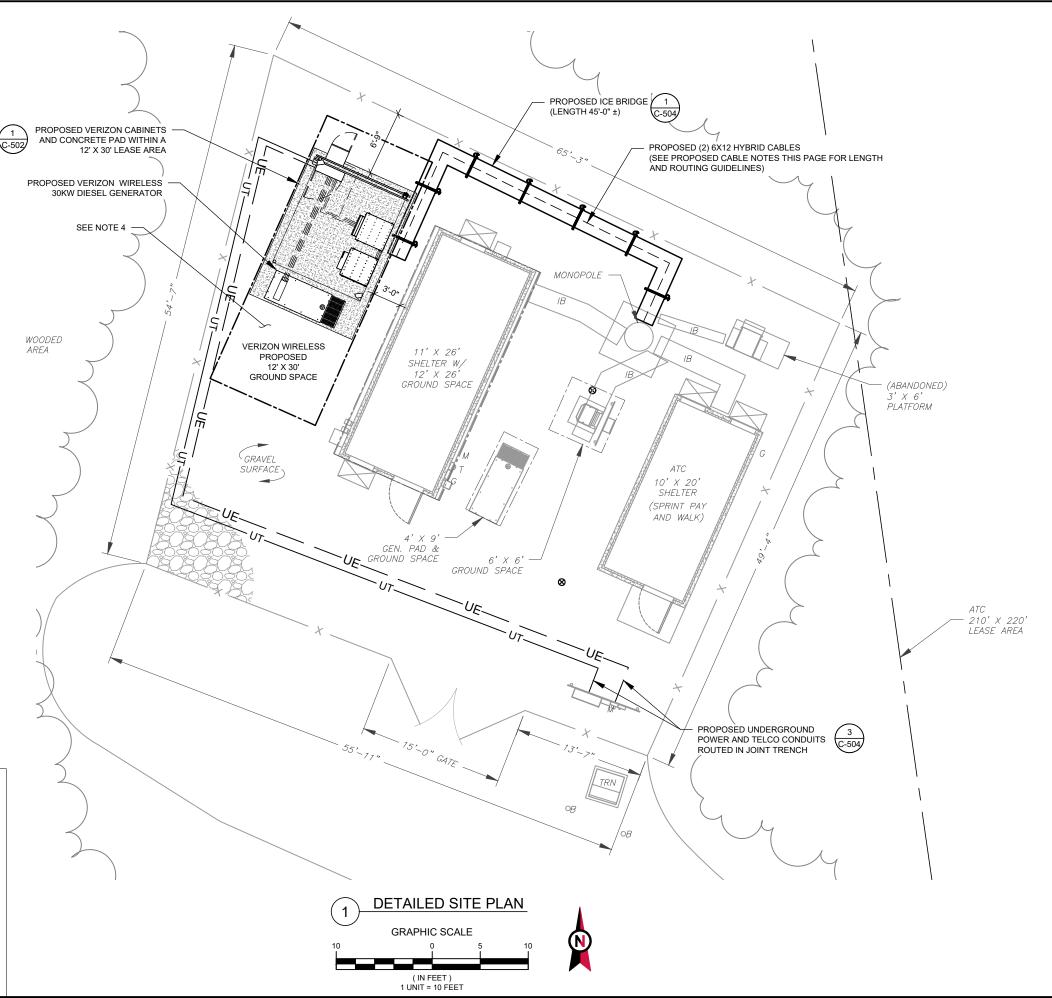





Dewberry Engineers Inc. 99 SUMMER STREET SUITE 700 BOSTON, MA 02110 PHONE: 617.695.3400 FAX: 617.695.3310

REV.	DESCRIPTION	BY	DATE
<u> </u>	PRELIM	<u>HMP</u>	08/07/23
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<u></u>	FINAL	VL_	12/21/23
1	FINAL	VL	01/22/24
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ATC SITE NUMBER: 302500 ATC SITE NAME:

**BRST - BRISTOL** 

VERIZON SITE NAME:

**BRISTOL SW CT** 

SITE ADDRESS: 790 WILLIS STREET BRISTOL, CT 06010-7269



ATC JOB NO:

CUSTOMER ID: BRISTOL SW CT

CUSTOMER #: 5000917346 (780529)

**DETAILED SITE PLAN** 

SHEET NUMBER:

C-101

PER MOUNT ANALYSIS COMPLETED BY COLLIERS ENGINEERING & DESIGN, DATED 11/06/23, THE THE PROPOSED LOADING.

PROPOSED MOUNT CAN ADEQUATELY SUPPORT





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REV.	DESCRIPTION	BY	DATE
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ATC SITE NUMBER: 302500 ATC SITE NAME:

**BRST - BRISTOL** 

VERIZON SITE NAME:

#### **BRISTOL SW CT**

SITE ADDRESS: 790 WILLIS STREET BRISTOL, CT 06010-7269





ATC JOB NO:

14430738\_G2 CUSTOMER ID: BRISTOL SW CT

CUSTOMER #: 5000917346 (780529)

**TOWER ELEVATION** 

SHEET NUMBER:

C-201

REVISION:

TOWER ELEVATION SCALE: N.T.S.

EXISTING TOWER

EXISTING TOP
OF BASE PLATE

TOP OF EXISTING HIGHEST APPURTENANCE

TOP OF EXISTING TOWER

ELEV 130.5

ELEV 120'

PROPOSED VERIZON EQUIPMENT

PROPOSED

(2) 6X12 HYBRID CABLES (SEE CABLE NOTES ON C-101)

EXISTING CARRIER ANTENNAS
RAD CENTER @ ELEV 124'

PROPOSED VERIZON RAD CENTER @ 112'


> WER NOTE:
> IT IS THE CONTRACTOR'S RESPONSIBILITY TO
> CONFIRM WITH THE PROJECT MANAGER THAT THEY HAVE THE MOST RECENT VERSION OF THE STRUCTURAL ANALYSIS BEFORE COMMENCING WORK. EXISTING AND PROPOSED TOWER APPURTENANCES, MOUNTS, AND ANTENNAS ARE SHOWN BASED ON THE STRUCTURAL ANALYSIS.

2. WHERE APPLICABLE, ALL NEW ANTENNAS, EQUIPMENT, MOUNTS, CABLING, ETC. SHALL BE PAINTED/SOCKED TO MATCH EXISTING EQUIPMENT IN ACCORDANCE WITH FAA, JURISDICTION, AND/OR OTHER LOCAL REQUIREMENTS.

3. ROUTE PROPOSED CABLES ALONG SAME PATH AS EXISTING CABLES AND IN ACCORDANCE WITH STRUCTURAL ANALYSIS. IF ADEQUATE SPACE EXISTS, ROUTE CABLES THROUGH ENTRY PORT HOLE, UP INSIDE OF MONOPOLE, AND THROUGH EXIT PORT HOLE. IF ROUTING OUTSIDE THE MONOPOLE, ATTACH CABLES USING STAND-OFF ADAPTERS MOUNTED TO TOWER USING STAINLESS STEEL BANDING. ADEQUATELY SECURE CABLES USING EITHER APPROPRIATELY SIZED STAINLESS STEEL SNAP-INS OR MOUNTING HARDWARE AND BRACKETS AS SPECIFIED BY CABLE

MANUFACTURER.
TOWER ELEVATIONS ARE MEASURED FROM TOP OF BASE PLATE TO MATCH STRUCTURAL ANALYSIS. ELEVATIONS DO NOT REFLECT TRUE ABOVE GROUND LEVEL (A.G.L.)

TOWER ELEVATION DEPICTION MAY NOT REFLECT ALL EQUIPMENT INCLUDED IN STRUCTURAL ANALYSIS. REFER TO STRUCTURAL ANALYSIS FOR FULL TOWER LOADING.

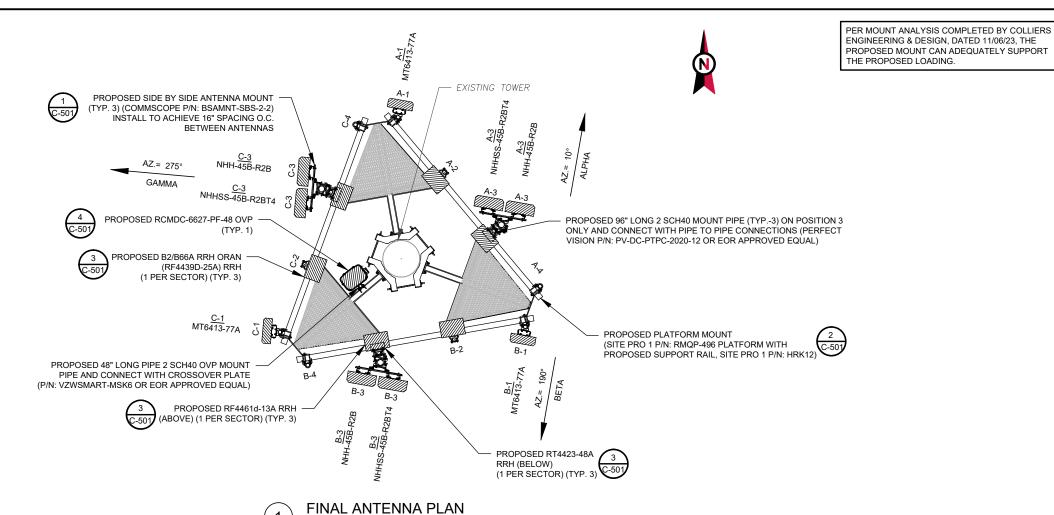

				FINAL EQUIPM	MENT SCHEDULE			
LOCATION				ANTENNA SUMMARY			MMARY	
SECTOR	RAD	AZ	POS	ANTENNA	BAND	ADDITIONAL TOWER MOUNTED EQUIPMENT	CABLE DESCRIPTION	
			A1	MT6413-77A	5G L-SUB6	-		
			A2	-	-	B2/B66A RRH ORAN (RF4439D-25A)		
ALPHA	112'	10°	A3	NHHSS-45B-R2BT4	LTE 700, LTE 850, 5G 850, LTE AWS, LTE CBRS	RF4461D-13A RRH (ABOVE)		
			A3	NHH-45B-R2B	LTE 700, 5G 850, LTE 850, LTE 1900	RT4423-48A RRH (BELOW)		
			A4	-	-	-		
			B1	MT6413-77A	5G L-SUB6	-		
				B2	-	-	B2/B66A RRH ORAN (RF4439D-25A)	(2) 6X12 HYBR
BETA	112'	190°	В3	NHHSS-45B-R2BT4	LTE 700, LTE 850, 5G 850, LTE AWS, LTE CBRS	RF4461D-13A RRH (ABOVE)	(2) 57(12111311	
			В	NHH-45B-R2B	LTE 700, 5G 850, LTE 850, LTE 1900	RT4423-48A RRH (BELOW)		
			B4	-	-	-		
			C1	MT6413-77A	5G L-SUB6	-		
			C2	-	-	B2/B66A RRH ORAN (RF4439D-25A)		
GAMMA	112'	275°	С3	NHHSS-45B-R2BT4	LTE 700, LTE 850, 5G 850, LTE AWS, LTE CBRS	RF4461D-13A RRH (ABOVE)		
			63	NHH-45B-R2B	LTE 700, 5G 850, LTE 850, LTE 1900	RT4423-48A RRH (BELOW)		
			C4	-	-	_		

- 1. CONFIRM WITH CARRIER REP FOR APPLICABLE UPDATES/REVISIONS AND MOST RECENT RFDS.
- 2. ALL PROPOSED EQUIPMENT INCLUDING ANTENNAS, COAX, ETC. SHALL BE MOUNTED IN ACCORDANCE WITH THE TOWER STRUCTURAL ANALYSIS ON FILE WITH THE ATC CM.
- 3. SPACING OF PROPOSED EQUIPMENT SHALL BE CONFIRMED FOR TOWER CONFLICTS AND PROPOSED MOUNTS SHALL NOT IMPEDE TOWER CLIMBING PEGS.
- 4. INSTALL (1) RCMDC-6627-PF-48 OVP.

RF JUMPER LENGTH

MONOPOLE = 15'±
GUYED / SELF SUPPORT = FACE WIDTH + 15'

REFER TO FINAL RFDS FOR TYPE AND QUANTITY

AMERICAN TOWER®



Dewberry Engineers Inc.
99 SUMMER STREET
SUITE 700
BOSTON, MA 02110
PHONE: 617.695.3400
FAX: 617.695.3310

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ATC SITE NUMBER: 302500
ATC SITE NAME:

BRST - BRISTOL

VERIZON SITE NAME:

**BRISTOL SW CT** 

SITE ADDRESS: 790 WILLIS STREET BRISTOL, CT 06010-7269

SEA






ATC JOB NO: 14430738\_G2
CUSTOMER ID: BRISTOL SW CT
CUSTOMER #: 5000917346 (780529)

ANTENNA INFORMATION & SCHEDULE

SHEET NUMBER:

C-401

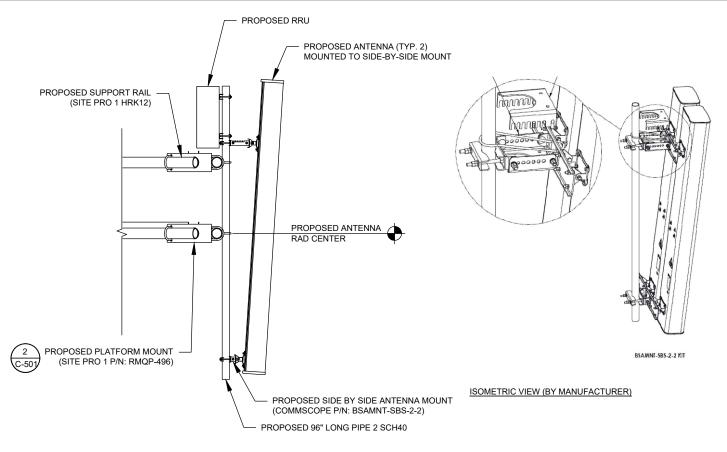

PROPOSED SUPPORT RAIL
(SITE PRO 1 HRK12)

PROPOSED MOUNTING PIPE


PROPOSED PLATFORM MOUNT
(SITE PRO 1 P/N: RMQP-496)

PROFILE VIEW

# PROPOSED ANTENNA MOUNTING DETAIL (ELEVATION)

SCALE: N.T.S

2 ISOMETRIC MOUNT DETAIL
SCALE: N.T.S.

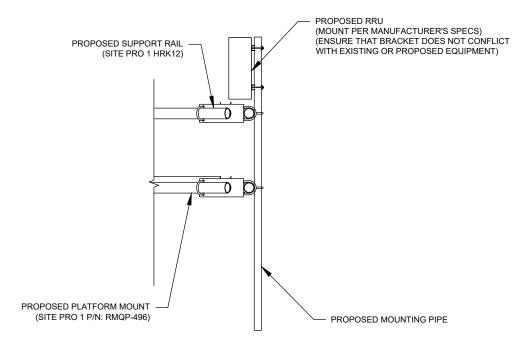

PROPOSED OVP
(MOUNT PER
MANUFACTURER'S SPECS)
(ENSURE THAT BRACKET DOES
NOT CONFLICT WITH EXISTING
OR PROPOSED EQUIPMENT)

PROPOSED MOUNTING
PIPE ATTACHED
PROPOSED STAND-OFF
SUPPORT

PROPOSED PLATFORM
STAND-OFF SUPPORT

PROPOSED CABINET

PROPOSED 3/8"Ø SIMPSON STRONG-BOLT® 2 WEDGE ANCHOR OR EQUIVALENT GC TO INSTALL PER ICC# ESR-3037

PROPOSED CONCRETE PAD

NOTE:

INSTALL SIMPSON STRONG-TIE® STRONG-BOLT® 2 WEDGE ANCHOR(S) STRICTLY PER INSTALLATION INSTRUCTIONS INCLUDED WITH PRODUCT OR FOUND ONLINE AT WWW.STRONGTIE.COM. PROPER INSTALLATION IS CRITICAL FOR FULL PERFORMANCE.

PROPOSED RRU MOUNTING DETAIL - TYPICAL

4 PROPOSED OVP MOUNTING
SCALE: N.T.S.

(5) C

CABINET ATTACHMENT DETAIL

SCALE: N.T.S.





Dewberry Engineers Inc.

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SUITE 700
BOSTON, MA 02110
PHONE: 617.695.3400
FAX: 617.695.3310

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BRST - BRISTOL

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**BRISTOL SW CT** 

SITE ADDRESS: 790 WILLIS STREET BRISTOL, CT 06010-7269

SEAL






ATC JOB NO: 14430738\_G2
CUSTOMER ID: BRISTOL SW CT
CUSTOMER #: 5000917346 (780529)

**MOUNT DETAILS** 

SHEET NUMBER:

C-501

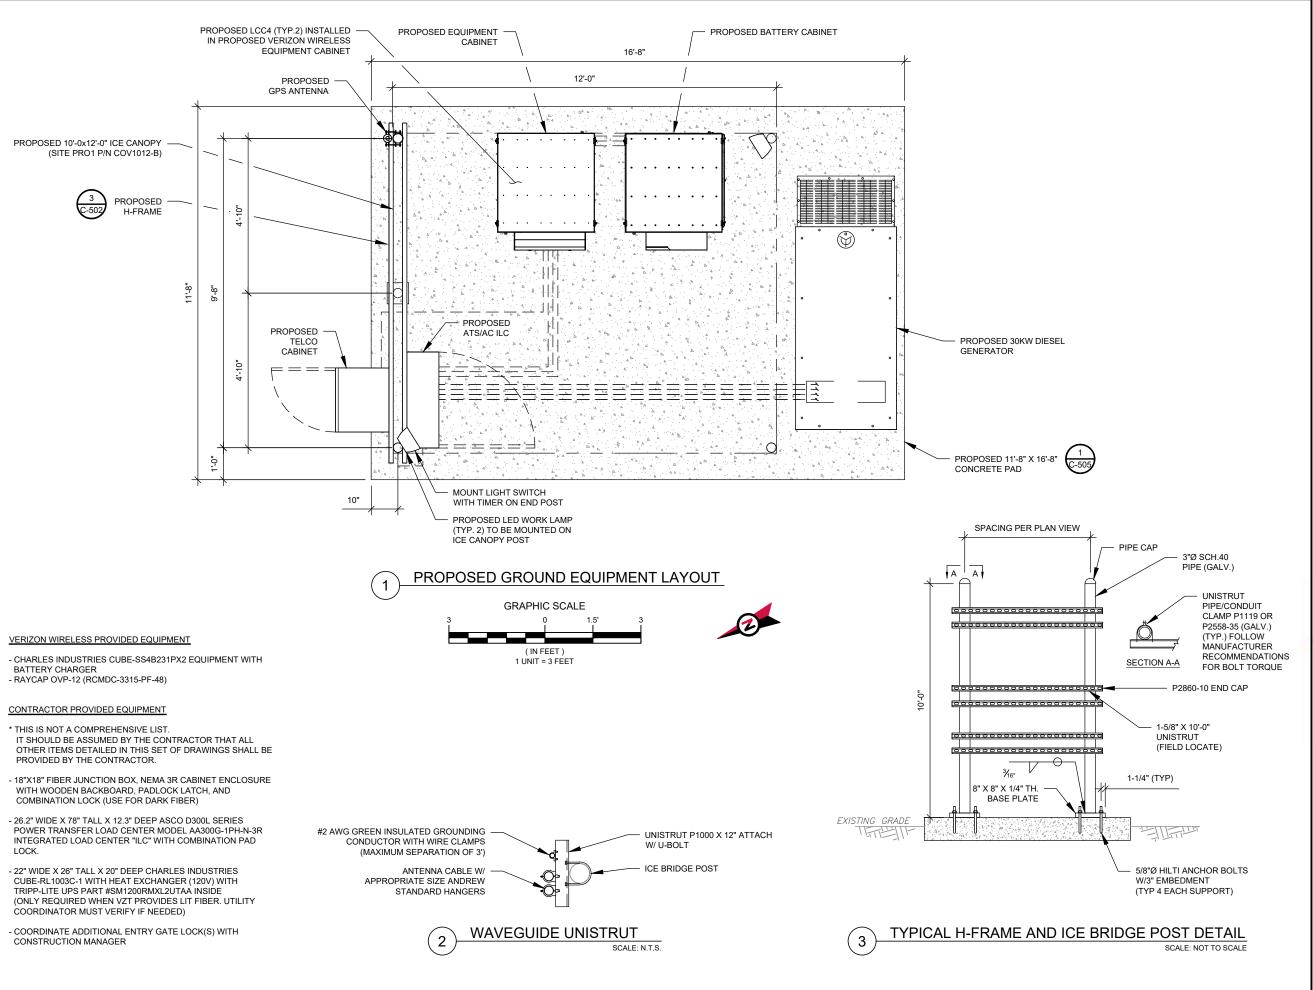





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<u></u>	FINAL	VL	01/22/24
$\wedge$			

ATC SITE NUMBER: 302500 ATC SITE NAME:

**BRST - BRISTOL** 

VERIZON SITE NAME:

**BRISTOL SW CT** 

SITE ADDRESS: 790 WILLIS STREET BRISTOL, CT 06010-7269





ATC JOB NO:

14430738\_G2 CUSTOMER ID: BRISTOL SW CT

CUSTOMER #: 5000917346 (780529) CONSTRUCTION


**DETAILS** 

SHEET NUMBER:


C-502



- NOTE:
  1. INTERCONNECTING CONDUITS SHALL BE INSTALLED AT OR ABOVE GRADE.
- 2. BOTTOM OF OVP'S SHALL NOT EXCEED 36" ABOVE FINISHED GRADE.

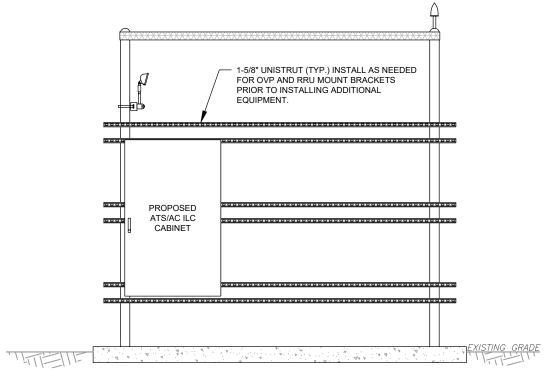

### FRONT VIEW

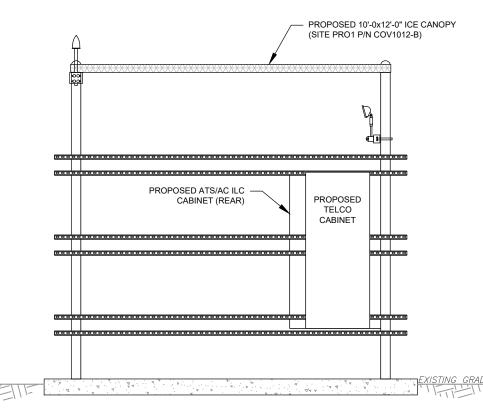

REAR VIEW

**DETAILED H-FRAME LAYOUT** 





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<u> </u>	PRELIM	HMP	08/07/23
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**BRST - BRISTOL** 

VERIZON SITE NAME:

**BRISTOL SW CT** 

SITE ADDRESS: 790 WILLIS STREET BRISTOL, CT 06010-7269






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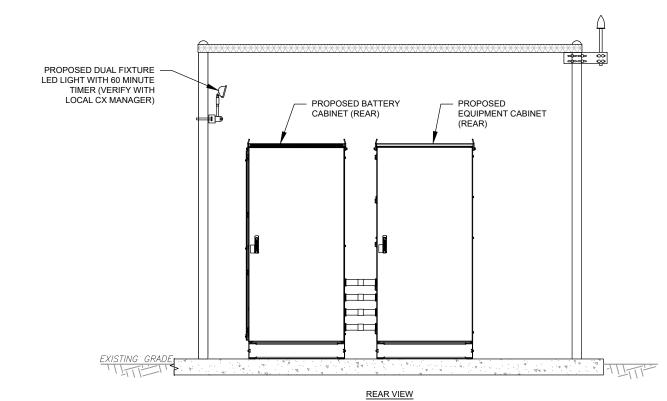
CUSTOMER ID: BRISTOL SW CT CUSTOMER #: 5000917346 (780529)

> CONSTRUCTION **DETAILS**

C-503

REVISION:




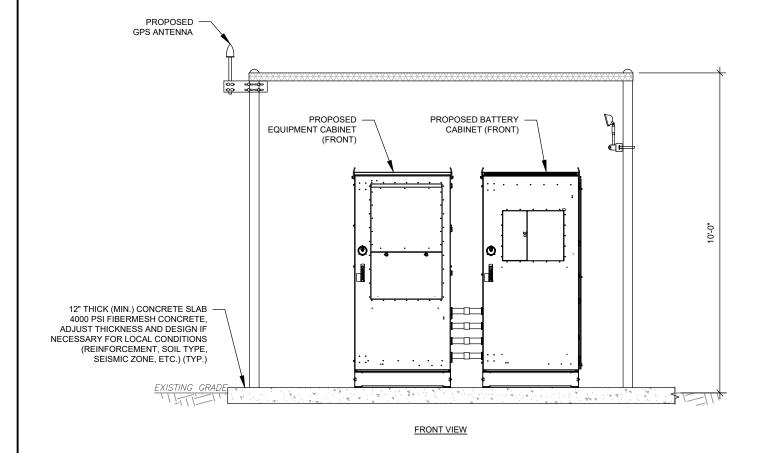


**DETAILED CABINET LAYOUT** 

#### CONSTRUCTION NOTE:

INSTALL ICE BRIDGE TO ALLOW 7 FEET CLEARANCE ABOVE GRADE TO LOWEST APPURTENANCE.

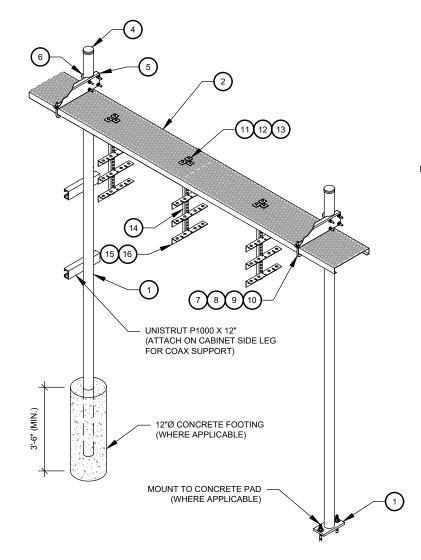


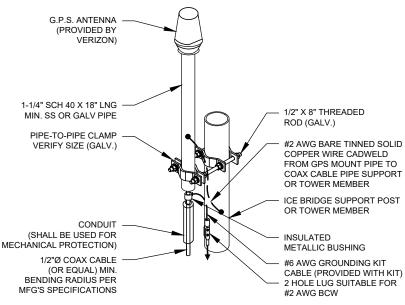

- 1. GPS SHALL BE PLACED WITH CLEAR SIGHT LINE TO THE SOUTHERN SKY.
- 2. CONTRACTOR TO SUPPLY COAX FOR GPS UNIT.

**GPS ANTENNA ATTACHMENT DETAIL** 2

SCALE: N.T.S.

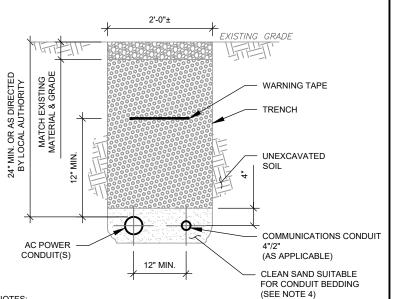

#### TRENCH NOTES:

- IF FREE OF ORGANIC OR OTHER DELETERIOUS MATERIAL, EXCAVATED MATERIAL MAY BE USED FOR BACKFILL. IF NOT, PROVIDE CLEAN, COMPACTIBLE MATERIAL.
- COMPACT IN 8" LIFTS. REMOVE ANY LARGE ROCKS PRIOR TO BACKFILLING. CONTRACTOR TO VERIFY LOCATION OF EXISTING U/G UTILITIES PRIOR TO DIGGING.
- IF CURRENT AS-BUILT DRAWINGS ARE NOT AVAILABLE CONTRACTOR SHALL HAND DIG U/G TRENCHING.
- USE COMMUNICATIONS ONLY TRENCH FOR COMMUNICATIONS CONDUIT UNLESS TRAVELING UNDER PATH OF VEHICLE TRAVEL, THEN CONDUIT MUST BE 24" MIN. BELOW
- CONFIRM SPACING AND DEPTH WITH NEC OR LOCAL CODE REQUIREMENTS







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ATC SITE NUMBER: 302500 ATC SITE NAME:

**BRST - BRISTOL** 

VERIZON SITE NAME:

**BRISTOL SW CT** 

SITE ADDRESS: 790 WILLIS STREET BRISTOL, CT 06010-7269






ATC JOB NO: 14430738\_G2 CUSTOMER ID: BRISTOL SW CT CUSTOMER #: 5000917346 (780529)

CONSTRUCTION **DETAILS** 

REVISION


SHEET NUMBER


C-504

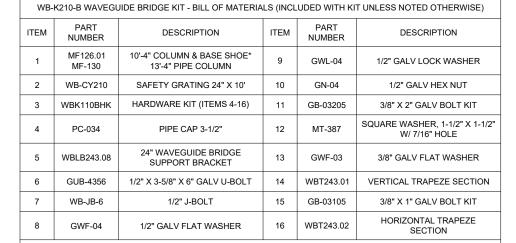

CONTRACTOR SHALL USE PARTS MANUFACTURED BY COMMSCOPE OR APPROVED EQUIVALENT. \*BASE SHOE NOT INCLUDED IN WB-K210-B KIT, ORDER COLUMN SEPARATELY OR KIT WB-K210-S.

WAVEGUIDE BRIDGE KIT

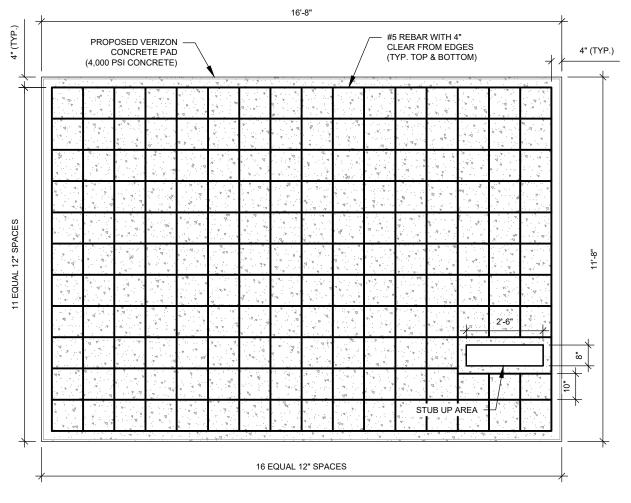

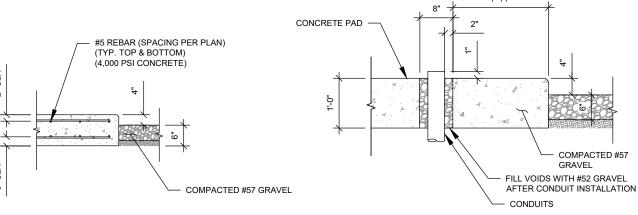

THIS DESIGN ASSUMES A 1500 PSF SOIL BEARING PRESSURE

SIMPSON STRONG-BOLT® 2 WEDGE

ANCHOR OR EQUIVALENT

(SIZE PER CABINET AND GENERATOR MANUFACTURER

SPECIFICATIONS)

GENERATOR CONDUIT STUB UP DETAIL

ATC SITE NUMBER:

DESCRIPTION

**PRELIM** 

PRELIM

**FINAL** 

**AMERICAN TOWER®** 

Dewberry Engineers Inc.

**Dewberry**®

99 SUMMER STREET

BOSTON, MA 02110 PHONE: 617.695.3400 FAX: 617.695.3310

BY DATE

HMP 08/07/23

VL 08/30/23

VL 12/21/23 VL 01/22/24

SUITE 700

ATC SITE NAME:

302500

**BRST - BRISTOL** 

VERIZON SITE NAME:

**BRISTOL SW CT** 

SITE ADDRESS: 790 WILLIS STREET BRISTOL, CT 06010-7269





ATC JOB NO: CUSTOMER #: 5000917346 (780529)

14430738\_G2 CUSTOMER ID: BRISTOL SW CT

> CONSTRUCTION **DETAILS**

SHEET NUMBER

C-505


REVISION

PAD NOTES:

PADS SHALL BE PRE-CAST MATCHING THIS DESIGN WHERE ALLOWED BY LOCAL JURISDICTION. REFER TO CONCRETE & REINFORCED STEEL NOTES ON SHEET G-002 & ATC SPEC 033000 FOR

CAST-IN-PLACE PADS.


### CONCRETE EQUIPMENT PAD DESIGN SCALE: N.T.S.

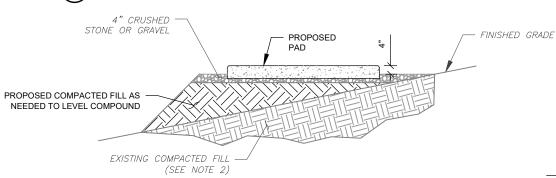


### PAD NOTES:

- SUBGRADE AND FILL SHALL CONSIST OF CLEAN SOIL. DELETRIOUS MATERIAL AND ORGANICS SHALL BE
- 2. CONTRACTOR TO REMOVE CRUSHED STONE IN FOOTPRINT OF PROPOSED PAD PLUS 2' PERIMETER, MECHANICALLY COMPACT EXISTING BACKFILL. CONTRACTOR TO PLACE NEW STRUCTURAL FILL AS REQUIRED TO LEVEL COMPOUND. ALL STRUCTURAL FILL SHOULD BE PLACED IN MAXIMUM 12" LOOSE LIFTS AND COMPACTED TO 95% MAXIMUM DENSITY AT OPTIMUM MOISTURE CONTENT AS DETERMINED BY ASTM D1557, THE MODIFIED PROCTOR DENSITY TEST.
- 3. USE GALVANIZED HILTI EXPANSION ANCHORS OR, APPROVED EQUAL, FOR EQUIPMENT ANCHORAGE.
- 4. FOR SIZE AND LOCATION OF ANCHORS AND OTHER REQUIREMENT, SEE EQUIPMENT VENDOR DRAWINGS.



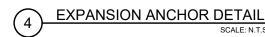

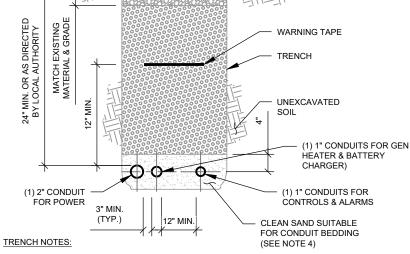

IF FREE OF ORGANIC OR OTHER DELETERIOUS MATERIAL, EXCAVATED MATERIAL MAY BE USED FOR BACKFILL. IF NOT, PROVIDE CLEAN, COMPACTIBLE MATERIAL.


COMPACT IN 8" LIFTS. REMOVE ANY LARGE ROCKS PRIOR TO BACKFILLING.

CONTRACTOR TO VERIFY LOCATION OF EXISTING U/G UTILITIES PRIOR TO DIGGING. IF CURRENT AS-BUILT DRAWINGS ARE NOT AVAILABLE CONTRACTOR SHALL HAND DIG U/G TRENCHING

USE COMMUNICATIONS ONLY TRENCH FOR COMMUNICATIONS CONDUIT UNLESS TRAVELING UNDER PATH OF VEHICLE TRAVEL, THEN CONDUIT MUST BE 24" MIN.


CONFIRM SPACING AND DEPTH WITH NEC OR LOCAL CODE REQUIREMENTS

GENERATOR CONDUIT TRENCH DETAILS SCALE: N.T.S.

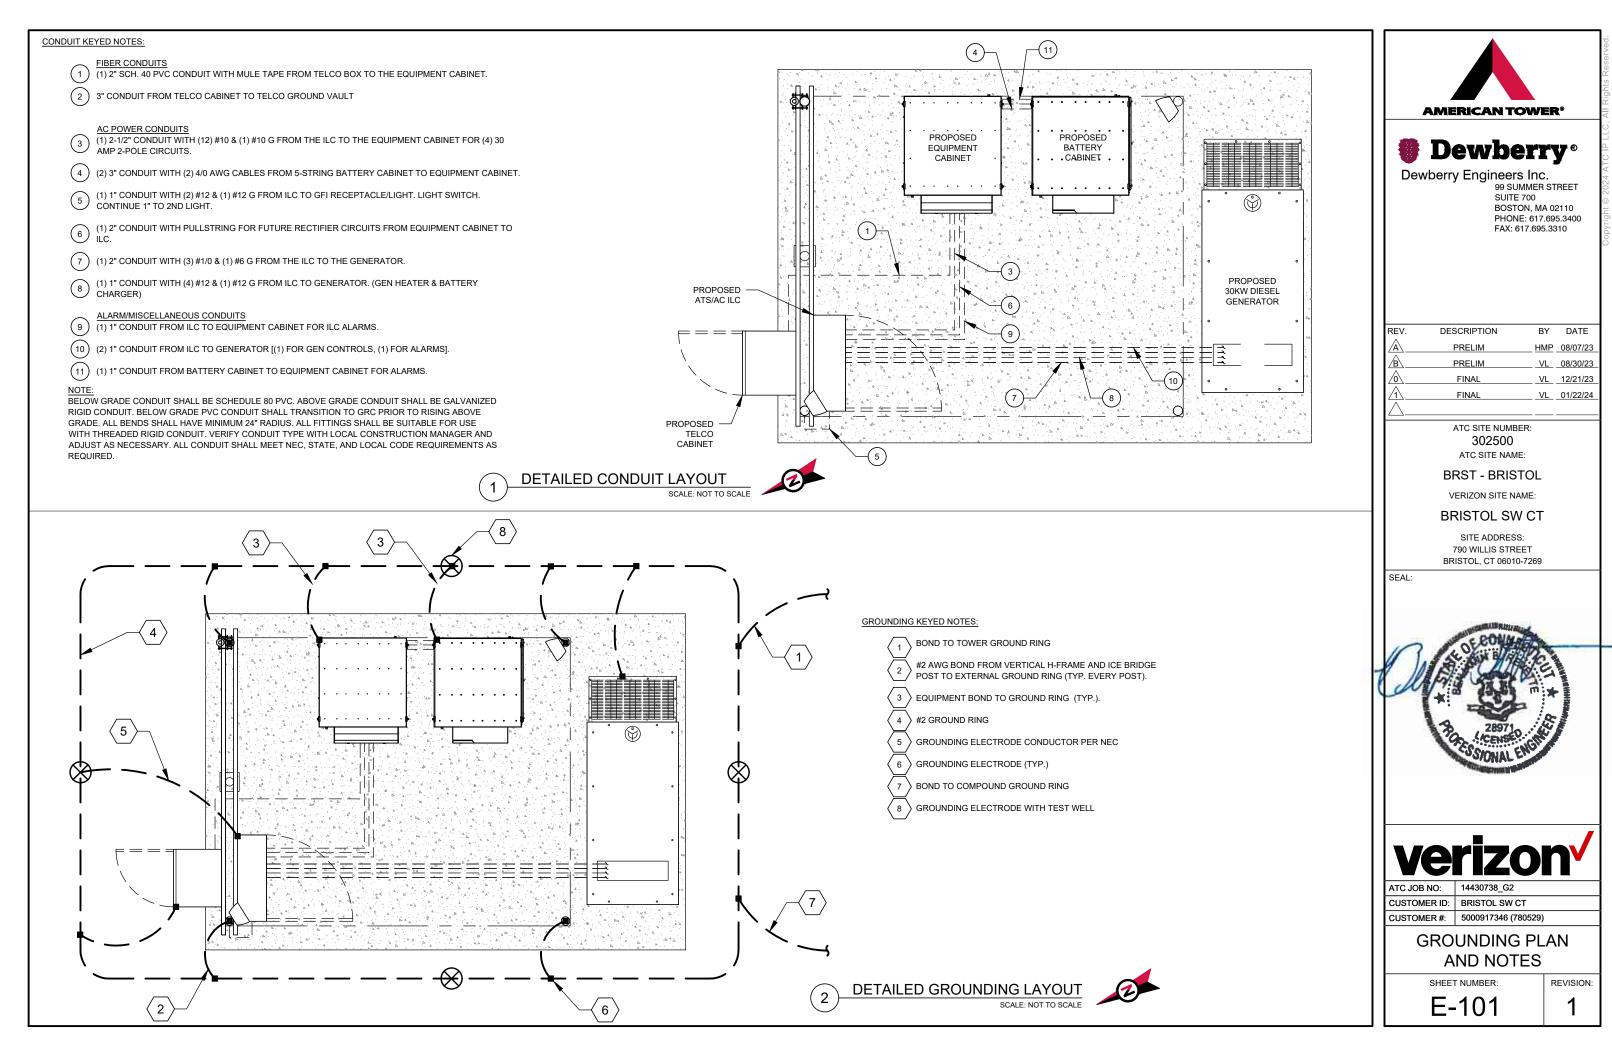

PA NEL		TYPE:	LIGHTING & A PPLIA NCE	SYSTEM:	120/240V, 3W, 30 CKT	LOCATION:	VZW LEASE AREA
DESIGNATION:	VZW	MOUNTING:	SURFACE	MAIN BREAKER (MB):	MLO		
		ENCLOSURE	N⊟MA 3R	MAIN BUS RATING:	200A	PANEL NOTES:	A SCO D300L SERIES
		_		MIN. A.I.C. RATING:	65K		

CONN	ECTED		FEE	EDER OR BRANC	CH CIRC	UIT			FEEDI	ER OR BRANCH	CIRCUIT			IECTED
LOAD	(kVA)	BRIEF DESCRIPTION	E	BREAKER	POLE	CIR C.		CIR C.	POLE	BRE	AKER	BRIEF DESCRIPTION	LOAD	(kVA)
Α	В		AMPS	POLES	NO.	N O T E S		N D T E S	NO.	POLES	AMPS		Α	В
2.88		RECTIFIER	30	2	1				2			SPACE	0.00	
	2.88	NECTIFIE!	30	_	3				4			SPACE		0.00
2.88		RECTIFIER	30	2	5				6			SPACE	0.00	
	2.88	KECHILIK	30	_	7				8			SPACE		0.00
2.88		RECTIFIER	30	2	9				10			SPACE	0.00	
	2.88	NECTI IEX	30	_	11				12			SPACE		0.00
2.88		RECTIFIER	30	2	13				14			SPACE	0.00	
	2.88	RECTIFIER	30	_	15				16			SPACE		0.00
0.68		GFI RECEPT / LIGHT	20	1	17				18			SPACE	0.00	
	1.92	GEN BLOCK HEATER	20	1	19				20			SPACE		0.00
1.92		BATTERY CHARGER	20	1	21				22			SPACE	0.00	
	0.00	SPACE			23				24			SPACE		0.00
0.00		SPACE			25				26			SPACE	0.00	
	0.00	SPACE			27				28			SPACE		0.00
0.00		SPACE			29				30			SPACE	0.00	
14.1	13.4		•	•	•	Α	В	тот	AL				0.0	0.0
						14.1	13.4	27	.6	CONNECTED LO	OAD (kVA)	'		
						14.1	13.4	27	.6	DEMAND LOAD	(kVA)	DERATING FACTOR (80%)		

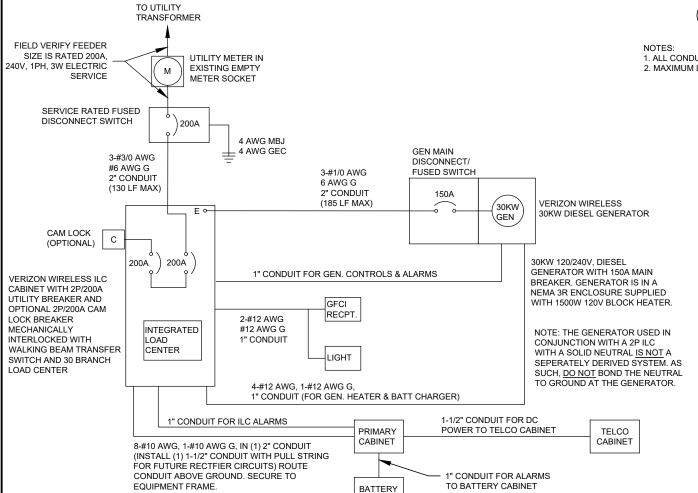

CABINET

# PANEL SCHEDULE

- 1. ALL CONDUCTORS ARE TYPE THWN (75°C) COPPER.
- 2. MAXIMUM LENGTH OF RUN FOR RECTIFIER CIRCUITS IS 50 FT.

# ELECTRICAL SINGLE LINE DIAGRAM

- 1. ALL EQUIPMENT SHALL BE NEMA 3R RATED.
- 2. ALL EQUIPMENT SHALL BE GROUNDED IN ACCORDANCE WITH TIA-222-G AND VERIZON WIRELESS STANDARDS.
- 3. CONDUCTOR SIZES AND DISTANCES HAVE BEEN SIZED FOR 3% MAX VOLTAGE DROP. (TOTAL SYSTEM VOLTAGE DROP ON BOTH FEEDERS AND BRANCH CIRCUITS TO THE FARTHEST DEMAND SHALL NOT EXCEED 5%)
- 4. WIRE SIZING AND MAXIMUM DISTANCE FROM GENERATOR TO ILC ASSUMES POWER FACTOR OF 0.9.
- 5. BELOW GRADE PVC CONDUIT SHALL TRANSITION TO RMC PRIOR TO RISING ABOVE GRADE, ALL BENDS SHALL HAVE A MINIMUM 24" RADIUS. ALL FITTINGS SHALL BE SUITABLE FOR USE WITH THREADED RIGID CONDUIT. VERIFY CONDUIT TYPE WITH LOCAL CONSTRUCTION MANAGER AND ADJUST IF NECESSARY. ALL CONDUIT SHALL MEET NEC, STATE, AND LOCAL CODE REQUIREMENTS AS REQUIRED.



# **Dewberry**®

Dewberry Engineers Inc. 99 SUMMER STREET SUITE 700 BOSTON, MA 02110 PHONE: 617.695.3400 FAX: 617.695.3310

REV.	DESCRIPTION	BY	DATE
$\mathbb{A}_{-}$	PRELIM	HMP	08/07/23
B	PRELIM	VL	08/30/23
$\overline{\wedge}$	FINAL	VL	12/21/23
1	FINAL	VL	01/22/24
$\overline{\wedge}$			

ATC SITE NUMBER: 302500 ATC SITE NAME:

**BRST - BRISTOL** 

VERIZON SITE NAME:

#### **BRISTOL SW CT**

SITE ADDRESS: 790 WILLIS STREET BRISTOL, CT 06010-7269

DEMANDLOAD SIZING:

147 AMPS




ATC JOB NO: CUSTOMER ID: BRISTOL SW CT

CUSTOMER #: 5000917346 (780529)


**ONE-LINE & PANEL SCHEDULE** 

E-102

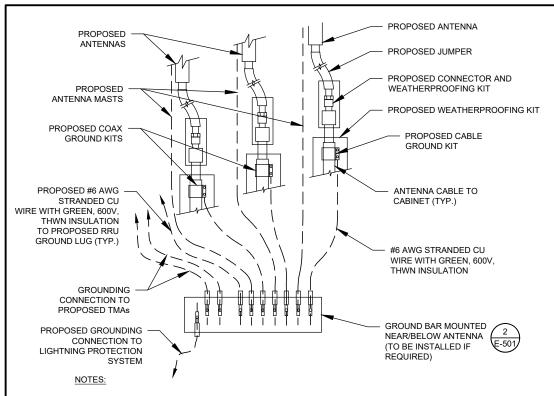

- THIS DETAIL IS INTENDED TO SHOW THE GENERAL GROUNDING REQUIREMENTS. SLIGHT ADJUSTMENTS MAY BE REQUIRED BASED ON EXISTING SITE CONDITIONS. THE CONTRACTOR SHALL MAKE FIELD ADJUSTMENTS AS NEEDED AND INFORM THE CONSTRUCTION MANAGER OF ANY CONFLICTS.
- SITE GROUNDING SHALL COMPLY WITH VERIZON GROUNDING STANDARDS, LATEST EDITION, AND COMPLY WITH VERIZON GROUNDING CHECKLIST, LATEST VERSION. WHEN NATIONAL AND LOCAL GROUNDING CODES ARE MORE STRINGENT THEY SHALL GOVERN.




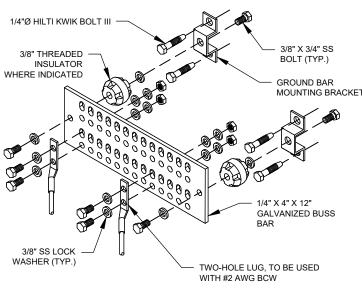

#### **GROUND BAR NOTES**

- GROUND KITS COME WITH ALL HARDWARE, NUTS, BOLTS, WASHERS, ETC. EXCEPT THE STRUCTURAL MOUNTING
- 2. GROUND BAR SHALL BE BOLTED TO STRUCTURAL MEMBER OR ANCHORED TO CONCRETE SLAB W/ HILTI KWIK BOLT III.



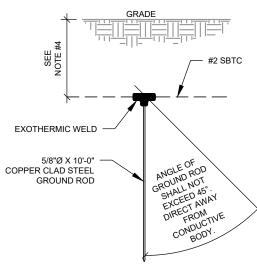

- SEPARATION DIMENSION TO BE VERIFIED WITH LOCAL UTILITY COMPANY REQUIREMENTS.
- 2. COORDINATE UTILITY, LOCATE BEFORE DIGGING.
- CONDUIT TRENCHING DEPTHS AT 36" OR 6" BELOW FROST LINE, WHICHEVER IS GREATER.
- 4. ALL RING AND RADIAL DEPTHS AT 30" OR 6" BELOW FROST LINE, WHICHEVER IS GREATER.





EXTERIOR GROUND RING #2 SBTC GROUNDING CONDUCTOR

EXOTHERMIC WELD

(THERMOWELD OR EQUIVALENT) PARALLEL, NO T-WELDS ALLOWED


(NO SLAG OR DEFORMITIES ALLOWED)



JUMPER, #2 SBTC

GROUNDING CONDUCTOR




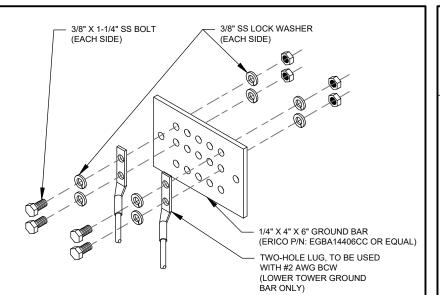

#### **GROUND BAR NOTES:**


- GROUND BAR KITS COME WITH ALL HARDWARE, NUTS, BOLTS, WASHERS, ETC. EXCEPT THE STRUCTURAL MOUNTING MEMBER(S).
- 2. GROUND BAR TO BE BONDED DIRECTLY TO TOWER.

**TOWER GROUND BAR DETAIL** 

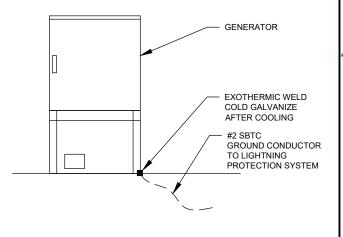

### **GENERATOR INSTALLATION NOTE:**

ACCESSORIES PER MANUFACTURER'S INSTALLATION INSTRUCTIONS AND SPECIFICATIONS. THIS INCLUDES, BUT IS NOT LIMITED TO, ACCESSORIES FOR THE EXHAUST SYSTEM, FUEL SYSTEM, ENCLOSURE INTEGRITY (CAPS, PLUGS, COVERS, ETC.), ELECTRICAL CONNECTIONS, AND GROUNDING CONNECTIONS

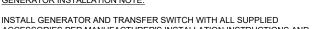

**GENERATOR GROUNDING** 





Dewberry Engineers Inc. 99 SUMMER STREET SUITE 700 BOSTON, MA 02110 PHONE: 617.695.3400 FAX: 617.695.3310

REV.	DESCRIPTION	BY	DATE
A	PRELIM	HMP	08/07/23
∕B∖	PRELIM	VL	08/30/23
$\overline{\wedge}$	FINAL	VL	12/21/23
1	FINAL	VL	01/22/24
$\overline{\wedge}$			

ATC SITE NUMBER: 302500 ATC SITE NAME:

**BRST - BRISTOL** 

VERIZON SITE NAME:

**BRISTOL SW CT** 

SITE ADDRESS: 790 WILLIS STREET BRISTOL, CT 06010-7269






ATC JOB NO: 14430738\_G2 CUSTOMER ID: BRISTOL SW CT CUSTOMER #: 5000917346 (780529)


**GROUNDING DETAILS** 

SHEET NUMBER:

E-501

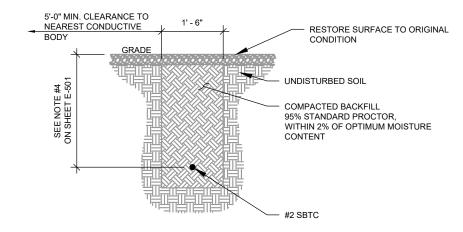

GROUND CONNECTION TRENCH DETAIL (STD.)

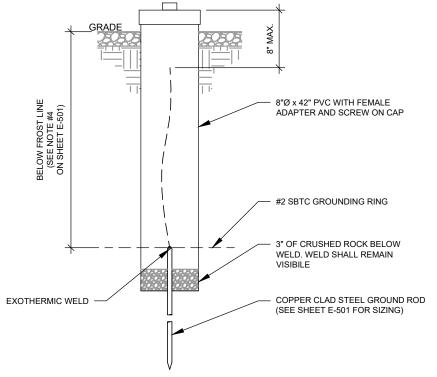

**TEST WELL DETAIL** SCALE: NOT TO SCALE





Dewberry Engineers Inc. 99 SUMMER STREET SUITE 700 BOSTON, MA 02110 PHONE: 617.695.3400 FAX: 617.695.3310

REV.	DESCRIPTION	BY	DATE
<u>A</u>	PRELIM	<u>HMP</u>	08/07/23
<u>B</u>	PRELIM	VL	08/30/23
<u> </u>	FINAL	VL_	12/21/23
1	FINAL	VL	01/22/24
$\overline{\wedge}$			

ATC SITE NUMBER: 302500 ATC SITE NAME:

**BRST - BRISTOL** 

VERIZON SITE NAME:

**BRISTOL SW CT** 

SITE ADDRESS: 790 WILLIS STREET BRISTOL, CT 06010-7269





ATC JOB NO: CUSTOMER ID: BRISTOL SW CT

14430738\_G2

CUSTOMER #: 5000917346 (780529)

**GROUNDING DETAILS** 

SHEET NUMBER:

E-502

## **Equipment Summary**

Added														
Equipment Type	Location	700	850	1900	AWS	CBRS	L-Sub6	Make	Model	Cable Length	Cable Size	Install Type	Quantity	Item ID
RRU	Tower	LTE	LTE 5G					Samsung	RF4461d-13A			PHYSICAL	3	
RRU	Tower					LTE		Samsung	RT4423-48A			PHYSICAL	3	
RRU	Tower			LTE	LTE			Samsung	B2/B66A RRH ORAN (RF4439d-25A)			PHYSICAL	3	
RRU	Tower						5G	Samsung	MT6413-77A			PHYSICAL	0	
Hybrid Cable	Tower							N/A	6x12 Hybriflex			PHYSICAL	2	
OVP Box	Tower							N/A	12 OVP			PHYSICAL	1	
Removed														
Equipment Type	Location	700	850	1900	AWS	CBRS	L-Sub6	Make	Model	Cable Length	Cable Size	Install Type	Quantity	Item ID
									No data av	ailable.				
Retained														
Equipment Type	Location	700	850	1900	AWS	CBRS	L-Sub6	Make	Model	Cable Length	Cable Size	Install Type	Quantity	Item ID
									No data ava	ailable.				

## Antenna Summary

Removed: 0

Retained: 0

Added															
700	850	1900	AWS	CBRS	L-Sub6	Make	Model	Centerline	Tip Height	Azimuth	RET	4xRx	Inst. Type	Quantity	Item ID
					5G	Samsung	MT6413-77A	112	113.2	10(A) 190(B) 275(C)		false	PHYSICAL	3	
LTE	LTE 5G		LTE	LTE		COMMSCOPE	NHHSS-45B-R2BT4	112	115	10(A) 190(B) 275(C)		true	PHYSICAL	3	
LTE	LTE 5G	LTE				CommScope	NHH-45B-R2B	112	115	10(A) 190(B) 275(C)		true	PHYSICAL	3	
Removed															
700	850	1900	AWS	CBRS	L-Sub6	Make	Model	Centerline	Tip Height	Azimuth	RET	4xRx	Inst. Type	Quantity	Item ID
									No o	data available.					
Retaine	Retained														
700	850	1900	AWS	CBRS	L-Sub6	Make	Model	Centerline	Tip Height	Azimuth	RET	4xRx	Inst. Type	Quantity	Item ID
									No o	data available.					



Added: 9





Dewberry Engineers Inc.
99 SUMMER STREET
SUITE 700
BOSTON, MA 02110
PHONE: 617.695.3400
FAX: 617.695.3310

ATC SITE NUMBER: 302500 ATC SITE NAME:

**BRST - BRISTOL** 

VERIZON SITE NAME: **BRISTOL SW CT** 

SITE ADDRESS: 790 WILLIS STREET

BRISTOL, CT 06010-7269


ATC JOB NO: 14430738\_G2 CUSTOMER ID: BRISTOL SW CT

CUSTOMER #: 5000917346 (780529)


SUPPLEMENTAL

SHEET NUMBER:

R-601

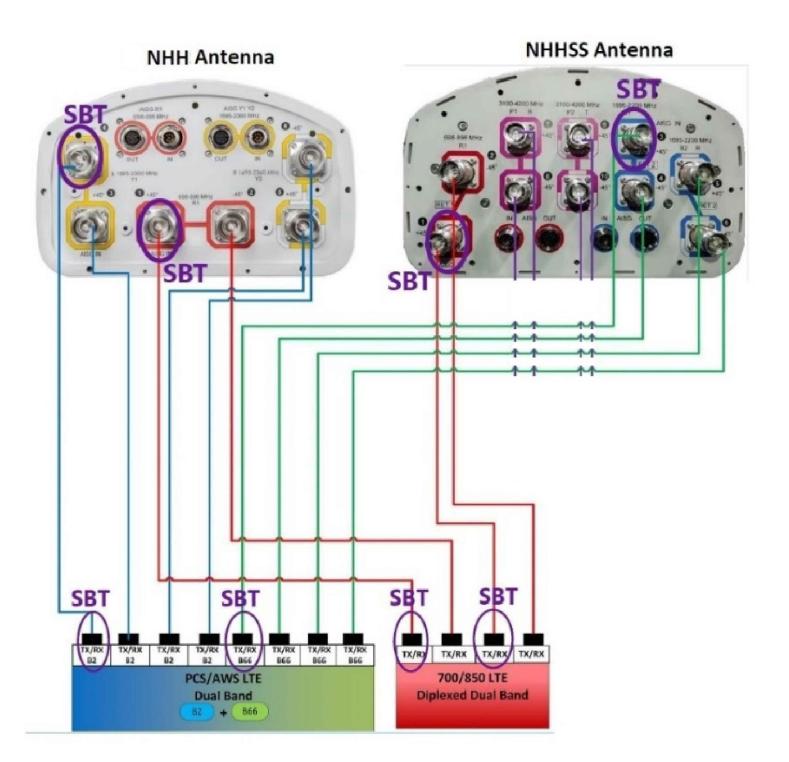



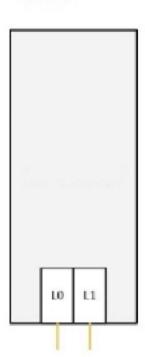





Dewberry Engineers Inc.
99 SUMMER STREET
SUITE 700
BOSTON, MA 02110
PHONE: 617.695.3400
FAX: 617.695.3310

ATC SITE NUMBER: 302500 ATC SITE NAME:

**BRST - BRISTOL** 

VERIZON SITE NAME: **BRISTOL SW CT** 

SITE ADDRESS: 790 WILLIS STREET BRISTOL, CT 06010-7269


ATC JOB NO:

CUSTOMER ID: BRISTOL SW CT CUSTOMER #: 5000917346 (780529)

**SUPPLEMENTAL** 

SHEET NUMBER:

R-602

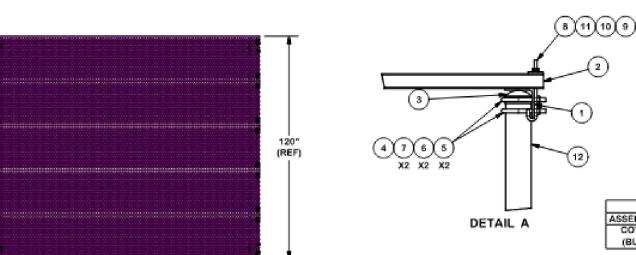

CPD BY DATE


24" (TYP)

			COMMON PARTS LIST			
ITEM	QTY	PART NO.	PART DESCRIPTION	LENGTH	UNIT WT.	NET WT.
1	2	X-COV10	4" X 4" x 1/4" ANGLE (A36)	120 in	66.32	132.64
2	5	GRS24-12	24" X 12' GRIP SPAN BRIDGE CHANNEL		81.68	408.41
3	4	PC312	3-1/2" FENCE POST CAP		0.59	2.34
4	8	X-UB1358	1/2" X 3-5/8" X 5-1/2" X 3" U-BOLT (HDG.)		0.81	6.49
5	16	G12NUT	1/2" HDG HEAVY 2H HEX NUT		0.07	1.14
6	16	G12LW	1/2" HDG LOCKWASHER		0.01	0.22
7	16	G12FW	1/2" HDG USS FLATWASHER		0.03	0.54
8	20	X-JB8	X-JB8		0.33	6.55
9	20	G38NUT	3/8" HDG HEAVY 2H HEX NUT		0.03	0.68
10	20	G38LW	3/8" HDG LOCKWASHER		0.01	0.13
11	20	SQW38	3/8" SQUARE WASHER (GALV.)	2 in	0.27	5.46

	VARIABLE PARTS LIST											
ASSEMBLY "A"	ITEM	QTY	PART NO.	PART DESCRIPTION	LENGTH	UNIT WT.	NET WT.					
COV1012 (BURIAL)	12	4	P3160	3" SCH 40 PIPE (3.5 O.D. x .216" WALL) A500	160 in	101.25	404.99					

TOTAL WEIGHT: 969.64



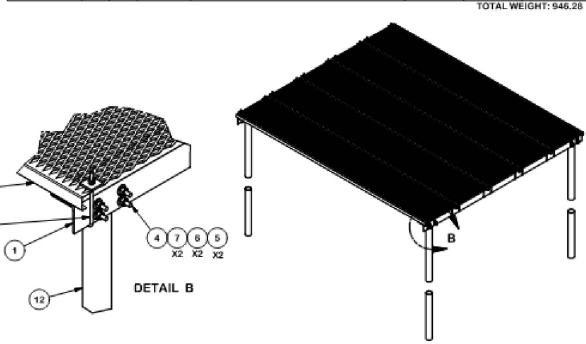

### TOLERANCE NOTES

SAWED, SHEARED AND GAS CUT EDGES (± 0.030") DRILLED AND GAS CUT HOLES (\$ 0.030") - NO CONING OF HOLES LASER CUT EDGES AND HOLES (\$ 0.010") - NO CONING OF HOLES

8 (1) (10 (9)

PROPERTARY NOTE:
THE DATA MAP TECHNIQUES CONTAINED IN THIS DRAWNS ARE PROPERTARY REPORTATION OF EXAMINITY AND RESIDENCE MITTOUT THE CONSENT OF

PLATFORM CANOPY 12' X 10' BURIAL OR BASE SHOE

BMC



Engineering Support Team: 1-888-753-7446

Les Angeles, CA Plymouth, IN Salem, OR Dallas, TX

ATC JOB NO: 14430738\_G2 CUSTOMER ID: BRISTOL SW CT CUSTOMER #: 5000917346 (780529)

**SUPPLEMENTAL** 

SHEET NUMBER:

R-603

TOLERANCES ON DIMENSIONS, UNLESS OTHERWISE NOTED ARE: BENDS ARE ± 1/2 DEGREE

ALL OTHER MACHINING (± 0.030") ALL OTHER ASSEMBLY (± 0.060")

DRAWN BY ENG. APPROVAL KC8 8/24/2012 DRAWING USAGE CHECKED BY

CUSTOMER

DESCRIPTION

81

7/2/2013

SEE ASSEMBLY "A"

COV1012

(REF)

A X-COV10 TO QTY 2, ITEM 2 "-12", UPDATED LENGTH & WTS

REV DESCRIPTION OF DESCRIPTION

**AMERICAN TOWER®** 

**Dewberry**®

Dewberry Engineers Inc. 99 SUMMER STREET SUITE 700 BOSTON, MA 02110 PHONE: 617.695.3400 FAX: 617.695.3310

> ATC SITE NUMBER: 302500 ATC SITE NAME:

**BRST - BRISTOL** VERIZON SITE NAME:

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