

COMPLIANCE CODE



ATC SITE NAME: TARTAGLIA ATC SITE NUMBER: 383598

VERIZON SITE NAME: BRIDGEPORT NORTH

VERIZON SITE NUMBER:467325

PROJECT SUMMARY

SITE ADDRESS: 1000 TRUMBULL AVENUE

BRIDGEPORT, CT 6606

PROJECT DESCRIPTION



LOCATION MAP

SHEET INDEX

VERIZON 5G L-SUB6 CARRIER ADD ANTENNA AMENDMENT DRAWINGS

ALL WORK SHALL BE PERFORMED AND MATERIALS INSTALLED IN ACCORDANCE WITH THE CURRENT EDITIONS OF THE FOLLOWING CODES AS ADOPTED BY THE LOCAL GOVERNMENT AUTHORITIES. NOTHING IN THESE PLANS IS TO BE CONSTRUED TO PERMIT WORK NOT CONFORMING TO THESE CODES. 1. 2018 CONNECTICUT STATE BUILDING CODE-AMENDMENTS TO IBC 2015 2. INTERNATIONAL BUILDING CODE 2015, INTERNATIONAL	SITE ADDRESS: 1000 TRUMBULL AVENUE BRIDGEPORT, CT 6606 COUNTY: FAIRFIELD GEOGRAPHIC COORDINATES: LATITUDE: 41.2196 LONGITUDE: -73.20128611	THE PROPOSED PROJECT INCLUDES MODIFYING GROUND BASED AND TOWER MOUNTED EQUIPMENT AS INDICATED PER BELOW: INSTALL (3) ANTENNA(s) AND (3) RRH(s) EXISTING (12) ANTENNAS(s), (9) RRU(s), (3) DIPLEXER(s), (2) OVP(s), (6) 1-5/8" COAX CABLE(s), AND (2) 6 X12 HYBRID CABLE(s) TO REMAIN	SHEET NO: G-001 G-002 C-101 C-201 C-401	DESCRIPTION: TITLE SHEET GENERAL NOTES DETAILED SITE PLAN TOWER ELEVATION ANTENNA INFORMATION & SCHEDULE	0 0 0 0 0 0 0 0 0 0 0 0 0 0 0 0 0 0 0	DATE: 06/30/21 06/30/21 06/30/21 06/30/21	BY: JI JI JI JI JI JI JI
CODE COUNCIL 3. TIA-222-G-4, STRUCTURAL STANDARD FRO ANTENNA SUPPORTING STRUCTURES AND ANTENNAS	GROUND ELEVATION: 212' AMSL		C-501	CONSTRUCTION DETAILS	0	06/30/21	JI
ASCE 7-10 MINIMUM DESIGN LOADS FOR BUILDINGS AND OTHER STRUCTURES, AMERICAN SOCIETY OF CIVIL ENGINEERS			E-501 R-601	GROUNDING DETAILS SUPPLEMENTAL	0	06/30/21	JI
5. STEEL CONSTRUCTION MANUAL 14TH EDITION, AMERICAN		PROJECT NOTES	R-602	SUPPLEMENTAL			
INSTITUTE OF STEEL CONSTRUCTION 6. CITY/COUNTY ORDINANCES	PROJECT TEAM TOWER OWNER: APPLICANT: AMERICAN TOWER VERIZON WIRELESS 10 PRESIDENTIAL WAY 118 FLANDERS ROAD WOBURN, MA 01801 WESTBOROUGH, MA 01581	THE FACILITY IS UNMANNED. A TECHNICIAN WILL VISIT THE SITE APPROXIMATELY ONCE A MONTH FOR ROUTINE INSPECTION AND MAINTENANCE. THE PROJECT WILL NOT RESULT IN ANY SIGNIFICANT LAND DISTURBANCE OR EFFECT OF STORM WATER DRAINAGE. NO SANITARY SEWER, POTABLE WATER OR TRASH DISPOSAL IS REQUIRED. HANDICAP ACCESS IS NOT REQUIRED.		MOUNT MODIFICATION DRAWINGS (9 PAGES)			
UTILITY COMPANIES	ENGINEER:	TANDICAF ACCESS IS NOT REQUIRED. THE PROJECT DEPICTED IN THESE PLANS QUALIFIES AS AN ELIGIBLE FACILITIES REQUEST ENTITLED TO EXPEDITED.					
POWER COMPANY: THE UNITED ILLUMINATING COMPANY PHONE: (800) 722-5584	DEWBERRY ENGINEERS, INC. 99 SUMMER STREET	REVIEW UNDER 47 U.S.C. § 1455(A) AS A MODIFICATION OF AN EXISTING WIRELESS TOWER THAT INVOLVES THE COLLOCATION, REMOVAL, AND/OR REPLACEMENT OF					
TELEPHONE COMPANY: N/A PHONE:	SUITE 700 BOSTON, MA 02110	TRANSMISSION EQUIPMENT THAT IS NOT A SUBSTANTIAL CHANGE UNDER CFR § 1.61000 (B)(7).					
Know what's below. Call before you dig.	PROPERTY OWNER: GLOBAL TOWER ASSETS LLC 10 PRESIDENTIAL WAY WOBURN, MA 01801	PROJECT LOCATION DIRECTIONS FROM DOWNTOWN NEW HAVEN CT START OUT GOING NORTHEAST ON CHURCH ST TOWARD WALL ST. CHURCH ST BECOMES WHITNEY AVE. TURN RIGHT ONTO TRUMBULL ST. TURN SLIGHT LEFT TO TAKE THE 191 SI-99 IN RAMP. MERGE ONTO 1-91 S TOWARD 195/N.Y. CITY/NEW LONDON. KEEP RIGHT TOWARD NY CITY. MERGE ONTO 1-95 S VIA THE EXIT ON THE LEFT TOWARD N Y CITY. TAKE EXIT 38 TOWARD CT-15/MERRITT PKWYWY CROSS PKWY. MERGE ONTO MERRITT PARKWAY/CT-15 S VIA EXIT 38 ON THE LEFT TOWARD NY CITY. MERGE ONTO CT-8 S VIA EXIT 52 TOWARD BRIDGEPORT. TAKE THE CT-127/MHITE PLAINS ROAD EXIT, EXIT 7. TURN SLIGHT LEFT ONTO OLD TOWN RD. OLD TOWN RD BECOMES TRUMBULL AVE. TURN RIGHT ONTO CHOPSEY HILL RD. 1336 CHOPSEY HILL RD, BRIDGEPORT. CT 05606-2422, 1336 CHOPSEY HILL RD IS ON THE RIGHT. DRIVE BETWEEN HOUSES TO TOWER SITE					



Dewberry

Dewberry Engineers Inc.
99 SUMMER STREET
SUITE 700
BOSTON, MA 02110
PHONE: 617.531.0801
FAX: 617.695.3310

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verizon /

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_	ATC JOB NO:	13668689
	CUSTOMER ID:	BRIDGEPORT NORTH
	CUSTOMER #:	467325

TITLE SHEET

SHEET NUMBER

G-001

GENERAL CONSTRUCTION NOTES:

- OWNER FURNISHED MATERIALS, VERIZON "THE COMPANY" WILL PROVIDE AND THE CONTRACTOR WILL INSTALL
- A. BTS EQUIPMENT FRAME (PLATFORM) AND ICEBRIDGE SHELTER (GROUND BUILD/CO-LOCATE ONLY)
- AC/TELCO INTERFACE BOX (PPC)
- D. TOWERS, MONOPOLES
- TOWER LIGHTING
- GENERATORS & LIQUID PROPANE TANK
- G. ANTENNA STANDARD BRACKETS, FRAMES AND PIPES FOR MOUNTING
- ANTENNAS (INSTALLED BY OTHERS)
- TRANSMISSION LINE
- TRANSMISSION LINE JUMPERS
- TRANSMISSION LINE CONNECTORS WITH WEATHERPROOFING KITS
- TRANSMISSION LINE GROUND KITS
- HANGERS
- HOISTING GRIPS
- O. BTS EQUIPMENT
- THE CONTRACTOR IS RESPONSIBLE TO PROVIDE ALL OTHER MATERIALS FOR THE COMPLETE INSTALLATION OF THE SITE INCLUDING, BUT NOT LIMITED TO, SUCH MATERIALS AS FENCING, STRUCTURAL STEEL SUPPORTING SUB-FRAME FOR PLATFORM, ROOFING LABOR AND MATERIALS GROUNDING RINGS GROUNDING WIRES COPPER-CLAD OR XIT CHEMICAL GROUND ROD(S), BUSS BARS, TRANSFORMERS AND DISCONNECT SWITCHES WHERE APPLICABLE, TEMPORARY ELECTRICAL POWER, CONDUIT, LANDSCAPING COMPOUND STONE, CRANES, CORE DRILLING, SLEEPERS AND RUBBER MATTING, REBAR, CONCRETE CAISSONS, PADS AND/OR AUGER MOUNTS, MISCELLANEOUS FASTENERS, CABLE TRAYS, NON-STANDARD ANTENNA FRAMES AND ALL OTHER MATERIAL AND LABOR REQUIRED TO COMPLETE THE JOB ACCORDING TO THE DRAWINGS AND SPECIFICATIONS. IT IS THE POSITION OF VERIZON TO APPLY FOR PERMITTING AND CONTRACTOR RESPONSIBLE FOR PICKUP AND PAYMENT OF REQUIRED
- ALL WORK SHALL CONFORM TO ALL CURRENT APPLICABLE FEDERAL, STATE, AND LOCAL CODES, INCLUDING ANSI/EIA/TIA-222, AND COMPLY WITH ATC CONSTRUCTION
- CONTRACTOR SHALL CONTACT LOCAL 811 FOR IDENTIFICATION OF UNDERGROUND
- CONTRACTOR SHALL BE RESPONSIBLE FOR COORDINATING ALL REQUIRED
- ALL DIMENSIONS TO, OF, AND ON EXISTING BUILDINGS, DRAINAGE STRUCTURES, AND SITE IMPROVEMENTS SHALL BE VERIFIED IN FIELD BY CONTRACTOR WITH ALL DISCREPANCIES REPORTED TO THE ENGINEER.
- DO NOT CHANGE SIZE OR SPACING OF STRUCTURAL ELEMENTS
- DETAILS SHOWN ARE TYPICAL; SIMILAR DETAILS APPLY TO SIMILAR CONDITIONS UNLESS
- THESE DRAWINGS DO NOT INCLUDE NECESSARY COMPONENTS FOR CONSTRUCTION SAFETY WHICH SHALL BE THE SOLE RESPONSIBILITY OF THE CONTRACTOR
- CONTRACTOR SHALL BRACE STRUCTURES UNTIL ALL STRUCTURAL ELEMENTS NEEDED FOR STABILITY ARE INSTALLED. THESE ELEMENTS ARE AS FOLLOWS: LATERAL BRACING,
- CONTRACTOR SHALL DETERMINE EXACT LOCATION OF EXISTING UTILITIES. GROUNDS DRAINS, DRAIN PIPES, VENTS, ETC, BEFORE COMMENCING WORK
- INCORRECTLY FABRICATED, DAMAGED, OR OTHERWISE MISFITTING OR NONCONFORMING MATERIALS OR CONDITIONS SHALL BE REPORTED TO THE VERIZON REP PRIOR TO REMEDIAL OR CORRECTIVE ACTION, ANY SUCH REMEDIAL ACTION SHALL REQUIRE WRITTEN APPROVAL BY THE VERIZON REP PRIOR TO PROCEEDING.
- EACH CONTRACTOR SHALL COOPERATE WITH THE VERIZON REP, AND COORDINATE HIS WORK WITH THE WORK OF OTHERS.
- CONTRACTOR SHALL REPAIR ANY DAMAGE CAUSED BY CONSTRUCTION OF THIS PROJECT TO MATCH EXISTING PRE-CONSTRUCTION CONDITIONS TO THE SATISFACTION
- ALL CABLE/CONDUIT ENTRY/EXIT PORTS SHALL BE WEATHERPROOFED DURING 15. INSTALLATION LISING A SILICONE SEALANT
- WHERE EXISTING CONDITIONS DO NOT MATCH THOSE SHOWN IN THIS PLAN SET. CONTRACTOR SHALL NOTIFY THE VERIZON REP AND ENGINEER OF RECORD
- CONTRACTOR SHALL ENSURE ALL SUBCONTRACTORS ARE PROVIDED WITH A COMPLETE AND CURRENT SET OF DRAWINGS AND SPECIFICATIONS FOR THIS PROJECT
- CONTRACTOR SHALL REMOVE ALL RUBBISH AND DEBRIS FROM THE SITE AT THE END OF
- CONTRACTOR SHALL COORDINATE WORK SCHEDULE WITH AMERICAN TOWER CORPORATION (ATC) AND TAKE PRECAUTIONS TO MINIMIZE IMPACT AND DISRUPTION OF OTHER OCCUPANTS OF THE FACILITY.
- CONTRACTOR SHALL FURNISH VERIZON AND AMERICAN TOWER CORPORATION (ATC) /ITH A PDF MARKED UP AS-BUILT SET OF DRAWINGS UPON COMPLETION OF WORK
- PRIOR TO SUBMISSION OF BID. CONTRACTOR SHALL COORDINATE WITH VERIZON REP TO DETERMINE WHAT, IF ANY, ITEMS WILL BE PROVIDED. ALL ITEMS NOT PROVIDED SHALL BE PROVIDED AND INSTALLED BY THE CONTRACTOR. CONTRACTOR WILL INSTALL

- 22. PRIOR TO SUBMISSION OF BID, CONTRACTOR SHALL COORDINATE WITH VERIZON REP TO DETERMINE IF ANY PERMITS WILL BE OBTAINED BY CONTRACTOR. ALL REQUIRED PERMITS NOT OBTAINED BY VERIZON MUST BE OBTAINED, AND PAID FOR, BY THE
- 23. CONTRACTOR SHALL INSTALL ALL SITE SIGNAGE IN ACCORDANCE WITH VERIZON SPECIFICATIONS AND REQUIREMENTS.
- ICE BRIDGE (CABLE TRAY WITH COVER) (GROUND BUILD/CO-LOCATE ONLY, GC TO FURNISH AND INSTALL FOR ROOFTOP INSTALLATION)

 24. CONTRACTOR SHALL SUBMIT ALL SHOP DRAWINGS TO VERIZON FOR REVIEW AND APPROVAL PRIOR TO FABRICATION.
 - ALL EQUIPMENT SHALL BE INSTALLED ACCORDING TO MANUFACTURER'S SPECIFICATIONS AND LOCATED ACCORDING TO VERIZON SPECIFICATIONS, AND AS SHOWN IN THESE PLANS
 - 26. THE CONTRACTOR SHALL SUPERVISE AND DIRECT THE PROJECT DESCRIBED HEREIN THE CONTRACTOR SHALL BE SOLELY RESPONSIBLE FOR ALL THE CONSTRUCTION MEANS, METHODS, TECHNIQUES, SEQUENCES AND PROCEDURES AND FOR COORDINATING ALL PORTIONS OF THE WORK UNDER THE CONTRACT.
 - CONTRACTOR SHALL NOTIFY VERIZON REP A MINIMUM OF 48 HOURS IN ADVANCE OF POURING CONCRETE OR BACKFILLING ANY UNDERGROUND UTILITIES, FOUNDATIONS OR SEALING ANY WALL, FLOOR OR ROOF PENETRATIONS FOR ENGINEERING REVIEW AND
 - CONTRACTOR SHALL BE RESPONSIBLE FOR SITE SAFETY INCLUDING COMPLIANCE WITH ALL APPLICABLE OSHA STANDARDS AND RECOMMENDATIONS AND SHALL PROVIDE ALL NECESSARY SAFETY DEVICES INCLUDING PPE AND PPM AND CONSTRUCTION DEVICES SUCH AS WELDING AND FIRE PREVENTION, TEMPORARY SHORING, SCAFFOLDING, TRENCH BOXES/SLOPING, BARRIERS, ETC.
 - THE CONTRACTOR SHALL PROTECT AT HIS OWN EXPENSE ALL EXISTING FACILITIES AND SUCH OF HIS NEW WORK LIABLE TO INJURY DURING THE CONSTRUCTION PERIOD. ANY DAMAGE CAUSED BY NEGLECT ON THE PART OF THIS CONTRACTOR OR HIS REPRESENTATIVES, OR BY THE ELEMENTS DUE TO NEGLECT ON THE PART OF THIS CONTRACTOR OR HIS REPRESENTATIVES, EITHER TO THE EXISTING WORK, OR TO HIS WORK OR THE WORK OF ANY OTHER CONTRACTOR, SHALL BE REPAIRED AT HIS EXPENSE TO THE OWNER'S SATISFACTION.
 - ALL WORK SHALL BE INSTALLED IN A FIRST CLASS, NEAT AND WORKMANLIKE MANNER BY MECHANICS SKILLED IN THE TRADE INVOLVED. THE QUALITY OF WORKMANSHIP SHALL BE SUBJECT TO THE APPROVAL OF THE VERIZON REP. ANY WORK FOUND BY THE VERIZON REP TO BE OF INFERIOR QUALITY AND/OR WORKMANSHIP SHALL BE REPLACED AND/OR REWORKED AT CONTRACTOR EXPENSE UNTIL APPROVAL IS
 - 31. IN ORDER TO ESTABLISH STANDARDS OF QUALITY AND PERFORMANCE, ALL TYPES OF MATERIALS LISTED HEREINAFTER BY MANUFACTURER'S NAMES AND/OR
 MANUFACTURER'S CATALOG NUMBER SHALL BE PROVIDED BY THESE MANUFACTURERS
 - VERIZON FURNISHED EQUIPMENT SHALL BE PICKED-UP AT THE VERIZON WAREHOUSE. NO LATER THAN 48HR AFTER BEING NOTIFIED INSURED, STORED, UNCRATE, PROTECTED AND INSTALLED BY THE CONTRACTOR WITH ALL APPURTENANCES REQUIRED TO PLACE THE EQUIPMENT IN OPERATION, READY FOR USE. THE CONTRACTOR SHALL BE RESPONSIBLE FOR THE EQUIPMENT AFTER PICKING IT UP.
 - VERIZON OR HIS ARCHITECT/ENGINEER RESERVES THE RIGHT TO REJECT ANY 33. EQUIPMENT OR MATERIALS WHICH, IN HIS OWN OPINION ARE NOT IN COMPLIANCE WITH THE CONTRACT DOCUMENTS, EITHER BEFORE OR AFTER INSTALLATION AND THE EQUIPMENT SHALL BE REPLACED WITH EQUIPMENT CONFORMING TO THE REQUIREMENTS OF THE CONTRACT DOCUMENTS BY THE CONTRACTOR AT NO COST TO VERIZON OR THEIR ARCHITECT/ENGINEER

SPECIAL CONSTRUCTION ANTENNA INSTALLATION NOTES:

- WORK INCLUDED:
 - ANTENNA AND COAXIAL CABLES ARE FURNISHED BY VERIZON UNDER A SEPARATE CONTRACT. THE CONTRACTOR SHALL ASSIST ANTENNA INSTALLATION CONTRACTOR IN TERMS OF COORDINATION AND SITE ACCESS ERECTION SUBCONTRACTOR SHALL BE RESPONSIBLE FOR THE PROTECTION OF
 - B. INSTALL ANTENNA AS INDICATE ON DRAWINGS AND VERIZON SPECIFICATIONS
 - C. INSTALL GALVANIZED STEEL ANTENNA MOUNTS AS INDICATED ON DRAWINGS
 - D. INSTALL FURNISHED GALVANIZED STEEL OR ALUMINUM WAVEGUIDE
 - CONTRACTOR SHALL PROVIDE FOUR (4) SETS OF SWEEP TESTS USING ANRITZU-PACKARD 8713B RF SCALAR NETWORK ANALYZER, SUBMIT FREQUENCY DOMAIN REFLECTOMETER(FDR) TESTS RESULTS TO THE PROJECT MANAGER. SWEEP TESTS SHALL BE AS PER ATTACHED RFS "MINIMUM FIELD TESTING RECOMMENDED FOR ANTENNA AND HELIAX COAXIAL CABLE SYSTEMS" DATED 10/5/93 TESTING SHALL BE PERFORMED BY AN INDEPENDENT TESTING SERVICE AND BE BOUND AND SUBMITTED WITHIN ONE WEEK OF WORK COMPLETION.
 - INSTALL COAXIAL CABLES AND TERMINATING BETWEEN ANTENNAS AND EQUIPMENT PER MANUFACTURER'S RECOMMENDATIONS, WEATHERPROOF ALL CONNECTIONS BETWEEN THE ANTENNA AND EQUIPMENT PER MANUFACTURER'S REQUIREMENTS. TERMINATE ALL COAXIAL CABLE THREE (3) FEET IN EXCESS OF ENTRY PORT LOCATION UNLESS OTHERWISE STATED.
 - G ANTENNA AND COAXIAL CABLE GROUNDING:
- ALL EXTERIOR #6 GREED GROUND WIRE "DAISY CHAIN" CONNECTIONS ARE TO BE WEATHER SEALED WITH RFS CONNECTORS/SPLICE WEATHERPROOFING KIT #221213 OR
- ALL COAXIAL CABLE GROUNDING KITS ARE TO BE INSTALLED ON STRAIGHT RUNS OF

AMERICAN TOWER®



Dewberry Engineers Inc. 99 SUMMER STREET SUITE 700 BOSTON, MA 02110 PHONE: 617.531.0801 FAX: 617.695.3310

DESCRIPTION	BY	DATE
PRELIM	SN	06/02/21
FINAL	JI	06/30/21
	PRELIM	PRELIM SN

ATC SITE NUMBER: 383598

ATC SITE NAME: **TARTAGLIA**

VERIZON SITE NAME:

BRIDGEPORT NORTH

SITE ADDRESS: 1000 TRUMBULL AVENUE BRIDGEPORT, CT 6606

ALL DISCREPANCIES FROM WHAT IS SHOWN ON THESE

CONSTRUCTION DRAWINGS SHALL BE COMMUNICATED TO ATC

FAILURE TO COMMUNICATE DIRECTLY WITH ATC ENGINEERING OR

ANY CHANGES FROM THE DESIGN CONDUCTED WITHOUT PRIOR

APPROVAL FROM ATC ENGINEERING SHALL BE THE SOLE RESPONSIBILITY OF THE GENERAL CONTRACTOR.

ENGINEERING IMMEDIATELY FOR CORRECTION OR RE-DESIGN.



DATE DRAWN:	06/02/21
ATC JOB NO:	13668689
CUSTOMER ID:	BRIDGEPORT NORTH
CUSTOMER #:	467325

GENERAL NOTES

SHEET NUMBER:

REVISION

G-002


SITE PLAN NOTES:


- 1. THIS SITE PLAN REPRESENTS THE BEST PRESENT KNOWLEDGE AVAILABLE TO THE ENGINEER AT THE TIME OF THIS DESIGN. THE CONTRACTOR SHALL VISIT THE SITE PRIOR TO CONSTRUCTION AND VERIFY ALL EXISTING CONDITIONS RELATED TO THE SCOPE OF WORK FOR THIS PROJECT.
- 2. ICE BRIDGE, CABLE LADDER, COAX PORT, AND COAX CABLE ARE SHOWN FOR REFERENCE ONLY. CONTRACTOR SHALL CONFIRM THE EXACT LOCATION OF ALL PROPOSED AND EXISTING EQUIPMENT AND STRUCTURES DEPICTED ON THIS PLAN. BEFORE UTILIZING EXISTING CABLE SUPPORTS, COAX PORTS, INSTALLING NEW PORTS OR ANY OTHER EQUIPMENT, CONTRACTOR SHALL VERIFY ALL ASPECTS OF THE COMPONENTS MEET THE ATC SPECIFICATIONS.
- 3. NO ELECTRICAL SCOPE IS INCLUDED IN THIS PROJECT.

<u>LEGEND</u>					
∣⊗	GROUNDING TEST WELL				
ATS	AUTOMATIC TRANSFER SWITCH				
В	BOLLARD				
CSC	CELL SITE CABINET				
D	DISCONNECT				
E	ELECTRICAL				
F	FIBER				
GEN	GENERATOR				
G	GENERATOR RECEPTACAL				
HH, V	HAND HOLE, VAULT				
IB	ICE BRIDGE				
K	KENTROX BOX				
LC	LIGHTING CONTROL				
М	METER				
PB	PULL BOX				
PP	POWER POLE				
Т	TELCO				
TRN	TRANSFORMER				
×	CHAINLINK FENCE				

PROPOSED CABLE LENGTH:

- ESTIMATED LENGTH OF PROPOSED CABLE IS XXX. ESTIMATED LENGTH OF CABLE WAS PROVIDED BY CUSTOMER OR CALCULATED BY ADDING THE RAD CENTER AND THE DISTANCE FROM THE SHELTER ENTRY PLATE TO THE TOWER (ALONG THE ICE BRIDGE) AND A SAFETY FACTOR MEASUREMENT OF 15% (OF THE TWO PREVIOUS VALUES), CDS DEFER TO GREATEST CABLE LENGTH.
- 2. ROUTE PROPOSED CABLES ALONG SAME PATH AS EXISTING CABLES AND IN ACCORDANCE WITH STRUCTURAL ANALYSIS. WHERE POSSIBLE UTILIZE EXISTING CABLE SUPPORT STRUCTURES AS PROVIDED FOR CARRIER TO ADEQUATELY SECURE CABLES, USING EITHER APPROPRIATELY SIZED STAINLESS STEEL SNAP-INS OR MOUNTING HARDWARE AND BRACKETS AS SPECIFIED BY CABLE MANUFACTURER. OTHERWISE, ATTACH CABLES TO HORIZONTAL OR DIAGONAL TOWER MEMBERS USING PROPOSED STAINLESS STEEL ADAPTERS (DO NOT ATTACH TO TOWER LEG).

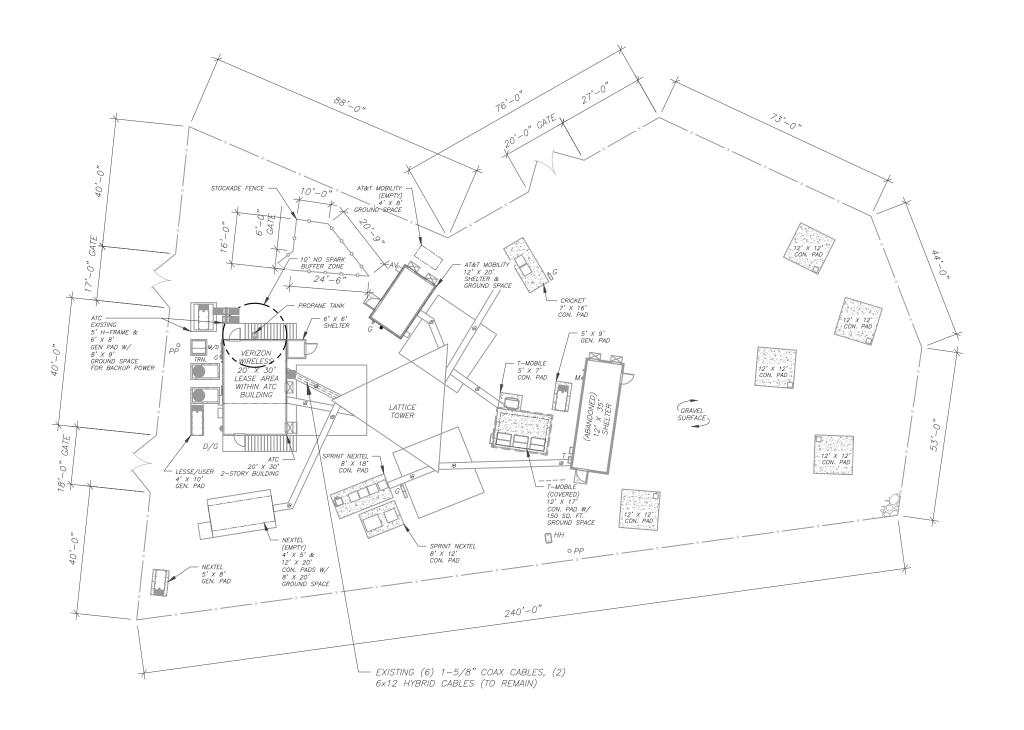

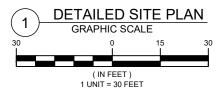







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verizon /


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DETAILED SITE PLAN

SHEET NUMBER:

C-101

PER MOUNT ANALYSIS COMPLETED BY MASER CONSULTING CONNECTICUT, DATED 06/11/21, THE EXISTING MOUNT MUST BE MODIFIED TO ADEQUATELY SUPPORT THE PROPOSED LOADING. THE MOUNT MODIFICATION PROPOSED IN THE MOUNT ANALYSIS, INCLUDED AT THE END OF THIS PLAN SET, MUST BE INSTALLED PRIOR TO THE INSTALLATION OF THE PROPOSED ANTENNAS AND OTHER EQUIPMENT.

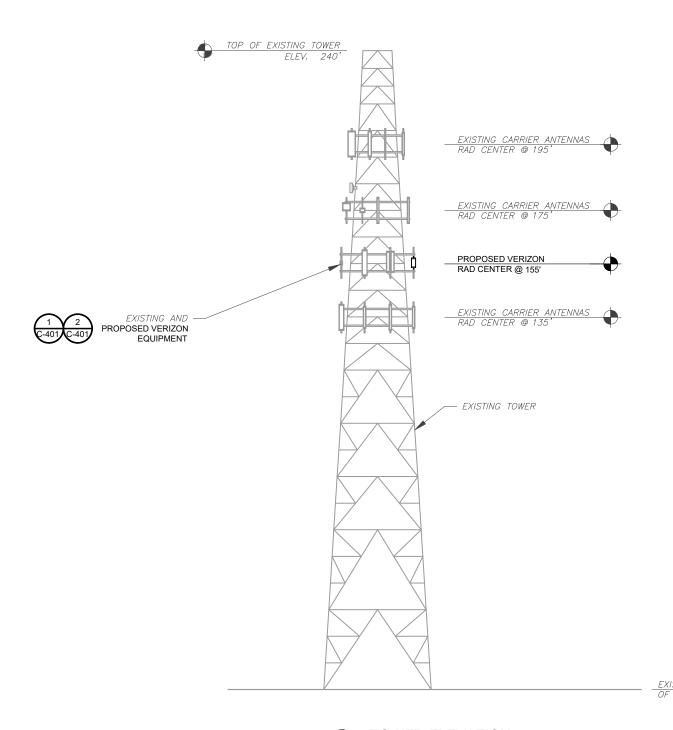

- TOWER NOTE:

 1. IT IS THE CONTRACTOR'S RESPONSIBILITY TO CONFIRM WITH THE PROJECT MANAGER THAT THEY HAVE THE MOST RECENT VERSION OF THE STRUCTURAL ANALYSIS BEFORE COMMENCING WORK. EXISTING AND PROPOSED TOWER APPURTENANCES, MOUNTS, AND ANTENNAS ARE SHOWN BASED ON THE STRUCTURAL ANALYSIS.
- 2. WHERE APPLICABLE, ALL NEW ANTENNAS, EQUIPMENT, MOUNTS, CABLING, ETC. SHALL BE PAINTED/SOCKED TO MATCH EXISTING EQUIPMENT IN ACCORDANCE WITH FAA, JURISDICTION, AND/OR OTHER LOCAL REQUIREMENTS.
- TOWER ELEVATIONS ARE MEASURED FROM TOP OF BASE PLATE TO MATCH STRUCTURAL ANALYSIS. ELEVATIONS DO NOT REFLECT TRUE ABOVE GROUND LEVEL (A.G.L.)





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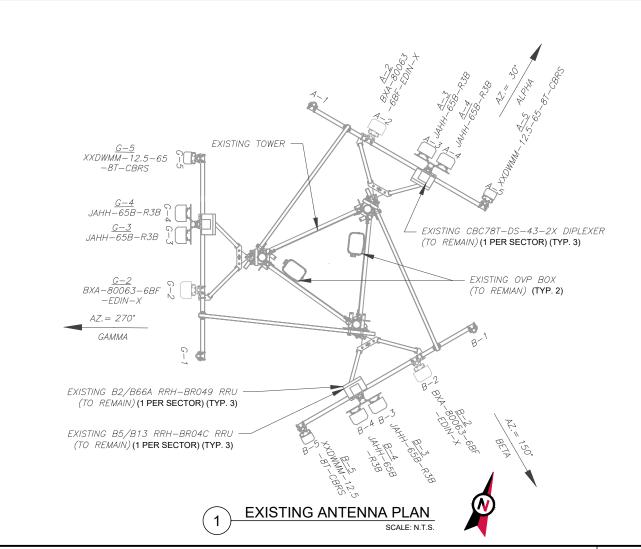
TOWER ELEVATION


SHEET NUMBER:

C-201

REVISION:

TOWER ELEVATION SCALE: N.T.S.



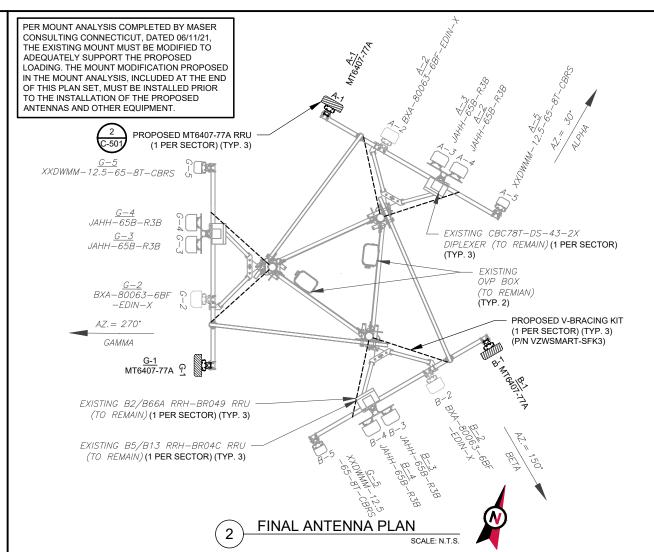

			EXIST	TING ANTENNA SCHEDUL	LE				NOTES					FINAL ANTENNA SCHE	DULE				
LOCATIO	N		ANTENN	IA SUMMARY			NON ANTENNA SUMM	ARY	CONFIRM WITH VERIZON REP	LOC	CATION		AN	TENNA SUMMARY			NON ANTENNA SUMM	MARY	
ECTO RAD	AZ	POS	ANTENNA	BAND	MECH/ELEC D-TILT	STAT	ADDITIONAL TOWER MOUNTED EQUIPMENT	STATUS	FOR APPLICABLE UPDATES/REVISIONS AND MOST RECENT RFDS FOR NSN	SECTOR	RAD	AZ	POS ANTENNA	BAND	MECH/ELEC D-TILT	STATUS	ADDITIONAL TOWER MOUNTED EQUIPMENT	STATUS	
		12	BXA-80063-6BF-EDIN-4	CDMA 850		RMN	_		CONFIGURATION (CONFIG). GC				A1 MT6407-77A	L-SUB6	0/6	ADD	MT6407-77A	ADD	
		AZ			_			_	TO CAP ALL UNUSED PORTS. 2. CONFIRM SPACING OF				A2 BXA-80063-68F-EDIN-4	CDMA 850	-	RMN	=	-	
		A3	JAHH-65B-R3B	700/850/1900/AWS	0/2,2,2,2	RMN	B2/B66A RRH-BR049	RMN	PROPOSED EQUIP DOES NOT				A3 JAHH-65B-R3B	700/850/1900/AWS	0/2,2,2,2	RMN	B2/B66A RRH-BR049	RMN	
LPHA 155'	30°	A4	IALIII CER DZD	700/850/1900/AWS	0/2222	DIAN	CBC78T-DS-43-2X	RMN	CAUSE TOWER CONFLICTS NOR IMPEDE TOWER CLIMBING	ALPHA	155'	30°			0/0.0.0.0	RMN	CBC78T-DS-43-2X	RMN	
		A4	<i>JAHH−65B−R3B</i>	700/630/1900/AWS	0/2,2,2,2	KIVIN	B5/B13 RRH-BROC	RMN	PEGS.				A4 JAHH-65B-R3B	700/850/1900/AWS	0/2,2,2,2	RMN	B5/B13 RRH-BRO4C	RMN	
		A5	XXDWMM-12.5-65-8T-CBRS	CBRS	0/8	RMN	CBRS RRH RT4401-48A	RMN	07.17.10.100.00			A5 XXDWMM-12.5-65-8T-CBRS	CBRS	0/8	RMN	CBRS RRH RT4401-48A	RMN		
		B2	BXA-80063-6BF-EDIN-4	CDMA 850	-	RMN	_	_	RMN: TO REMAIN REL: TO BE RELOCATED				B1 MT6407-77A	L-SUB6	0/6	ADD	MT6407-77A	ADD	
		B3	JAHH-65B-R3B	700/850/1900/AWS	0/2,2,2,2	RMN	<i>B2/B66A RRH-BR049</i>	RMN					B2 BXA-80063-68F-EDIN-4	CDMA 850				+	
BETA 155'	150°) _{B4}	JAHH-65B-R3B	700/850/1900/AWS	0/2222	DIANI	CBC78T-DS-43-2X	RMN			155'	150°	B3 JAHH-65B-R3B	700/850/1900/AWS	0/2,2,2,2	RMN	B2/B66A RRH-BR049	RMN	
			UATITI USB - NOB	7007000713007AWS	0/ 2,2,2,2	777777	B5/B13 RRH-BROC	RMN	ADD: TO BE ADDED	BEIA	133	130			0/0.0.0	RMN	CBC78T-DS-43-2X	RMN	
		B5	XXDWMM-12.5-65-8T-CBRS	CBRS	0/8	RMN	CBRS RRH RT4401-48A	RMN					B4 JAHH-65B-R3B	700/850/1900/AWS	0/2,2,2,2	RMN	B5/B13 RRH-BRO4C	RMN	
		G2	BXA-80063-6BF-EDIN-4	CDMA 850	_	RMN	_	_					B5 XXDWMM-12.5-65-8T-CBR	CBRS	0/8	RMN	CBRS RRH RT4401-48A	RMN	
		G3	JAHH-65B-R3B	700/850/1900/AWS	0/2,2,2,2	RMN	<i>B2/B66A RRH-BR049</i>	RMN	CABLE LENGTHS FOR JUMPERS				G1 MT6407-77A	L-SUB6	0/6	ADD	MT6407-77A	ADD	
AMMA 155'	270°	· G4	141111 0550 0750	700/850/1900/AWS	0/2222	0144	CBC78T-DS-43-2X	RMN	JUNCTION BOX TO RRU: 15' RRU TO ANTENNA: 10'					G2 BXA-80063-68F-EDIN-4	CDMA 850				
		64	JAHH-65B-R3B	700/630/1900/AWS	0/2,2,2,2	KIVIIV	B5/B13 RRH-BROC	RMN	RRO TO ANTENNA. 10	GAMMA	155'		G3 JAHH-65B-R3B	700/850/1900/AWS	0/2,2,2,2	RMN	B2/B66A RRH-BR049	RMN	
		G5	XXDWMM-12.5-65-8T-CBRS	CBRS	0/8	RMN	CBRS RRH RT4401-48A	RMN		GAIVIIVIA	133	210	G4 JAHH-65B-R3B	700/850/1900/AWS	0/2,2,2,2	RMN	CBC78T-DS-43-2X	RMN	
	1							1					G4 3AHH-03B-13B	700/030/1900/AVV3	0/2,2,2,2	RMN	B5/B13 RRH-BRO4C	RMN	
													G5 XXDWMM-12.5-65-8T-CBR	CBRS	0/8	RMN	CBRS RRH RT4401-48A	RMN	

EXISTING FIBER DISTRIBUTION/O	/P BOX	EXISTING CABLING SUMMARY						
MODEL NUMBER	STATUS	COAX	HYBRID	STATUS				
(2) OVP-6	RMN	(6)1-5/8"	(2) 6X12	RMN				

3 EQUIPMENT SCHEDULES

FINAL FIBER DISTRIBUTION / OVP BOX		FINAL CABLING SUMMARY		
MODEL NUMBER	STATUS	COAX	HYBRID	STATUS
(2) OVP-6	RMN	(6) 1-5/8"	(2) 6X12	RMN





Dewberry Engineers Inc.
99 SUMMER STREET
SUITE 700
BOSTON, MA 02110
PHONE: 617.531.0801
FAX: 617.695.3310

REV.	DESCRIPTION	BY	DATE
<u> </u>	PRELIM	SN	06/02/21
<u></u>	FINAL	JI	06/30/21
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ATC SITE NUMBER: 383598

ATC SITE NAME: TARTAGLIA

VERIZON SITE NAME:
BRIDGEPORT NORTH

SITE ADDRESS: 1000 TRUMBULL AVENUE BRIDGEPORT, CT 6606






	DATE DRAWN:	06/02/21
	ATC JOB NO:	13668689
	CUSTOMER ID:	BRIDGEPORT NORTH
	CUSTOMER #:	467325


ANTENNA INFORMATION & SCHEDULE

C-401

1 0

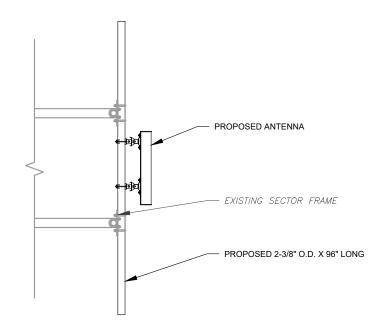

PROPOSED 5G ANTENNA MOUNTING DETAIL - TYPICAL
SCALE: N.T.S

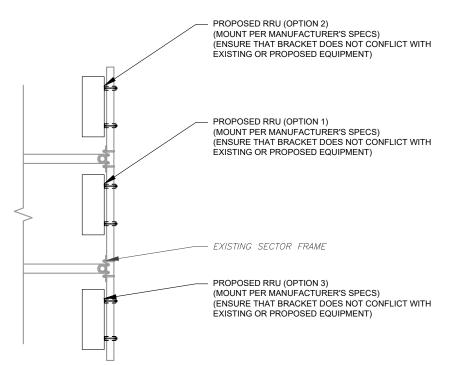

PROPOSED RRU MOUNTING DETAIL - TYPICAL
SCALE: N.T.S.





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<u> </u>	PRELIM	SN	06/02/21
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SEAL:






	DATE DRAWN:	06/02/21
	ATC JOB NO:	13668689
	CUSTOMER ID:	BRIDGEPORT NORTH
	CUSTOMER #:	467325

CONSTRUCTION DETAILS


SHEET NUMBER:

C-501

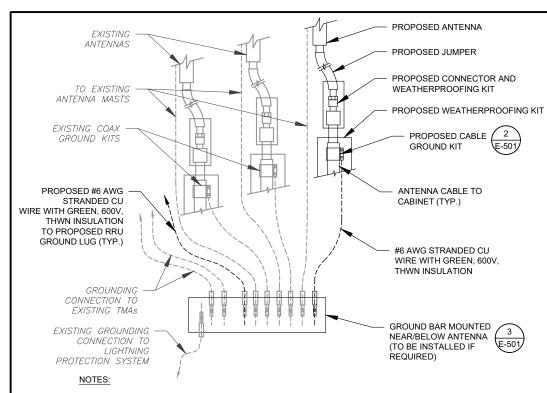

- 1. THIS DETAIL IS INTENDED TO SHOW THE GENERAL GROUNDING REQUIREMENTS. SLIGHT ADJUSTMENTS MAY BE REQUIRED BASED ON EXISTING SITE CONDITIONS. THE CONTRACTOR SHALL MAKE FIELD ADJUSTMENTS AS NEEDED AND INFORM THE CONSTRUCTION MANAGER OF ANY CONFLICTS.
- 2. SITE GROUNDING SHALL COMPLY WITH VERIZON GROUNDING STANDARDS, LATEST EDITION, AND COMPLY WITH VERIZON GROUNDING CHECKLIST, LATEST VERSION. WHEN NATIONAL AND LOCAL GROUNDING CODES ARE MORE STRINGENT THEY SHALL GOVERN.




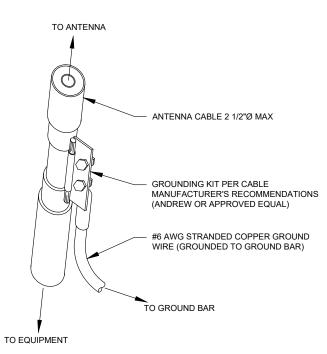

- GROUND KIT NOTES:

 1. DO NOT INSTALL CABLE GROUND KIT AT A BEND AND ALWAYS DIRECT GROUND WIRE DOWN TO GROUND BAR.
- 2. CONTRACTOR SHALL PROVIDE WEATHERPROOFING KIT (ANDREW PART NUMBER 221213) AND INSTALL/TAPE PER MANUFACTURER'S SPECIFICATIONS.

CABLE GROUND KIT CONNECTION DETAIL

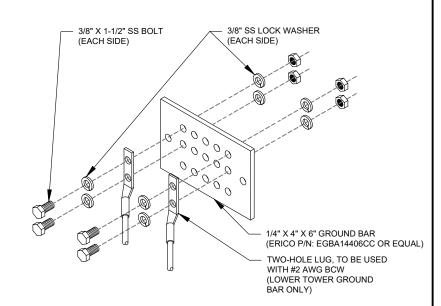

GROUND BAR NOTES:

- GROUND BAR KITS COME WITH ALL HARDWARE, NUTS, BOLTS, WASHERS, ETC. EXCEPT THE STRUCTURAL MOUNTING MEMBER(S).
- 2. GROUND BAR TO BE BONDED DIRECTLY TO TOWER.







Dewberry Engineers Inc.
99 SUMMER STREET SUITE 700 BOSTON, MA 02110 PHONE: 617.531.0801 FAX: 617.695.3310

REV.	DESCRIPTION	BY	DATE
<u> </u>	PRELIM	SN	06/02/21
<u></u>	FINAL	JI	06/30/21
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ATC SITE NUMBER: 383598

ATC SITE NAME: **TARTAGLIA**

VERIZON SITE NAME:

BRIDGEPORT NORTH

SITE ADDRESS: 1000 TRUMBULL AVENUE BRIDGEPORT, CT 6606






DATE DRAWN:	06/02/21
ATC JOB NO:	13668689
CUSTOMER ID:	BRIDGEPORT NORTH
CUSTOMER #:	467325

GROUNDING DETAILS

SHEET NUMBER:

REVISION:


E-501

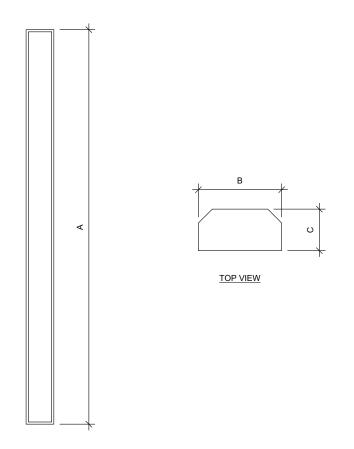

FRONT VIEW

ANTENNA SPECIFICATIONS FOR ILLUSTRATIVE PURPOSES ONLY - NOT TO SCALE

ANTENNA SPECIFICATIONS				
ANTENNA MODEL	А	В	С	WEIGHT (LBS)
MT6407-77A	35.1"	16.1"	5.5"	81.6

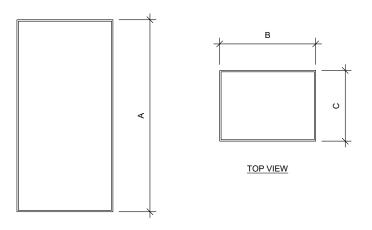

FRONT VIEW

2 RRU SPECIFICATIONS FOR ILLUSTRATIVE PURPOSES ONLY - NOT TO SCALE

RRU SPECIFICATIONS				
RRU MODEL	A	В	С	WEIGHT (LBS)
MT6407-77A	35.1"	16.1"	5.5"	81.6





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SUITE 700
BOSTON, MA 02110
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DATE DRAWN:	06/02/21
ATC JOB NO:	13668689
CUSTOMER ID:	BRIDGEPORT NORTH
CUSTOMER #:	467325

SUPPLEMENTAL

SHEET NUMBER:

R-601





Maser Consulting Connecticut 2000 Midlantic Drive, Suite 100 Mt. Laurel, NJ 08054 856.797.0412 Peter.Albano@ColliersEngineering.com

Post-Mod Antenna Mount Analysis Report and PMI Requirements

Mount Fix

SMART Tool Project #: 10069536 Maser Consulting Connecticut Project #: 21777438A

June 11, 2021

Site Information Site ID: 467325-VZW / N BRIDGEPORT CT

Site Name: N BRIDGEPORT CT
Carrier Name: Verizon Wireless
Address: 1330 Chopsey Hill Ro

1330 Chopsey Hill Rd. Bridgeport, Connecticut 06606,

Fairfield County
Latitude: 41.219528°
Longitude: -73.201779°

 Structure Information
 Tower Type:
 Self-Support

 Mount Type:
 13.00-Ft Sector Frame

FUZE ID # 16231899

Analysis Results

Sector Frame: 81.2% Pass

***Contractor PMI Requirements:
Included at the end of this MA report
Available & Submitted via portal at https://pmi.vzwsmart.com
Contractor - Please Review Specific Site PMI Requirements Upon Award
Requirements also Noted on Mount Modification Drawings
Requirements may also be Noted on A & E drawings

Report Prepared By: Abigail Enriquez



Mount Post-Modification Analysis Report (3) 13.00-Ft Sector Frame

June 11, 2021 Site ID: 467325-VZW / N BRIDGEPORT CT Page I 4

- 5. The mount was checked up to, and including, the bolts that fasten it to the mount collar/attachment and threaded rod connections in collar members if applicable. Local deformation and interaction between the mount collar/attachment and the supporting tower structure are outside the scope of this analysis.
- All services are performed, results obtained, and recommendations made in accordance with generally
 accepted engineering principles and practices. Maser Consulting Connecticut is not responsible for the
 conclusion, opinions, and recommendations made by others based on the information supplied.
- Structural Steel Grades have been assumed as follows, if applicable, unless otherwise noted in this analysis:

Channel, Solid Round, Angle, Plate
HSS (Rectangular)
Pipe
Threaded Rod
Bolts
ASTM A36 (Gr. 36)
ASTM 500 (Gr. B-46)
ASTM A53 (Gr. B-35)
F1554 (Gr. 36)
ASTM A325

 Any mount modifications listed under Sources of Information are assumed to have been installed per the design specifications.

Discrepancies between in-field conditions and the assumptions listed above may render this analysis invalid unless explicitly approved by Maser Consulting Connecticut.

Analysis Results:

Component	Utilization %	Pass/Fail
Pipe Standoff Horizontal	11.2 %	Pass
Face Horizontal	45.8 %	Pass
Face Diagonal	6.6 %	Pass
Mount Pipe	69.1 %	Pass
Pipe Face Horizontal	81.2 %	Pass
Standoff Horizontal	26.8 %	Pass
Standoff Vertical	12.4 %	Pass
Standoff Diagonal	6.3 %	Pass
Dual Mount Pipe	19.4 %	Pass
Tieback	11.3 %	Pass
V-Brace	27.0 %	Pass
Mount Connection Check	8.5 %	Pass
Kicker Connection Check	26.6 %	Pass

Structure Rating – (Controlling Utilization of all Components)	81.2%

Recommendation:

The existing mounts will be **SUFFICIENT** for the final loading after the proposed modifications are successfully completed.

ANSI/ASSP rigging plan review services compliant with the requirements of ANSI/TIA 322 are available for a Construction Class IV site or other, if required. Separate review fees will apply.

AMERICAN TOWER®



Dewberry Engineers Inc.
99 SUMMER STREET
SUITE 700
BOSTON, MA 02110
PHONE: 617.531.0801
FAX: 617.695.3310

ATC SITE NUMBER: 383598

ATC SITE NAME: TARTAGLIA

VERIZON SITE NAME:

BRIDGEPORT NORTH

SITE ADDRESS: 1000 TRUMBULL AVENUE BRIDGEPORT, CT 6606

verizon[/]

 DATE DRAWN:
 06/02/21

 ATC JOB NO:
 13668689

 CUSTOMER ID:
 BRIDGEPORT NORTH

 CUSTOMER #:
 467325

SUPPLEMENTAL

SHEET NUMBER:

R-602

PROJECT NOTES

- SEE MODIFICATION NOTES
- THE CONTRACTOR SHALL COMPLY WITH ALL APPLICABLE CODES, ORDINANCES, LAWS AND REGULATIONS OF ALL MUNICIPALITIES, UTILITY COMPANIES OR OTHER PUBLIC/GOVERNING AUTHORITIES
- THE CONTRACTOR SHALL BE RESPONSIBLE FOR OBTAINING ALL PERMITS AND INSPECTIONS THAT MAY BE REQUIRED BY ANY FEDERAL, STATE, COUNTY OR MUNICIPAL AUTHORITIES.
- THE CONTRACTOR SHALL NOTIFY THE CONSTRUCTION MANAGER, IN WRITING, OF ANY CONFLICTS, ERRORS OR OMISSIONS PRIOR TO THE SUBMISSION OF BIDS OR PERFORMANCE
- THE CONTRACTOR SHALL BE RESPONSIBLE FOR PROTECTING ALL EXISTING SITE IMPROVEMENTS PRIOR TO COMMENCING CONSTRUCTION. THE CONTRACTOR SHALL REPAIR ANY DAMAGE AS A RESULT OF CONSTRUCTION OF THIS FACILITY AT THE CONTRACTOR'S EXPENSE TO THE SATISFACTION OF THE OWNER.
- THE SCOPE OF WORK FOR THIS PROJECT SHALL INCLUDE PROVIDING ALL MATERIALS, EQUIPMENT AND LABOR REQUIRED TO COMPLETE THIS PROJECT. ALL EQUIPMENT SHALL BE INSTALLED IN ACCORDANCE WITH MANUFACTURER'S RECOMMENDATIONS.
- THE CONTRACTOR SHALL VISIT THE PROJECT SITE PRIOR TO SUBMITTING THE BID TO VERIFY THAT THE PROJECT CAN BE CONSTRUCTED IN ACCORDANCE WITH THE CONTRACT DOCUMENTS AND CONSTRUCTION DRAWINGS
- THE CONTRACTOR SHALL VERIFY ALL EXISTING DIMENSIONS AND CONDITIONS PRIOR TO COMMENCING ANY WORK. ALL DIMENSIONS OF EXISTING CONSTRUCTION SHOWN ON THESE DRAWINGS MUST BE VERIFIED. THE CONTRACTOR SHALL NOTIFY THE CONSTRUCTION MANAGER OF ANY DISCREPANCIES PRIOR TO ORDERING MATERIAL OR PROCEEDING WITH CONSTRUCTION.
- SINCE THE CELL SITE MAY BE ACTIVE, ALL SAFETY PRECAUTIONS MUST BE TAKEN WHEN WORKING AROUND HIGH LEVELS OF ELECTROMAGNETIC RADIATION. EQUIPMENT SHOULD BE SHUTDOWN PRIOR TO PERFORMING ANY WORK THAT COULD EXPOSE THE WORKERS TO DANGER. PERSONAL RF EXPOSURE MONITORS ARE REQUIRED TO BE WORN TO ALERT OF ANY POTENTIALLY DANGEROUS EXPOSURE LEVELS.
- NO NOISE, SMOKE, DUST OR ODOR WILL RESULT FROM THIS FACILITY AS TO CAUSE A NUISANCE.
- THE FACILITY IS UNMANNED AND NOT FOR HUMAN HABITATION (NO HANDICAP ACCESS IS REQUIRED).

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MOUNT MODIFICATION DRAWINGS **EXISTING 13.00' SECTOR FRAME**

SITE NAME: N BRIDGEPORT CT **SITE NUMBER: 467325**

> 1330 CHOPSEY HILL RD. BRIDGEPORT, CT 06606 **FAIRFIELD COUNTY**

PROJECT INFORMATION

SITE INFORMATION

41.219528° N 73.201779° W ATITUDE: LONGITUDE: JURISDICTION: FAIRFIELD COUNTY

APPLICANT/LESSEE

COMPANY: **VERIZON WIRELESS**

CLIENT REPRESENTATIVE

VERIZON WIRELESS

I 18 FLANDERS ROAD, THIRD FLOOR CITY, STATE, ZIP:

WESTBOROUGH, MA 01581 ANDREW CANDIELLO CONTACT:

ANDREW.CANDIELLO@VERIZONWIRELESS.COM EMAIL:

PROJECT MANAGER

COMPANY: MASER CONSULTING PETER ALBANO CONTACT (856) 797-0412 PHONE:

PETER.ALBANO@COLLIERSENGINEERING.COM

	SHEET INDEX				
SHEET	DESCRIPTION				
T-I	TITLE SHEET				
S-I	BILL OF MATERIALS				
S-2	MODIFICATION NOTES				
S-3	MODIFICATION NOTES				
S-4	MODIFICATION DETAILS				
S-5	MODIFICATION DETAILS				
S-6	MOUNT PHOTOS				
	SPECIFICATION SHEETS				

CONTRACTOR PMI REQUIREMENTS

PMI LOCATION: HTTPS://PMI.VZWSMART.COM

SMART TOOL PROJECT #: 10069536 VZW LOCATION CODE (PSLC): 467325

PMI REQUIREMENTS EMBEDDED WITHIN MOUNT MODIFICATION REPORT

REFERENCED DOCUMENTS

FAILING MOUNT ANALYSIS REPORT SMART TOOL PROJECT #: MASER CONSULTING PROJECT #: 10050383 21777438A

ANALYSIS DATE:

MASER CONSULTING
—CONNECTICUT—

NEW YORK PENNSYLVANIA ■ MARYLAND ■ GEORGIA VIRGINIA FLORIDA


TEXAS NORTH CAROLINA SOUTH CAROLINA

■ NEW MEXICO





AS SHOW к: 21777438A

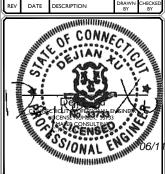

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SITE NAME:

N BRIDGEPORT CT 467325

1330 CHOPSEY HILL RD. BRIDGEPORT, CT 06606 FAIRFIELD COUNTY



Phone: 856.797.0412 Fax: 856.722.1120

TITLE SHEET

BILL OF MATERIALS VZWSMART KITS QUANTITY MANUFACTURER PART NUMBER DESCRIPTION NOTES CONTRACTOR TO VERIFY THE LENGTH REQUIRED AND TRIM AS NECESSARY IN ACCORDANCE WITH THE 'STRUCTURAL STEEL' NOTES ON SHEET S-2 VZWSMART-SFK3 V-BRACING KIT 2 VZWSMART-MSKI CROSSOVER PLATE **VZWSMART** OTHER REQUIRED PARTS QUANTITY MANUFACTURER PART NUMBER DESCRIPTION NOTES

NOTE: ALL MATERIALS REQUIRED FOR THE DESIGNED MODIFICATIONS BUT NOT LISTED IN THIS SHEET ARE ASSUMED TO BE PROVIDED BY THE CONTRACTOR

VZWSMART KITS - APPROVED VENDORS				
COMMSCOPE				
CONTACT	SALVADOR ANGUIANO			
PHONE	(817) 304-7492			
EMAIL	SALVADOR.ANGUIANO@COMMSCOPE.COM			
WEBSITE	WWW.COMMSCOPE.COM			
METROSITE FABRICATORS, LLC				
CONTACT	KENT RAMEY			
PHONE	(706) 335-7045 (O), (706) 982-9788 (M)			
EMAIL	KENT@METROSITELLC.COM			
WEBSITE	METROSITEFABRICATORS.COM			
	PERFECTVISION			
CONTACT	WIRELESS SALES			
PHONE	PHONE (844) 887-6723			
EMAIL	WWW.PERFECT-VISION.COM			
WEBSITE	WIRELESSSALES@PERFECT-VISION.COM			
	SABRE INDUSTRIES, INC.			
CONTACT	ANGIE WELCH			
PHONE	(866) 428-6937			
EMAIL	AKWELCH@SABREINDUSTRIES.COM			
WEBSITE	www.sabresitesolutions.com			
SITE PRO 1				
CONTACT	PAULA BOSWELL			
PHONE	(972) 236-9843			
EMAIL	PAULA.BOSWELL@VALMONT.COM			
WEBSITE	WWW.SITEPROI.COM			

NOTE: WHEN SPECIFIED, VZWSMART KITS SHALL BE REQUIRED AND WILL BE VERIFIED DURING THE DESKTOP PMI




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Customer Loyalty through Client Satisfaction
W W W . m a s e r c o n s ul t i ng . c o m
Office Locations:

NEW JERSEY
NEW JERSEY
NEW YORK
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NEW YORK
NEW YORK
NEW YORK
NEW YORK
NEW TORK
NEW YORK
NEW TORK
NEW MARYLAND
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TEXAS
FLORIDA
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SOUTH CAROLINA
Caprigned Dill Plant Consideral All Rights Bearned. This downing and all the informationable heating and for one only by they for whord the arrows one contrassement was contrassed and the contrassed the case in adults of the other through and all the informationable manually for one only by the grey the whord the arrows one contrassed the case in adults of the other through and all the informationable manually and the out for the other through and all the informationable manually and the out for the other through the other through the contrassed through the other through the other through the other through the contrassed through the other through through the other through the other through the other through through the other through through the other through the other through through through through the other through through th



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REV	DATE	DESCRIPTIO	Z	DRAWN RY	CHECKED RY

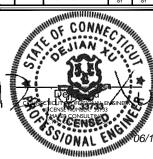

IT IS A VIOLATION OF LAW FOR ANY PERSON, UNLESS THEY ARE ACTING UNDER THE DIRECTION OF THE RESPONSIBLE LICENSED PROFESSIONAL ENGINEER, TO ALTER THIS DOCUMENT.

SITE NAME:

N BRIDGEPORT CT 467325

1330 CHOPSEY HILL RD. BRIDGEPORT, CT 06606 FAIRFIELD COUNTY



Phone: 856.797.0412 Fax: 856.722.1120

BILL OF MATERIALS

S-I

GENERAL NOTES

- I. THESE MODIFICATIONS HAVE BEEN DESIGNED IN ACCORDANCE WITH THE GOVERNING PROVISIONS OF THE TELECOMMUNICATIONS INDUSTRY STANDARD TIA-222-H. MATERIALS AND SERVICES PROVIDED BY THE CONTRACTOR SHALL CONFORM TO THE ABOVE MENTIONED CODES.
- 2. CONTRACTOR SHALL TAKE ALL PRECAUTIONS NECESSARY TO PREVENT DAMAGE TO EXISTING STRUCTURES, ANY DAMAGE TO EXISTING STRUCTURES AS A RESULT OF THE CONTRACTOR'S WORK OR FROM DAMAGE DUE TO OTHER CAUSES SHALL BE REPAIRED AT THE CONTRACTOR'S EXPENSE TO THE SATISFACTION OF THE OWNER.
- CONTRACTOR SHALL VERIFY ALL DIMENSIONS AND EXISTING CONDITIONS BEFORE BEGINNING WORK, ORDERING MATERIAL, AND PREPARING OF SHOP DRAWINGS, ANY DISCREPANCIES BETWEEN FIELD CONDITIONS AND THE CONTRACT DOCUMENTS SHALL BE BROUGHT TO THE IMMEDIATE ATTENTION OF THE ENGINEER. IF THE CONTRACTOR DISCOVERS ANY EXISTING CONDITIONS THAT ARE NOT REPRESENTED ON THESE DRAWINGS, OR ANY CONDITIONS THAT WOULD INTERFERE WITH THE INSTALLATION OF THE MODIFICATIONS, NOTIFY THE ENGINEER IMMEDIATELY
- 4. IT IS ASSUMED THAT ANY STRUCTURAL MODIFICATION WORK SPECIFIED ON THESE PLANS WILL BE ACCOMPLISHED BY KNOWLEDGEABLE WORKMEN WITH TOWER CONSTRUCTION EXPERIENCE.
- 5. THE CONTRACTOR SHALL SUPERVISE AND DIRECT THE WORK AND SHALL BE SOLELY RESPONSIBLE FOR ALL CONSTRUCTION METHODS, MEANS, TECHNIQUES, SEQUENCES, AND PROCEDURES.
- ALL CONSTRUCTION MEANS AND METHODS; INCLUDING BUT NOT LIMITED TO, ERECTION PLANS, RIGGING PLANS, CLIMBING PLANS, AND RESCUE PLANS SHALL BE THE RESPONSIBILITY OF THE GENERAL CONTRACTOR RESPONSIBLE FOR THE EXECUTION OF THE WORK CONTAINED HEREIN AND SHALL MEET ANSI/TIA-322 (LATEST EDITION), OSHA, AND GENERAL INDUSTRY STANDARDS ALL RIGGING PLANS SHALL ADHERE TO ANSI/TIA-322 (LATEST EDITION) INCLUDING THE REQUIRED INVOLVEMENT OF A QUALIFIED ENGINEER FOR CLASS IV CONSTRUCTION.
- 7. THE CONTRACTOR IS SOLELY RESPONSIBLE FOR INITIATING, MAINTAINING, AND SUPERVISING ALL SAFETY PROGRAMS IN ACCORDANCE WITH APPLICABLE SAFETY CODES.
- WORK SHALL ONLY BE PERFORMED DURING CALM DRY DAYS (WINDS LESS THAN 30-MPH). THE STRUCTURE SHOWN ON THE DRAWINGS IS STRUCTURALLY SOUND ONLY IN THE COMPLETED FORM. THE CONTRACTOR SHALL BE RESPONSIBLE FOR THE STRENGTH AND STABILITY OF THE STRUCTURE DURING ERECTION. CONTRACTOR SHALL PROVIDE TEMPORARY SUPPORT, SHORING, BRACING AND ANY OTHER STRUCTURAL SYSTEMS AS REQUIRED TO RESIST ALL FORCES THAT MAY OCCUR DURING HANDLING AND ERECTION UNTIL THE STRUCTURE IS FULLY COMPLETED. TEMPORARY SUPPORTS, BRACING AND OTHER STRUCTURAL SYSTEMS REQUIRED DURING CONSTRUCTION SHALL REMAIN THE CONTRACTOR'S PROPERTY AFTER THEIR USE.
- ALL INSTALLATIONS PERFORMED ON THIS STRUCTURE SHALL BE COMPLETED IN ACCORDANCE WITH THE GOVERNING PROVISIONS OF THE STANDARD FOR INSTALLATION, ALTERATION AND MAINTENANCE OF ANTENNA SUPPORTING STRUCTURES AND ANTENNAS, ANSI/TIA-322.
- 10. CONTRACTOR SHALL SECURE SITE BACK TO EXISTING CONDITION UNDER SUPERVISION OF OWNER, ALL FENCE, STONE, GEOFABRIC, GROUNDING, AND SURROUNDING GRADE SHALL BE REPLACED AND REPAIRED AS REQUIRED TO ACHIEVE OWNER APPROVAL. POSITIVE DRAINAGE AWAY FROM TOWER SITE SHALL BE MAINTAINED.
- II. CONNECTIONS BETWEEN ITEMS SUPPORTED BY THE STRUCTURE AND THE STRUCTURE NOT SPECIFICALLY DETAILED IN THE CONTRACT DOCUMENTS. ARE THE RESPONSIBILITY OF THE CONTRACTOR, SUCH CONNECTIONS SHALL BE DESIGNED, COORDINATED AND INSPECTED BY A PROFESSIONAL STRUCTURAL ENGINEER LICENSED IN THE STATE OF THE PROJECT, SUBMIT SIGNED AND SEALED CALCULATIONS DURING SHOP DRAWING REVIEW.
- 12. DO NOT SCALE DRAWINGS.
- 13. DO NOT USE THESE DRAWINGS FOR ANY OTHER SITE.
- 14 ALL MATERIAL UTILIZED FOR THIS PROJECT MUST BE NEW AND FREE OF ANY DEFECTS. ANY MATERIAL SUBSTITUTIONS, INCLUDING BUT NOT LIMITED TO ALTERED SIZE AND/OR STRENGTHS, MUST BE APPROVED BY THE OWNER AND ENGINEER IN WRITING.
- 15. THE MOUNT UNDER NO CIRCUMSTANCES SHOULD BE USED AS A TIE OFF

DESIGN LOADS

WIND LOADS

- a. BASIC WIND SPEED (3 SECOND GUST), V = 119 MPH
- b. EXPOSURE CATEGORY C
- c. TOPOGRAPHIC CATEGORY I
- d. MEAN BASE ELEVATION (AMSL) = 202.05'

- a. ICE WIND SPEED (3 SECOND GUST), V = 50 MPH
- b. ICE THICKNESS = 1.00 IN

SEISMIC LOADS

- a. SEISMIC DESIGN CATEGORY B
- b. SHORT TERM MCER GROUND MOTION, Sc = .211
- c. LONG TERM MCER GROUND MOTION, S_I = .054

STRUCTURAL STEEL

- I. DESIGN, DETAILING, FABRICATION AND ERECTION OF STRUCTURAL STEEL SHALL CONFORM TO THE FOLLOWING PUBLICATIONS EXCEPT AS SPECIFICALLY INDICATED IN THE CONTRACT DOCUMENTS.
 - a. AMERICAN INSTITUTE OF STEEL CONSTRUCTION (AISC) MANUAL OF STEEL CONSTRUCTION (15TH EDITION)
 - b. SPECIFICATION FOR STRUCTURAL JOINTS USING ASTM A325 OR A490 BOLTS
 - c. AISC CODE OF STANDARD PRACTICE
- 2. STRUCTURAL STEEL SHALL CONFORM TO THE FOLLOWING UNLESS OTHERWISE SHOWN:

CHANNELS, ANGLES, PLATES, ETC. ASTM A36 (GR 36) STEEL PIPE ASTM A53 (GR 35) **BOLTS** ASTM A325 NUTS ASTM A563

LOCK WASHERS LOCKING STRUCTURAL GRADE

- 3. ALL SUBSTITUTIONS PROPOSED BY THE CONTRACTOR SHALL BE APPROVED IN WRITING BY THE ENGINEER. CONTRACTOR SHALL PROVIDE DOCUMENTATION TO ENGINEER FOR VERIFYING THE SUBSTITUTE IS SUITABLE FOR USE AND MEETS ORIGINAL DESIGN CRITERIA. DIFFERENCES FROM THE ORIGINAL DESIGN, INCLUDING MAINTENANCE, REPAIR AND REPLACEMENT, SHALL BE NOTED. ESTIMATES OF COSTS/CREDITS ASSOCIATED WITH THE SUBSTITUTION (INCLUDING RE-DESIGN COSTS AND COSTS TO SUB-CONTRACTORS) SHALL BE PROVIDED TO THE ENGINEER. CONTRACTOR SHALL PROVIDE ADDITIONAL DOCUMENTATION AND/OR SPECIFICATIONS TO THE ENGINEER AS REQUESTED.
- 4. PROVIDE STRUCTURAL STEEL SHOP DRAWINGS TO ENGINEER FOR APPROVAL PRIOR TO FABRICATION.
 - a SUBMIT SHOP DRAWINGS TO
 - PETER.ALBANO@COLLIERSENGINEERING.COM
 - b. PROVIDE MASER CONSULTING PROJECT # AND MASER CONSULTING PROJECT ENGINEER CONTACT IN THE BODY OF THE EMAIL.
- 5. DRILL NO HOLES IN ANY NEW OR EXISTING STRUCTURAL STEEL MEMBERS OTHER THAN THOSE SHOWN ON STRUCTURAL DRAWINGS WITHOUT THE APPROVAL OF THE ENGINEER OF RECORD.
- 6. GALVANIZED ASTM A325 BOLTS SHALL NOT BE REUSED.
- 7. ALL NEW STEEL SHALL BE HOT BE DIPPED GALVANIZED FOR FULL WEATHER PROTECTION. IN ADDITION ALL NEW STEEL SHALL BE PAINTED TO MATCH EXISTING STEEL, CONTRACTOR SHALL OBTAIN WRITTEN PERMISSION TO PROTECT STEEL BY ANY OTHER MEANS.
- 8. ALL BOLT ASSEMBLIES FOR STRUCTURAL MEMBERS REPRESENTED IN THIS DRAWING REQUIRE LOCKING DEVICES TO BE INSTALLED IN ACCORDANCE WITH TIA-222-H SECTION 4.9.2 REQUIREMENTS.
- 9. WHERE CONNECTIONS ARE NOT FULLY DETAILED ON THESE DRAWINGS, FABRICATOR SHALL DESIGN CONNECTIONS TO RESIST LOADS AND FORCES WHERE SHOWN ON DRAWINGS AND AS OUTLINED IN SPECIFICATIONS.
- 10. FOR MEMBERS BEING REPLACED, PROVIDE NEW BOLTS AND MATCH EXISTING SIZE AND GRADE. MAINTAIN AISC REQUIREMENTS FOR MINIMUM BOLT DISTANCE AND SPACING.
- II. ALL PROPOSED AND/OR REPLACED BOLTS SHALL BE OF SUFFICIENT LENGTH SUCH THAT THE END OF THE BOLT IS AT LEAST FLUSH WITH THE FACE OF THE NUT. IT IS NOT PERMITTED FOR THE BOLT END TO BE BELOW THE FACE OF THE NUT AFTER TIGHTENING IS COMPLETED.
- 12. GALVANIZED ASTM A325 BOLTS SHALL NOT BE REUSED.
- 13. ALL NEW STEEL SHALL BE HOT BE DIPPED GALVANIZED FOR FULL WEATHER PROTECTION. CONTRACTOR SHALL OBTAIN WRITTEN PERMISSION TO PROTECT STEEL BY ANY OTHER MEANS.

- 14. ALL EXISTING PAINTED/GALVANIZED SURFACES DAMAGED DURING REHAB INCLUDING AREAS UNDER STIFFENER PLATES SHALL BE WIRE BRUSHED CLEAN, REPAIRED BY COLD GALVANIZING (ZINGA OR ZINC COTE), AND REPAINTED TO MATCH THE EXISTING FINISH (IF APPLICABLE)
- 15. ALL HOLES IN STEEL MEMBERS SHALL BE SIZED 1/16" LARGER THAN THE BOLT DIAMETER. STANDARD HOLES SHALL BE USED UNLESS NOTED OTHERWISE.



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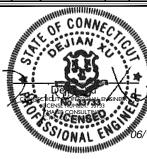
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MT. LAUREL OFFICE

Phone: 856.797.0412 Fax: 856.722.1120

MODIFICATION NOTES

S-2

MODIFICATION INSPECTION NOTES

MI CHECKLIST			
CONSTRUCTION/ INSTALLATIO INSPECTIONS AND TESTING REQUIRED (COMPLETED BY EOI	REPORT ITEM		
PRE-CONSTRUCTION			
X MI CHECKLIST DRAWING			
Х	EOR APPROVED SHOP DRAWINGS		
NA	FABRICATION INSPECTION		
NA	FABRICATOR CERTIFIED WELD INSPECTION		
X	MATERIAL TEST REPORT (MTR)		
NA	FABRICATOR NDE INSPECTION		
X	PACKING SLIPS		
dditional testing and inspec	CTIONS:		
dditional testing and inspec	CTIONS:		
dditional testing and inspec	CONSTRUCTION		
DDITIONAL TESTING AND INSPEC			
	CONSTRUCTION		
X	CONSTRUCTION CONSTRUCTION INSPECTIONS		
X NA	CONSTRUCTION CONSTRUCTION INSPECTIONS CONTRACTOR'S CERTIFIED WELD INSPECTION AND NDE REPORTS		
X NA X	CONSTRUCTION CONSTRUCTION INSPECTIONS CONTRACTOR'S CERTIFIED WELD INSPECTION AND NDE REPORTS ON SITE COLD GALVANIZING VERIFICATION GC AS-BUILT DOCUMENTS		
X NA X X	CONSTRUCTION CONSTRUCTION INSPECTIONS CONTRACTOR'S CERTIFIED WELD INSPECTION AND NDE REPORTS ON SITE COLD GALVANIZING VERIFICATION GC AS-BUILT DOCUMENTS		
X NA X X	CONSTRUCTION CONSTRUCTION INSPECTIONS CONTRACTOR'S CERTIFIED WELD INSPECTION AND NDE REPORTS ON SITE COLD GALVANIZING VERIFICATION GC AS-BUILT DOCUMENTS		
X NA X X	CONSTRUCTION CONSTRUCTION INSPECTIONS CONTRACTOR'S CERTIFIED WELD INSPECTION AND NDE REPORTS ON SITE COLD GALVANIZING VERIFICATION GC AS-BUILT DOCUMENTS CTIONS:		
X NA X X DDITIONAL TESTING AND INSPEC	CONSTRUCTION CONSTRUCTION INSPECTIONS CONTRACTOR'S CERTIFIED WELD INSPECTION AND NDE REPORTS ON SITE COLD GALVANIZING VERIFICATION GC AS-BUILT DOCUMENTS CTIONS: POST-CONSTRUCTION		
X NA X X DDITIONAL TESTING AND INSPEC	CONSTRUCTION CONSTRUCTION INSPECTIONS CONTRACTOR'S CERTIFIED WELD INSPECTION AND NDE REPORTS ON SITE COLD GALVANIZING VERIFICATION GC AS-BUILT DOCUMENTS CTIONS: POST-CONSTRUCTION MI INSPECTOR REDLINE OR RECORD DRAWING(S)		

NOTE: X DENOTES A DOCUMENT REQUIRED FOR THE MI REPORT NA DENOTES A DOCUMENT THAT IS NOT REQUIRED FOR THE MI REPORT THE MODIFICATION INSPECTION (MI) IS A VISUAL INSPECTION OF MODIFICATIONS AND A REVIEW OF CONSTRUCTION INSPECTIONS AND OTHER REPORTS TO ENSURE THE INSTALLATION WAS CONSTRUCTED IN ACCORDANCE WITH THE CONTRACT DOCUMENTS, NAMELY THE MODIFICATION DRAWINGS, AS DESIGNED BY THE ENGINEER OF RECORD (EOR).

THE MI IS TO CONFIRM INSTALLATION CONFIGURATION AND WORKMANSHIP ONLY AND IS NOT A REVIEW OF THE MODIFICATION DESIGN ITSELF, NOR DOES THE MI INSPECTOR TAKE OWNERSHIP OF THE MODIFICATION DESIGN. OWNERSHIP OF THE STRUCTURAL MODIFICATION DESIGN EFFECTIVENESS AND INTEGRITY RESIDES WITH THE EOR AT ALL TIMES.

TO ENSURE THAT THE REQUIREMENTS OF THE MI ARE MET, IT IS VITAL THAT THE GENERAL CONTRACTOR (GC) AND THE MI INSPECTOR BEGIN COMMUNICATING AND COORDINATING AS SOON AS A PURCHASE ORDER (PO) IS RECEIVED. IT IS EXPECTED THAT EACH PARTY WILL BE PROACTIVE IN REACHING OUT TO THE OTHER PARTY

MI INSPECTOR

THE MI INSPECTOR IS REQUIRED TO CONTACT THE GC AS SOON AS RECEIVING A PO FOR THE MI

- REVIEW THE REQUIREMENTS OF THE MI CHECKLIST
- WORK WITH THE GC TO DEVELOP A SCHEDULE TO CONDUCT ON-SITE INSPECTIONS

THE MI INSPECTOR IS RESPONSIBLE FOR COLLECTING ALL GC INSPECTION AND TEST REPORTS, REVIEWING THE DOCUMENTS FOR ADHERENCE TO THE CONTRACT DOCUMENTS, CONDUCTING THE IN-FIELD INSPECTIONS, AND SUBMITTING THE MI REPORT TO EOR.

GENERAL CONTRACTOR

THE GC IS REQUIRED TO CONTACT THE MI INSPECTOR AS SOON AS RECEIVING A PO FOR THE MODIFICATION INSTALLATION OR TURNKEY PROJECT TO, AT A MINIMUM:

- REVIEW THE REQUIREMENTS OF THE MI CHECKLIST
- WORK WITH THE MI INSPECTOR TO DEVELOP A SCHEDULE TO CONDUCT ON-SITE MI INSPECTIONS, INCLUDING FOUNDATION INSPECTIONS
- BETTER UNDERSTAND ALL INSPECTION AND TESTING REQUIREMENTS

THE GC SHALL PERFORM AND RECORD THE TEST AND INSPECTION RESULTS IN ACCORDANCE WITH THE REQUIREMENTS OF THE MI CHECKLIST.

RECOMMENDATIONS

THE FOLLOWING RECOMMENDATIONS AND SUGGESTIONS ARE OFFERED TO ENHANCE THE EFFICIENCY AND EFFECTIVENESS OF DELIVERING AN MI REPORT:

- IT IS SUGGESTED THAT THE GC PROVIDE A MINIMUM OF 5 BUSINESS DAYS NOTICE. PREFERABLY 10, TO THE MI INSPECTOR AS TO WHEN THE SITE WILL BE READY FOR THE MI
- THE GC AND MI INSPECTOR COORDINATE CLOSELY THROUGHOUT THE ENTIRE PROJECT.
- WHEN POSSIBLE, IT IS PREFERRED TO HAVE THE GC AND MI INSPECTOR ON-SITE SIMULTANEOUSLY FOR ANY GUY WIRE TENSIONING OR RE-TENSIONING OPERATIONS.
- IT MAY BE BENEFICIAL TO INSTALL ALL MODIFICATIONS PRIOR TO CONDUCTING THE FOUNDATION INSPECTIONS TO ALLOW THE FOUNDATION AND MI INSPECTION(S) TO COMMENCE WITH ONE SITE VISIT.
- WHEN POSSIBLE, IT IS PREFERRED TO HAVE THE GC AND MI INSPECTOR ON-SITE DURING THE MI TO HAVE ANY DEFICIENCIES CORRECTED DURING THE INITIAL MI. THEREFORE, THE GC MAY CHOOSE TO COORDINATE THE MI CAREFULLY TO ENSURE ALL CONSTRUCTION FACILITIES ARE AT THEIR DISPOSAL WHEN THE MI INSPECTOR IS ON SITE.

CORRECTION OF FAILING MI'S

IF THE MODIFICATION INSTALLATION WOULD FAIL THE MI ("FAILED MI"), THE GC SHALL WORK WITH THE OWNER TO COORDINATE A REMEDIATION PLAN-


CORRECT FAILING ISSUES TO COMPLY WITH THE SPECIFICATIONS CONTAINED IN THE ORIGINAL CONTRACT DOCUMENTS AND COORDINATE A SUPPLEMENT MI.

REQUIRED PHOTOS

BETWEEN THE GC AND THE MI INSPECTOR THE FOLLOWING PHOTOGRAPHS, AT A MINIMUM, ARE TO BE TAKEN AND INCLUDED IN THE MI REPORT:


- PRE-CONSTRUCTION GENERAL SITE CONDITION
- PHOTOGRAPHS DURING THE REINFORCEMENT MODIFICATION CONSTRUCTION/ERECTION AND INSPECTION
- RAW MATERIALS
- PHOTOS OF ALL CRITICAL DETAILS
- FOUNDATION MODIFICATIONS WELD PREPARATION
- BOLT INSTALLATION
- FINAL INSTALLED CONDITION
- SURFACE COATING REPAIR
 POST CONSTRUCTION PHOTOGRAPHS
- FINAL INFIELD CONDITION

PHOTOS OF ELEVATED MODIFICATIONS TAKEN ONLY FROM THE GROUND SHALL BE CONSIDERED INADEQUATE.

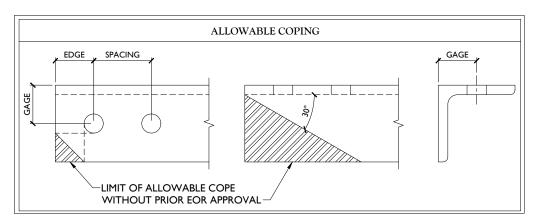

BOLT SCHEDULE (IN.)					
BOLT DIAMETER	STANDARD HOLE	SHORT SLOT	MIN. EDGE DISTANCE	SPACING	
1/2	9/16	9/16 x 11/16	7/8	I I/2	
5/8	11/16	11/16 x 7/8	1 1/8	I 7/8	
3/4	13/16	13/16 x 1	I I/4	2 1/4	
7/8	15/16	15/16 x 1 1/8	1 1/2	2 5/8	
I	1 1/16	1 1/16 x 1 5/16	I 3/4	3	

WORKABLE GAGES (IN.)			
LEG	GAGE		
4	2 1/2		
3 1/2	2		
3	I 3/4		
2 1/2	I 3/8		
2	I I/8		

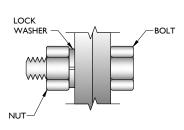

TYP. BOLT ASSEMBLY

- ALL DIMENSIONS REPRESENTED IN THE ABOVE TABLES ARE AISC MINIMUM REQUIREMENTS. CONTRACTOR SHALL VERIFY EXISTING CONDITIONS IN FIELD AND NOTIFY ENGINEER IF DISTANCES ARE LESS THAN THOSE PROVIDED.
- THE DIMENSIONS PROVIDED ARE MINIMUM REQUIREMENTS. ACTUAL DIMENSIONS OF PROPOSED MEMBERS WITHIN THESE DRAWINGS MAY VARY FROM THE AISC MINIMUM REQUIREMENTS.
- 3. SHORT SLOT HOLES SHALL ONLY BE USED WHEN DEPICTED IN THE DRAWINGS
- MATCH EXISTING GAGES WHEN APPLICABLE, UNLESS MINIMUM EDGE DISTANCES ARE COMPROMISED

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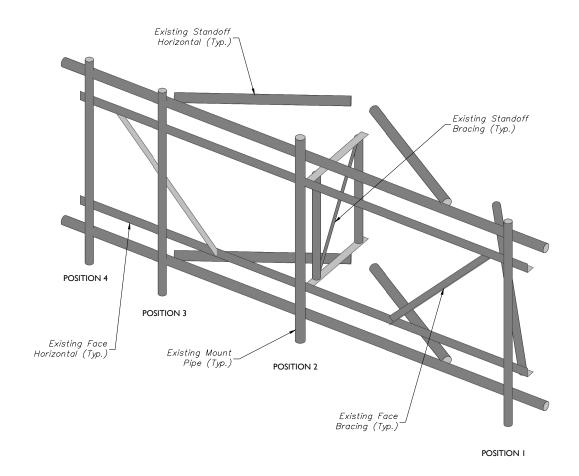



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MODIFICATION NOTES

S-3





1 EXISTING SECTOR FRAME ISOMETRIC VIEW (TYP. ALL SECTORS)

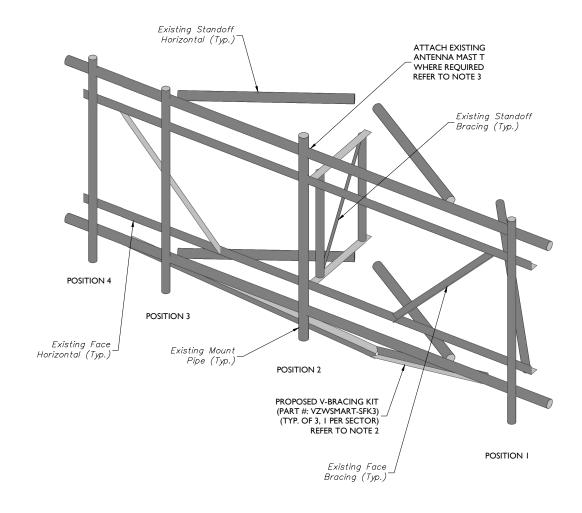STRUCTURAL NOTES:


- PER THE MOUNT MAPPING COMPLETED BY RKS DESIGN & ENGINEERING LLC ON 4/2/2021, THE SAFETY CLIMB AND CLIMBING FACILITIES UP TO THE VERIZON MOUNT ELEVATION (153'-11") ARE IN GOOD CONDITION. MASER DOES NOT WARRANT THIS INFORMATION.
- INSTALL SHALL NOT CAUSE HARM TO THE STRUCTURE, CLIMBING FACILITY, SAFETY CLIMB, OR ANY SYSTEM INSTALLED ON THE STRUCTURE. TIMELY NOTICE AND DOCUMENTATION SHALL BE PROVIDED BY CONTRACTORS TO THE EOR (OF STRUCTURAL DESIGN) IF AN OBSTRUCTION WAS REQUIRED TO MEET THE RF SYSTEM DESIGN REQUIREMENTS AND PERFORMANCES.

PROPOSED SECTOR FRAME ISOMETRIC VIEW (TYP. ALL SECTORS)

MODIFICATION NOTES:

- I. MOUNT MEMBERS NOT SHOWN FOR CLARITY U.N.O.
- 2. CONTRACTOR TO VERIFY THE LENGTH REQUIRED AND TRIM AS NECESSARY IN ACCORDANCE WITH THE 'STRUCTURAL STEEL' NOTES ON SHEET S-2.
- 3. ATTACH EXISTING PIPE FACE HORIZONTALS TO EXISTING POSITION #2 MOUNT PIPE WITH CROSSOVER PLATES (PART #: VZWSMART-MSKI) WHERE MISSING.




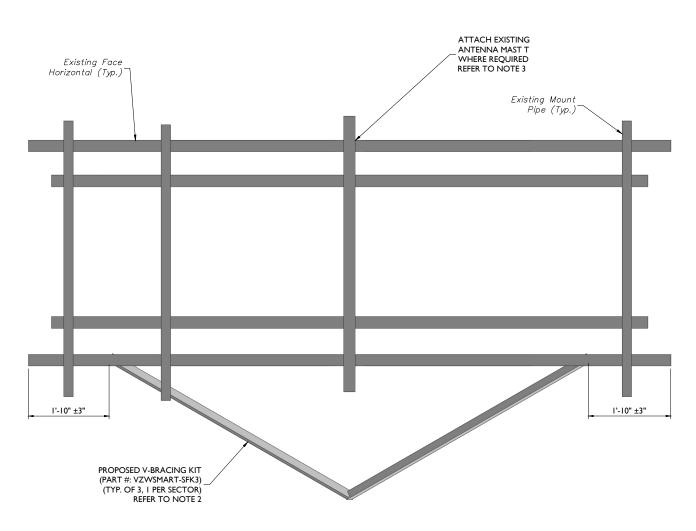


PROPOSED FRONT ELEVATION VIEW (TYP. EACH SECTOR) SCALE: N.T.S.

MODIFICATION NOTES:

- MOUNT MEMBERS NOT SHOWN FOR CLARITY U.N.O.
- CONTRACTOR TO VERIFY THE LENGTH REQUIRED AND TRIM AS NECESSARY IN ACCORDANCE 2. WITH THE 'STRUCTURAL STEEL' NOTES ON SHEET S-2.
- 3. ATTACH EXISTING PIPE FACE HORIZONTALS TO EXISTING POSITION #2 MOUNT PIPE WITH CROSSOVER PLATES (PART #: VZWSMART-MSKI) WHERE MISSING.

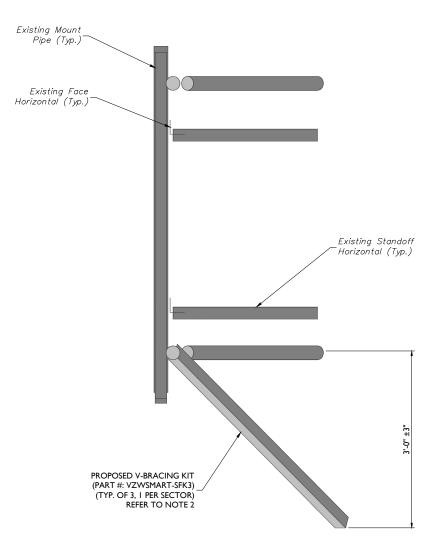

PROPOSED SIDE ELEVATION VIEW (TYP. EACH SECTOR) SCALE : N.T.S.

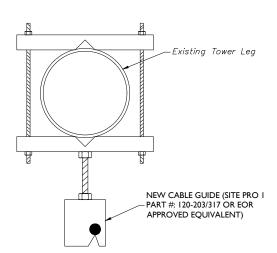

PROPOSED SAFETY CLIMB DETAIL SCALE: N.T.S.

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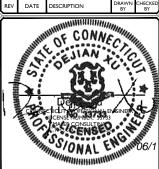
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MODIFICATION DETAILS

S-5



MOUNT PHOTO 1



MOUNT PHOTO 3



MOUNT PHOTO 2




MOUNT PHOTO 4



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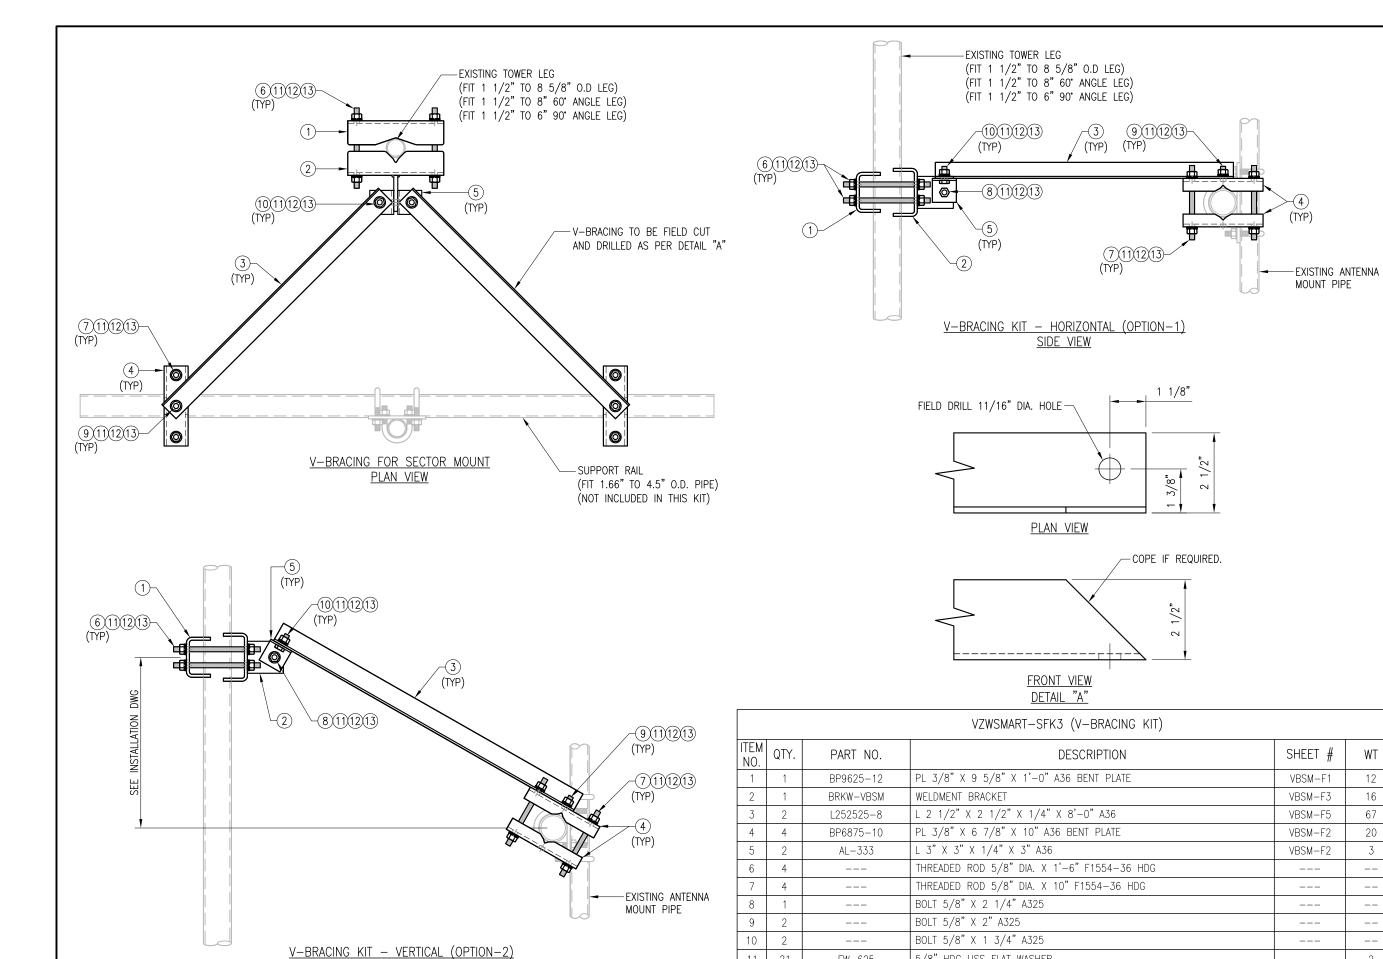
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MOUNT PHOTOS



11

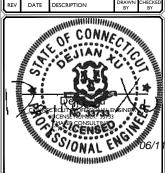12

13

SIDE VIEW

1. HOT-DIPPED GALVANIZED PER ASTM A123.

21

21

21

FW-625

LW-625

NUT-625

VzW**SMART Tool**[©] Vendor

verizon

DRAWN BY: H.R.	CHECKED BY: HMA		
REV. DESCRIPTION	BY DATE		
FIRST ISSUE	H.R. 05/08/20		
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SHEET TITLE:			
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WT

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GALVANIZED WT


5/8" HDG USS FLAT WASHER


5/8" HDG LOCK WASHER

5/8" HDG HEX NUT

VZWSMART-SFK3 V-BRACING KIT

SHEET NUMBER: REV #: VZWSMART-SFK3

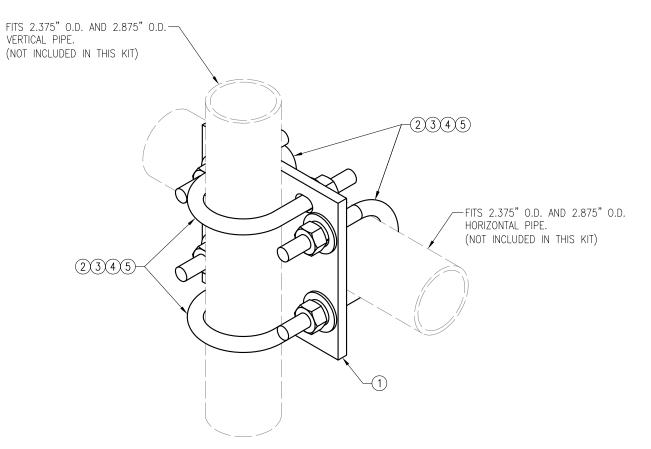

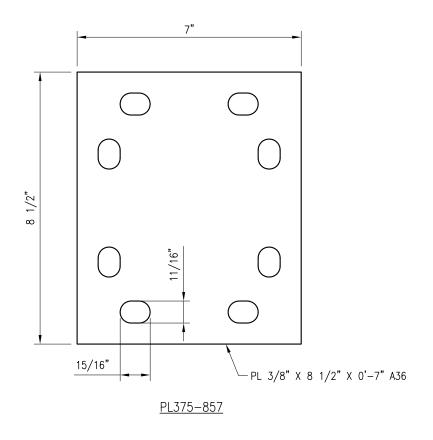

VZWSMART-MSK1 (CROSSOVER PLATE)					
ITEM NO.	QTY.	PART NO.	DESCRIPTION	SHEET #	WT
1	1	PL375-857	PL 3/8" X 8 1/2" X 0'-7" A36	MSK1-F1	6
2	4	MS02-625-300-500	RU-BOLT 5/8" X 3" I.W. X 5" I.L. A36 (OR EQUIV.)	RBC-1	5
3	8	FW-625	5/8" HDG USS FLAT WASHER		1
4	8	LW-625	5/8" HDG LOCK WASHER		0
5	8	NUT-625	5/8" HDG HEX NUT		1
GALVANIZED WT					14

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REV. DESCRIPTION	BY DATE		
FIRST ISSUE	H.R 05/08/20		
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SHEET TITLE:			

VZWSMART-MSK1 CROSSOVER PLATE

SHEET NUMBER: REV #:

VZWSMART-MSK1

NOTES:
1. HOT-DIPPED GALVANIZED PER ASTM A123.