

VIA ELECTRONIC MAIL

March 29, 2023

Jack Andrews Centerline Communications 10130 Donleigh Drive Columbia, MD 21046 jmandrews@clinellc.com

RE: **EM-AT&T-015-230316** - AT&T notice of intent to modify an existing telecommunications facility located at 1000 Trumbull Avenue (a/k/a 1320 Chopsey Hill Road), Bridgeport, Connecticut.

Dear Jack Andrews:

The Connecticut Siting Council (Council) is in receipt of your correspondence of March 29, 2023 submitted in response to the Council's March 24, 2023 notification of an incomplete request for exempt modification with regard to the above-referenced matter.

The submission renders the request for exempt modification complete and the Council will process the request in accordance with the Federal Communications Commission 60-day timeframe.

Thank you for your attention and cooperation.

Sincerely,

Melanie Bachman Executive Director

MAB/ANM/laf

-----Original Message-----

From: John Andrews <jmandrews@clinellc.com> Sent: Wednesday, March 29, 2023 1:25 PM To: CSC-DL Siting Council <Siting.Council@ct.gov>; Fontaine, Lisa <Lisa.Fontaine@ct.gov> Cc: Stephen Smith <slsmith@clinellc.com>; Blake.Paynter@AmericanTower.com Subject: EM-AT&T-015-230316 - AT&T notice of intent to modify 1000 Trumbull Avenue (a/k/a 1320 Chopsey Hill Road), Bridgeport, Site #14178890

Dear CSC:

Attached are a set of Revised Drawings incorporating the correct Code Year, and a signed cover letter. Three (3) sets of hard copies will be overnighted to you this afternoon.

Thank you for your kind attention to this matter.

Thanks, J

John Andrews Jr. | Project Manager 10130 Donleigh Drive, Columbia, MD 21046 Centerline Communications 750 W Center St, Suite 301 | West Bridgewater, MA 02379 Mobile: 443.677.0144 jmandrews@clinellc.com | https://gcc02.safelinks.protection.outlook.com/?url=https://sa4x2P%2Fwvww.centerlinecommunications.com%2F&data=05%7C01%7CLisa.Fontaine%40ct.gov%7C293899165ab94746aa4508db307a9386%7C118b7cfaa3dd48b9b0263 1f69bb738b%7C0%7C0%7C0%7C0%7C9%7C9%7C9%7C9%7C%7C%3c8adta=cj549%2F019GiVMaHUzyhda7pxcuG RHFeigt92UImgl(X3D&reserved=0



March 29, 2023

Melanie A. Bachman Executive Director Connecticut Siting Council 10 Franklin Square New Britain, CT 06051

RE: EM-AT&T-015-230316 - AT&T notice of intent to modify an existing telecommunications facility located at 1000 Trumbull Avenue (a/k/a 1320 Chopsey Hill Road), Bridgeport, Connecticut

Dear Ms. Bachman,

I am in receipt of your letter dated March 24, 2023, advising the Code Year must be revised on the drawings. Accordingly, enclosed please find three (3) sets of revised drawings dated 3/29/23 incorporating the 2022 Connecticut State Building Code.

I trust that you will find the new drawings satisfactory. An electronic copy of the revisions and this letter will be emailed to the Council today.


As always, please feel free to contact me with any questions or comments.

Thank you for your kind attention to this matter.

Sincerely,

Jack Andrews

Zoning Manager, Centerline Communications 10130 Donleigh Drive Columbia, MD 21046 443-677-0144

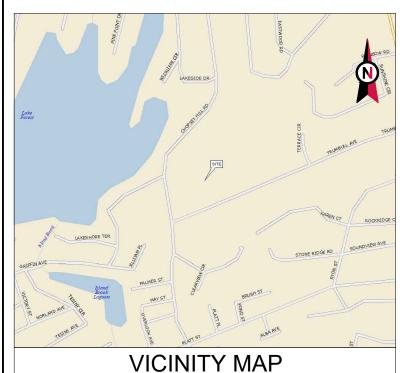

AMERICAN TOWER®


ATC SITE NAME: TARTAGLIA ATC SITE NUMBER: 383598 AT&T MOBILITY PACE NUMBERS: MRCTB057463 (SPLIT SECTOR - LTE) AT&T MOBILITY SITE ID: CTL05093 AT&T MOBILITY FA CODE: 10070948 AT&T MOBILITY SITE NAME: BRIDGEPORT BEARDSLEY SITE ADDRESS: 1000 TRUMBULL AVE BRIDGEPORT, CT 06606



LOCATION MAP

AT&T MOBILITY ANTENNA AMENDMENT PLAN

COMPLIANCE CODE	PROJECT DESCRIPTION		SHEET INDEX				
ALL WORK SHALL BE PERFORMED AND MATERIALS INSTALLED IN ACCORDANCE WITH THE CURRENT EDITIONS OF THE	SITE ADDRESS:	THE PROPOSED PROJECT INCLUDES MODIFYING GROUND BASED AND TOWER MOUNTED EQUIPMENT AS INDICATED PER BELOW:	SHEET NO:	DESCRIPTION:	REV:	DATE:	BY:
FOLLOWING CODES AS ADOPTED BY THE LOCAL GOVERNMENT AUTHORITIES. NOTHING IN THESE PLANS IS	1000 TRUMBULL AVE BRIDGEPORT, CT 06606	TOWER WORK: REMOVE (1) ANTENNA, AND (2) RRU(s).	G-001	TITLE SHEET	1	03/29/23	TR
TO BE CONSTRUED TO PERMIT WORK NOT CONFORMING TO THESE CODES.	COUNTY: FAIRFIELD	INSTALL (1) ANTENNA, (4) RRU(s), (1) DC6, (6) DIPLEXER(s), (4) Y-CABLE(s), (3) 0.92" DC TRUNK(s), AND (1) 0.41" FIBER TRUNK.	G-002	GENERAL NOTES	1	03/29/23	TR
1. 2022 CONNECTICUT STATE BUILDING CODE (CSBC)	GEOGRAPHIC COORDINATES:	DINATES: EXISTING (11) ANTENNA(s), (13) RRU(s), (3) Y-CABLE(s), (1) DC9, (2) DC6(s) (6) 1-5(8" COAX CABLE(s) (4) 0.92" DC TRUNK(s) AND	C-101	DETAILED SITE PLAN	1	03/29/23	TR
2. 2017 NATIONAL ELECTRIC CODE (NEC 2017) 3. LOCAL BUILDING CODE	LATITUDE: 41.21958		C-201	TOWER ELEVATION	1	03/29/23	TR
4. CITY/COUNTY ORDINANCES	LONGITUDE: -73.20131	GROUND WORK:	C-401	ANTENNA INSTALLATION	1	03/29/23	TR
PROJECT TEAM	GROUND ELEVATION: 212' AMSL ZONING INFORMATION:	EXISTING (3) RRU(s) TO REMAIN IN EXISTING SHELTER. INSTALL (1) 6675 IN EXISTING SHELTER.	C-402	ANTENNA SCHEDULE	1	03/29/23	TR
	JURISDICTION: CITY OF BRIDGEPORT		C-501	CONSTRUCTION DETAILS	1	03/29/23	TR
	APPLICANT: PARCEL ID: 2778-61B	E-101	GROUNDING DETAILS	1	03/29/23	TR	
10 PRESIDENTIAL WAY			R-601	SUPPLEMENTAL			
WOBURN, MA 01801 ENGINEER: PROPERTY OWNER:		NOTE: THIS CONSTRUCTION DRAWING SET IS NOT INTENDED TO REPRESENT ANY ELECTRICAL DESIGN OTHER THAN THE	R-602	SUPPLEMENTAL			
TOWER ENGINEERING CELL TOWER LEASE		REPRESENT ANY ELECTRICAL DESIGN OTHER THAN THE GROUNDING SHOWN, OR TO BE USED TO OBTAIN AN ELECTRICAL PERMIT. AN ELECTRICAL PERMIT IS REQUIRED TO WIRE UP THE	R-603	SUPPLEMENTAL			
PROFESSIONALS ACQUISITION LLC 326 TRYON RD 92 THOMAS JOHNSON DR		PROPOSED EQUIPMENT. ANY ELECTRICAL UPGRADES WILL BE ENGINEERED AND PERMITTED IN A SEPARATE CONSTRUCTION	R-604	SUPPLEMENTAL			
RALEIGH, NC 27603 FREDERICK, MD 21702		DRAWING SET.	R-605	SUPPLEMENTAL			
UTILITY COMPANIES	PROJECT LOCATION DIRECTIONS	PROJECT NOTES	R-606	SUPPLEMENTAL			
POWER COMPANY: UNITED ILLUMINATING COMPANY PHONE: (800) 722-5584	FROM DOWNTOWN NEW HAVEN CT START OUT GOING	 THE FACILITY IS UNMANNED. A TECHNICIAN WILL VISIT THE SITE APPROXIMATELY ONCE A 	R-607	SUPPLEMENTAL			
TELEPHONE COMPANY: AT&T	NORTHEAST ON CHURCH ST TOWARD WALL ST. CHURCH ST BECOMES WHITNEY AVE. TURN RIGHT ONTO TRUMBULL ST.	MONTH FOR ROUTINE INSPECTION AND MAINTENANCE. 3. THE PROJECT WILL NOT RESULT IN ANY SIGNIFICANT LAND					
PHONE: (800) 331-0500	TURN SLIGHT LEFT TO TAKE THE I-91 S/I-91 N RAMP. MERGE ONTO I-91 S TOWARD I-95/N.Y.CITY/NEW LONDON. KEEP RIGHT	DISTURBANCE OR EFFECT OF STORM WATER DRAINAGE. 4. NO SANITARY SEWER, POTABLE WATER OR TRASH DISPOSAL					
	TOWARD NY CITY. MERGE ONTO I-95 S VIA THE EXIT ON THE LEFT TOWARD N Y CITY. TAKE EXIT 38 TOWARD	IS REQUIRED. 5. HANDICAP ACCESS IS NOT REQUIRED.					
	CT-15/MERRITT PKWY/W CROSS PKWY. MERGE ONTO MILFORD PKWY. MERGE ONTO MERRITT PARKWAY/CT-15 S VIA EXIT 3B	6. THE PROJECT DEPICTED IN THESE PLANS QUALIFIES AS AN ELIGIBLE FACILITIES REQUEST ENTITLED TO EXPEDITED					
	ON THE LEFT TOWARD NY CITY. MERGE ONTO CT-8 S VIA EXIT 52 TOWARD BRIDGEPORT. TAKE THE CT-127/WHITE PLAINS	REVIEW UNDER 47 U.S.C. § 1455(A) AS A MODIFICATION OF AN EXISTING WIRELESS TOWER THAT INVOLVES THE					
	ROAD EXIT, EXIT 7. TURN SLIGHT LEFT ONTO OLD TOWN RD. OLD TOWN RD BECOMES TRUMBULL AVE. TURN RIGHT ONTO	COLLOCATION, REMOVAL, AND/OR REPLACEMENT OF TRANSMISSION EQUIPMENT THAT IS NOT A SUBSTANTIAL					
Know what's below. Call before you dig.	CHOPSEY HILL RD. 1336 CHOPSEY HILL RD, BRIDGEPORT, CT 06606-2422, 1336 CHOPSEY HILL RD IS ON THE RIGHT. DRIVE	CHANGE UNDER CFR § 1.61000 (B)(7).					
	BETWEEN HOUSES TO TOWER SITE						

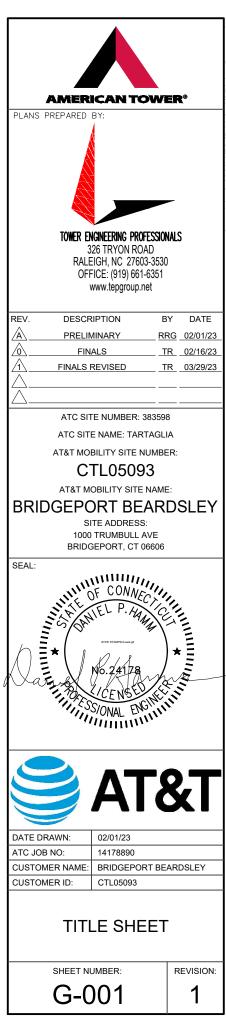

GENERAL CONSTRUCTION NOTES:

- OWNER FURNISHED MATERIALS, AT&T MOBILITY "THE COMPANY" WILL PROVIDE AND THE 22. CONTRACTOR WILL INSTALL
 - A. BTS EQUIPMENT FRAME (PLATFORM) AND ICEBRIDGE SHELTER (GROUND BUILD/CO-LOCATE ONLY) AC/TELCO INTERFACE BOX (PPC)
 - C. ICE BRIDGE (CABLE TRAY WITH COVER) (GROUND BUILD/CO-LOCATE ONLY, GC TO FURNISH AND INSTALL FOR ROOFTOP INSTALLATION)
 - D. TOWERS, MONOPOLES
 - TOWER LIGHTING
 - GENERATORS & LIQUID PROPANE TANK
 - ANTENNA STANDARD BRACKETS, FRAMES AND PIPES FOR MOUNTING ANTENNAS (INSTALLED BY OTHERS)
 - TRANSMISSION LINE
 - TRANSMISSION LINE JUMPERS
 - TRANSMISSION LINE CONNECTORS WITH WEATHERPROOFING KITS
 - TRANSMISSION LINE GROUND KITS
 - HANGERS
 - HOISTING GRIPS O. BTS EQUIPMENT
- THE CONTRACTOR IS RESPONSIBLE TO PROVIDE ALL OTHER MATERIALS FOR THE COMPLETE INSTALLATION OF THE SITE INCLUDING, BUT NOT LIMITED TO, SUCH MATERIALS AS FENCING, STRUCTURAL STEEL SUPPORTING SUB-FRAME FOR PLATFORM ROOFING LABOR AND MATERIALS, GROUNDING RINGS, GROUNDING WIRES COPPER-CLAD OR XIT CHEMICAL GROUND ROD(S), BUSS BARS, TRANSFORMERS AND DISCONNECT SWITCHES WHERE APPLICABLE, TEMPORARY ELECTRICAL POWER, CONDUIT, LANDSCAPING COMPOUND STONE, CRANES, CORE DRILLING, SLEEPERS AND RUBBER MATTING, REBAR, CONCRETE CAISSONS, PADS AND/OR AUGER MOUNTS, MISCELLANEOUS FASTENERS, CABLE TRAYS, NON-STANDARD ANTENNA FRAMES AND ALL OTHER MATERIAL AND LABOR REQUIRED TO COMPLETE THE JOB ACCORDING TO THE DRAWINGS AND SPECIFICATIONS. IT IS THE POSITION OF AT&T MOBILITY TO APPLY FOR PERMITTING AND CONTRACTOR RESPONSIBLE FOR PICKUP AND PAYMENT OF REQUIRED PERMITS.
- ALL WORK SHALL CONFORM TO ALL CURRENT APPLICABLE FEDERAL, STATE, AND LOCAL CODES, INCLUDING ANSI/EIA/TIA-222, AND COMPLY WITH ATC CONSTRUCTION SPECIFICATIONS
- CONTRACTOR SHALL CONTACT LOCAL 811 FOR IDENTIFICATION OF UNDERGROUND UTILITIES PRIOR TO START OF CONSTRUCTION
- CONTRACTOR SHALL BE RESPONSIBLE FOR COORDINATING ALL REQUIRED INSPECTIONS.
- ALL DIMENSIONS TO, OF, AND ON EXISTING BUILDINGS, DRAINAGE STRUCTURES, AND SITE IMPROVEMENTS SHALL BE VERIFIED IN FIELD BY CONTRACTOR WITH ALL DISCREPANCIES REPORTED TO THE ENGINEER.
- DO NOT CHANGE SIZE OR SPACING OF STRUCTURAL ELEMENTS 7
- DETAILS SHOWN ARE TYPICAL; SIMILAR DETAILS APPLY TO SIMILAR CONDITIONS UNLESS 32. 8
- THESE DRAWINGS DO NOT INCLUDE NECESSARY COMPONENTS FOR CONSTRUCTION 9. SAFETY WHICH SHALL BE THE SOLE RESPONSIBILITY OF THE CONTRACTOR
- CONTRACTOR SHALL BRACE STRUCTURES UNTIL ALL STRUCTURAL ELEMENTS NEEDED 33. 10. FOR STABILITY ARE INSTALLED. THESE ELEMENTS ARE AS FOLLOWS: LATERAL BRACING, ANCHOR BOLTS, ETC.
- CONTRACTOR SHALL DETERMINE EXACT LOCATION OF EXISTING UTILITIES. GROUNDS 11. DRAINS, DRAIN PIPES, VENTS, ETC, BEFORE COMMENCING WORK
- INCORRECTLY FABRICATED, DAMAGED, OR OTHERWISE MISFITTING OR NONCONFORMING MATERIALS OR CONDITIONS SHALL BE REPORTED TO THE AT&T MOBILITY REP PRIOR TO REMEDIAL OR CORRECTIVE ACTION. ANY SUCH REMEDIAL 12. ACTION SHALL REQUIRE WRITTEN APPROVAL BY THE AT&T MOBILITY REP PRIOR TO PROCEEDING
- EACH CONTRACTOR SHALL COOPERATE WITH THE AT&T MOBILITY REP, AND 13. ORDINATE HIS WORK WITH THE WORK OF OTHERS
- CONTRACTOR SHALL REPAIR ANY DAMAGE CAUSED BY CONSTRUCTION OF THIS PROJECT TO MATCH EXISTING PRE-CONSTRUCTION CONDITIONS TO THE SATISFACTION 14. OF THE AT&T MOBILITY CONSTRUCTION MANAGER
- 15. ALL CABLE/CONDUIT ENTRY/EXIT PORTS SHALL BE WEATHERPROOFED DURING INSTALLATION USING A SILICONE SEALANT.
- WHERE EXISTING CONDITIONS DO NOT MATCH THOSE SHOWN IN THIS PLAN SET, 16. CONTRACTOR SHALL NOTIFY THE AT&T MOBILITY REP AND ENGINEER OF RECORD
- CONTRACTOR SHALL ENSURE ALL SUBCONTRACTORS ARE PROVIDED WITH A COMPLETE AND CURRENT SET OF DRAWINGS AND SPECIFICATIONS FOR THIS PROJECT. 17.
- CONTRACTOR SHALL REMOVE ALL RUBBISH AND DEBRIS FROM THE SITE AT THE END OF 18. FACH DAY
- CONTRACTOR SHALL COORDINATE WORK SCHEDULE WITH AMERICAN TOWER CORPORATION (ATC) AND TAKE PRECAUTIONS TO MINIMIZE IMPACT AND DISRUPTION OF 19. OTHER OCCUPANTS OF THE FACILITY.
- CONTRACTOR SHALL FURNISH AT&T MOBILITY AND AMERICAN TOWER CORPORATION 20. (ATC) WITH A PDF MARKED UP AS-BUILT SET OF DRAWINGS UPON COMPLETION OF WORK
- PRIOR TO SUBMISSION OF BID, CONTRACTOR SHALL COORDINATE WITH AT&T MOBILITY 21. REP TO DETERMINE WHAT, IF ANY, ITEMS WILL BE PROVIDED. ALL ITEMS NOT PROVIDED SHALL BE PROVIDED AND INSTALLED BY THE CONTRACTOR. CONTRACTOR WILL INSTALL

ALL ITEMS PROVIDED.

24.

31

- PRIOR TO SUBMISSION OF BID. CONTRACTOR SHALL COORDINATE WITH AT&T MOBILITY 3 REP TO DETERMINE IF ANY PERMITS WILL BE OBTAINED BY CONTRACTOR. ALL REQUIRED PERMITS NOT OBTAINED BY AT&T MOBILITY MUST BE OBTAINED, AND PAID FOR, BY THE CONTRACTOR
- 23. CONTRACTOR SHALL INSTALL ALL SITE SIGNAGE IN ACCORDANCE WITH AT&T MOBILITY SPECIFICATIONS AND REQUIREMENTS
- CONTRACTOR SHALL SUBMIT ALL SHOP DRAWINGS TO AT&T MOBILITY FOR REVIEW AND APPROVAL PRIOR TO FABRICATION.
- 25. ALL EQUIPMENT SHALL BE INSTALLED ACCORDING TO MANUFACTURER'S SPECIFICATIONS AND LOCATED ACCORDING TO AT&T MOBILITY SPECIFICATIONS, AND AS SHOWN IN THESE PLANS.
- THE CONTRACTOR SHALL SUPERVISE AND DIRECT THE PROJECT DESCRIBED HEREIN. 26. THE CONTRACTOR SHALL BE SOLELY RESPONSIBLE FOR ALL THE CONSTRUCTION MEANS, METHODS, TECHNIQUES, SEQUENCES AND PROCEDURES AND FOR COORDINATING ALL PORTIONS OF THE WORK UNDER THE CONTRACT.
- CONTRACTOR SHALL NOTICY AT&T MOBILITY, REP & MINIMUM OF 48 HOURS IN ADVANCE 27. OF POURING CONCRETE OR BACKFILLING ANY UNDERGOUND UTILITIES, FOUNDATIONS OR SEALING ANY WALL, FLOOR OR ROOF PENETRATIONS FOR ENGINEERING REVIEW
- CONTRACTOR SHALL BE RESPONSIBLE FOR SITE SAFETY INCLUDING COMPLIANCE WITH ALL APPLICABLE OSHA STANDARDS AND RECOMMENDATIONS AND SHALL PROVIDE ALL NECESSARY SAFETY DEVICES INCLUDING PPE AND PPM AND CONSTRUCTION DEVICES 28. SUCH AS WELDING AND FIRE PREVENTION, TEMPORARY SHORING, SCAFFOLDING, TRENCH BOXES/SLOPING, BARRIERS, ETC.
- THE CONTRACTOR SHALL PROTECT AT HIS OWN EXPENSE, ALL EXISTING FACILITIES AND 29. SUCH OF HIS NEW WORK LIABLE TO INJURY DURING THE CONSTRUCTION PERIOD. ANY DAMAGE CAUSED BY NEGLECT ON THE PART OF THIS CONTRACTOR OR HIS REPRESENTATIVES, OR BY THE ELEMENTS DUE TO NEGLECT ON THE PART OF THIS CONTRACTOR OR HIS REPRESENTATIVES, FITHER TO THE EXISTING WORK, OR TO HIS WORK OR THE WORK OF ANY OTHER CONTRACTOR, SHALL BE REPAIRED AT HIS EXPENSE TO THE OWNER'S SATISFACTION.
- 30. ALL WORK SHALL BE INSTALLED IN A FIRST CLASS. NEAT AND WORKMANLIKE MANNER BY MECHANICS SKILLED IN THE TRADE INVOLVED. THE QUALITY OF WORKMANSHIP SHALL BE SUBJECT TO THE APPROVAL OF THE AT&T MOBILITY REP. ANY WORK FOUND BY THE AT&T MOBILITY, REP TO BE OF INFERIOR QUALITY AND/OR WORKMANSHIP SHALL BE REPLACED AND/OR REWORKED AT CONTRACTOR EXPENSE UNTIL APPROVAL IS OBTAINED.
 - IN ORDER TO ESTABLISH STANDARDS OF QUALITY AND PERFORMANCE, ALL TYPES OF MATERIALS LISTED HEREINAETER BY MANUFACTURER'S NAMES AND/OF MANUFACTURER'S CATALOG NUMBER SHALL BE PROVIDED BY THESE MANUFACTURERS AS SPECIFIED
 - AT&T MOBILITY FURNISHED EQUIPMENT SHALL BE PICKED-UP AT THE AT&T MOBILITY WAREHOUSE, NO LATER THAN 48HR AFTER BEING NOTIFIED INSURED, STORED, UNCRATE, PROTECTED AND INSTALLED BY THE CONTRACTOR WITH ALL APPURTENANCES REQUIRED TO PLACE THE EQUIPMENT IN OPERATION. READY FOR USE. THE CONTRACTOR SHALL BE RESPONSIBLE FOR THE EQUIPMENT AFTER PICKING IT
 - AT&T MOBILITY OR HIS ARCHITECT/ENGINEER RESERVES THE RIGHT TO REJECT ANY FOULIPMENT OR MATERIALS WHICH. IN HIS OWN OPINION ARE NOT IN COMPLIANCE WITH THE CONTRACT DOCUMENTS, EITHER BEFORE OR AFTER INSTALLATION AND THE EQUIPMENT SHALL BE REPLACED WITH EQUIPMENT CONFORMING TO THE REQUIREMENTS OF THE CONTRACT DOCUMENTS BY THE CONTRACTOR AT NO COST TO AT&T MOBILITY OR THEIR ARCHITECT/ENGINEER


SPECIAL CONSTRUCTION

ANTENNA INSTALLATION NOTES:


- 1. WORK INCLUDED
 - ANTENNA AND COAXIAL CABLES ARE FURNISHED BY AT&T MOBILITY UNDER A SEPARATE CONTRACT, THE CONTRACTOR SHALL ASSIST ANTENNA INSTALLATION CONTRACTOR IN TERMS OF COORDINATION AND SITE ACCESS. ERECTION SUBCONTRACTOR SHALL BE RESPONSIBLE FOR THE PROTECTION OF PERSONNEL
 - B. INSTALL ANTENNAS AS INDICATED ON DRAWINGS AND AT&T MOBILITY SPECIFICATIONS
 - C. INSTALL GALVANIZED STEEL ANTENNA MOUNTS AS INDICATED ON DRAWINGS.
 - D. INSTALL FURNISHED GALVANIZED STEEL OR ALUMINUM WAVEGUIDE.
 - E. CONTRACTOR SHALL PROVIDE FOUR (4) SETS OF SWEEP TESTS USING ANRITZU-PACKARD 8713B RF SCALAR NETWORK ANALYZER. SUBMIT FREQUENCY DOMAIN REFLECTOMETER(FDR) TESTS RESULTS TO THE PROJECT MANAGER. SWEEP TESTS SHALL BE AS PER ATTACHED RFS "MINIMUM FIELD TESTING RECOMMENDED FOR ANTENNA AND HELIAX COAXIAL CABLE SYSTEMS" DATED 10/5/93. TESTING SHALL BE PERFORMED BY AN INDEPENDENT TESTING SERVICE AND BE BOUND AND SUBMITTED WITHIN ONE WEEK OF WORK COMPLETION.
 - INSTALL COAXIAL CABLES AND TERMINATING BETWEEN ANTENNAS AND EQUIPMENT PER MANUFACTURER'S RECOMMENDATIONS. WEATHERPROOF ALL CONNECTIONS BETWEEN THE ANTENNA AND EQUIPMENT PER MANUFACTURER'S REQUIREMENTS. TERMINATE ALL COAXIAL CABLE THREE (3) FEET IN EXCESS OF ENTRY PORT LOCATION UNLESS OTHERWISE STATED.
 - G. ANTENNA AND COAXIAL CABLE GROUNDING:
 - ALL EXTERIOR #6 GREEN GROUND WIRE "DAISY CHAIN" CONNECTIONS ARE TO BE WEATHER SEALED WITH RES CONNECTORS/SPLICE WEATHERPROOFING KIT #221213 OR


EQUAL


ALL COAXIAL CABLE GROUNDING KITS ARE TO BE INSTALLED ON STRAIGHT RUNS OF COAXIAL CABLE (NOT WITHIN BENDS

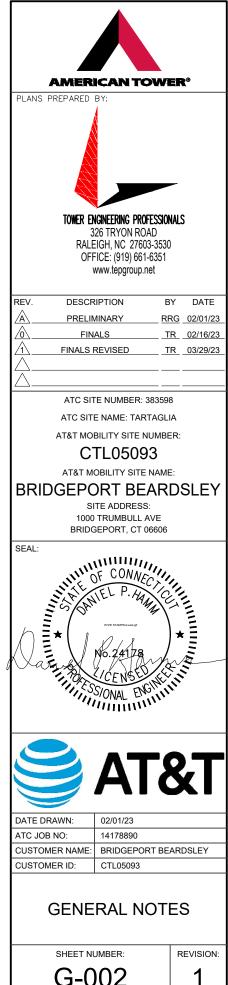

ALL DISCREPANCIES FROM WHAT IS SHOWN ON THESE CONSTRUCTION DRAWINGS SHALL BE COMMUNICATED TO ATC ENGINEERING IMMEDIATELY FOR CORRECTION OR RE-DESIGN. FAILURE TO COMMUNICATE DIRECTLY WITH ATC ENGINEERING OR ANY CHANGES FROM THE DESIGN CONDUCTED WITHOUT PRIOR APPROVAL FROM ATC ENGINEERING SHALL BE THE SOLE RESPONSIBILITY OF THE GENERAL CONTRACTOR.

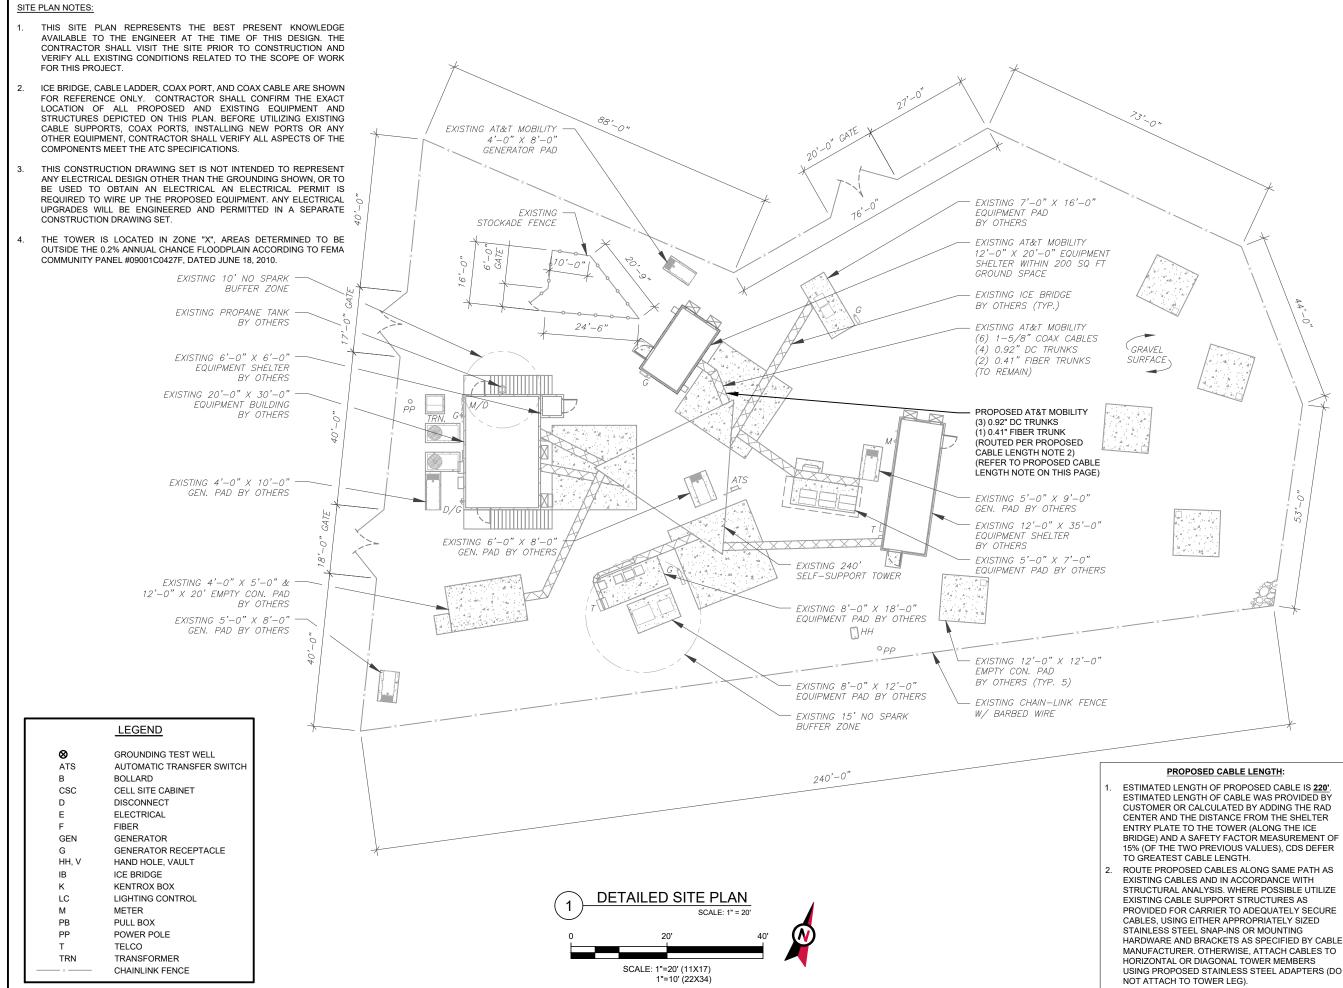

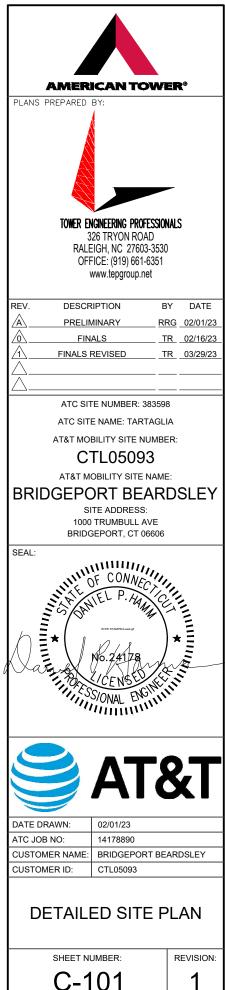

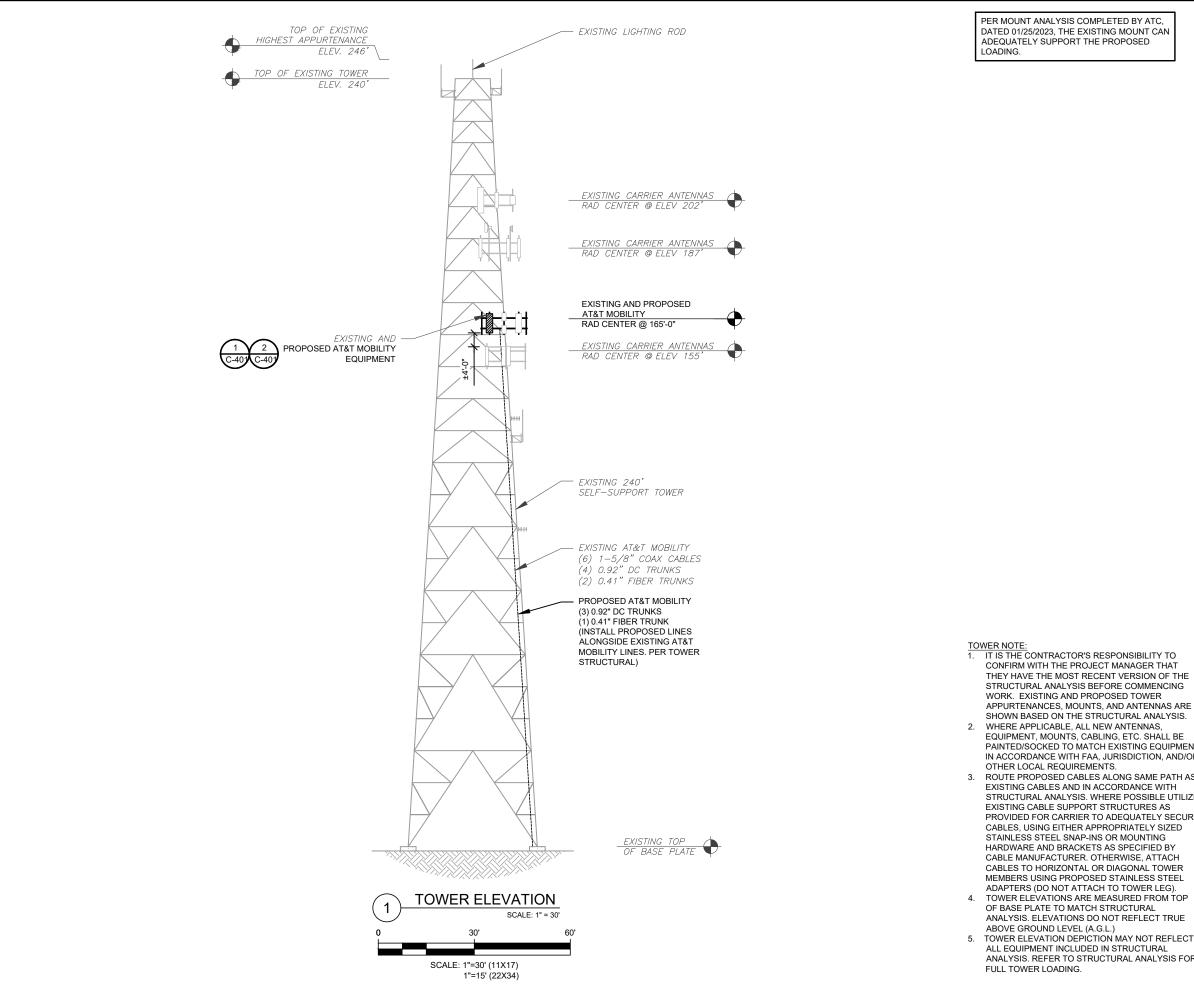



PER MOUNT ANALYSIS COMPLETED BY ATC. DATED 01/25/2023, THE EXISTING MOUNT CAN ADEQUATELY SUPPORT THE PROPOSED

STRUCTURAL ANALYSIS BEFORE COMMENCING WORK. EXISTING AND PROPOSED TOWER APPURTENANCES, MOUNTS, AND ANTENNAS ARE SHOWN BASED ON THE STRUCTURAL ANALYSIS. WHERE APPLICABLE, ALL NEW ANTENNAS, EQUIPMENT, MOUNTS, CABLING, ETC. SHALL BE PAINTED/SOCKED TO MATCH EXISTING EQUIPMENT IN ACCORDANCE WITH FAA, JURISDICTION, AND/OR ROUTE PROPOSED CABLES ALONG SAME PATH AS EXISTING CABLES AND IN ACCORDANCE WITH STRUCTURAL ANALYSIS. WHERE POSSIBLE UTILIZE EXISTING CABLE SUPPORT STRUCTURES AS PROVIDED FOR CARRIER TO ADEQUATELY SECURE CABLES, USING EITHER APPROPRIATELY SIZED STAINLESS STEEL SNAP-INS OR MOUNTING HARDWARE AND BRACKETS AS SPECIFIED BY CABLE MANUFACTURER. OTHERWISE, ATTACH CABLES TO HORIZONTAL OR DIAGONAL TOWER MEMBERS USING PROPOSED STAINLESS STEEL ADAPTERS (DO NOT ATTACH TO TOWER LEG). TOWER ELEVATIONS ARE MEASURED FROM TOP OF BASE PLATE TO MATCH STRUCTURAL ANALYSIS. ELEVATIONS DO NOT REFLECT TRUE

TOWER ELEVATION DEPICTION MAY NOT REFLECT ALL EQUIPMENT INCLUDED IN STRUCTURAL

ANALYSIS. REFER TO STRUCTURAL ANALYSIS FOR

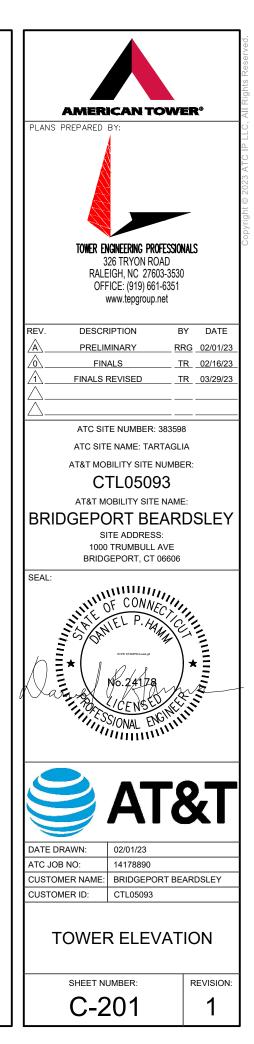


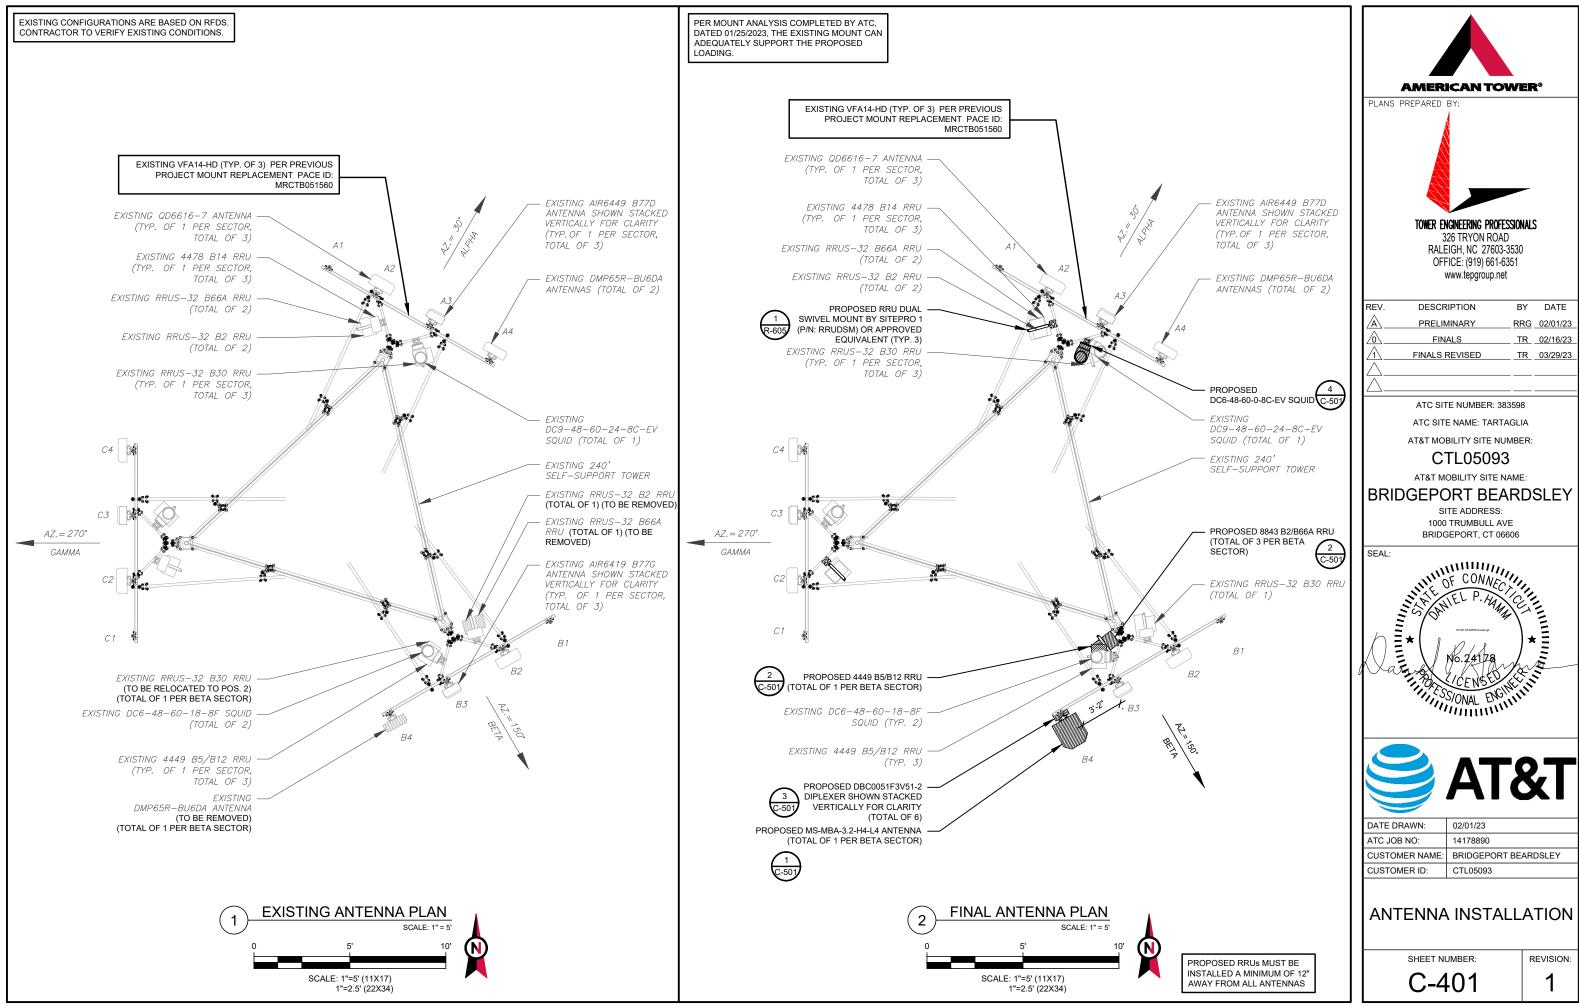



															EINAL					PLANS PREPARED BY: TOWER ENCINEERING PROFESSIONALS 326 TRYON ROAD RALEIGH, NC 27603-3530 OFFICE: (919) 661-6351 www.tepgroup.net
			1			TENNA SCHEDULE				NOTES 1. CONFIRM WITH AT&T MOBILITY	LC	CATION				ANTENNA SCHEDULE		NON ANTENNA SUM	IARY	REV. DESCRIPTION BY DATE
					NTENNA SUMI			ADDITIONAL TOWER		REP FOR APPLICABLE UPDATES/REVISIONS AND MOST	SECTOR	RAD	AZ	POS	ANTENNA	BAND	STATUS	ADDITIONAL TOWER MOUNTED EQUIPMENT	STATUS	A PRELIMINARY RRG 02/01/23 0 FINALS TR 02/16/23
SECTOR	RAD	AZ	POS	ANTENNA		BAND	STATUS	MOUNTED EQUIPMENT	STATUS	RECENT RFDS FOR NSN CONFIGURATION (CONFIG). GC TO				A1	-	-	-	-	-	
	165'		A1 A2	– QD6616–7		– 700/LTE 1900/ AWS/5G 1900/ 5G AWS		– (1) 4478 B14 (1) RRUS–32 B2 (1) RRUS–32 B66A (1) RRUS–E2 B29	– RMN RMN RMN RMN	CAP ALL UNUSED PORTS. 2. CONFIRM SPACING OF PROPOSED EQUIP DOES NOT CAUSE TOWER CONFLICTS NOR IMPEDE TOWER CLIMBING PEGS. 3. THE ANTENNA ORIENTATION PLAN IS A SCHEMATIC. ATC DID NOT	ALPHA	165'	- 30°	A2 A3	QD6616-7 AIR6419 B77G	LTE 700/LTE 1900/ LTE AWS/5G 1900/ 5G AWS 5G CBAND	RMN RMN	(1) 4478 B14 (1) RRUS–32 B2 (1) RRUS–32 B66A (1) RRUS–E2 B29	RMN RMN RMN RMN	ATC SITE NUMBER: 383598 ATC SITE NAME: TARTAGLIA
ALPHA	167'	30°	A3A	AIR6419 B7.	7G	5G CBAND	RMN	(.)		CONFIRM EXISTING SITE CONDITIONS INCLUDING, BUT NOT		163'		A3	AIR6449 B77D	5G CBAND	RMN	-	-	AT&T MOBILITY SITE NUMBER:
	163'	-	A3B	AIR6449 B7.		5G CBAND	RMN	-	-	LIMITED TO, ANTENNA AZIMUTHS, MOUNT CONFIGURATIONS AND TOWER ORIENTATION. SCALES		165'		A4	DMP65R-BU6DA	LTE 700/5G 850/ LTE WCS	RMN	(1) 4449 B5/B12 (1) RRUS–32 B30 (1) Y–CABLE	RMN RMN RMN	CTL05093 AT&T MOBILITY SITE NAME:
	165'		A4	DMP65R-BU6	6DA LTE	E 700/5G 850/ LTE WCS	RMN	(1) 4449 B5/B12 (1) RRUS–32 B30 (1) Y–CABLE	RMN RMN RMN	SHOWN ARE FOR REFERENCE ONLY AND EXISTING DIMENSIONS ARE APPROXIMATE. THE CONTRACTOR SHALL VERIFY ALL		165'		B1	-	-	-	- (1) 4478 B14	- RMN	BRIDGEPORT BEARDSLEY SITE ADDRESS:
			B1	-		-	_	_	-	EXISTING CONDITIONS PRIOR TO INSTALLATION AND NOTIFY ATC				B2	QD6616-7	LTE 700/LTE WCS	RMN	(1) RRUS–32 B30 (1) RRUS–E2 B29	REL RMN	1000 TRUMBULL AVE
	165'		B2	QD6616—7		700/LTE 1900/ AWS/5G 1900/ 5G AWS		(1) 4478 B14 (1) RRUS-32 B2 (1) RRUS-32 B66A (1) RRUS-E2 B29	RMN RMV RMV RMN	OF ANY DISCREPANCIES. 4. CONTRACTOR TO ENSURE PROPER SEPARATION IN ACCORDANCE WITH AT&T'S	BETA	167' 163'	150°	B3 B3	AIR6419 B77G AIR6449 B77D	5G CBAND 5G CBAND	RMN RMN	- (1) 4449 B5/B12	- RMN	BRIDGEPORT, CT 06606 SEAL:
BETA	167' 163'	150°	ВЗА ВЗВ	AIR6419 B7. AIR6449 B7.		5G CBAND 5G CBAND	RMN RMN	_	_	FIRSTNET REQUIREMENTS (SEE SHEET R-607)		165'		B4	MS-MBA-3.2-H4-L4	LTE 700/LTE 1900/ 5G 850/LTE AWS/ 5G AWS/5G 1900	ADD	 (1) Y-CABLE (1) 4449 B5/B12 (3) 8843 B2/B66A (6) DBC0051F3V51-2 	RMN ADD ADD ADD	SHELP HAR CHI
	165'		B4	DMP65R-BU6	6DA LTE	E 700/5G 850/ LTE WCS	RMV	(1) 4449 B5/B12 (1) RRUS–32 B30 (1) Y–CABLE	RMN REL RMN	STATUS ABBREVIATIONS RMV: TO BE REMOVED				C1	-	-	-	(4) Y-CABLES	ADD -	
			C1	_		-	-	- (1) 4478 B14	- RMN	RMN: TO REMAIN REL: TO BE RELOCATED ADD: TO BE ADDED		165'		C2	QD6616-7	LTE 700/LTE 1900/ LTE AWS/5G 1900/ 5G AWS	RMN	(1) 4478 B14 (1) RRUS-32 B2 (1) RRUS-32 B66A (1) RRUS-E2 B29	RMN RMN RMN RMN	NO.24178
	165'		C2	QD6616—7		700/LTE 1900/ AWS/5G 1900/ 5G AWS		(1) RRUS–32 B2 (1) RRUS–32 B66A (1) RRUS–E2 B29	RMN RMN RMN	CABLE LENGTHS FOR JUMPERS	GAMMA	167' 163'	270°	C3 C3	AIR6419 B77G AIR6449 B77D	5G CBAND 5G CBAND	RMN RMN	-	-	SONAL ENGINE
GAMMA	167' 163'	270°	C3A C3B	AIR6419 B7. AIR6449 B7.		5G CBAND 5G CBAND	RMN	_	_	JUNCTION BOX TO RRU: 15' RRU TO ANTENNA: 10'		165'		C4	DMP65R-BU6DA	LTE 700/5G 850/ LTE WCS	RMN	(1) 4449 B5/B12 (1) RRUS–32 B30 (1) Y–CABLE	RMN RMN RMN	
	165'		C4	DMP65R-BU6	1.71	E 700/5G 850/ LTE WCS	RMN	(1) 4449 B5/B12 (1) RRUS–32 B30 (1) Y–CABLE	RMN RMN RMN	l			<u> </u>					(I) I UNDEL		T&TA
	ISTING FI			ON/SQUID STATUS	COAX	EXISTING CABLIN	NG SUMMARY FIBER	STATUS		EQUIPMENT SCHEDU				MOD	FIBER DISTRIBUTION/SC EL NUMBER 3-60-24-8C-EV 48-60-18-8F	DUID STATUS COAX RMN (6) 1–5/		L CABLING SUMMARY DC FIBER 0.92" (2) 0.41"	STATUS	DATE DRAWN: 02/01/23 ATC JOB NO: 14178890 CUSTOMER NAME: BRIDGEPORT BEARDSLEY CUSTOMER ID: CTL05093 ANTENNA SCHEDULE SHEET NUMBER: REVISION: C-402 1

EXISTING FIBER DISTRIBUTIO	DN/SQUID	EXISTING CABLING SUMMARY							
MODEL NUMBER	COAX	DC	FIBER	STATUS					
(1) DC9-48-60-24-8C-EV (2) DC6-48-60-18-8F	RMN	(6) 1–5/8"	(4) 0.92"	(2) 0.41"	RMN				

AL CABLING SUMMARY									
DC	FIBER	STATUS							
0.92"	(2) 0.41"	RMN							
) 0.92"	(1) 0.41"	ADD							

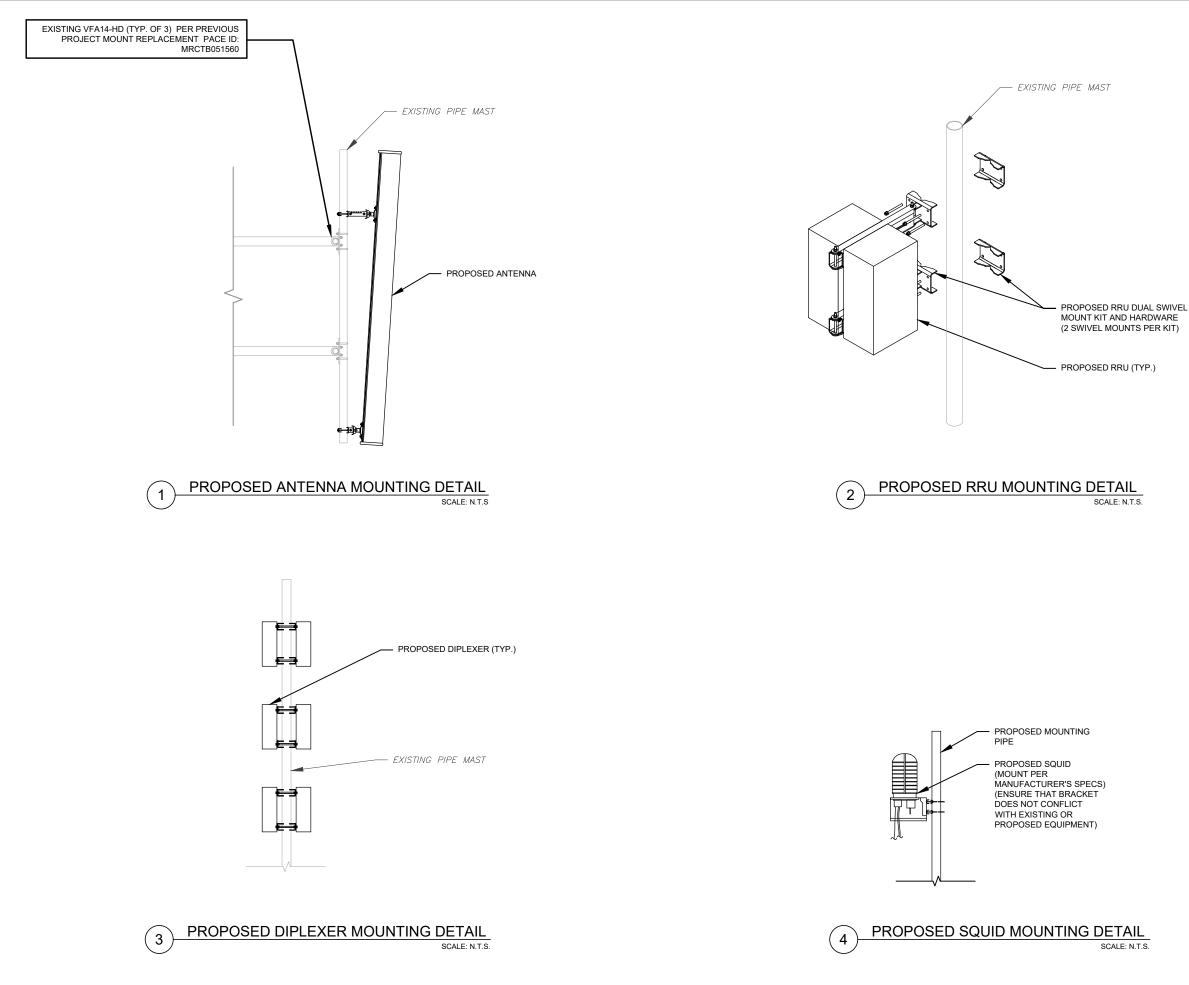


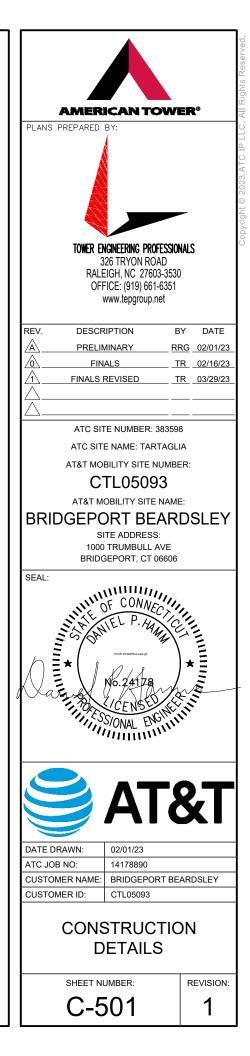


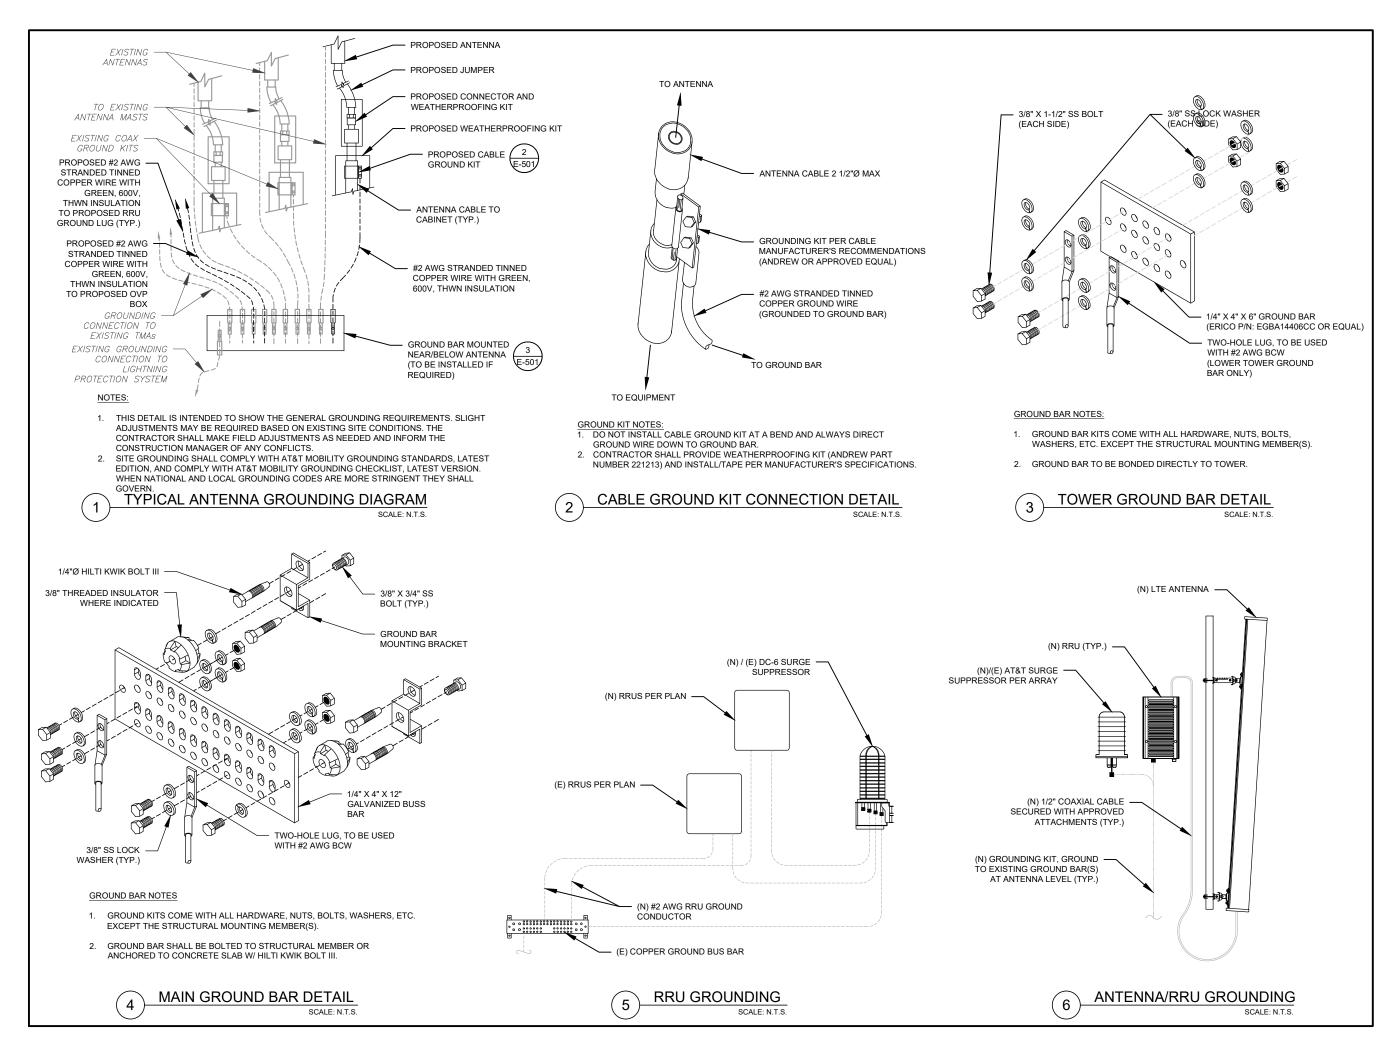



AMERICAN TOWN	ER®
TOWER ENGINEERING PROFESSION 326 TRYON ROAD RALEIGH, NC 27603-3530 OFFICE: (919) 661-6351 www.tepgroup.net	
REV. DESCRIPTION B A PRELIMINARY RF O FINALS T 1 FINALS REVISED T	R 02/16/23
ATC SITE NUMBER: 38359 ATC SITE NAME: TARTAGLI AT&T MOBILITY SITE NUMBE CTL05093	IA
AT&T MOBILITY SITE NAME BRIDGEPORT BEAR SITE ADDRESS: 1000 TRUMBULL AVE BRIDGEPORT, CT 06606	
SEAL: INTEL P. MARCON NO. 74178	
CENSES IN	
	ЪТ
DATE DRAWN: 02/01/23 ATC JOB NO: 14178890 CUSTOMER NAME: BRIDGEPORT BE CUSTOMER ID: CTL05093	ARDSLEY
GROUNDING DET	AILS
SHEET NUMBER: E-501	REVISION:

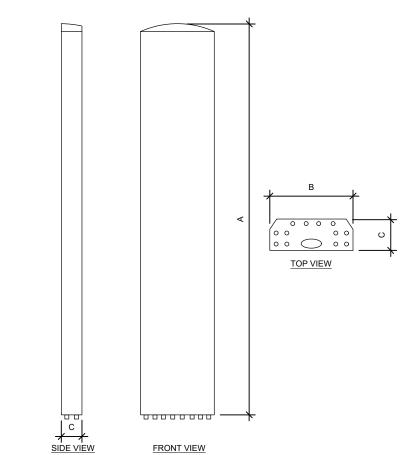

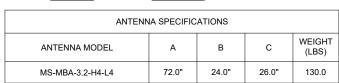


TOP VIEW




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SIDE VIEW

FRONT VIEW

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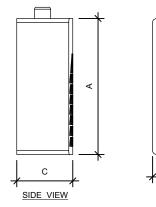
DIPLEXER SPECIFICATIONS										
DIPLEXER MODEL	A	В	С	WEIGHT (LBS)						
DBC0051F3V51-2	8.0"	6.2"	4.4"	12.4						

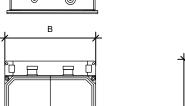
EQUIPMENT SPECIFICATIONS SCALE: N.T.S.

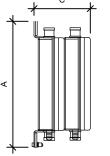(1)





TOP VIEW




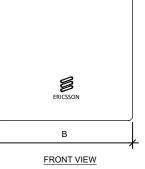


RRU SPECIFICATIONS										
RRU MODEL	A	В	С	WEIGHT (LBS)						
4449 B5/B12	17.9"	13.2"	9.4"	71.0						
8843 B2/B66A	14.9"	13.2"	10.9"	72.0						

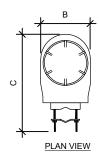


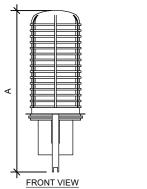

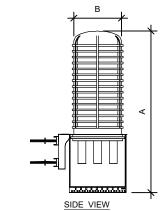


RAYCAP SPECIFICATIONS										
RAYCAP MODEL A B C WEIG (LBS										
DC6-48-60-0-8C-EV	18.3"	10.2"	31.4"	16.0						

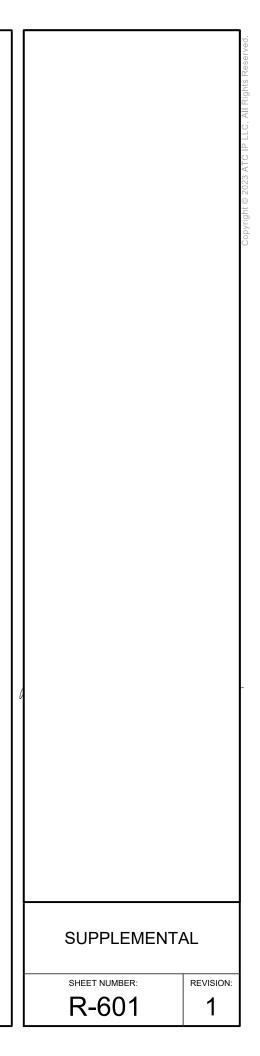


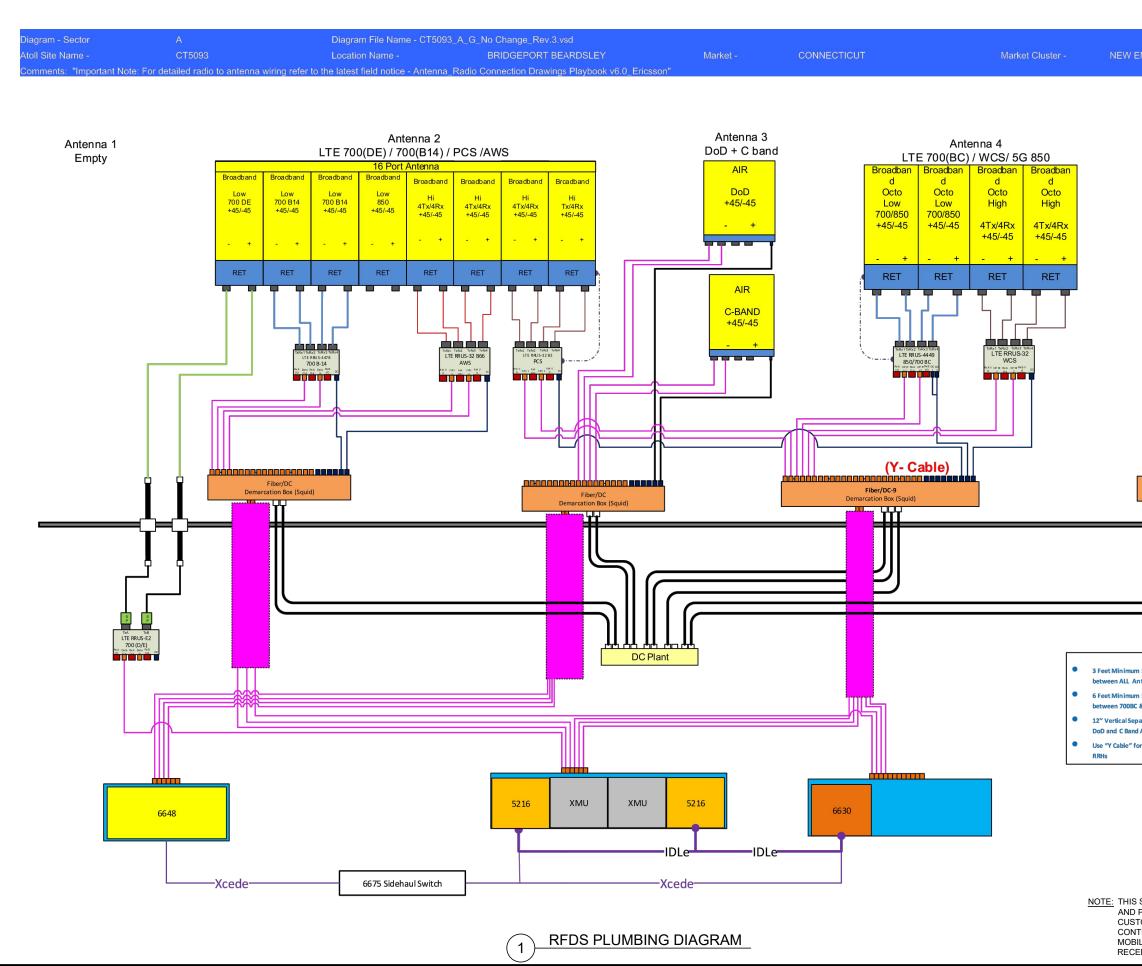


ENGLAND	Copyright © 2023 ATC IP LLC, All Rights Reserved
Antenna 5	Copyright © 2023 A
Dematation Box (Squid Only)	
m Separation Internas m Separation C & 700 DE paration between d Antenna. for D ual band	
S SHEET WAS CREATED BY OTHERS PROVIDED AT THE REQUEST OF THE TOMER WITHOUT EDIT. GENERAL ITRACTOR IS TO CHECK WITH THE AT&T SULTY CM TO ENSURE THIS IS THE MOST ENT VERSION OF THE RFDS.	SUPPLEMENTAL SHEET NUMBER: REVISION: R-602 1

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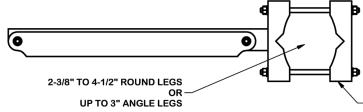


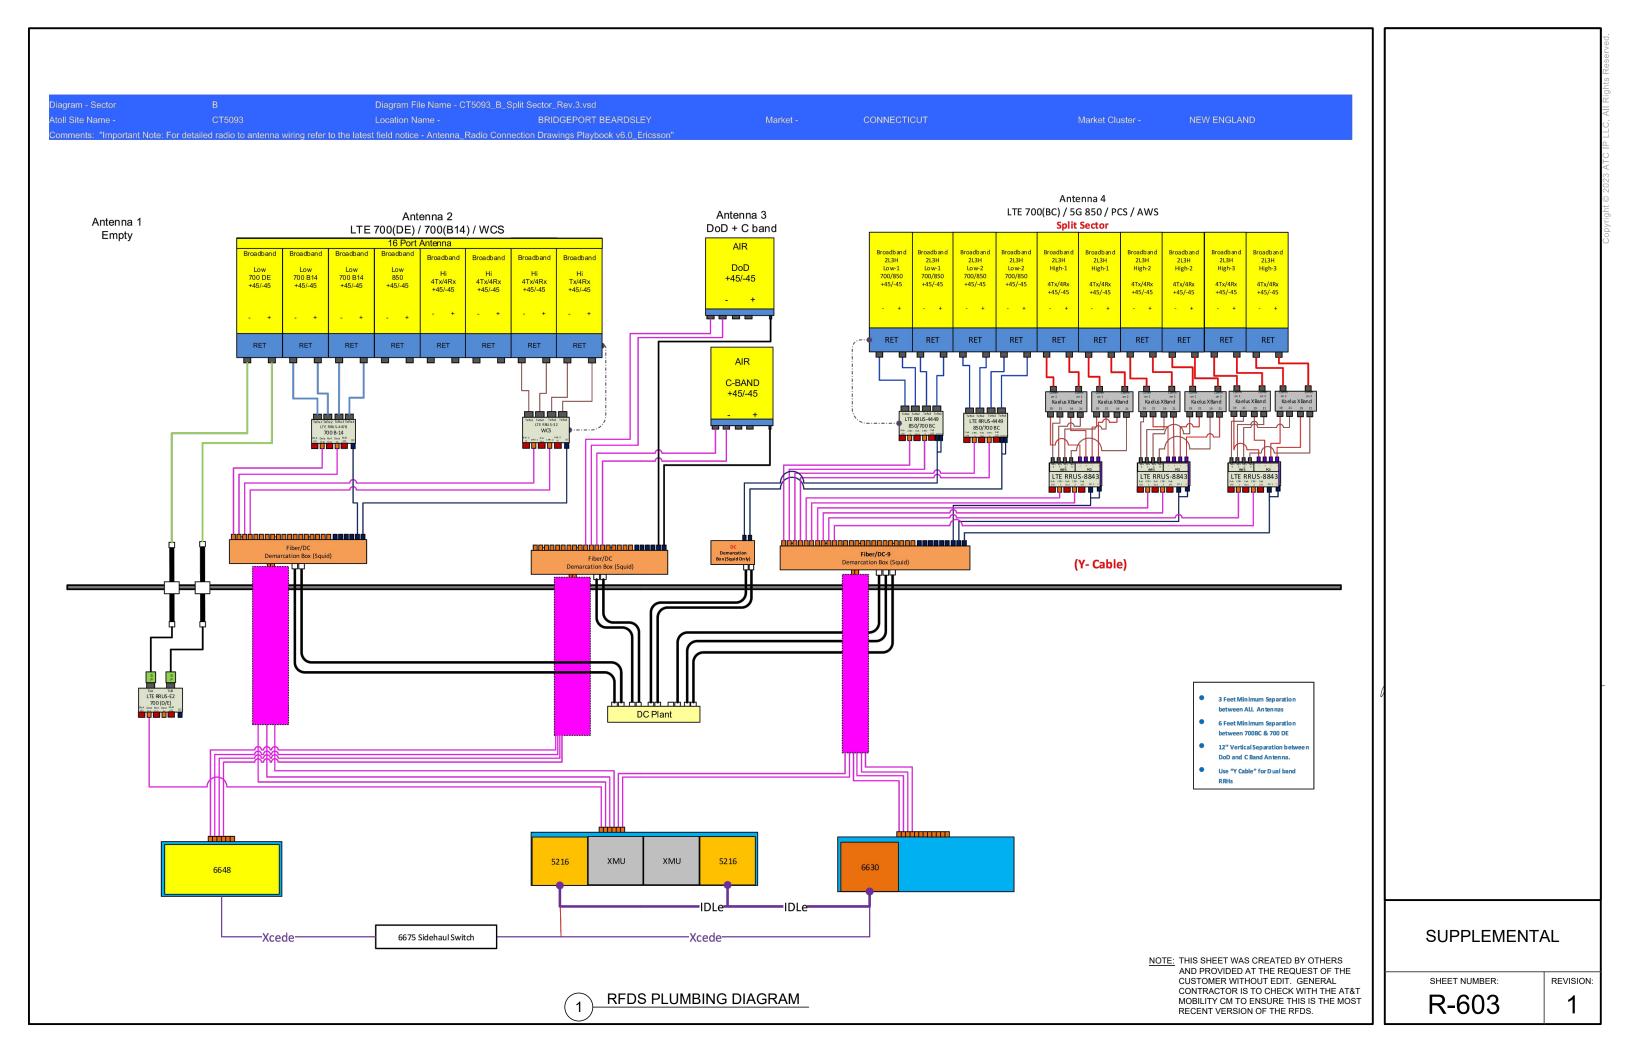


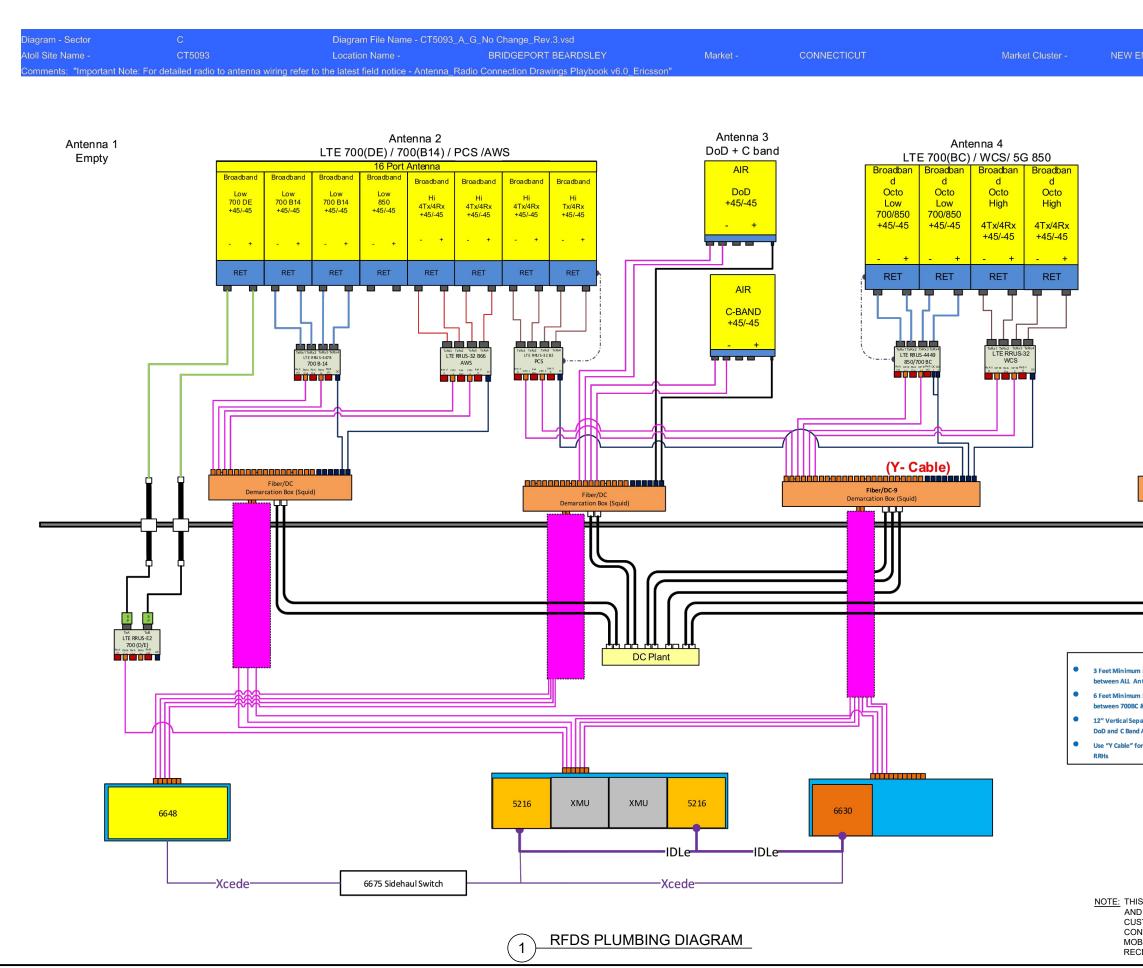
ENGLAND		Copyright © 2023 ATC IP LLC, All Rights Reserved.
Antenna 5		Copyright © 202
C Demarcation Box (Squid Only)		
m Separation Internas m Separation 6 & 700 DE paration between d Antenna. for Dual band		
IS SHEET WAS CREATED BY OTHERS D PROVIDED AT THE REQUEST OF THE STOMER WITHOUT EDIT. GENERAL NTRACTOR IS TO CHECK WITH THE AT&T BILITY CM TO ENSURE THIS IS THE MOST CENT VERSION OF THE RFDS.	SUPPLEMI SHEET NUMBER: R-604	ENTAL REVISION: 1

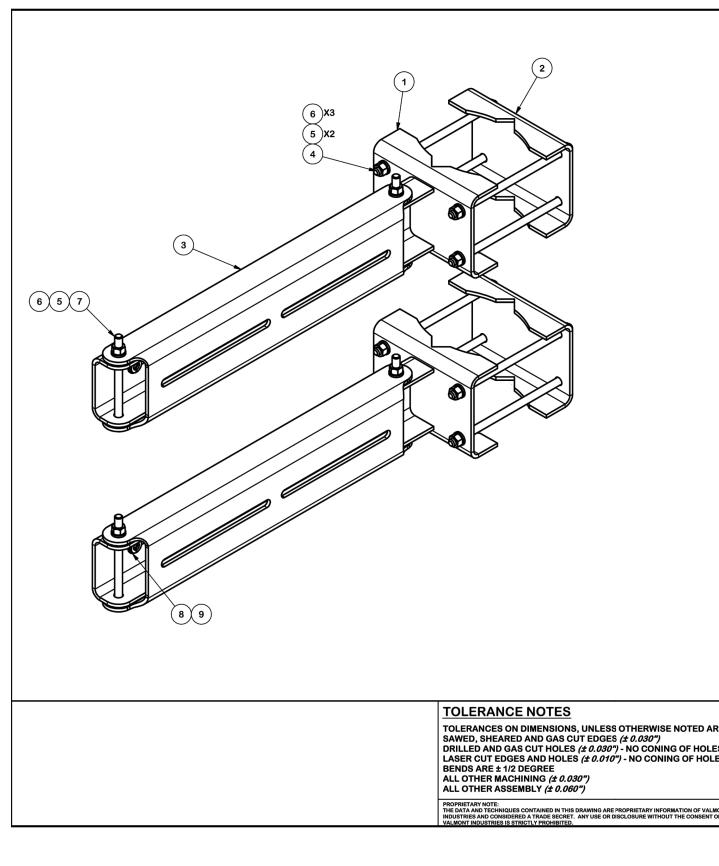

		PARTS LIST		
ITEM	QTY	PART DESCRIPTION	LENGTH	
1	2	MOUNTING ARM		Γ
2	2	CLAMP PLATE		
3	2	SWIVEL MOUNT		
4	8	3/8"-16 UNC X 8" GALV. THREADED ROD		
5	20	3/8" GALV LOCK WASHER		
6	28	3/8"-16 UNC GALV HEX NUT		
7	4	3/8" X 5" GALV BOLT		
8	8	3/8" SS FLAT WASHER		
9	8	3/8" SS LOCK WASHER		



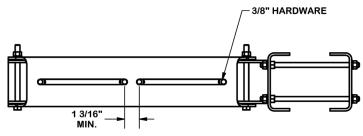

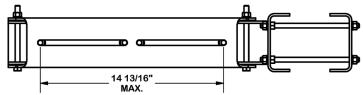


TOLERANCE NOTES TOLERANCES ON DIMENSIONS, UNLESS OTHERWISE NOTED ARE: SAWED, SHEARED AND GAS CUT EDGES (± 0.030") DRILLED AND GAS CUT HOLES (± 0.030") - NO CONING OF HOLES LASER CUT EDGES AND HOLES (± 0.010") - NO CONING OF HOLES BENDS ARE ± 1/2 DEGREE	DESCRIPT	ION RRU DUAL SWIVEL M	OUNT	SITE PRO	Engineering Support Team 1-888-753-744
ALL OTHER MACHINING (± 0.030") ALL OTHER ASSEMBLY (± 0.060")	CPD NO.	DRAWN BY CEK 1/12/2015	ENG. APPROVAL	PART NO.	RRUDSM
PROPRIETARY NOTE: THE DATA AND TECHNIQUES CONTAINED IN THIS DRAWING ARE PROPRIETARY INFORMATION OF VALMONT INDUSTRIES AND CONSIDERED A TRADE SECRET. ANY USE OR DISCLOSURE WITHOUT THE CONSENT OF VALMONT INDUSTRIES IS STRICTLY PROHIBITED.	CLASS SU 81 01	B DRAWING USAGE	снескер ву ВМС 2/3/2015	DWG. NO.	RRUDSM

UNIT WT. NET WT. 8.99 17.97			
2.35 4.69			
6.65 13.30			
0.25 2.00	1		
0.01 0.13			
0.02 0.52			
0.18 0.71			
0.01 0.06 0.01 0.05			
TOTAL WT. # 39.43			
FLIP BRACKET IN ORDER TO MOUNT TO SMALLER DIAMETER RODS			
New York, NY jineering Atlanta, GA Joort Team: Los Angeles, CA 3-753-7446 Plymouth, IN Salem, OR Dallas, TX			
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RF REQUIREMENTS FOR 700 B14 FIRSTNET, 700 B12, 700D B29 ANTENNA SEPARATION

- Horizontal separation (side to side of antenna): >= 3'
- \Box Vertical separation (between the tips of the antennas): > 3'
- Inter-sector separation: > 3' between the center of the antenna backplane

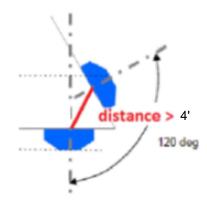

- Please note additional horizontal separation may be required if B14 antennas azimuth are different from others or antennas are severely angle with respect to the mount.
- □ Typical 3' horizontal separation can tolerate skew angle up to 6°.



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THIS SHEET CREATED BY OTHERS AND PROVIDED BY REQUEST OF CUSTOMER WITHOUT EDIT.		SHEET NUMBER: R-606	REVISION:	



Mount Analysis Report

ATC Asset Name	:	Tartaglia	
ATC Asset Number	:	383598	
Engineering Number	:	14178890_C8_01	
Mount Elevation	:	165 ft	
Proposed Carrier	:	AT&T Mobility	
Carrier Site Name	:	MRCTB057463	
Carrier Site Number	:	CTL05093	
Site Location	:	1000 Trumbull Avenue Bridgeport, CT 6606 41.21958, -73.201313	
County	:	Fairfield	
Date	:	January 25, 2023	
Max Usage	:	51%	NIN OF C
Analysis Result	:	Pass - Pending Mod	STATILIAN PARTICI
Prepared By:		Reviewed I	三*月 5日

Prepared By: Sharon Thorne Structural Engineer







Eng. Numbe

Introduction

The purpose of this report is to summarize results of the mount analysis performed for AT&T Mobilit

Supporting Documents

Specifications Sheet:	Site Pro 1 VFA14-HD, dated June 29, 2018	
Previous Analysis:	ATC Project #13682699_C8_09, dated June 29, 2022	
Radio Frequency Data Sheet:	RFDS ID #10070948, dated January 17, 2023	
Reference Photos:	Site photos from 2020	
Other Document:	ATC Project # 13682699_G3 dated December 9, 2021	
* The modifications by ATC Job # 13682699_C8_09 are scheduled to be installed at construction of the referenced pro		

Analysis

This mount was analyzed using American Tower Corporation's Mount Analysis Program and RISA-3D

Basic Wind Speed:	119 mph (3-Second Gust)
Basic Wind Speed w/ Ice:	50 mph (3-Second Gust) w/ 1.00" radial ice concurrent
Codes:	ANSI/TIA-222-H / 2021 IBC / 2022 Connecticut State Building Cod
Exposure Category:	C
Risk Category:	П
Topographic Factor Procedure:	Method 2
Feature:	Flat
Crest Height (H):	0 ft
Crest Length (L):	0 ft
Spectral Response:	Ss = 0.211, S1 = 0.054
Site Class:	D - Stiff Soil - Default
Live Loads:	Lm = 500 lbs, Lv = 250 lbs

Conclusion

Based on the analysis results, the mount meets the requirements per the applicable codes listed abors upport the equipment as described in this report. If the pending modifications cited in the Support are not completed, the results of this analysis are no longer valid, and AT&T Mobility should contact. Site Manager for further direction on how to proceed.


 Analysis based on new installation of Site Pro 1 VFA14-HD V-Frame(s) (M900R(1500)-4[6]).

If you have any questions or require additional information, please contact American Tower via en Engineering@americantower.com. Please include the American Tower site name, site number, a number in the subject line for any questions.

COA: PEC.0001553

A.T. Engineering Service, PLLC - 3500 Regency Parkway, Suite 100 - Cary, NC 27518 - 919.468.0112 Office - 919.466.5414 Fax - www.americantower.com

A.T. Engineering Service, PLLC - 3500 Regency Parkway, Suite 100 - Cary, NC 27518 - 919.468.0112 Office - 919.466.5414 Fax - www.america

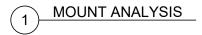

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YSIS PRIOR TO CONTRUCTION.			