From: Daniel Hatab <daniel.hatab@ramapocom.com>

Sent: Thursday, August 26, 2021 2:40 PM

**To:** CSC-DL Siting Council <Siting.Council@ct.gov> **Subject:** EM-CING-015-200807 (AT&T Site CTL02252)

Good Morning,

The site below has been 04/21, CCA letter attached

AT&T Site: CTL02252

Address: 1069 CONNECTICUT AVENUE, BRIDGEPORT CT 06607

Thank You,

### Daniel Hatab

daniel.hatab@ramapocom.com
20 Romanelli Ave, S. Hackensack, NJ 07606

Cell Phone: (201) 742-1070 Office Phone: (201) 343-2995



Date: August 23, 2021

State of Connecticut Connecticut Siting Council Ten Franklin Square New Britain, Ct. 06051 Phone: (860) 827-2935

SMW Engineering Group, Inc. 158 Business Center Dr Birmingham AL. 35244 (205) 252-6985

RE: EM-CING-015-200807

Subject: Special Inspection Letter – Final Certification

ATC Site: Bridgeport CT 2 – 302469

AT&T site: CTL02252 – FA:10084453

Site Address: 1069 Connecticut Avenue

Bridgeport, Ct. 06607-1226

AT&T Scope of work: 5C,6C,5G NR – Antenna Amendment Drawings

SMW Engineering Project: 20-10207.1

Dear Sir or Madam,

On April 20, 2021, SMW Engineering Group, Inc., reviewed detailed photographs of the AT&T telecommunication facility located at the above referenced site. The purpose of these pictures was to inspect the installation in accordance with the following codes:

- International Building Code (IBC)
- National Electric Code (NEC)
- Local Building Code
- City / County Ordinances

#### Proposed scope of work on tower from Construction Drawings:

- Removal of existing platform antenna mount
- Removal of (3) existing Powerwave 7750 antennas (1) per sector
- Removal of (6) existing Powerwave LGP 21901 Diplexers (2) per sector
- Removal of (6) existing Powerwave LGP 21401 TMA's (2) per sector
- Removal of (3) existing RRUS-11 B12 (1) per sector
- Removal of (6) existing DBC0062F3V52-1 Diplexers (2) per sector
- Removal of (6) existing DBC0061F1V51-2 Diplexers (2) per sector

- Installation of (1) new Site Pro 1 RMQLP-4120-H10 Low profile platform w/handrail kit
- Relocate (3) existing CCI-OPA-65R-LCUU-H4 antennas (1) per sector
- Installation of (3) new CCI OPA65R-BU4DA antennas (1) per sector
- Installation of (3) new CCI DMP65R-BU4DA antennas (1) per sector
- Installation of (3) RRUS E2-B29 (1) per sector
- Installation of (3) RRUS 4478 B14 (1) per sector
- Installation of (3) RRUS 4449 B5/B12 (1) per sector
- Installation of (2) DC6-48-60-18-8C squid

#### **Discrepancies from Permitted Drawings:**

None

To the best of our knowledge, belief, and professional judgment, the connections of the installed equipment were performed **in substantial compliance** with the approved construction drawings prepared by SMW Engineering Group, Inc. dated 11-06-20 Rev.1.

Should you have any questions or wish to discuss any aspect of this letter, please do not hesitate to contact the undersigned.

Sincerely,

John T. Liu, PE **SMW Engineering Group, INC.** Principal Engineer Connecticut Registration #33076







ATC SITE NAME: BRIDGEPORT CT 2

ATC SITE NUMBER: 302469

AT&T PACE NUMBER: MRCTB045164/MRCTB045264/

MRCTB045348/MRCTB045267

AT&T SITE ID: CTL02252 AT&T FA CODE:10084453 PROJECTS: 5C, 6C,5G NR

SITE ADDRESS: 1069 CONNECTICUT AVENUE

BRIDGEPORT, CT 06607-1226





**LOCATION MAP** 

COMPLIANCE CODE	PROJECT SUMMARY	PROJECT DESCRIPTION		SHEET INDEX			
ALL WORK SHALL BE PERFORMED AND MATERIALS INSTALLED IN ACCORDANCE WITH THE CURRENT EDITIONS OF THE	SITE ADDRESS:	THE PROPOSED PROJECT INCLUDES MODIFYING GROUND BASED AND TOWER MOUNTED EQUIPMENT AS INDICATED PER BELOW:	SHEET NO:			DATE:	BY:
IN ACCORDANCE WITH THE CURRENT EDITIONS OF THE FOLLOWING CODES AS ADOPTED BY THE LOCAL GOVERNMENT AUTHORITIES. NOTHING IN THESE PLANS IS	1069 CONNECTICUT AVENUE	TOWER WORK: REMOVE (3) ANTENNAS, (3) RRH'S, (9) DIPLEXERS, AND (6) TMA'S.	G-001	COVER SHEET	1	11/06/20	ZDS
TO BE CONSTRUED TO PERMIT WORK NOT CONFORMING TO THESE CODES.	BRIDGEPORT, CT 06607-1226  COUNTY: FAIRFIELD	INSTALL (6) ANTENNAS, (3) RRUS-E2 B29, (3) RRUS-4478 B14,	G-002	GENERAL NOTES	1	11/06/20	ZDS
INTERNATIONAL BUILDING CODE (IBC)	GEOGRAPHIC COORDINATES:	(3) RRUS-4449 B5/B12, (2) SQUIDS, (4) 0.78" 8AWG6 DC CABLES, (2) 0.39" FIBER CABLES, AND NEW MOUNT	C-101	DETAILED SITE PLAN	1	11/06/20	ZDS
NATIONAL ELECTRIC CODE (NEC)     LOCAL BUILDING CODE	LATITUDE: 41.18361667	EXISTING (6) ANTENNAS, (6) RRH'S, (2) SQUIDS, (4) 0.78" 8AWG6 DC	C-201	TOWER ELEVATION	1	11/06/20	ZDS
4. CITY/COUNTY ORDINANCES	LONGITUDE: -73.15838333	CABLES AND (2) 0.39" FIBER CABLES TO REMAIN.	C-401	EXISTING RF SCHEDULE AND ANTENNA INSTALLATION	1	11/06/20	ZDS
	GROUND ELEVATION: 32' AMSL	GROUND WORK: INSTALL (1) 6630 AND (1) IDLE CABLE.	C-402	FINAL RF SCHEDULE AND ANTENNA INSTALLATION	1	11/06/20	ZDS
		INSTALL (1) 0030 AND (1) IDLE CABLE.	C-501	CONSTRUCTION DETAILS	1	11/06/20	ZDS
			C-502	EQUIPMENT SPECIFICATIONS	1	11/06/20	ZDS
				GROUNDING DETAILS	1	11/06/20	ZDS
	PROJECT TEAM	PROJECT NOTES	R-601	SUPPLEMENTAL	1	11/06/20	ZDS
	TOWER OWNER: APPLICANT:	THE FACILITY IS UNMANNED.     A TECHNICIAN WILL VISIT THE SITE APPROXIMATELY ONCE     A MONTH FOR ROUTINE INSPECTION AND MAINTENANCE.	R-602	SUPPLEMENTAL	1	11/06/20	ZDS
	AMERICAN TOWER AT&T MOBILITY						
	10 PRESIDENTIAL WAY WOBURN, MA 01801	<ol> <li>THE PROJECT WILL NOT RESULT IN ANY SIGNIFICANT LAND DISTURBANCE OR EFFECT OF STORM WATER DRAINAGE.</li> </ol>					
UTILITY COMPANIES	ENGINEER:	NO SANITARY SEWER, POTABLE WATER OR TRASH     DISPOSAL IS REQUIRED.     HANDICAP ACCESS IS NOT REQUIRED.					
POWER COMPANY: UTILITY COMPANY DIRECT PHONE: NOT PROVIDED	SMW ENGINEERING GROUP, INC						
TELEPHONE COMPANY: NOT PROVIDED	158 BUSINESS CENTER DRIVE BIRMINGHAM, AL 35244	PROJECT LOCATION DIRECTIONS					
PHONE: NOT PROVIDED	JOB# 20-10207						
<b>6777</b>	PROPERTY OWNER:						
<b>X11</b>	CITY OF BRIDGEPORT 1069 CONNECTICUT AVE.	FROM HARTFORD, CT TAKE I-91 SOUTH TO I-95 SOUTH TO EXIT 29. TURN LEFT OFF EXIT AND AT LIGHT TAKE A LEFT U-TURN					
	BRIDGEPORT, CT 06607	ONTO STRATFORD AVENUE. FOLLOW STRATFORD TO FREEMAN STREET AND TURN LEFT. GO TO STOP SIGN AND					
		CROSS OVER CONNECTICUT AVENUE INTO PARKING LOT. TOWER IS AT THE LEFT HAND END OF THE PARKING LOT.					
Know what's <b>below. Call</b> before you dig.							
Outil before you dig.							





# TOGETHER PLANNING A BETTER TOMORROW 158 BUSINESS CENTER DRIVE BIRMINGHAM, AL 35244

TEL: 205-252-6985 FAX: 205-320-1504

REV.	DESCRIPTION	BY	DATE
<u> </u>	FOR CONSTRUCTION	ZDS	05/26/20
<u> </u>	FOR CONSTRUCTION	ZDS	11/06/20
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ATC SITE NUMBER:

302469

ATC SITE NAME:

#### **BRIDGEPORT CT 2**

SITE ADDRESS: 1069 CONNECTICUT AVENUE BRIDGEPORT, CT 06607-1226





DATE DRAWN:	05/08/20
ATC JOB NO:	302469
CUSTOMER ID:	13202054
CUSTOMER #:	20-10207

**COVER SHEET** 

G-001

#### **GENERAL CONSTRUCTION NOTES:**

- OWNER FURNISHED MATERIALS, AT&T MOBILITY "THE COMPANY" WILL PROVIDE AND THE 22. CONTRACTOR WILL INSTALL
- A. BTS EQUIPMENT FRAME (PLATFORM) AND ICEBRIDGE SHELTER (GROUND
- BUILD/CO-LOCATE ONLY) AC/TELCO INTERFACE BOX (PPC)
- C. ICE BRIDGE (CABLE TRAY WITH COVER) (GROUND BUILD/CO-LOCATE ONLY, GC TO FURNISH AND INSTALL FOR ROOFTOP INSTALLATION)
- D. TOWERS, MONOPOLES TOWER LIGHTING
- GENERATORS & LIQUID PROPANE TANK
- ANTENNA STANDARD BRACKETS, FRAMES AND PIPES FOR MOUNTING
- ANTENNAS (INSTALLED BY OTHERS)
- TRANSMISSION LINE
- TRANSMISSION LINE JUMPERS
- TRANSMISSION LINE CONNECTORS WITH WEATHERPROOFING KITS
- TRANSMISSION LINE GROUND KITS
- HANGERS
- HOISTING GRIPS
- O. BTS EQUIPMENT
- THE CONTRACTOR IS RESPONSIBLE TO PROVIDE ALL OTHER MATERIALS FOR THE MATERIALS AS FENCING, STRUCTURAL STEEL SUPPORTING SUB-FRAME FOR PLATFORM ROOFING LABOR AND MATERIALS GROUNDING RINGS GROUNDING WIRES COPPER-CLAD OR XIT CHEMICAL GROUND ROD(S), BUSS BARS, TRANSFORMERS AND DISCONNECT SWITCHES WHERE APPLICABLE, TEMPORARY ELECTRICAL POWER, CONDUIT, LANDSCAPING COMPOUND STONE, CRANES, CORE DRILLING, SLEEPERS AND RUBBER MATTING, REBAR, CONCRETE CAISSONS, PADS AND/OR AUGER MOUNTS,
  MISCELLANEOUS FASTENERS, CABLE TRAYS, NON-STANDARD ANTENNA FRAMES AND ALL OTHER MATERIAL AND LABOR REQUIRED TO COMPLETE THE JOB ACCORDING TO THE DRAWINGS AND SPECIFICATIONS. IT IS THE POSITION OF AT&T MOBILITY TO APP FOR PERMITTING AND CONTRACTOR RESPONSIBLE FOR PICKUP AND PAYMENT OF
- ALL WORK SHALL CONFORM TO ALL CURRENT APPLICABLE FEDERAL, STATE, AND LOCAL CODES, INCLUDING ANSI/EIA/TIA-222, AND COMPLY WITH ATC CONSTRUCTION
- CONTRACTOR SHALL CONTACT LOCAL 811 FOR IDENTIFICATION OF UNDERGROUND
- CONTRACTOR SHALL BE RESPONSIBLE FOR COORDINATING ALL REQUIRED INSPECTIONS.
- ALL DIMENSIONS TO, OF, AND ON EXISTING BUILDINGS, DRAINAGE STRUCTURES, AND SITE IMPROVEMENTS SHALL BE VERIFIED IN FIELD BY CONTRACTOR WITH ALL DISCREPANCIES REPORTED TO THE ENGINEER.
- DO NOT CHANGE SIZE OR SPACING OF STRUCTURAL ELEMENTS
- DETAILS SHOWN ARE TYPICAL; SIMILAR DETAILS APPLY TO SIMILAR CONDITIONS UNLESS 32.
- THESE DRAWINGS DO NOT INCLUDE NECESSARY COMPONENTS FOR CONSTRUCTION SAFETY WHICH SHALL BE THE SOLE RESPONSIBILITY OF THE CONTRACTOR
- CONTRACTOR SHALL BRACE STRUCTURES UNTIL ALL STRUCTURAL FLEMENTS NEEDED 33. FOR STABILITY ARE INSTALLED. THESE ELEMENTS ARE AS FOLLOWS: LATERAL BRACING,
- CONTRACTOR SHALL DETERMINE EXACT LOCATION OF EXISTING UTILITIES, GROUNDS DRAINS, DRAIN PIPES, VENTS, ETC, BEFORE COMMENCING WORK
- INCORRECTLY FABRICATED, DAMAGED, OR OTHERWISE MISFITTING OR NONCONFORMING MATERIALS OR CONDITIONS SHALL BE REPORTED TO THE AT&T MOBILITY REP PRIOR TO REMEDIAL OR CORRECTIVE ACTION. ANY SUCH REMEDIAL ACTION SHALL REQUIRE WRITTEN APPROVAL BY THE AT&T MOBILITY REP PRIOR TO
- EACH CONTRACTOR SHALL COOPERATE WITH THE AT&T MOBILITY REP, AND OORDINATE HIS WORK WITH THE WORK OF OTHERS
- CONTRACTOR SHALL REPAIR ANY DAMAGE CAUSED BY CONSTRUCTION OF THIS PROJECT TO MATCH EXISTING PRE-CONSTRUCTION CONDITIONS TO THE SATISFACTION OF THE AT&T MOBILITY CONSTRUCTION MANAGER.
- ALL CABLE/CONDUIT ENTRY/EXIT PORTS SHALL BE WEATHERPROOFED DURING
- WHERE EXISTING CONDITIONS DO NOT MATCH THOSE SHOWN IN THIS PLAN SET, CONTRACTOR SHALL NOTIFY THE AT&T MOBILITY REP AND ENGINEER OF RECORD
- CONTRACTOR SHALL ENSURE ALL SUBCONTRACTORS ARE PROVIDED WITH A COMPLETE AND CURRENT SET OF DRAWINGS AND SPECIFICATIONS FOR THIS PROJECT.
- CONTRACTOR SHALL REMOVE ALL RUBBISH AND DEBRIS FROM THE SITE AT THE END OF
- CONTRACTOR SHALL COORDINATE WORK SCHEDULE WITH AMERICAN TOWER CORPORATION (ATC) AND TAKE PRECAUTIONS TO MINIMIZE IMPACT AND DISRUPTION OF OTHER OCCUPANTS OF THE FACILITY.
- CONTRACTOR SHALL FURNISH AT&T MOBILITY AND AMERICAN TOWER CORPORATION (ATC) WITH A PDF MARKED UP AS-BUILT SET OF DRAWINGS UPON COMPLETION OF
- PRIOR TO SUBMISSION OF BID, CONTRACTOR SHALL COORDINATE WITH AT&T MOBILITY REP TO DETERMINE WHAT, IF ANY, ITEMS WILL BE PROVIDED. ALL ITEMS NOT PROVIDED SHALL BE PROVIDED AND INSTALLED BY THE CONTRACTOR. CONTRACTOR WILL INSTALL 2. ALL EXTERIOR #6 GREED GROUND WIRE "DAISY CHAIN" CONNECTIONS ARE TO BE

- ALL ITEMS PROVIDED.
- PRIOR TO SUBMISSION OF BID. CONTRACTOR SHALL COORDINATE WITH AT&T MOBILITY REP TO DETERMINE IF ANY PERMITS WILL BE OBTAINED BY CONTRACTOR. ALL
  REQUIRED PERMITS NOT OBTAINED BY AT&T MOBILITY MUST BE OBTAINED, AND PAID
- 23. CONTRACTOR SHALL INSTALL ALL SITE SIGNAGE IN ACCORDANCE WITH AT&T MOBILITY
- CONTRACTOR SHALL SUBMIT ALL SHOP DRAWINGS TO AT&T MOBILITY FOR REVIEW AND APPROVAL PRIOR TO FABRICATION.
- 25. ALL EQUIPMENT SHALL BE INSTALLED ACCORDING TO MANUFACTURER'S SPECIFICATIONS AND LOCATED ACCORDING TO AT&T MOBILITY SPECIFICATIONS, AND AS SHOWN IN THESE PLANS.
- THE CONTRACTOR SHALL SUPERVISE AND DIRECT THE PROJECT DESCRIBED HEREIN. THE CONTRACTOR SHALL BE SOLELY RESPONSIBLE FOR ALL THE CONSTRUCTION MEANS, METHODS, TECHNIQUES, SEQUENCES AND PROCEDURES AND FOR COORDINATING ALL PORTIONS OF THE WORK UNDER THE CONTRACT.
- CONTRACTOR SHALL NOTIFY AT&T MOBILITY REP A MINIMUM OF 48 HOURS IN ADVANCE OF POURING CONCRETE OR BACKFILLING ANY UNDERGROUND UTILITIES, FOUNDATIONS OR SEALING ANY WALL, FLOOR OR ROOF PENETRATIONS FOR ENGINEERING REVIEW
- CONTRACTOR SHALL BE RESPONSIBLE FOR SITE SAFETY INCLUDING COMPLIANCE WITH ALL APPLICABLE OSHA STANDARDS AND RECOMMENDATIONS AND SHALL PROVIDE ALL NECESSARY SAFETY DEVICES INCLUDING PPE AND PPM AND CONSTRUCTION DEVICES SUCH AS WELDING AND FIRE PREVENTION, TEMPORARY SHORING, SCAFFOLDING, TRENCH BOXES/SLOPING, BARRIERS, ETC.
- THE CONTRACTOR SHALL PROTECT AT HIS OWN EXPENSE, ALL EXISTING FACILITIES AND SUCH OF HIS NEW WORK LIABLE TO INJURY DURING THE CONSTRUCTION PERIOD. ANY DAMAGE CAUSED BY NEGLECT ON THE PART OF THIS CONTRACTOR OR HIS REPRESENTATIVES, OR BY THE ELEMENTS DUE TO NEGLECT ON THE PART OF THIS CONTRACTOR OR HIS REPRESENTATIVES. FITHER TO THE EXISTING WORK, OR TO HIS WORK OR THE WORK OF ANY OTHER CONTRACTOR, SHALL BE REPAIRED AT HIS EXPENSE TO THE OWNER'S SATISFACTION.
- 30. ALL WORK SHALL BE INSTALLED IN A FIRST CLASS, NEAT AND WORKMANLIKE MANNER BY MECHANICS SKILLED IN THE TRADE INVOLVED. THE QUALITY OF WORKMANSHIP SHALL BE SUBJECT TO THE APPROVAL OF THE AT&T MOBILITY REP. ANY WORK FOUND BY THE AT&T MOBILITY, REP TO BE OF INFERIOR QUALITY AND/OR WORKMANSHIP SHALL BE REPLACED AND/OR REWORKED AT CONTRACTOR EXPENSE UNTIL APPROVAL IS
- IN ORDER TO ESTABLISH STANDARDS OF QUALITY AND PERFORMANCE, ALL TYPES OF MATERIALS LISTED HEREINAFTER BY MANUFACTURER'S NAMES AND/OF MANUFACTURER'S CATALOG NUMBER SHALL BE PROVIDED BY THESE MANUFACTURERS
- AT&T MOBILITY FURNISHED EQUIPMENT SHALL BE PICKED-UP AT THE AT&T MOBILITY WAREHOUSE, NO LATER THAN 48HR AFTER BEING NOTIFIED INSURED, STORED, UNCRATE, PROTECTED AND INSTALLED BY THE CONTRACTOR WITH ALL APPURTENANCES REQUIRED TO PLACE THE EQUIPMENT IN OPERATION. READY FOR USE. THE CONTRACTOR SHALL BE RESPONSIBLE FOR THE EQUIPMENT AFTER PICKING IT
- AT&T MOBILITY OR HIS ARCHITECT/ENGINEER RESERVES THE RIGHT TO REJECT ANY FOLIPMENT OR MATERIALS WHICH, IN HIS OWN OPINION ARE NOT IN COMPLIANCE WITH THE CONTRACT DOCUMENTS, EITHER BEFORE OR AFTER INSTALLATION AND THE EQUIPMENT SHALL BE REPLACED WITH EQUIPMENT CONFORMING TO THE REQUIREMENTS OF THE CONTRACT DOCUMENTS BY THE CONTRACTOR AT NO COST TO AT&T MOBILITY OR THEIR ARCHITECT/ENGINEER

#### SPECIAL CONSTRUCTION ANTENNA INSTALLATION NOTES:

- WORK INCLUDED
  - ANTENNA AND COAXIAL CABLES ARE FURNISHED BY AT&T MOBILITY UNDER A SEPARATE CONTRACT. THE CONTRACTOR SHALL ASSIST ANTENNA INSTALLATION CONTRACTOR IN TERMS OD COORDINATION AND SITE ACCESS. ERECTION SUBCONTRACTOR SHALL BE RESPONSIBLE FOR THE PROTECTION OF
  - B. INSTALL ANTENNA AS INDICATE ON DRAWINGS AND AT&T MOBILITY
  - C. INSTALL GALVANIZED STEEL ANTENNA MOUNTS AS INDICATED ON DRAWINGS
  - D. INSTALL FURNISHED GALVANIZED STEEL OR ALUMINUM WAVEGUIDE AND PROVIDE PRINTOUT OF THAT TEST.
  - E. CONTRACTOR SHALL PROVIDE FOUR (4) SETS OF SWEEP TESTS USING ANRITZU-PACKARD 8713B RF SCALAR NETWORK ANALYZER. SUBMIT FREQUENCY DOMAIN REFLECTOMETER(FDR) TESTS RESULTS TO THE PROJECT MANAGER. SWEEP TESTS SHALL BE AS PER ATTACHED RFS "MINIMUM FIELD TESTING RECOMMENDED FOR ANTENNA AND HELIAX COAXIAL CABLE SYSTEMS" DATED 10/5/93. TESTING SHALL BE PERFORMED BY AN INDEPENDENT TESTING SERVICE AND BE BOUND AND SUBMITTED WITHIN ONE WEEK OF WORK COMPLETION.
  - INSTALL COAXIAL CABLES AND TERMINATING BETWEEN ANTENNAS AND EQUIPMENT PER MANUFACTURER'S RECOMMENDATIONS. WEATHERPROOF ALL CONNECTIONS RETWEEN THE ANTENNA AND FOLIPMENT PER MANUFACTURER'S REQUIREMENTS. TERMINATE ALL COAXIAL CABLE THREE (3) FEET IN EXCESS OF ENTRY PORT LOCATION UNLESS OTHERWISE STATED.
  - G. ANTENNA AND COAXIAL CABLE GROUNDING:

WEATHER SEALED WITH RES CONNECTORS/SPLICE WEATHERPROOFING KIT #221213 OR

ALL COAXIAL CABLE GROUNDING KITS ARE TO BE INSTALLED ON STRAIGHT RUNS OF COAXIAL CABLE (NOT WITHIN BENDS)

> ALL DISCREPANCIES FROM WHAT IS SHOWN ON THESE CONSTRUCTION DRAWINGS SHALL BE COMMUNICATED TO ATC ENGINEERING IMMEDIATELY FOR CORRECTION OR RE-DESIGN. FAILURE TO COMMUNICATE DIRECTLY WITH ATC ENGINEERING OR ANY CHANGES FROM THE DESIGN CONDUCTED WITHOUT PRIOR APPROVAL FROM ATC ENGINEERING SHALL BE THE SOLE RESPONSIBILITY OF THE GENERAL CONTRACTOR.





TOGETHER PLANNING A BETTER TOMORROW 158 BUSINESS CENTER DRIVE BIRMINGHAM AL 35244 TEL: 205-252-6985 FAX: 205-320-1504

REV. DESCRIPTION BY DATE FOR CONSTRUCTION ZDS 05/26/20 FOR CONSTRUCTION ZDS 11/06/20

ATC SITE NUMBER:

302469

ATC SITE NAME:

BRIDGEPORT CT 2

SITE ADDRESS: 1069 CONNECTICUT AVENUE BRIDGEPORT, CT 06607-1226





DATE DRAWN: 05/08/20 ATC JOB NO: 302469 CUSTOMER ID: 13202054 CUSTOMER #: 20-10207

**GENERAL NOTES** 

SHEET NUMBER:


G-002

#### SITE PLAN NOTES:

- 1. THIS SITE PLAN REPRESENTS THE BEST PRESENT KNOWLEDGE AVAILABLE TO THE ENGINEER AT THE TIME OF THIS DESIGN. THE CONTRACTOR SHALL VISIT THE SITE PRIOR TO CONSTRUCTION AND VERIFY ALL EXISTING CONDITIONS RELATED TO THE SCOPE OF WORK FOR THIS PROJECT.
- ICE BRIDGE, CABLE LADDER, COAX PORT, AND COAX CABLE ARE SHOWN FOR REFERENCE ONLY. CONTRACTOR SHALL CONFIRM THE EXACT LOCATION OF ALL PROPOSED AND EXISTING EQUIPMENT AND STRUCTURES DEPICTED ON THIS PLAN. BEFORE UTILIZING EXISTING CABLE SUPPORTS, COAX PORTS, INSTALLING NEW PORTS OR ANY OTHER EQUIPMENT, CONTRACTOR SHALL VERIFY ALL ASPECTS OF THE COMPONENTS MEET THE ATC SPECIFICATIONS.
- 3. THIS PROJECT INCLUDES NO INSTALL OR MODIFICATION AT GRADE.


#### LEGEND GROUNDING TEST WELL AUTOMATIC TRANSFER SWITCH ATS BOLLARD CSC CELL SITE CABINET D DISCONNECT ELECTRICAL **FIBER** GEN GENERATOR GENERATOR RECEPTACAL HH, V HAND HOLE, VAULT ΙB ICE BRIDGE KENTROX BOX LC LIGHTING CONTROL М METER PB PULL BOX PP POWER POLE TELCO TRN TRANSFORMER

CHAINLINK FENCE

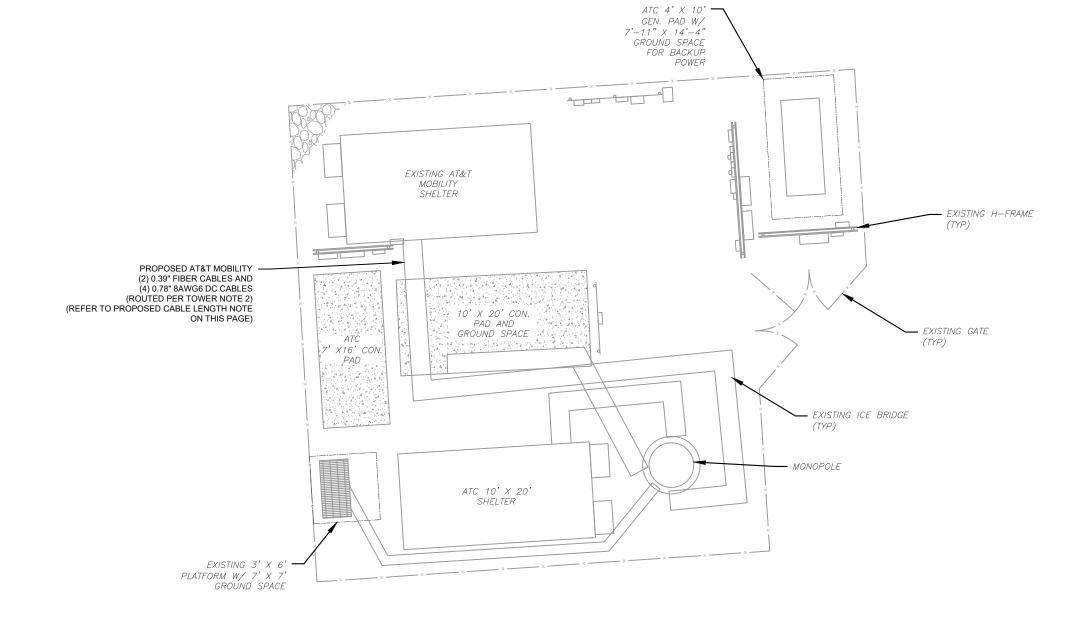

#### PROPOSED CABLE LENGTH:

- ESTIMATED LENGTH OF PROPOSED CABLE IS XXX. ESTIMATED LENGTH OF CABLE WAS PROVIDED BY CUSTOMER OR CALCULATED BY ADDING THE RAD CENTER AND THE DISTANCE FROM THE SHELTER ENTRY PLATE TO THE TOWER (ALONG THE ICE BRIDGE) AND A SAFETY FACTOR MEASUREMENT OF 15% (OF THE TWO PREVIOUS VALUES), CDS DEFER TO GREATEST CABLE LENGTH.
- 2. ROUTE PROPOSED CABLES ALONG SAME PATH AS EXISTING CABLES AND IN ACCORDANCE WITH STRUCTURAL ANALYSIS. WHERE POSSIBLE UTILIZE EXISTING CABLE SUPPORT STRUCTURES AS PROVIDED FOR CARRIER TO ADEQUATELY SECURE CABLES, USING EITHER APPROPRIATELY SIZED STAINLESS STEEL SNAP-INS OR MOUNTING HARDWARE AND BRACKETS AS SPECIFIED BY CABLE MANUFACTURER. OTHERWISE, ATTACH CABLES TO HORIZONTAL OR DIAGONAL TOWER MEMBERS USING PROPOSED STAINLESS STEEL ADAPTERS (DO NOT ATTACH TO TOWER LEG).

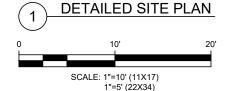







# TOGETHER PLANNING A BETTER TOMORROW 158 BUSINESS CENTER DRIVE BIRMINGHAM. AL 35244

TEL: 205-252-6985 FAX: 205-320-1504

REV.	DESCRIPTION	BY	DATE
<u></u>	FOR CONSTRUCTION	_ ZDS	05/26/20
<u> </u>	FOR CONSTRUCTION	ZDS	11/06/20
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ATC SITE NUMBER:

302469

ATC SITE NAME:

#### BRIDGEPORT CT 2

SITE ADDRESS: 1069 CONNECTICUT AVENUE BRIDGEPORT, CT 06607-1226

SEA






DATE DRAWN:	05/08/20
ATC JOB NO:	302469
CUSTOMER ID:	13202054
CUSTOMER #:	20-10207

### **DETAILED SITE PLAN**

SHEET NUMBER:

C-101

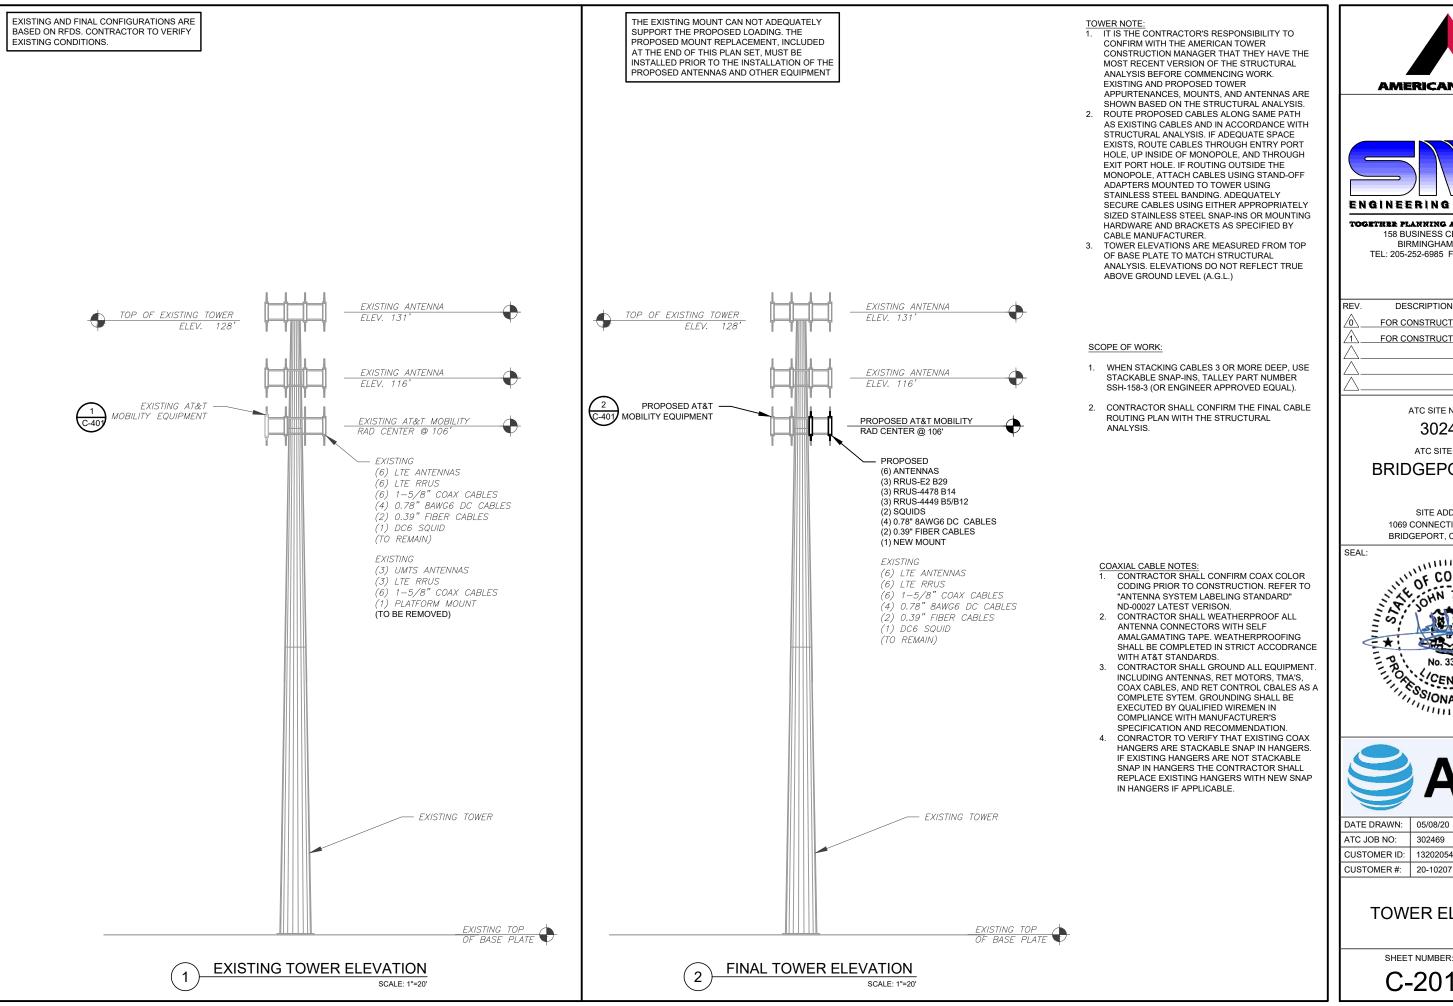





TOGETHER PLANNING A BETTER TOMORROW 158 BUSINESS CENTER DRIVE BIRMINGHAM, AL 35244

TEL: 205-252-6985 FAX: 205-320-1504

REV.	DESCRIPTION	BY	DATE
<u></u>	FOR CONSTRUCTION	_ ZDS	05/26/20
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ATC SITE NUMBER:

302469

ATC SITE NAME:

#### **BRIDGEPORT CT 2**

SITE ADDRESS: 1069 CONNECTICUT AVENUE BRIDGEPORT, CT 06607-1226





13202054


**TOWER ELEVATION** 

SHEET NUMBER:

REVISION

C-201

EXISTING AND FINAL CONFIGURATIONS ARE BASED ON RFDS. CONTRACTOR TO VERIFY

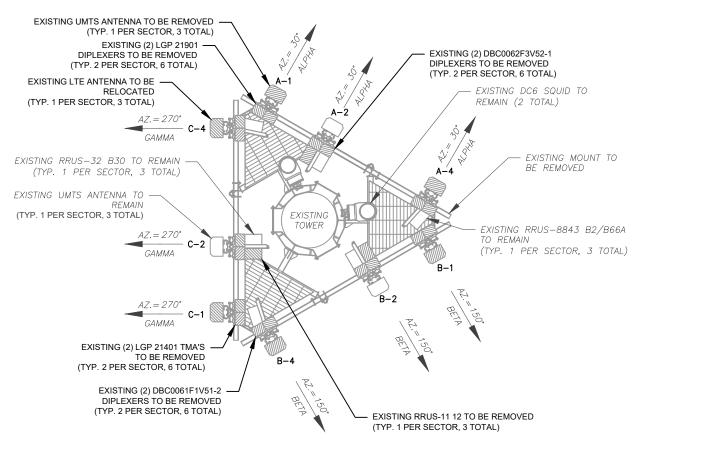

**CURRENT ANTENNA PLAN** 

NOTES					FINAL /	ANTENNA SCHEDULE				
BASED ON APPROVED ATC	LO	LOCATION ANTENNA SUMMARY NON ANTENNA SU						NON ANTENNA SUMMAR	имаRY	
APPLICATION 302469, DATED 04/16/20. CONFIRM WITH AT&T	SECTOR	RAD	AZ	POS	ANTENNA	BAND	STATUS	ADDITIONAL TOWER MOUNTED EQUIPMENT	STATUS	
MOBILITY REP FOR APPLICABLE UPDATES/REVISIONS AND MOST RECENT RFDS FOR NSN				4.1	DOMEDIMANE 7750	LIMTO	DM/	POWERWAVE LGP 21901 DIPLEXER	RMV	
CONFIGURATION (CONFIG). GC TO CAP ALL UNUSED PORTS.				A1	POWERWAVE 7750	UMTS	RMV	(2) POWERWAVE LGP 21401 TMA	RMV	
2. ATC HAS NOT YET VERIFIED ANY								RRUS-11 B12	RMV	
EXISTING ANTENNA CONFIG OR MOUNT CONFIG. CONTRACTOR	ALPHA	106'	30°	A2	CCI OPA-65R-LCUU-H4	LTE	RMN	RRUS-32 B30	RMN	
TO VERIFY MOUNT CONFIG HAS								DBC0062F3V52-1 DIPLEXER	RMV	
SUFFICIENT SPACE FOR PROPOSED LESSEE EQUIPMENT				A3	-	=	_	-	_	
(EQUIP) (I.E. CLEARANCES,				4.4	CCI OPA-65R-LCUU-H4	LTE	DEL	RRUS-8843 B2/B66A	RMN	
MOUNT PIPE, SUFFICIENT LENGTH, ETC.) ATC DID NOT				A4		LTE	REL	DBC0061F1V51-2 DIPLEXER	RMV	
ANALYZE ANTÉNNA MOUNT TO DETERMINE ADEQUATE	<b>.</b>			B1	POWERWAVE 7750	UMTS	RMV	POWERWAVE LGP 21901 DIPLEXER	RMV	
STRUCTURAL CAPACITY FOR ANY LESSEE LOADING.								(2) POWERWAVE LGP 21401 TMA	RMV	
ALL PROPOSED EQUIP INCLUDING ANTENNAS, COAX, ETC. SHALL BE								RRUS-11 B12	RMV	
MOUNTED IN ACCORDANCE WITH	BETA	106'	150°	B2	CCI OPA-65R-LCUU-H4	LTE	RMN	RRUS-32 B30	RMN	
THE TOWER STRUCTURAL ANALYSIS ON FILE WITH ATC'S CM.								DBC0062F3V52-1 DIPLEXER	RMV	
CONFIRM SPACING OF PROPOSED				<i>B3</i>	_	-	_	_	_	
EQUIP DOES NOT CAUSE TOWER CONFLICTS NOR IMPEDE TOWER				B4	COLODA SED LOUILIA	LTE	DEL	RRUS-8843 B2/B66A	RMN	
CLIMBING PEGS.				D4	CCI OPA-65R-LCUU-H4 LTE REL	DBC0061F1V51-2 DIPLEXER	RMV			
POSITIONS START WITH FIRST PIPE ON THE LEFT SIDE (AS VIEWED FROM BEHIND THE				C1	POWERWAVE 7750	UMTS	RMV	POWERWAVE LGP 21901 DIPLEXER	RMV	
MOUNT).				C1	FOWERWAVE 1130	OWITS	RIVIV	(2) POWERWAVE LGP 21401 TMA	RMV	
								RRUS-11 B12	RMV	
	GAMMA	106'	270°	C2	CCI OPA-65R-LCUU-H4	LTE	RMN	RRUS-32 B30	RMN	
								DBC0062F3V52-1 DIPLEXER	RMV	
				C3	_	_	_	_	-	
				C4	CCI OPA-65R-LCUU-H4	LTE	REL	RRUS-8843 B2/B66A	RMN	
				CGI OPA-05R-LCOU-H4		LIE KEL		DBC0061F1V51-2 DIPLEXER	RMV	

CABLE LENGTHS FOR JUMPERS FIBER DISTRIBUTION/SQUID TO RRU: 15' RRU TO ANTENNA: 10'

STATUS ABBREVIATIONS RMV: TO BE REMOVED RMN: TO REMAIN REL: TO BE RELOCATED DSC: TO BE DISCONNECTED & REMAIN ADD: TO BE ADDED

EXISTING FIBER DISTRIBUTIO	N/SQUID	EXISTING CABLING SUMMARY				
MODEL NUMBER	STATUS	COAX	DC	FIBER	STATUS	
DC6-48-60-18-8F	RMN	(6) 1-5/8" COAX	(4) 0.78"	(2) 0.39"	RMN	
DC6-48-60-18-8F	RMN	(6) 1-5/8"	_	_	RMV	





TOGETHER PLANNING A BETTER TOMORROW 158 BUSINESS CENTER DRIVE BIRMINGHAM, AL 35244 TEL: 205-252-6985 FAX: 205-320-1504

REV.	DESCRIPTION	BY	DATE
<u></u>	FOR CONSTRUCTION	ZDS	05/26/20
<u> </u>	FOR CONSTRUCTION	ZDS	11/06/20
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ATC SITE NUMBER:


302469

ATC SITE NAME:

#### **BRIDGEPORT CT 2**

SITE ADDRESS: 1069 CONNECTICUT AVENUE BRIDGEPORT, CT 06607-1226



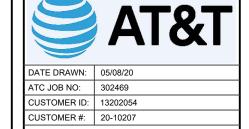

**EXISTING RF SCHEDULE** AND ANTENNA INSTALLATION

SHEET NUMBER:

C-401


REVISION:

**EQUIPMENT SCHEDULES** 

THE EXISTING MOUNT CAN NOT ADEQUATELY SUPPORT THE PROPOSED LOADING. THE PROPOSED MOUNT REPLACEMENT, INCLUDED AT THE END OF THIS PLAN SET, MUST BE INSTALLED PRIOR TO THE INSTALLATION OF THE PROPOSED ANTENNAS AND OTHER EQUIPMENT

VIEWED FROM BEHIND THE

MOUNT).

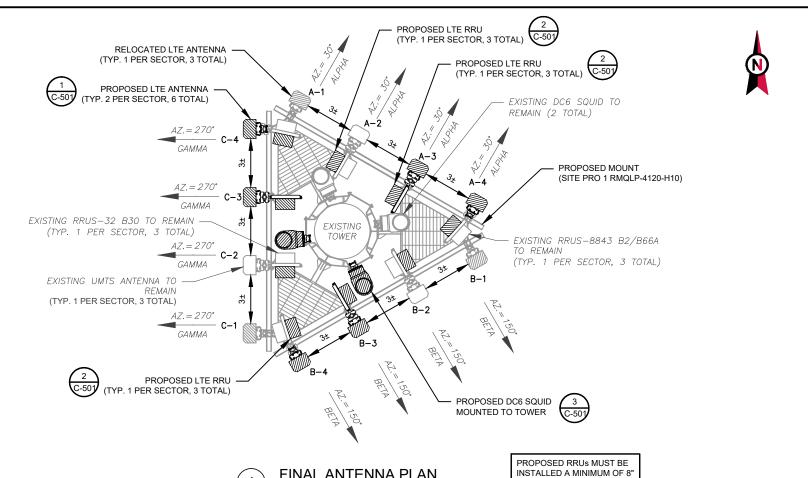

FINAL ANTENNA PLAN

									<u> </u>	
	NOTES					FINAL A	NTENNA SCHEDULE			
1	BASED ON APPROVED ATC	LOCATION				ANTENNA SUMMARY			NON ANTENNA SUMMARY	
	APPLICATION 302469, DATED 04/16/20. CONFIRM WITH AT&T	SECTOR	RAD	AZ	POS	ANTENNA	BAND	STATUS	ADDITIONAL TOWER MOUNTED EQUIPMENT	STATUS
	MOBILITY REP FOR APPLICABLE UPDATES/REVISIONS AND MOST				A1	CCI OPA-65R-LCUU-H4	UMTS	REL	-	-
	RECENT RFDS FOR NSN				40	001 004 050 10111 114	1.75	DIAN	RRUS-E2 B29	ADD
	CONFIGURATION (CONFIG). GC TO CAP ALL UNUSED PORTS.				A2	CCI OPA-65R-LCUU-H4	LTE	RMN	RRUS-32 B30	RMN
2.	ATC HAS NOT YET VERIFIED ANY	ALPHA	106'	30°	A3	CCI OPA65R-BU4DA	LTE	ADD	RRUS-4478 B14	ADD
	EXISTING ANTENNA CONFIG OR								RRUS-4449 B5/B12	ADD
	MOUNT CONFIG. CONTRACTOR TO VERIFY MOUNT CONFIG HAS				A4	CCI DMP65R-BU4DA	LTE	ADD	RRUS-8843 B2/B66A	RMN
	SUFFICIENT SPACE FOR PROPOSED LESSEE EQUIPMENT	BETA			B1	CCI OPA-65R-LCUU-H4	UMTS	REL	-	-
	(EQUIP) (I.E. CLEARANCES,			4500	B2	2 CCI OPA-65R-LCUU-H4	, ,,	5141	RRUS-E2 B29	ADD
	MOUNT PIPE, SUFFICIENT		106'			CCI UPA-65R-LCUU-H4	LTE	RMN	RRUS-32 B30	RMN
	LENGTH, ETC.) ATC DID NOT ANALYZE ANTENNA MOUNT TO			150°	В3	CCI OPA65R-BU4DA	LTE	ADD	RRUS-4478 B14	ADD
	DETERMINE ADEQUATE					A COLDMOSED BUADA			RRUS-4449 B5/B12	ADD
	STRUCTURAL CAPACITY FOR ANY LESSEE LOADING.				B4	CCI DMP65R-BU4DA	LTE	ADD	RRUS-8843 B2/B66A	RMN
3.	ALL PROPOSED EQUIP INCLUDING				C1	CCI OPA-65R-LCUU-H4	UMTS	REL	-	-
	ANTENNAS, COAX, ETC. SHALL BE MOUNTED IN ACCORDANCE WITH				-00	001 004 650 10111 114	, , , , ,	D1 (A)	RRUS-E2 B29	ADD
	THE TOWER STRUCTURAL			.=	C2	CCI OPA-65R-LCUU-H4	LTE	RMN	RRUS-32 B30	RMN
4	ANALYSIS ON FILE WITH ATC'S CM. CONFIRM SPACING OF PROPOSED	GAMMA	106'	270°	C3	CCI OPA65R-BU4DA	LTE	ADD	RRUS-4478 B14	ADD
	EQUIP DOES NOT CAUSE TOWER					0010110000 011101			RRUS-4449 B5/B12	ADD
	CONFLICTS NOR IMPEDE TOWER CLIMBING PEGS.				C4	CCI DMP65R-BU4DA	LTE	ADD	RRUS-8843 B2/B66A	RMN
5.	POSITIONS START WITH FIRST PIPE ON THE LEFT SIDE (AS		1	1	1			1		

CABLE LENGTHS FOR JUMPERS FIBER DISTRIBUTION/SQUID TO RRU: 15' RRU TO ANTENNA: 10'

AWAY FROM ALL ANTENNAS

STATUS ABBREVIATIONS
RMV: TO BE REMOVED
RMN: TO REMAIN
REL: TO BE RELOCATED
DSC: TO BE DISCONNECTED & REMAIN
ADD: TO BE ADDED

FINAL FIBER DISTRIBUTION	/SQUID	FINAL CABLING SUMMARY					
MODEL NUMBER	STATUS	COAX	DC	FIBER	STATUS		
DC6-48-60-18-8F	RMN	(6) 1-5/8" COAX	(4) 0.78"	(2) 0.39"	RMN		
DC6-48-60-18-8F	RMN	-	-	-	-		
DC6-48-60-18-8C	ADD	-	(2) 0.78" 8AWG6	(1) 0.39"	ADD		
DC6-48-60-18-8C	ADD	-	(2) 0.78" 8AWG6	(1) 0.39"	ADD		





TOGETHER PLANNING A BETTER TOMORROW 158 BUSINESS CENTER DRIVE BIRMINGHAM, AL 35244 TEL: 205-252-6985 FAX: 205-320-1504

REV.	DESCRIPTION	BY	DATE
<u></u>	FOR CONSTRUCTION	ZDS	05/26/20
$\Lambda_{-}$	FOR CONSTRUCTION	ZDS	11/06/20
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ATC SITE NUMBER:


302469

ATC SITE NAME:

#### **BRIDGEPORT CT 2**

SITE ADDRESS: 1069 CONNECTICUT AVENUE BRIDGEPORT, CT 06607-1226




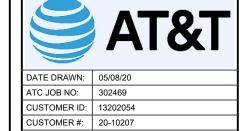


FINAL RF SCHEDULE AND ANTENNA INSTALLATION

SHEET NUMBER:


C-402

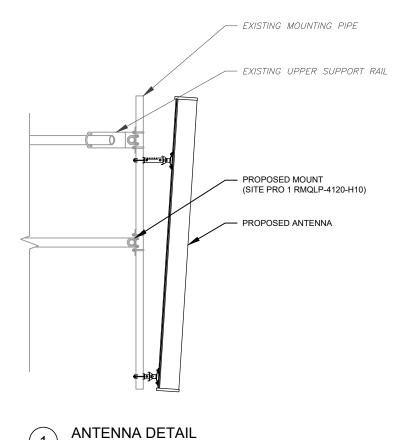

SCALE: N.T.S.

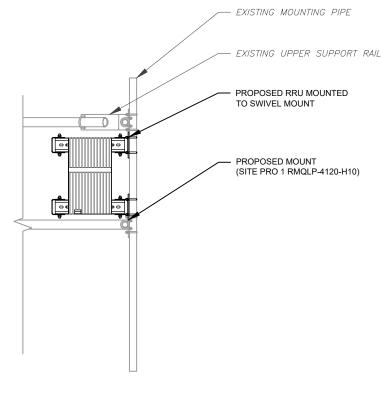



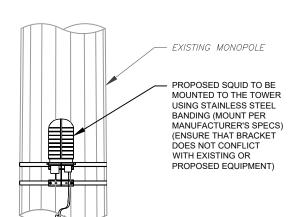

PROPOSED SQUID MOUNTING
SCALE: NOT TO SCALE





TOGETHER PLANNING A BETTER TOMORROW

158 BUSINESS CENTER DRIVE
BIRMINGHAM, AL 35244

TEL: 205-252-6985 FAX: 205-320-1504

REV.	DESCRIPTION	BY	DATE
<u> </u>	FOR CONSTRUCTION	ZDS	05/26/20
<u> </u>	FOR CONSTRUCTION	ZDS	11/06/20
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ATC SITE NUMBER:

302469

ATC SITE NAME:

#### BRIDGEPORT CT 2

SITE ADDRESS: 1069 CONNECTICUT AVENUE BRIDGEPORT, CT 06607-1226

SEAL:






	DATE DRAWN:	05/08/20
	ATC JOB NO:	302469
П	CUSTOMER ID:	13202054
	CUSTOMER #:	20-10207


# CONSTRUCTION DETAILS


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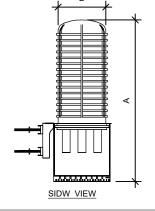
C-501

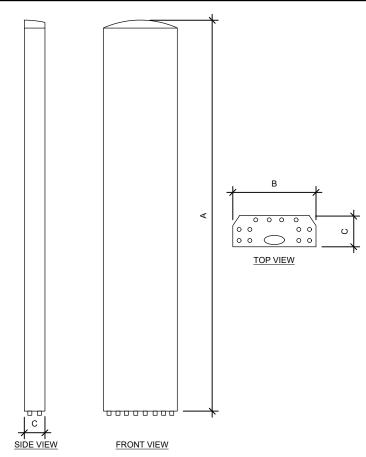


ANTENNA SPECIFICATIONS				
ANTENNA MODEL	А	В	С	WEIGHT (LBS)
CCI OPA65R-BU4DA	48.2"	21"	7.8"	52.5
CCI DMP65R-BU4DA	48.0"	20.7"	7.7"	67.9



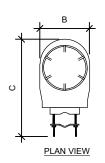

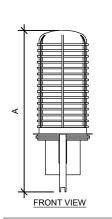

RAYCAP SPECIFICATIONS				
RAYCAP MODEL	А	В	С	WEIGHT (LBS)
DC6-48-60-18-8F	31.41"	10.24"	18.28"	16.0

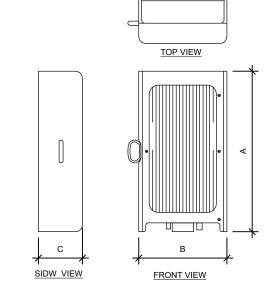

RRU SPECIFICATIONS				
RRU MODEL	А	В	С	WEIGHT (LBS)
RRUS-E2 B29	20.4"	18.5"	7.5"	60.0
4478 B14	18.1"	13.4"	8.3"	59.4
RRUS-4449 B5/B12	17.9"	13.2"	9.4"	71.0





#### NGINEERING GROUP, IN

TOGETHER PLANNING A BETTER TOMORROW

158 BUSINESS CENTER DRIVE
BIRMINGHAM, AL 35244

TEL: 205-252-6985 FAX: 205-320-1504

REV.	DESCRIPTION	BY	DATE
<u> </u>	FOR CONSTRUCTION	ZDS	05/26/20
<u>1</u>	FOR CONSTRUCTION	ZDS	11/06/20
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ATC SITE NUMBER:

302469

ATC SITE NAME:

#### **BRIDGEPORT CT 2**

SITE ADDRESS: 1069 CONNECTICUT AVENUE BRIDGEPORT, CT 06607-1226

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I	DATE DRAWN:	05/08/20
I	ATC JOB NO:	302469
I	CUSTOMER ID:	13202054
I	CUSTOMER #:	20-10207


EQUIPMENT SPECIFICATIONS

SHEET NUMBER:

REVISION:

C-502




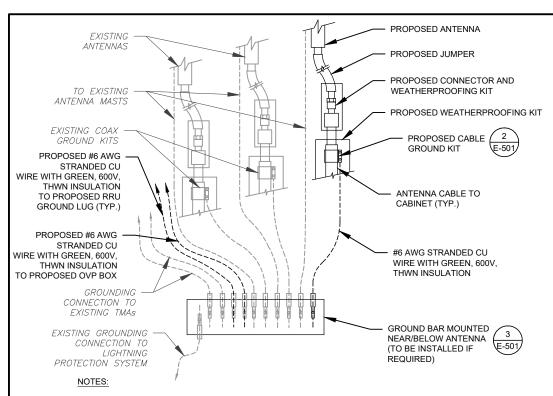

THIS DETAIL IS INTENDED TO SHOW THE GENERAL GROUNDING REQUIREMENTS. SLIGHT ADJUSTMENTS MAY BE REQUIRED BASED ON EXISTING SITE CONDITIONS. THE CONTRACTOR SHALL MAKE FIELD ADJUSTMENTS AS NEEDED AND INFORM THE CONSTRUCTION MANAGER OF ANY CONFLICTS.

SITE GROUNDING SHALL COMPLY WITH AT&T MOBILITY GROUNDING STANDARDS, LATEST EDITION, AND COMPLY WITH AT&T MOBILITY GROUNDING CHECKLIST, LATEST VERSION. WHEN NATIONAL AND LOCAL GROUNDING CODES ARE MORE STRINGENT THEY SHALL

TYPICAL ANTENNA GROUNDING DIAGRAM

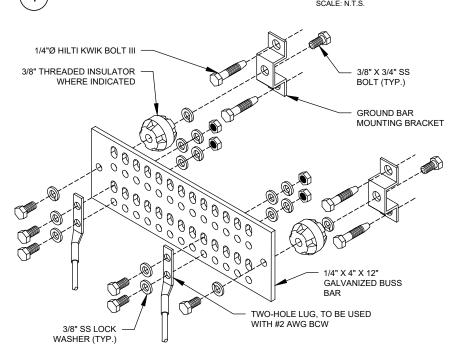


#### **GROUND BAR NOTES**

GROUND KITS COME WITH ALL HARDWARE, NUTS, BOLTS, WASHERS, ETC. EXCEPT THE STRUCTURAL MOUNTING MEMBER(S).

MAIN GROUND BAR DETAIL


2. GROUND BAR SHALL BE BOLTED TO STRUCTURAL MEMBER OR ANCHORED TO CONCRETE SLAB W/ HILTI KWIK BOLT III.




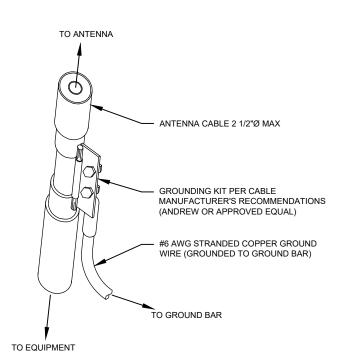

- $\frac{\text{GROUND KIT NOTES:}}{1.\quad \text{DO NOT INSTALL CABLE GROUND KIT AT A BEND AND ALWAYS DIRECT}}$ GROUND WIRE DOWN TO GROUND BAR.
- 2. CONTRACTOR SHALL PROVIDE WEATHERPROOFING KIT (ANDREW PART NUMBER 221213) AND INSTALL/TAPE PER MANUFACTURER'S SPECIFICATIONS.

## CABLE GROUND KIT CONNECTION DETAIL

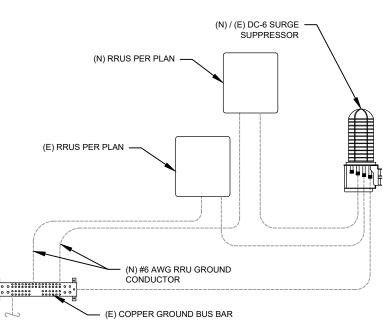


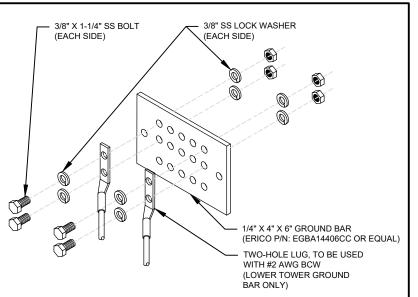

#### **GROUND BAR NOTES:**

- GROUND BAR KITS COME WITH ALL HARDWARE, NUTS, BOLTS, WASHERS, ETC. EXCEPT THE STRUCTURAL MOUNTING MEMBER(S).
- 2. GROUND BAR TO BE BONDED DIRECTLY TO TOWER.

### TOWER GROUND BAR DETAIL

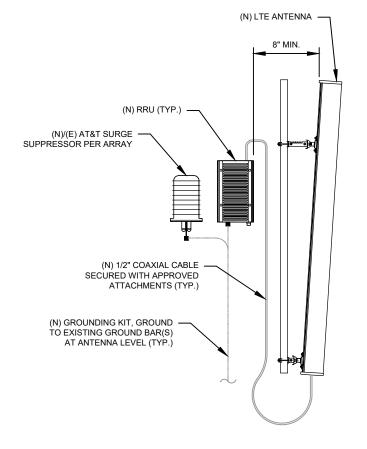

ANTENNA/RRU GROUNDING





ENGINEERING GROUP, INC. TOGETHER PLANNING A BETTER TOMORROW 158 BUSINESS CENTER DRIVE BIRMINGHAM, AL 35244

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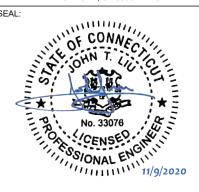
ATC SITE NUMBER:


302469

ATC SITE NAME:

#### **BRIDGEPORT CT 2**


SITE ADDRESS: 1069 CONNECTICUT AVENUE BRIDGEPORT, CT 06607-1226



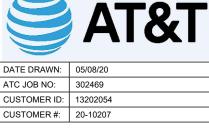

**GROUNDING DETAILS** 

E-501

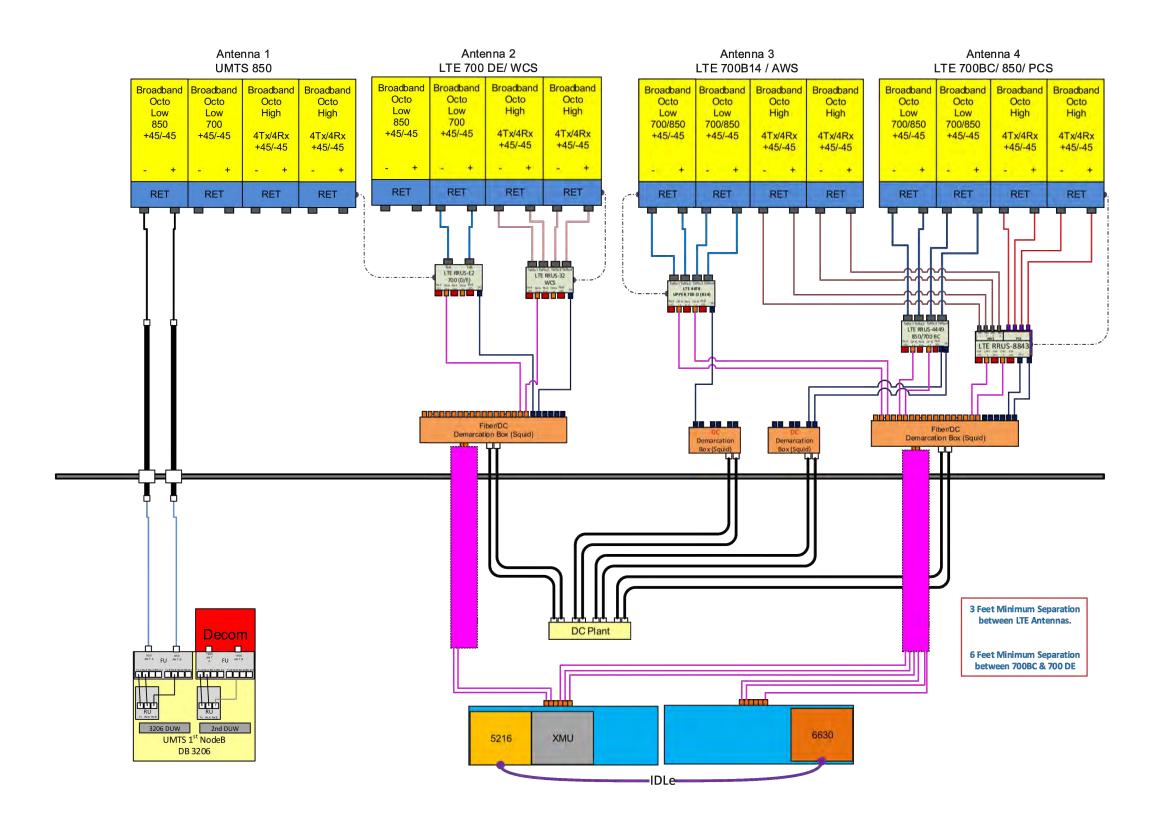







#### TOGETHER PLANNING A BETTER TOMORROW 158 BUSINESS CENTER DRIVE

BIRMINGHAM, AL 35244 TEL: 205-252-6985 FAX: 205-320-1504

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<u> </u>	FOR CONSTRUCTION	ZDS	11/06/20
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ATC SITE NUMBER:

302469

ATC SITE NAME:

#### **BRIDGEPORT CT 2**

SITE ADDRESS: 1069 CONNECTICUT AVENUE BRIDGEPORT, CT 06607-1226






	DATE DRAWN:	05/08/20
	ATC JOB NO:	302469
	CUSTOMER ID:	13202054
	CUSTOMER #:	20-10207

#### SUPPLEMENTAL

SHEET NUMBER:

NOTE: THIS SHEET CREATED BY OTHERS AND PROVIDED

BY REQUEST OF CUSTOMER WITHOUT EDIT.

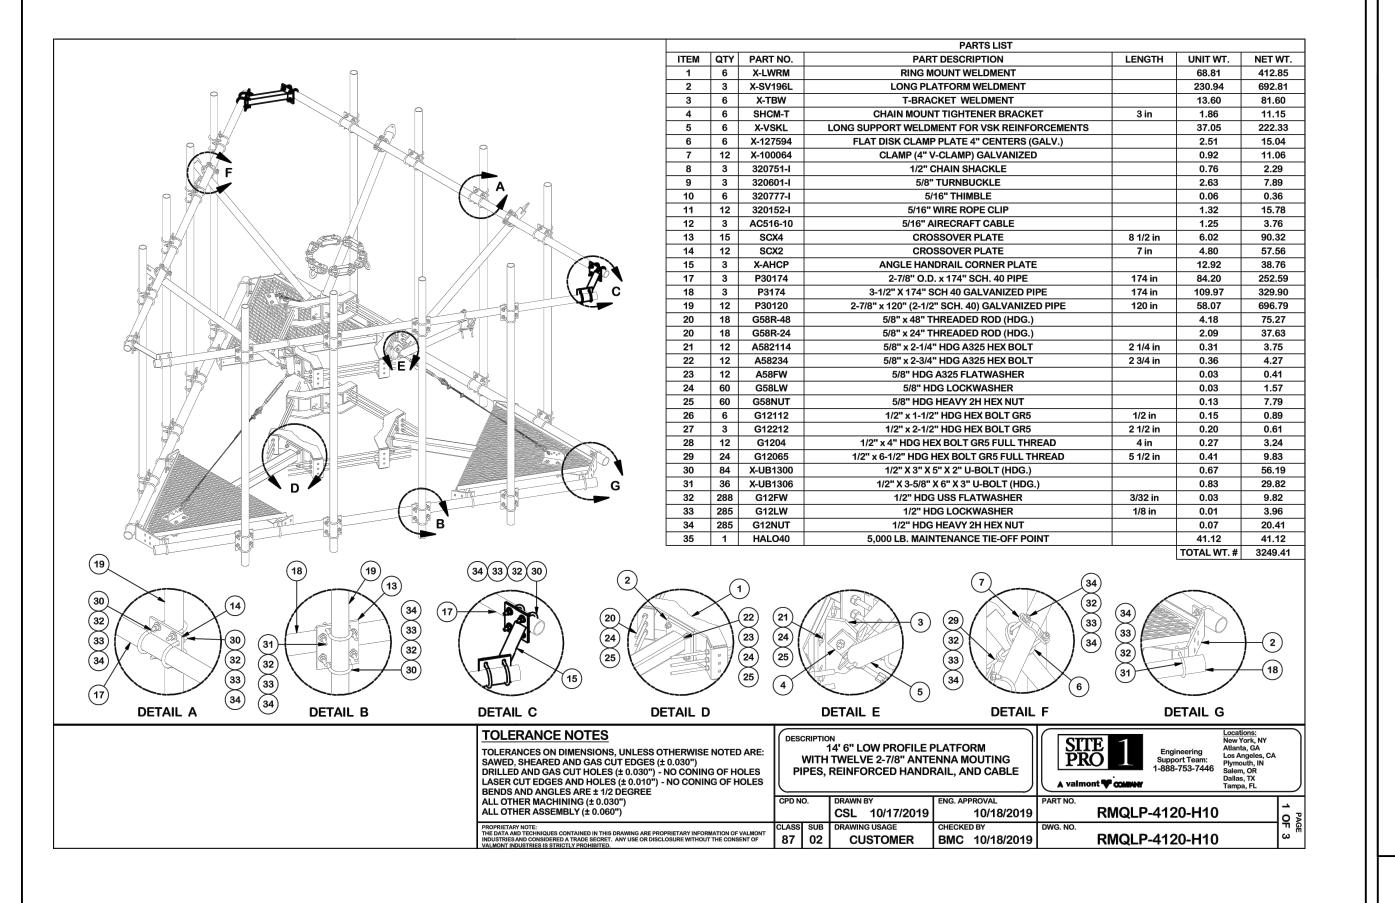

MOUNT DETAIL

SUPPLEMENTAL

SHEET NUMBER:

REVISION

R-602

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