

COMPLIANCE CODE



ATC SITE NAME: SHORT BEACH BRANFORD CT

ATC SITE NUMBER: 283422

PROJECT SUMMARY

VERIZON SITE NAME: BRANFORD SHORT BEACH

VERIZON SITE NUMBER:468083

SITE ADDRESS: 171 SHORT BEACH ROAD BRANFORD, CT 06405-4930 SITE LOCATION **LOCATION MAP**

SHEET INDEX

VERIZON 5G L-SUB6 CARRIER ADD ANTENNA AMENDMENT DRAWINGS

PROJECT DESCRIPTION

OOMI LIMITOL OODL	T TOOLOT GOIVIIVITAT	TITOULOT BLOOKII TIOIV		OHLLIMDLA			
ALL WORK SHALL BE PERFORMED AND MATERIALS INSTALLED IN ACCORDANCE WITH THE CURRENT EDITIONS OF THE FOLLOWING CODES AS ADOPTED BY THE LOCAL	SITE ADDRESS:	THE PROPOSED PROJECT INCLUDES MODIFYING GROUND BASED AND TOWER MOUNTED EQUIPMENT AS INDICATED PER	SHEET NO:	DESCRIPTION:	REV:	DATE:	BY:
GOVERNMENT AUTHORITIES. NOTHING IN THESE PLANS IS TO BE CONSTRUED TO PERMIT WORK NOT CONFORMING TO	171 SHORT BEACH ROAD	BELOW:	G-001	TITLE SHEET	0	09/17/21	BR
THESE CODES.	BRANFORD, CT 06405-4930	TOWER WORK:	G-002	GENERAL NOTES	0	09/17/21	BR
2018 CONNECTICUT STATE BUILDING CODE-AMENDMENTS TO IBC 2015	COUNTY: NEW HAVEN GEOGRAPHIC COORDINATES:	REMOVE (3) ANTENNA MOUNTS, (9) ANTENNA(s) AND (9) RRH(s) INSTALL (3) MOUNT MODIFICATIONS, (9) ANTENNA(s), (9) RRH(s)	C-101	DETAILED SITE PLAN	0	09/17/21	BR
INTERNATIONAL BUILDING CODE 2015, INTERNATIONAL	LATITUDE: 41.262788	AND (3) DIPLEXER(s)	C-201	TOWER ELEVATION	0	09/17/21	BR
CODE COUNCIL 3. TIA-222-G-4. STRUCTURAL STANDARD FOR ANTENNA	LATTIUDE: 41.202788 LONGITUDE: -72.834427	EXISTING (3) ANTENNA(s) AND (2) 6-OVP(s) TO REMAIN	C-401	ANTENNA INFORMATION & SCHEDULE	0	09/17/21	BR
SUPPORTING STRUCTURES AND ANTENNAS	GROUND ELEVATION: 59' AMSL	GROUND WORK:	C-501	CONSTRUCTION DETAILS	0	09/17/21	BR
ASCE 7-10 MINIMUM DESIGN LOADS FOR BUILDINGS AND OTHER STRUCTURES, AMERICAN SOCIETY OF CIVIL		REMOVE (2) 1-5/8" 6X12 NON-LI HYBRID CABLES INSTALL (2) 1-5/8" 6X12 LI HYBRID CABLES	E-501	GROUNDING DETAILS	0	09/17/21	BR
ENGINEERS		EXISTING (12) 1-5/8" COAX CABLES TO REMAIN	R-601	SUPPLEMENTAL SUPPLEMENTAL	0	03/11/21	
5. STEEL CONSTRUCTION MANUAL 14TH EDITION, AMERICAN INSTITUTE OF STEEL CONSTRUCTION		PROJECT NOTES					
6. CITY/COUNTY ORDINANCES		1. THE FACILITY IS UNMANNED.	R-602	SUPPLEMENTAL			
	PROJECT TEAM	A TECHNICIAN WILL VISIT THE SITE APPROXIMATELY ONCE A MONTH FOR ROUTINE INSPECTION AND MAINTENANCE.					
	TOWER OWNER: APPLICANT:	3. THE PROJECT WILL NOT RESULT IN ANY SIGNIFICANT LAND DISTURBANCE OR EFFECT OF STORM WATER DRAINAGE.					
	AMERICAN TOWER VERIZON WIRELESS	4. NO SANITARY SEWER, POTABLE WATER OR TRASH					
	10 PRESIDENTIAL WAY 118 FLANDERS ROAD WOBURN, MA 01801 WESTBOROUGH, MA 01581	DISPOSAL IS REQUIRED. 5. HANDICAP ACCESS IS NOT REQUIRED.					
UTILITY COMPANIES	WODDING, WA 01001 WESTBOROOGH, WA 01301	THE PROJECT DEPICTED IN THESE PLANS QUALIFIES AS AN ELIGIBLE FACILITIES REQUEST ENTITLED TO					
POWER COMPANY: EVERSOURCE		EXPEDITED REVIEW UNDER 47 U.S.C. 1455(A) AS A MODIFICATION OF AN EXISTING WIRELESS TOWER THAT					
PHONE: (877) 659-6326	ENGINEER:	INVOLVES THE COLLOCATION REMOVAL AND/OR REPLACEMENT OF TRANSMISSION EQUIPMENT THAT IS					
TELEPHONE COMPANY: FRONTIER COMMUNICATIONS	DEWBERRY ENGINEERS INC. 99 SUMMER ST.	NOT A SUBSTANTIAL CHANGE UNDER CFR 1.61000 (B)(7).					
PHONE: (800) 376-6843	SUITE 700	PROJECT LOCATION DIRECTIONS					
Know what's below. Call before you dig.	BOSTON, MA 02110 PROPERTY OWNER: 171 SHORT BEACH ROAD REALTY LLC. 171 SHORT BEACH RD. BRANFORD, CT 06405	FROM DOWNTOWN NEW HAVEN CT START OUT GOING NORTHEAST ON CHURCH ST TOWARD COURT ST. TAKE THE 3RD RIGHT ONTO WALL ST. TAKE THE 1ST LEFT ONTO ORANGE ST. TAKE THE 3RD RIGHT ONTO TRUMBULL ST. TURN SLIGHT LEFT TO TAKE THE 1-91 S/1-91 N RAMP. MERGE ONTO 1-91 S TOWARD 1-95/NEW LONDON/N.Y.CITY. MERGE ONTO 1-95 N/GOVERNOR JOHN DAVIS LODGE TPKE N VIA THE EXIT ON THE LEFT TOWARD NEW LONDON. TAKE THE US-1 EXIT, EXIT 53, TOWARD CT-142/CT-146/SHORT BEACH. MERGE ONTO BRANFORD CONN. TAKE THE 1ST RIGHT ONTO W MAIN ST/US-1 S. TURN LEFT ONTO CT-142/SHORT BEACH RD. 171 SHORT BEACH RD, BRANFORD, CT 06405-4930, 171 SHORT BEACH RD IS ON THE RIGHT.					





Dewberry Engineers Inc. SUITE 700 BOSTON, MA 02110 PHONE: 617.695.3400 FAX: 617.695.3310

REV.	DESCRIPTION	BY	DATE
Â	PRELIM	MR	06/01/21
<u></u>	FINAL	BR	09/17/21
$\overline{\wedge}$			
$\overline{\wedge}$			
$\overline{\wedge}$			

ATC SITE NUMBER: 283422

ATC SITE NAME: SHORT BEACH BRANFORD CT

VERIZON SITE NAME:

BRANFORD SHORT BEACH

SITE ADDRESS: 171 SHORT BEACH ROAD BRANFORD, CT 06405-4930



	DATE DRAWN:	06/01/21
	ATC JOB NO:	13668667
	CUSTOMER ID:	BRANFORD SHORT BEACH
	CUSTOMER #:	468083

TITLE SHEET

G-001

REVISION: 0

GENERAL CONSTRUCTION NOTES:

- OWNER FURNISHED MATERIALS, VERIZON "THE COMPANY" WILL PROVIDE AND THE CONTRACTOR WILL INSTALL
- A. BTS EQUIPMENT FRAME (PLATFORM) AND ICEBRIDGE SHELTER (GROUND BUILD/CO-LOCATE ONLY)
 - AC/TELCO INTERFACE BOX (PPC)
- D. TOWERS, MONOPOLES
- TOWER LIGHTING
- GENERATORS & LIQUID PROPANE TANK
- ANTENNA STANDARD BRACKETS, FRAMES AND PIPES FOR MOUNTING
- ANTENNAS (INSTALLED BY OTHERS)
- TRANSMISSION LINE
- TRANSMISSION LINE JUMPERS
- TRANSMISSION LINE CONNECTORS WITH WEATHERPROOFING KITS
- TRANSMISSION LINE GROUND KITS
- HANGERS
- HOISTING GRIPS
- O. BTS EQUIPMENT
- THE CONTRACTOR IS RESPONSIBLE TO PROVIDE ALL OTHER MATERIALS FOR THE COMPLETE INSTALLATION OF THE SITE INCLUDING, BUT NOT LIMITED TO, SUCH MATERIALS AS FENCING, STRUCTURAL STEEL SUPPORTING SUB-FRAME FOR PLATFORM, ROOFING LABOR AND MATERIALS GROUNDING RINGS GROUNDING WIRES COPPER-CLAD OR XIT CHEMICAL GROUND ROD(S), BUSS BARS, TRANSFORMERS AND DISCONNECT SWITCHES WHERE APPLICABLE, TEMPORARY ELECTRICAL POWER, CONDUIT, LANDSCAPING COMPOUND STONE, CRANES, CORE DRILLING, SLEEPERS AND RUBBER MATTING, REBAR, CONCRETE CAISSONS, PADS AND/OR AUGER MOUNTS, MISCELLANEOUS FASTENERS, CABLE TRAYS, NON-STANDARD ANTENNA FRAMES AND ALL OTHER MATERIAL AND LABOR REQUIRED TO COMPLETE THE JOB ACCORDING TO THE DRAWINGS AND SPECIFICATIONS. IT IS THE POSITION OF VERIZON TO APPLY FOR PERMITTING AND CONTRACTOR RESPONSIBLE FOR PICKUP AND PAYMENT OF REQUIRED
- ALL WORK SHALL CONFORM TO ALL CURRENT APPLICABLE FEDERAL, STATE, AND LOCAL CODES, INCLUDING ANSI/EIA/TIA-222, AND COMPLY WITH ATC CONSTRUCTION
- CONTRACTOR SHALL CONTACT LOCAL 811 FOR IDENTIFICATION OF UNDERGROUND
- CONTRACTOR SHALL BE RESPONSIBLE FOR COORDINATING ALL REQUIRED
- ALL DIMENSIONS TO, OF, AND ON EXISTING BUILDINGS, DRAINAGE STRUCTURES, AND SITE IMPROVEMENTS SHALL BE VERIFIED IN FIELD BY CONTRACTOR WITH ALL DISCREPANCIES REPORTED TO THE ENGINEER.
- DO NOT CHANGE SIZE OR SPACING OF STRUCTURAL ELEMENTS
- DETAILS SHOWN ARE TYPICAL; SIMILAR DETAILS APPLY TO SIMILAR CONDITIONS UNLESS
- THESE DRAWINGS DO NOT INCLUDE NECESSARY COMPONENTS FOR CONSTRUCTION SAFETY WHICH SHALL BE THE SOLE RESPONSIBILITY OF THE CONTRACTOR
- CONTRACTOR SHALL BRACE STRUCTURES UNTIL ALL STRUCTURAL ELEMENTS NEEDED FOR STABILITY ARE INSTALLED. THESE ELEMENTS ARE AS FOLLOWS: LATERAL BRACING,
- CONTRACTOR SHALL DETERMINE EXACT LOCATION OF EXISTING UTILITIES. GROUNDS DRAINS, DRAIN PIPES, VENTS, ETC, BEFORE COMMENCING WORK
- INCORRECTLY FABRICATED, DAMAGED, OR OTHERWISE MISFITTING OR NONCONFORMING MATERIALS OR CONDITIONS SHALL BE REPORTED TO THE VERIZON REP PRIOR TO REMEDIAL OR CORRECTIVE ACTION, ANY SUCH REMEDIAL ACTION SHALL REQUIRE WRITTEN APPROVAL BY THE VERIZON REP PRIOR TO PROCEEDING.
- EACH CONTRACTOR SHALL COOPERATE WITH THE VERIZON REP, AND COORDINATE HIS WORK WITH THE WORK OF OTHERS.
- CONTRACTOR SHALL REPAIR ANY DAMAGE CAUSED BY CONSTRUCTION OF THIS PROJECT TO MATCH EXISTING PRE-CONSTRUCTION CONDITIONS TO THE SATISFACTION
- ALL CABLE/CONDUIT ENTRY/EXIT PORTS SHALL BE WEATHERPROOFED DURING 15. INSTALLATION LISING A SILICONE SEALANT
- WHERE EXISTING CONDITIONS DO NOT MATCH THOSE SHOWN IN THIS PLAN SET. CONTRACTOR SHALL NOTIFY THE VERIZON REP AND ENGINEER OF RECORD
- CONTRACTOR SHALL ENSURE ALL SUBCONTRACTORS ARE PROVIDED WITH A COMPLETE AND CURRENT SET OF DRAWINGS AND SPECIFICATIONS FOR THIS PROJECT
- CONTRACTOR SHALL REMOVE ALL RUBBISH AND DEBRIS FROM THE SITE AT THE END OF
- CONTRACTOR SHALL COORDINATE WORK SCHEDULE WITH AMERICAN TOWER CORPORATION (ATC) AND TAKE PRECAUTIONS TO MINIMIZE IMPACT AND DISRUPTION OF OTHER OCCUPANTS OF THE FACILITY.
- CONTRACTOR SHALL FURNISH VERIZON AND AMERICAN TOWER CORPORATION (ATC) /ITH A PDF MARKED UP AS-BUILT SET OF DRAWINGS UPON COMPLETION OF WORK
- PRIOR TO SUBMISSION OF BID. CONTRACTOR SHALL COORDINATE WITH VERIZON REP TO DETERMINE WHAT, IF ANY, ITEMS WILL BE PROVIDED. ALL ITEMS NOT PROVIDED SHALL BE PROVIDED AND INSTALLED BY THE CONTRACTOR. CONTRACTOR WILL INSTALL

- 22. PRIOR TO SUBMISSION OF BID, CONTRACTOR SHALL COORDINATE WITH VERIZON REP TO DETERMINE IF ANY PERMITS WILL BE OBTAINED BY CONTRACTOR. ALL REQUIRED PERMITS NOT OBTAINED BY VERIZON MUST BE OBTAINED, AND PAID FOR, BY THE
- 23. CONTRACTOR SHALL INSTALL ALL SITE SIGNAGE IN ACCORDANCE WITH VERIZON SPECIFICATIONS AND REQUIREMENTS.
- ICE BRIDGE (CABLE TRAY WITH COVER) (GROUND BUILD/CO-LOCATE ONLY, GC TO FURNISH AND INSTALL FOR ROOFTOP INSTALLATION)

 24. CONTRACTOR SHALL SUBMIT ALL SHOP DRAWINGS TO VERIZON FOR REVIEW AND APPROVAL PRIOR TO FABRICATION.
 - ALL EQUIPMENT SHALL BE INSTALLED ACCORDING TO MANUFACTURER'S SPECIFICATIONS AND LOCATED ACCORDING TO VERIZON SPECIFICATIONS, AND AS SHOWN IN THESE PLANS
 - 26. THE CONTRACTOR SHALL SUPERVISE AND DIRECT THE PROJECT DESCRIBED HEREIN THE CONTRACTOR SHALL BE SOLELY RESPONSIBLE FOR ALL THE CONSTRUCTION MEANS, METHODS, TECHNIQUES, SEQUENCES AND PROCEDURES AND FOR COORDINATING ALL PORTIONS OF THE WORK UNDER THE CONTRACT.
 - CONTRACTOR SHALL NOTIFY VERIZON REP A MINIMUM OF 48 HOURS IN ADVANCE OF POURING CONCRETE OR BACKFILLING ANY UNDERGROUND UTILITIES, FOUNDATIONS OR SEALING ANY WALL, FLOOR OR ROOF PENETRATIONS FOR ENGINEERING REVIEW AND
 - CONTRACTOR SHALL BE RESPONSIBLE FOR SITE SAFETY INCLUDING COMPLIANCE WITH ALL APPLICABLE OSHA STANDARDS AND RECOMMENDATIONS AND SHALL PROVIDE ALL NECESSARY SAFETY DEVICES INCLUDING PPE AND PPM AND CONSTRUCTION DEVICES SUCH AS WELDING AND FIRE PREVENTION, TEMPORARY SHORING, SCAFFOLDING, TRENCH BOXES/SLOPING, BARRIERS, ETC.
 - THE CONTRACTOR SHALL PROTECT AT HIS OWN EXPENSE ALL EXISTING FACILITIES AND SUCH OF HIS NEW WORK LIABLE TO INJURY DURING THE CONSTRUCTION PERIOD. ANY DAMAGE CAUSED BY NEGLECT ON THE PART OF THIS CONTRACTOR OR HIS REPRESENTATIVES, OR BY THE ELEMENTS DUE TO NEGLECT ON THE PART OF THIS CONTRACTOR OR HIS REPRESENTATIVES, EITHER TO THE EXISTING WORK, OR TO HIS WORK OR THE WORK OF ANY OTHER CONTRACTOR, SHALL BE REPAIRED AT HIS EXPENSE TO THE OWNER'S SATISFACTION.
 - ALL WORK SHALL BE INSTALLED IN A FIRST CLASS, NEAT AND WORKMANLIKE MANNER BY MECHANICS SKILLED IN THE TRADE INVOLVED. THE QUALITY OF WORKMANSHIP SHALL BE SUBJECT TO THE APPROVAL OF THE VERIZON REP. ANY WORK FOUND BY THE VERIZON REP TO BE OF INFERIOR QUALITY AND/OR WORKMANSHIP SHALL BE REPLACED AND/OR REWORKED AT CONTRACTOR EXPENSE UNTIL APPROVAL IS
 - 31. IN ORDER TO ESTABLISH STANDARDS OF QUALITY AND PERFORMANCE, ALL TYPES OF MATERIALS LISTED HEREINAFTER BY MANUFACTURER'S NAMES AND/OR
 MANUFACTURER'S CATALOG NUMBER SHALL BE PROVIDED BY THESE MANUFACTURERS
 - VERIZON FURNISHED EQUIPMENT SHALL BE PICKED-UP AT THE VERIZON WAREHOUSE. NO LATER THAN 48HR AFTER BEING NOTIFIED INSURED, STORED, UNCRATE, PROTECTED AND INSTALLED BY THE CONTRACTOR WITH ALL APPURTENANCES REQUIRED TO PLACE THE EQUIPMENT IN OPERATION, READY FOR USE. THE CONTRACTOR SHALL BE RESPONSIBLE FOR THE EQUIPMENT AFTER PICKING IT UP.
 - VERIZON OR HIS ARCHITECT/ENGINEER RESERVES THE RIGHT TO REJECT ANY 33. EQUIPMENT OR MATERIALS WHICH, IN HIS OWN OPINION ARE NOT IN COMPLIANCE WITH THE CONTRACT DOCUMENTS, EITHER BEFORE OR AFTER INSTALLATION AND THE EQUIPMENT SHALL BE REPLACED WITH EQUIPMENT CONFORMING TO THE REQUIREMENTS OF THE CONTRACT DOCUMENTS BY THE CONTRACTOR AT NO COST TO VERIZON OR THEIR ARCHITECT/ENGINEER

SPECIAL CONSTRUCTION ANTENNA INSTALLATION NOTES:

- WORK INCLUDED:
 - ANTENNA AND COAXIAL CABLES ARE FURNISHED BY VERIZON UNDER A SEPARATE CONTRACT. THE CONTRACTOR SHALL ASSIST ANTENNA INSTALLATION CONTRACTOR IN TERMS OD COORDINATION AND SITE ACCESS.
 ERECTION SUBCONTRACTOR SHALL BE RESPONSIBLE FOR THE PROTECTION OF
 - B. INSTALL ANTENNA AS INDICATE ON DRAWINGS AND VERIZON SPECIFICATIONS
 - C. INSTALL GALVANIZED STEEL ANTENNA MOUNTS AS INDICATED ON DRAWINGS
 - D. INSTALL FURNISHED GALVANIZED STEEL OR ALUMINUM WAVEGUIDE
 - CONTRACTOR SHALL PROVIDE FOUR (4) SETS OF SWEEP TESTS USING ANRITZU-PACKARD 8713B RF SCALAR NETWORK ANALYZER, SUBMIT FREQUENCY DOMAIN REFLECTOMETER(FDR) TESTS RESULTS TO THE PROJECT MANAGER. SWEEP TESTS SHALL BE AS PER ATTACHED RFS "MINIMUM FIELD TESTING RECOMMENDED FOR ANTENNA AND HELIAX COAXIAL CABLE SYSTEMS" DATED 10/5/93 TESTING SHALL BE PERFORMED BY AN INDEPENDENT TESTING SERVICE AND BE BOUND AND SUBMITTED WITHIN ONE WEEK OF WORK COMPLETION.
 - INSTALL COAXIAL CABLES AND TERMINATING BETWEEN ANTENNAS AND EQUIPMENT PER MANUFACTURER'S RECOMMENDATIONS, WEATHERPROOF ALL CONNECTIONS BETWEEN THE ANTENNA AND EQUIPMENT PER MANUFACTURER'S REQUIREMENTS. TERMINATE ALL COAXIAL CABLE THREE (3) FEET IN EXCESS OF ENTRY PORT LOCATION UNLESS OTHERWISE STATED.
 - G ANTENNA AND COAXIAL CABLE GROUNDING:
- ALL EXTERIOR #6 GREED GROUND WIRE "DAISY CHAIN" CONNECTIONS ARE TO BE WEATHER SEALED WITH RFS CONNECTORS/SPLICE WEATHERPROOFING KIT #221213 OR
- ALL COAXIAL CABLE GROUNDING KITS ARE TO BE INSTALLED ON STRAIGHT RUNS OF

AMERICAN TOWER®



99 SUMMER STREET SUITE 700 BOSTON, MA 02110 PHONE: 617.695.3400 FAX: 617.695.3310

DESCRIPTION	BY	DATE
PRELIM	MR	06/01/21
FINAL	BR	09/17/21
	PRELIM	PRELIM MR

ATC SITE NUMBER: 283422

ATC SITE NAME: SHORT BEACH BRANFORD CT

VERIZON SITE NAME:

BRANFORD SHORT BEACH

SITE ADDRESS: 171 SHORT BEACH ROAD BRANFORD, CT 06405-4930

DATE DRAWN:	06/01/21
ATC JOB NO:	13668667
CUSTOMER ID:	BRANFORD SHORT BEACH
CUSTOMER #:	468083

GENERAL NOTES

SHEET NUMBER:

REVISION

G-002

ALL DISCREPANCIES FROM WHAT IS SHOWN ON THESE

CONSTRUCTION DRAWINGS SHALL BE COMMUNICATED TO ATC

FAILURE TO COMMUNICATE DIRECTLY WITH ATC ENGINEERING OR

ANY CHANGES FROM THE DESIGN CONDUCTED WITHOUT PRIOR

APPROVAL FROM ATC ENGINEERING SHALL BE THE SOLE RESPONSIBILITY OF THE GENERAL CONTRACTOR.

ENGINEERING IMMEDIATELY FOR CORRECTION OR RE-DESIGN.

SITE PLAN NOTES:


- THIS SITE PLAN REPRESENTS THE BEST PRESENT KNOWLEDGE
 AVAILABLE TO THE ENGINEER AT THE TIME OF THIS DESIGN. THE
 CONTRACTOR SHALL VISIT THE SITE PRIOR TO CONSTRUCTION AND
 VERIFY ALL EXISTING CONDITIONS RELATED TO THE SCOPE OF
 WORK FOR THIS PROJECT.
- 2. ICE BRIDGE, CABLE LADDER, COAX PORT, AND COAX CABLE ARE SHOWN FOR REFERENCE ONLY. CONTRACTOR SHALL CONFIRM THE EXACT LOCATION OF ALL PROPOSED AND EXISTING EQUIPMENT AND STRUCTURES DEPICTED ON THIS PLAN. BEFORE UTILIZING EXISTING CABLE SUPPORTS, COAX PORTS, INSTALLING NEW PORTS OR ANY OTHER EQUIPMENT, CONTRACTOR SHALL VERIFY ALL ASPECTS OF THE COMPONENTS MEET THE ATC SPECIFICATIONS
- 3. NO ELECTRICAL SCOPE IS INCLUDED IN THIS PROJECT.

LEGEND GROUNDING TEST WELL ATS AUTOMATIC TRANSFER SWITCH BOLLARD CSC CELL SITE CABINET DISCONNECT ELECTRICAL FIBER GEN GENERATOR GENERATOR RECEPTACAL G HH. V HAND HOLE, VAULT ICE BRIDGE KENTROX BOX LC LIGHTING CONTROL METER РΒ PULL BOX PΡ POWER POLE TELCO TRN TRANSFORMER

CHAINLINK FENCE

PROPOSED CABLE LENGTH:

- ESTIMATED LENGTH OF PROPOSED CABLE IS 132'. ESTIMATED LENGTH OF CABLE WAS PROVIDED BY CUSTOMER OR CALCULATED BY ADDING THE RAD CENTER AND THE DISTANCE FROM THE SHELTER ENTRY PLATE TO THE TOWER (ALONG THE ICE BRIDGE) AND A SAFETY FACTOR MEASUREMENT OF 15% (OF THE TWO PREVIOUS VALUES), CDS DEFER TO GREATEST CABLE LENGTH.
- 2. ROUTE PROPOSED CABLES ALONG SAME PATH AS EXISTING CABLES AND IN ACCORDANCE WITH STRUCTURAL ANALYSIS. IF ADEQUATE SPACE EXISTS, ROUTE CABLES THROUGH ENTRY PORT HOLE, UP INSIDE OF MONOPOLE, AND THROUGH EXIT PORT HOLE. IF ROUTING OUTSIDE THE MONOPOLE, ATTACH CABLES USING STAND-OFF ADAPTERS MOUNTED TO TOWER USING STAINLESS STEEL BANDING. ADEQUATELY SECURE CABLES USING EITHER APPROPRIATELY SIZED STAINLESS STEEL SNAP-INS OR MOUNTING HARDWARE AND BRACKETS AS SPECIFIED BY CABLE MANUFACTURER.

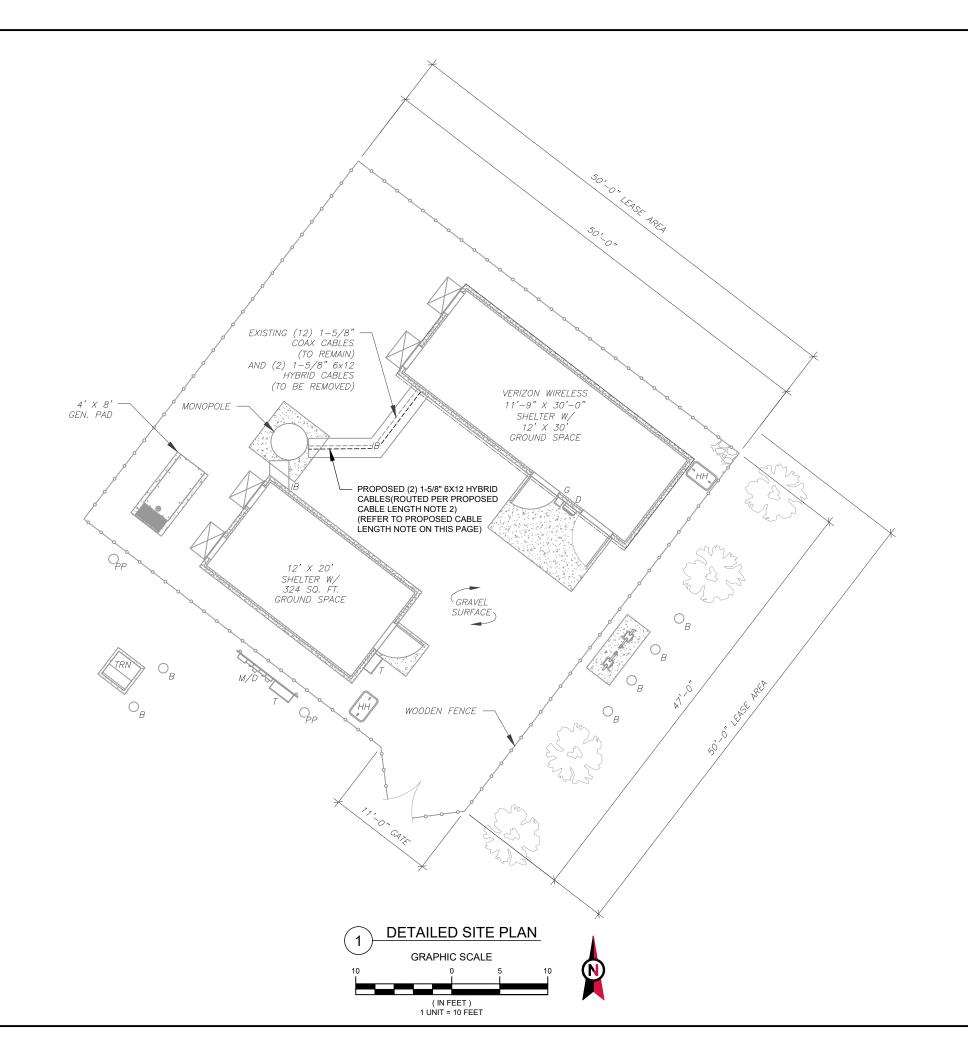





Dewberry Engineers Inc.
99 SUMMER STREET
SUITE 700
BOSTON, MA 02110
PHONE: 617.695.3400
FAX: 617.695.3310

REV	. DESCRIPTION	BY	DATE
\triangle	PRELIM	MR	06/01/21
<u> </u>	FINAL	BR	09/17/21
\triangle			
$\overline{\wedge}$			
$\overline{\wedge}$			
_		-	

ATC SITE NUMBER: 283422

ATC SITE NAME:
SHORT BEACH BRANFORD CT

VERIZON SITE NAME:

BRANFORD SHORT BEACH

SITE ADDRESS: 171 SHORT BEACH ROAD BRANFORD, CT 06405-4930

SEAL:

28971
CENSE CONAL ENGINE

verizon /


DATE DRAWN:	06/01/21
ATC JOB NO:	13668667
CUSTOMER ID:	BRANFORD SHORT BEACH
CUSTOMER #:	468083
	ATC JOB NO: CUSTOMER ID:

DETAILED SITE PLAN

SHEET NUMBER:

C-101

REVISION

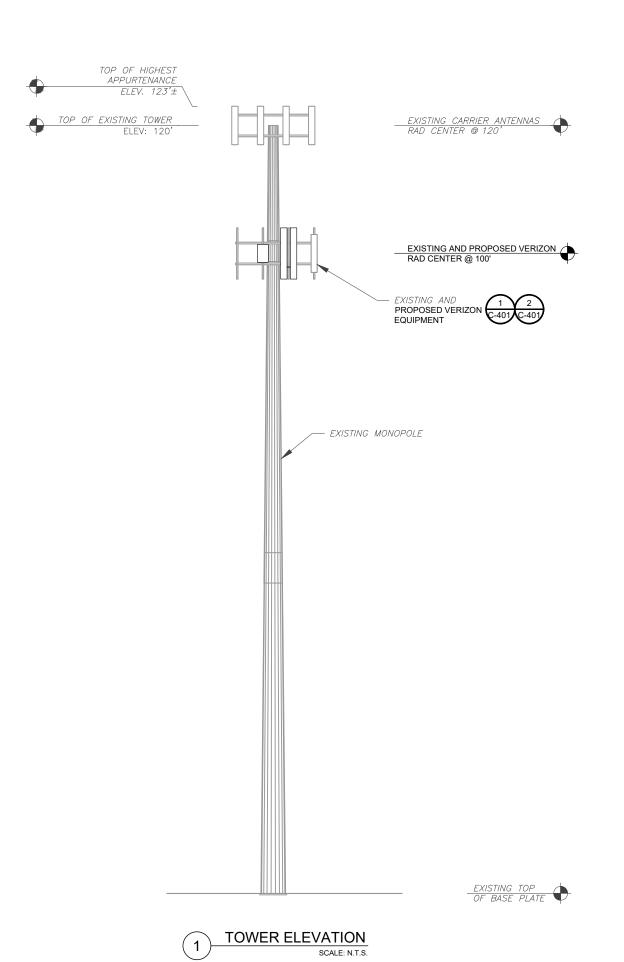

PER MOUNT ANALYSIS COMPLETED BY MASER CONSULTING CONNECTICUT, DATED 05/04/2021 THE EXISTING MOUNT CAN ADEQUATELY SUPPORT THE PROPOSED LOADING.

- TOWER NOTE:

 1. IT IS THE CONTRACTOR'S RESPONSIBILITY TO CONFIRM WITH THE PROJECT MANAGER THAT THEY HAVE THE MOST RECENT VERSION OF THE STRUCTURAL ANALYSIS BEFORE COMMENCING WORK. EXISTING AND PROPOSED TOWER APPURTENANCES, MOUNTS, AND ANTENNAS ARE SHOWN BASED ON THE STRUCTURAL ANALYSIS.
- 2. WHERE APPLICABLE, ALL NEW ANTENNAS, EQUIPMENT, MOUNTS, CABLING, ETC. SHALL BE PAINTED/SOCKED TO MATCH EXISTING EQUIPMENT IN ACCORDANCE WITH FAA, JURISDICTION, AND/OR OTHER LOCAL REQUIREMENTS.
- ROUTE PROPOSED CABLES ALONG SAME PATH AS EXISTING CABLES AND IN ACCORDANCE WITH STRUCTURAL ANALYSIS. IF ADEQUATE SPACE EXISTS, ROUTE CABLES THROUGH ENTRY PORT HOLE, UP INSIDE OF MONOPOLE, AND THROUGH EXIT PORT HOLE. IF ROUTING OUTSIDE THE MONOPOLE, ATTACH CABLES USING STAND-OFF ADAPTERS MOUNTED TO TOWER USING STAINLESS STEEL BANDING. ADEQUATELY SECURE CABLES USING EITHER APPROPRIATELY SIZED STAINLESS STEEL SNAP-INS OR MOUNTING HARDWARE AND BRACKETS AS SPECIFIED BY CABLE MANUFACTURER.
- 4. TOWER ELEVATIONS ARE MEASURED FROM TOP OF BASE PLATE TO MATCH STRUCTURAL ANALYSIS. ELEVATIONS DO NOT REFLECT TRUE ABOVE GROUND LEVEL (A.G.L.)





Dewberry Engineers Inc. 99 SUMMER STREET SUITE 700 BOSTON, MA 02110 PHONE: 617.695.3400 FAX: 617.695.3310

EV.	DESCRIPTION	BY	DATE
Â.	PRELIM	MR	06/01/21
6	FINAL	BR	09/17/21
$\overline{\wedge}$			
$\overline{\wedge}$			
$\overline{\wedge}$			
		-	

ATC SITE NUMBER: 283422

ATC SITE NAME: SHORT BEACH BRANFORD CT

VERIZON SITE NAME:

BRANFORD SHORT BEACH

SITE ADDRESS: 171 SHORT BEACH ROAD BRANFORD, CT 06405-4930




	DATE DRAWN:	06/01/21
	ATC JOB NO:	13668667
	CUSTOMER ID:	BRANFORD SHORT BEACH
	CUSTOMER #:	468083


DETAILED SITE PLAN

SHEET NUMBER:

C-201

REVISION

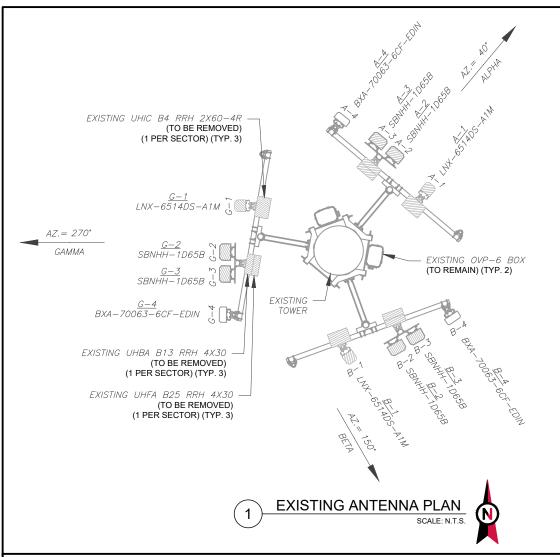

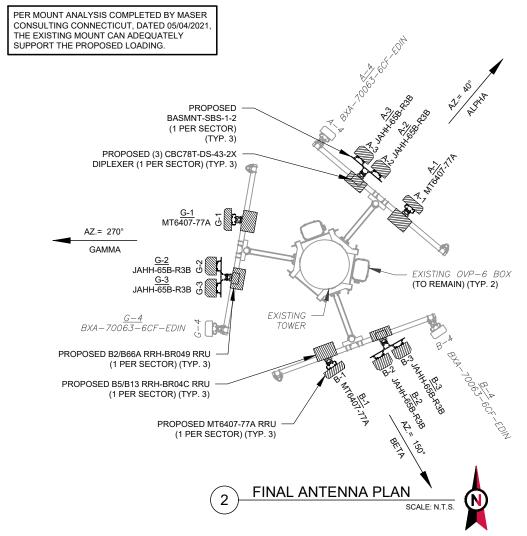

	EXISTING ANTENNA SCHEDULE							NOTES					FINAL ANTENNA SCH	EDULE											
LOCATIO	N			ANTE	NNA SUMMARY			NON ANTENNA SUMMA	ARY	CONFIRM WITH VERIZON REP	LO	CATION		AN	ITENNA SUMMARY			NON ANTENNA SUMM	MARY						
SECTOR RAD	AZ	Z PC	os	ANTENNA	BAND	MECH/ELEC D-TILT	STATUS	ADDITIONAL TOWER MOUNTED EQUIPMENT	STATUS	FOR APPLICABLE UPDATES/REVISIONS AND MOST RECENT RFDS FOR NSN	SECTOR	RAD	AZ PO	S ANTENNA	BAND	MECH/ELEC D-TILT	STATUS	ADDITIONAL TOWER MOUNTED EQUIPMENT	STATUS						
		Α	.1	LNX-6514DS-A1M	_	_	RMV	UHIC B4 RRH 2X60-4R	RMV	CONFIGURATION (CONFIG). GC TO CAP ALL UNUSED PORTS.			Α	1 MT6407-77A	L-SUB6	0/6	ADD	B5/B13 RRH-BR04C	ADD						
AL DUA 100	, ,,	. A	2	SBNHH-1D65B	700/1900/AWS	0/6,4,4	RMV	UHBA B13 RRH 4X30	RMV	2. CONFIRM SPACING OF									Α	2 JAHH-65B-R3B	700/850/1900/AWS	0/6,6,4,4	ADD	B2/B66A RRH-BR049	ADD
ALPHA 100	40	' A	3	SBNHH-1D65B	700/1900/AWS	0/6,4,4	RMV	UHFA B25 RRH 4X30	RMV	PROPOSED EQUIP DOES NOT CAUSE TOWER CONFLICTS	ALPHA	100'	40° 🔼	IALILI GED DOD	700/050/4000/4140	0/6,6,4,4	ADD	-	-						
		Α	4	BXA-70063-6CF-EDIN	_	-	RMN	_	_	NOR IMPEDE TOWER CLIMBING			A3	3 JAHH-65B-R3B	700/850/1900/AWS	0/6,6,4,4	ADD	CBC78T-DS-43-2X	ADD						
		В	1	LNX-6514DS-A1M	_	_	RMV	UHIC B4 RRH 2X60-4R	RMV	PEGS.			Α	BXA-70063-6CF-EDIN	-	-	RMN	-	-						
DETA 100	, 150	, B	2	SBNHH-1D65B	700/1900/AWS	0/6,4,4	RMV	UHBA B13 RRH 4X30	RMV	STATUS ARRDEVIATIONS		В	1 MT6407-77A	L-SUB6	0/6	ADD	B5/B13 RRH-BR04C	ADD							
BETA 100	150	B	3	SBNHH-1D65B	700/1900/AWS	0/6,4,4	RMV	UHFA B25 RRH 4X30	RMV		STATUS ABBREVIATIONS			В	2 JAHH-65B-R3B	700/850/1900/AWS	0/6,6,4,4	ADD	B2/B66A RRH-BR049	ADD					
		В	4	BXA-70063-6CF-EDIN	-	_	RMN	_	-	RMV: TO BE REMOVED	BETA	BETA	BETA 100' 15	50° B	3 JAHH-65B-R3B	700/850/1900/AWS	0/6,6,4,4	ADD	-	-					
		С	1	LNX-6514DS-A1M	-	_	RMV	UHIC B4 RRH 2X60-4R	RMV	RMN: TO REMAIN	RMN: TO REMAIN REL: TO BE RELOCATED			Ľ	0AHH-00B-10B	700/030/1300/AVV0	0/0,0,1,1	ADD	CBC78T-DS-43-2X	ADD					
	, , , ,	C.		SBNHH-1D65B	700/1900/AWS	0/2,2,4	RMV	UHBA B13 RRH 4X30	RMV	ADD: TO BE ADDED			В	BXA-70063-6CF-EDIN	-	-	RMN	-	-						
GAMMA 100	2/0	C	3	SBNHH-1D65B	700/1900/AWS	0/2,2,4	RMV	UHFA B25 RRH 4X30	RMV				C	1 MT6407-77A	L-SUB6	0/6	ADD	B5/B13 RRH-BR04C	ADD						
		C	4	BXA-70063-6CF-EDIN	_	_	RMN	_	_				С	2 JAHH-65B-R3B	700/850/1900/AWS	0/2,2,2,4	ADD	B2/B66A RRH-BR049	ADD						
'	-					1		1		CABLE LENGTHS FOR JUMPERS G	GAMMA	GAMMA 100' 270°	GAMMA 100' 270°		LALILL OFF FOR	700/050/4000/414/0	0/2,2,2,4	400	-	-					
										JUNCTION BOX TO RRU: 15'			C	3 JAHH-65B-R3B	700/850/1900/AWS	0/2,2,2,4	ADD	CBC78T-DS-43-2X	ADD						
										RRU TO ANTENNA: 10'			С	BXA-70063-6CF-EDIN	-	-	RMN	-	-						

EXISTING FIBER DISTRIBUTION/O	/P BOX	EXISTING CABLING SUMMARY			
MODEL NUMBER STATUS		COAX	HYBRID	STATUS	
(2) DB-T1-6Z-8AB-0Z	RMN	-	(2) 1-5/8" 6X12 NON LI	RMV	
		(12) 1-5/8"	ı	RMN	

(3) EQUIPMENT SCHEDULES

FINAL FIBER DISTRIBUTION / OV	Р ВОХ	FINAL CABLING SUMMARY					
MODEL NUMBER	STATUS	COAX	HYBRID	STATUS			
(2) DB-T1-6Z-8AB-0Z	RMN	(12) 1-5/8"	-	RMN			
-	-	-	(2) 1-5/8" 6X12 LI	ADD			





Dewberry Engineers Inc.
99 SUMMER STREET
SUITE 700
BOSTON, MA 02110
PHONE: 617.695.3400
FAX: 617.695.3310

REV.	DESCRIPTION	BY	DATE
\mathbb{A}_{-}	PRELIM	MR	06/01/21
△_	FINAL	BR	09/17/21
\wedge			
$\overline{\wedge}$			
$\overline{\wedge}$			

ATC SITE NUMBER: 283422

ATC SITE NAME:
SHORT BEACH BRANFORD CT

VERIZON SITE NAME:

BRANFORD SHORT BEACH

SITE ADDRESS: 171 SHORT BEACH ROAD BRANFORD, CT 06405-4930




verizon[/]


DATE DRAWN:	06/01/21
ATC JOB NO:	13668667
CUSTOMER ID:	BRANFORD SHORT BEACH
CUSTOMER #:	468083
	ATC JOB NO: CUSTOMER ID:


ANTENNA INFORMATION & SCHEDULE

SHEET NUMBER:

REVISION:

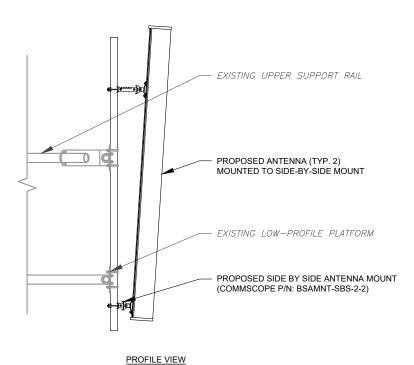

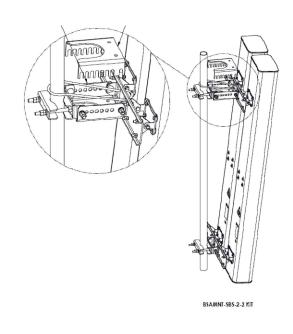


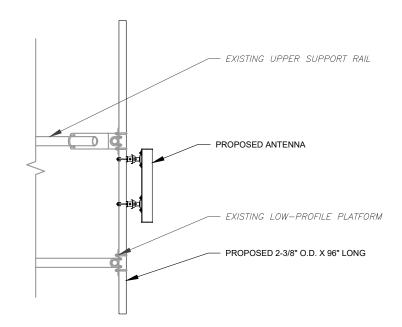

ISOMETRIC VIEW (BY MANUFACTURER)

1 PROPOSED SIDE-BY-SIDE MOUNT
SCALE: NOT TO SCALE

PROPOSED 5G ANTENNA MOUNTING DETAIL - TYPICAL

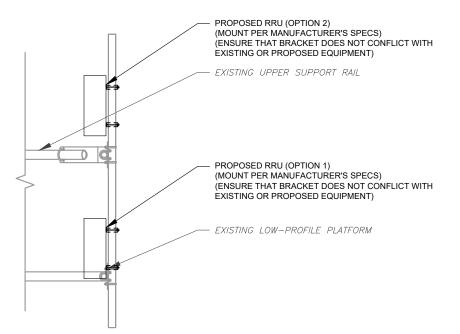

3 PROPOSED RRU MOUNTING DETAIL - TYPICAL SCALE: N.T.S.





Dewberry Engineers Inc.

99 SUMMER STREET
SUITE 700
BOSTON, MA 02110
PHONE: 617.695.3400
FAX: 617.695.3310

REV.	DESCRIPTION	BY	DATE
<u> </u>	PRELIM		06/01/21
<u> </u>	FINAL	BR	09/17/21
\wedge			
$\overline{\wedge}$			
$\overline{\wedge}$			

ATC SITE NUMBER: 283422

ATC SITE NAME:
SHORT BEACH BRANFORD CT

VERIZON SITE NAME:

BRANFORD SHORT BEACH

SITE ADDRESS: 171 SHORT BEACH ROAD BRANFORD, CT 06405-4930





	DATE DRAWN:	06/01/21
	ATC JOB NO:	13668667
	CUSTOMER ID:	BRANFORD SHORT BEACH
	CUSTOMER #:	468083


CONSTRUCTION DETAILS

SHEET NUMBER:

C-501


0

REVISION:

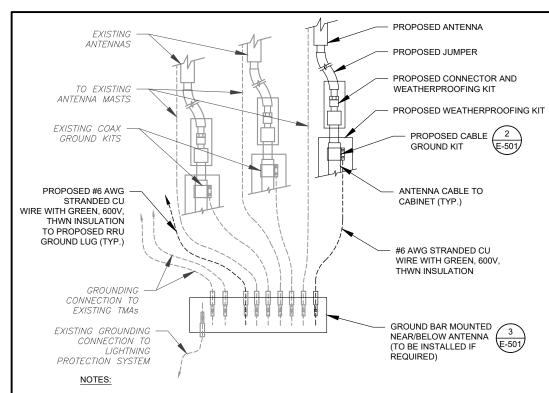

- 1. THIS DETAIL IS INTENDED TO SHOW THE GENERAL GROUNDING REQUIREMENTS. SLIGHT ADJUSTMENTS MAY BE REQUIRED BASED ON EXISTING SITE CONDITIONS. THE CONTRACTOR SHALL MAKE FIELD ADJUSTMENTS AS NEEDED AND INFORM THE CONSTRUCTION MANAGER OF ANY CONFLICTS.
- 2. SITE GROUNDING SHALL COMPLY WITH VERIZON GROUNDING STANDARDS, LATEST EDITION, AND COMPLY WITH VERIZON GROUNDING CHECKLIST, LATEST VERSION. WHEN NATIONAL AND LOCAL GROUNDING CODES ARE MORE STRINGENT THEY SHALL GOVERN.



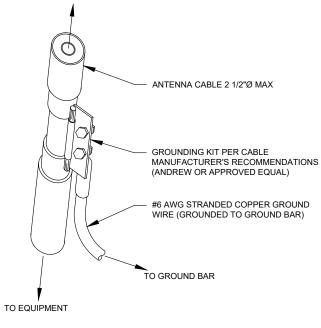


GROUND KIT NOTES:

1. DO NOT INSTALL CABLE GROUND KIT AT A BEND AND ALWAYS DIRECT GROUND WIRE DOWN TO GROUND BAR.

TO ANTENNA

2. CONTRACTOR SHALL PROVIDE WEATHERPROOFING KIT (ANDREW PART NUMBER 221213) AND INSTALL/TAPE PER MANUFACTURER'S SPECIFICATIONS.

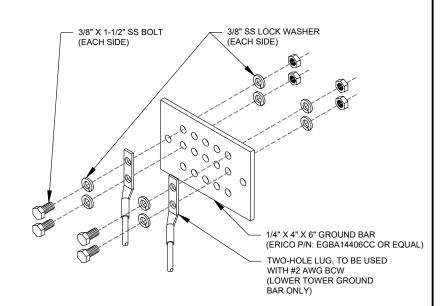

GROUND BAR NOTES:

- GROUND BAR KITS COME WITH ALL HARDWARE, NUTS, BOLTS, WASHERS, ETC. EXCEPT THE STRUCTURAL MOUNTING MEMBER(S).
- 2. GROUND BAR TO BE BONDED DIRECTLY TO TOWER.







Dewberry Engineers Inc. 99 SUMMER STREET SUITE 700 BOSTON, MA 02110 PHONE: 617.695.3400 FAX: 617.695.3310

REV.	DESCRIPTION	BY	DATE
<u> </u>	PRELIM	MR	06/01/21
<u> </u>	FINAL	BR	09/17/21
$\overline{\wedge}$			
$\overline{\wedge}$			
$\overline{\wedge}$			

ATC SITE NUMBER: 283422

ATC SITE NAME: SHORT BEACH BRANFORD CT

VERIZON SITE NAME:

BRANFORD SHORT BEACH

SITE ADDRESS: 171 SHORT BEACH ROAD BRANFORD, CT 06405-4930




	DATE DRAWN:	06/01/21
	ATC JOB NO:	13668667
	CUSTOMER ID:	BRANFORD SHORT BEACH
	CUSTOMER #:	468083
		ATC JOB NO: CUSTOMER ID:

GROUNDING DETAILS

SHEET NUMBER:


REVISION: E-501

CABLE GROUND KIT CONNECTION DETAIL

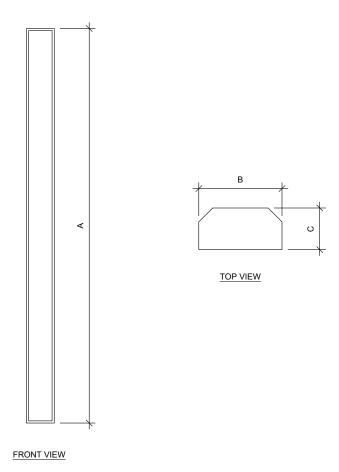

1 ANTENNA SPECIFICATIONS FOR ILLUSTRATIVE PURPOSES ONLY - NOT TO SCALE

ANTENN	IA SPECIFIC	ATIONS		
ANTENNA MODEL	А	В	С	WEIGHT (LBS)
MT6407-77A	35.1"	16.1"	5.5"	81.6
JAHH-65B-R2B	72.0"	13.8"	8.2"	60.6

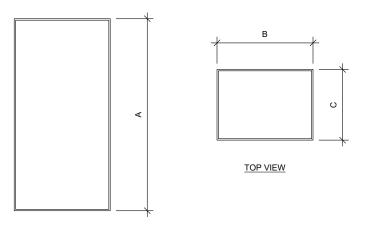

FRONT VIEW

2 RRU/DIPLEXER SPECIFICATIONS FOR ILLUSTRATIVE PURPOSES ONLY - NOT TO SCALE

RRU SPECIFICATIONS				
RRU MODEL	А	В	С	WEIGHT (LBS)
B2/B66A RRH-BR049	15.0"	15.0"	10.0"	84.4
B5/B13 RRH-BR04C	15.0"	15.0"	8.1"	70.3
MT6407-77A	35.1"	16.1"	5.5"	81.6
CBC78T-DS-43-2X	9.6"	6.9"	6.4"	20.7





Dewberry Engineers Inc.
99 SUMMER STREET
SUITE 700
BOSTON, MA 02110
PHONE: 617.695.3400
FAX: 617.695.3310

REV.	DESCRIPTION	BY	DATE
\triangle			
$\overline{\wedge}$			
<u></u>			

ATC SITE NUMBER: 283422

ATC SITE NAME:
SHORT BEACH BRANFORD CT

VERIZON SITE NAME:

BRANFORD SHORT BEACH

SITE ADDRESS: 171 SHORT BEACH ROAD BRANFORD, CT 06405-4930

SEAL:

	/
var	izon [/]

	DATE DRAWN:	06/01/21	
	ATC JOB NO:	13668667	
ı		CUSTOMER ID:	BRANFORD SHORT BEACH
ı		CUSTOMER #:	468083

SUPPLEMENTAL

SHEET NUMBER:

REVISION:

R-601





Maser Consulting Connecticut 2000 Midlantic Drive, Suite 100 Mt. Laurel, NJ 08054 856.797.0412 Peter.Albano@colliersengineering.com

Antenna Mount Analysis Report and PMI Requirements

Mount Analysis

SMART Tool Project #: 10050357 Maser Consulting Connecticut Project #: 21777425A

May 4, 2021

468083-VZW / BRANFORD SHORT BEACH CT Site Information Site ID:

Site Name: BRANFORD SHORT BEACH CT

Carrier Name: Verizon Wireless Address:

171 Short Beach Rd Branford, Connecticut 06405

New Haven County

41.262789° Latitude: Longitude: -72.834428°

120.00-Ft Monopole Tower Type: Structure Information 12.50-Ft Platform

Mount Type:

FUZE ID # 16227623

Analysis Results

Platform: 66.9% Pass

***Contractor PMI Requirements: Included at the end of this MA report Available & Submitted via portal at https://pmi.vzwsmart.com Contractor - Please Review Specific Site PMI Requirements Upon Award Requirements also Noted on Mount Modification Drawings Requirements may also be Noted on A & E drawings

Report Prepared By: Abigail Enriquez

Mount Structural Analysis Report (1) 12.50-Ft Platform

May 4, 2021 Site ID: 468083-VZW / BRANFORD SHORT BEACH

Page | 4

7. Structural Steel Grades have been assumed as follows, if applicable, unless otherwise noted in this analysis:

 Channel, Solid Round, Angle, Plate ASTM A36 (Gr. 36) HSS (Rectangular) ASTM 500 (Gr. B-46) ASTM A53 (Gr. B-35) Pipe Threaded Rod F1554 (Gr. 36) ASTM A325 Bolts

Discrepancies between in-field conditions and the assumptions listed above may render this analysis invalid unless explicitly approved by Maser Consulting Connecticut.

Analysis Results:

Component	Utilization %	Pass/Fail
Mount Pipe	44.7%	Pass
Dual Antenna Mount Pipe	32.0%	Pass
Circle Angle	66.9%	Pass
Face Horizontal	22.6%	Pass
Connection Plates	46.3%	Pass
Handrail Connection	19.9%	Pass
Handrail	24.8%	Pass
Standoff HSS	35.8%	Pass
Circular Angle Connection	22.4%	Pass
Platform Angle	4.8%	Pass
Platform-Face Plate	15.1%	Pass
Connection Check	48.8%	Pass

Recommendation:

The existing mounts are SUFFICIENT for the final loading configuration and do not require modifications.

ANSI/ASSP rigging plan review services compliant with the requirements of ANSI/TIA 322 are available for a Construction Class IV site or other, if required. Separate review fees will apply.

Attachments:

- Mount Photos
- 2. Mount Mapping Report (for reference only)
- 3. Analysis Calculations
- 4. Contractor Required Post Installation Inspection (PMI) Report Deliverables
- Antenna Placement Diagrams
- 6. TIA Adoption and Wind Speed Usage Letter





Dewberry Engineers Inc. 99 SUMMER STREET SUITE 700 BOSTON, MA 02110 PHONE: 617.695.3400 FAX: 617.695.3310

. DESCRIPTION	BY	DATE
	DESCRIPTION	DESCRIPTION BY

ATC SITE NUMBER: 283422

ATC SITE NAME: SHORT BEACH BRANFORD CT

VERIZON SITE NAME:

BRANFORD SHORT BEACH

SITE ADDRESS: 171 SHORT BEACH ROAD BRANFORD, CT 06405-4930

SEAL:

ver	 	1
YCI	IZUI	

DATE DRAWN:	06/01/21	
ATC JOB NO:	13668667	
CUSTOMER ID:	BRANFORD SHORT BEACH	
CUSTOMER #:	468083	

SUPPLEMENTAL

SHEET NUMBER:

R-602

REVISION:

MOUNT ANALYSIS