verizon BERLIN KENSINGTON CT

CROWN CASTLE BU #:826217 240 KENSINGTON RD BERLIN, CT 06037



DO NOT SCALE DRAWINGS

CONTRACTOR SHALL VERIFY ALL PLANS AND EXISTING DIMENSIONS AND CONDITIONS ON THE JOB SITE AND SHALL IMMEDIATELY NOTIFY THE LESSEE/LICENSEE REPRESENTATIVE IN WRITING OF DISCREPANCIES BEFORE PROCEEDING WITH THE WORK OR BE RESPONSIBLE FOR SAME

CONSULTANT TEAM

APPLICANT: VERIZON WIRELESS 20 ALEXANDER DRIVE WALLINGFORD, CT 06492 CONTACT: JAMES O'DONNELL

APPLICANT'S CONTACT: JAMES O'DONNELL (413) 575-2626

JACOBS ENGINEERING GROUP, INC. 120 SAINT JAMES AVENUE

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PROJECT SUMMARY

VERIZON SITE NAME: BERLIN KENSINGTON CT

CROWN CASTLE SITE NAME: NEWINGTON_1

TOWER OWNER: CROWN CASTLE LLC

67 SHARP STREET HINGHAM, MA 02043

N 41° 37' 34.30" COORDINATES:

APPLICANT:

W 72° 46' 32.33"

VERIZON WIRELESS 20 ALEXANDER DRIVE WALLINGFORD, CT 06492

PROJECT DIRECTORY

SITE ADDRESS: 240 KENSINGTON RD BERLIN, CT 06037

PROJECT DESCRIPTION

THE PROJECT WILL CONSIST OF REMOVING (6) EXISTING RRUS REMOVING (6) EXISTING ANTENNAS INSTALLING (6) PROPOSED RRUS AND (6) PROPOSED

THIS DOCUMENT WAS DEVELOPED TO REFLECT A SPECIFIC SITE AND ITS SITE CONDITIONS AND IS NOT TO BE USED FOR ANOTHER SITE OR WHEN CONDITIONS PERTAIN REUSE OF THIS DOCUMENT IS AT THE SOLE RISK OF THE USER

A.D.A. COMPLIANCE: FACILITY IS UNMANNED AND NOT FOR HUMAN HABITATION

SHEET INDEX

TITLE SHEET

SITE PLAN

EQUIPMENT DETAILS

A-2 **ELEVATION PLAN**

UNDERGROUND SERVICE ALERT

THE LAW REQUIRES TWO WORKING DAYS NOTICE PRIOR TO ANY EARTH MOVING ACTIVITIES. **DIAL 811**

Verzor

CROWN 3 CORPORATE PARK DRIVE, SUITE 10:



APPROVALS

PROJECT NO: ERCC0004

CHECKED BY SUBMITTALS

08/21/19 FOR CONSTRUCTION 0 07/30/19 FOR PERMITTING

TRICTLY PROHIBITED. DUPLICATION AND U Y GOVERNMENT AGENCIES FOR THE RPOSES OF CONDUCTING THEIR LAWFULL THORIZED REGULATORY AND INISTRATIVE FUNCTIONS IS SPECIFICALL

SITE NAME: BERLIN KENSINGTON CT CROWN CASTLE BU#: 826217


240 KENSINGTON RD BERLIN, CT 06037

TITLE SHEET

T-1

CONSTRUCTION

ARCHITECT: 5TH FLOOR BOSTON, MA 02116 STRUCTURAL ENGINEER: 5TH FLOOR BOSTON, MA 02116 ELECTRICAL ENGINEER: 5TH FLOOR BOSTON, MA 02116

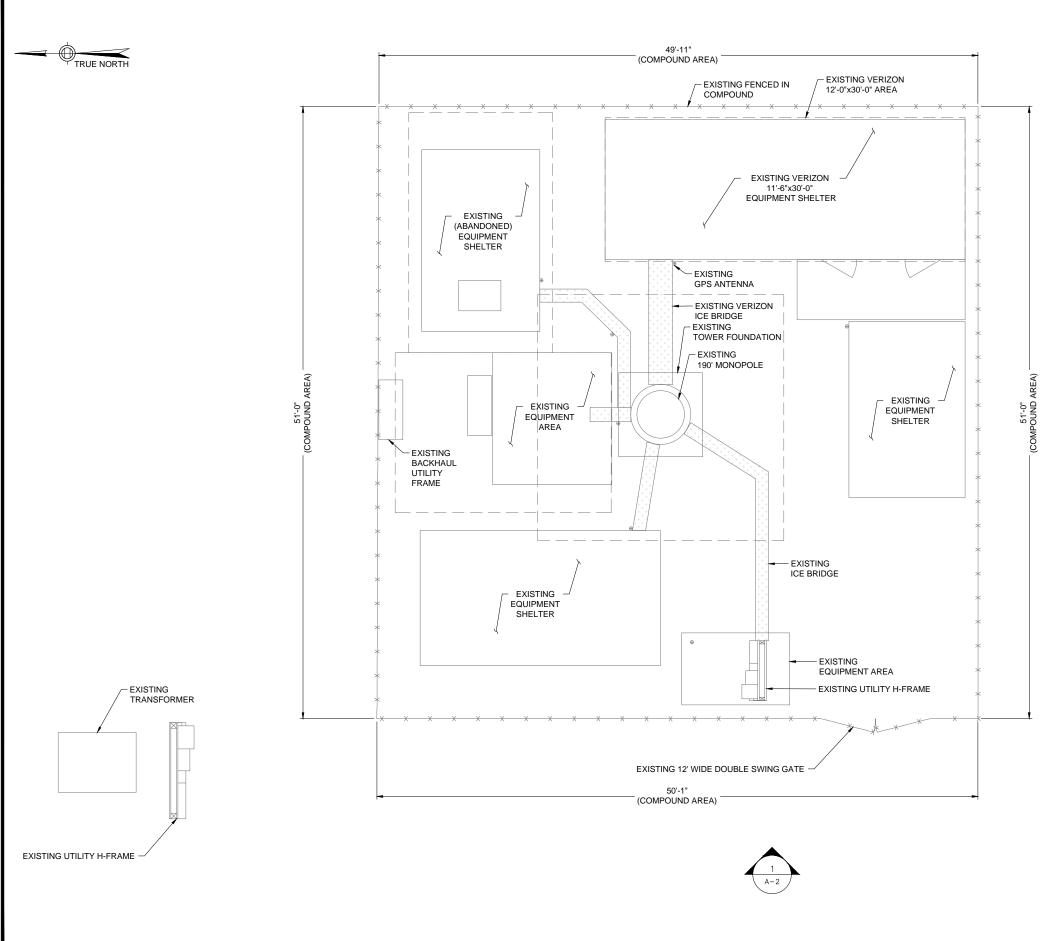



CROWN CASTLE

3 CORPORATE PARK DRIVE SUITE 10

JACOBS Jacobs Engineering Group, In

120 ST JAMES AVENUE 5TH FLOOR BOSTON, MA 02116 TEL (617) 242-9222 FAX (617) 242-9824



APPROVALS LANDLORD_____ LEASING _____ R.F. ____ ZONING ____ CONSTRUCTION _____ A & E _____

PROJECT NO: ERCC0004

DRAWN BY:

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SUBMITTALS

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240 KENSINGTON RD BERLIN, CT 06037


SITE PLAN


A-1

CONSTRUCTION


GENERAL NOTES:

- 1. SOME EXISTING AND PROPOSED INFORMATION NOT SHOWN FOR CLARITY.
- 2. NORTH SHOWN AS APPROXIMATE.
- 3. EXISTING ANTENNAS SHOWN AS APPROXIMATE. ELEVATION BASED ON EXISTING INFORMATION AND VISUAL INSPECTION AND HAVE NOT BEEN VERIFIED THROUGH AN ANTENNA MAPPING.
- 4. PLANS BASED ON DRAWINGS FROM CROWN CASTLE WEB-SITE.
- 5. ANTENNAS TO BE INSTALLED PER TOWER MANUFACTURER RECOMMENDATIONS AND TOWER STRUCTURAL ANALYSIS SPECIFICATIONS.
- REUSED EXISTING ANTENNA MOUNTS AND COAX. INSPECT FOR DAMAGE OR DECAY AND REPLACE AS NEEDED PER STRUCTURAL ANALYSIS.
- 7. CONTRACTOR TO VERIFY FINAL ANTENNA DESIGN AND NOTIFY CARRIER AND ENGINEER WITH ANY DISCREPANCIES PRIOR TO THE INSTALLATION.
- 8. INSTALL ALL EQUIPMENT PER MANUFACTURER'S RECOMMENDATIONS.
- ALL EQUIPMENT SHALL BE GROUNDED PER VERIZON WIRELESS STANDARDS AND MANUFACTURER'S RECOMMENDATIONS.
- 10. EQUIPMENT MOUNTING DETAIL IS PROVIDED AS SCHEMATIC IN NATURE WITH SUGGESTED PART NUMBERS, ACTUAL PARTS, MOUNTING METHOD, LOCATION AND ORIENTATION MUST BE IN ACCORDANCE WITH THE STRUCTURAL ANALYSIS OR CONFIRMED WITH THE STRUCTURAL ENGINEER THAT COMPLETED THE REPORT IF NOT PROVIDED.
- 11. ALL PROPOSED EQUIPMENT INCLUDING ANTENNAS, COAX, SURGE ARRESTORS, RRU'S, ETC. SHALL BE MOUNTED IN ACCORDANCE WITH THE STRUCTURAL ANALYSIS (BY OTHERS)
- 12. ALL DIMENSIONS TO, OF, AND ON EXISTING BUILDINGS, DRAINAGE STRUCTURES, AND SITE IMPROVEMENTS SHALL BE VERIFIED IN FIELD BY CONTRACTOR PRIOR TO ALL FABRICATION. ANY DISCREPANCIES SHALL BE REPORTED IMMEDIATELY TO ENGINEER.
- 13. CONSTRUCTION SAFETY SHALL BE THE SOLE RESPONSIBILITY OF THE CONTRACTOR. THESE DRAWINGS DO NOT INCLUDE NECESSARY SAFETY COMPONENTS
- 14. BRACE STRUCTURES SUCH AS LATERAL BRACING, ANCHOR BOLTS, ETC. SHALL BE INSTALLED UNTIL ALL STRUCTURAL ELEMENTS REACH TO REQUIRED STABILITY
- 15. INCORRECTLY FABRICATED, DAMAGED, OR OTHERWISE MISFITTING OF NONCONFORMING MATERIALS OR CONDITIONS SHALL BE REPORTED TO THE OWNER PRIOR TO REMEDIAL OR CORRECTIVE ACTION. ANY SUCH REMEDIAL ACTION SHALL REQUIRE WRITTEN APPROVAL BY THE OWNER'S REPRESENTATIVE PRIOR TO PROCEEDING.
- 16. EACH CONTRACTOR SHALL COOPERATE WITH THE OWNER'S REPRESENTATIVE AND COORDINATE HIS WORK WITH THE WORK OF OTHERS.
- 17. REPAIR ANY DAMAGE DURING CONSTRUCTION TO MATCH EXISTING PRE-CONSTRUCTION CONDITIONS TO THE SATISFACTION OF THE CONSTRUCTION MANAGER.
- 18. CONTRACTOR SHALL SUPERVISE AND DIRECT THE PROJECT DESCRIBED HEREIN. CONTRACTOR SHALL BE SOLELY RESPONSIBLE FOR ALL CONSTRUCTION MEANS, METHODS, TECHNIQUES, SEQUENCES AND PROCEDURES AND FOR COORDINATING ALL PORTIONS OF THE WORK UNDER THE CONTRACT.
- 19. REUSE EXISTING ANTENNA MOUNTS AND COAX. INSPECT FOR DAMAGE OR DECAY AND REPLACE AS NEEDED PER STRUCTURAL ANALYSIS.
- 20. CONTRACTOR TO VERIFY FINAL ANTENNA DESIGN AND NOTIFY CARRIER AND ENGINEER WITH ANY DISCREPANCIES PRIOR TO THE INSTALLATION.
- 21. ALL CONSTRUCTION SHALL BE GOVERN BY THE FOLLOWING CODES: 2018 CONNECTICUT STATE BUILDING CODE 2018 AMENDMENT WITH 2015 INTERNATIONAL BUILDING CODE 2009 ICC/ANSI A117.1 ACCESSIBLE AND USABLE BUILDINGS AND FACILITIES 2015 INTERNATIONAL MECHANICAL CODE 2015 INTERNATIONAL ENERGY CONSERVATION CODE 2017 NATIONAL ELECTRICAL CODE (NFPA 70 2017) ANSI/TIA-222-G

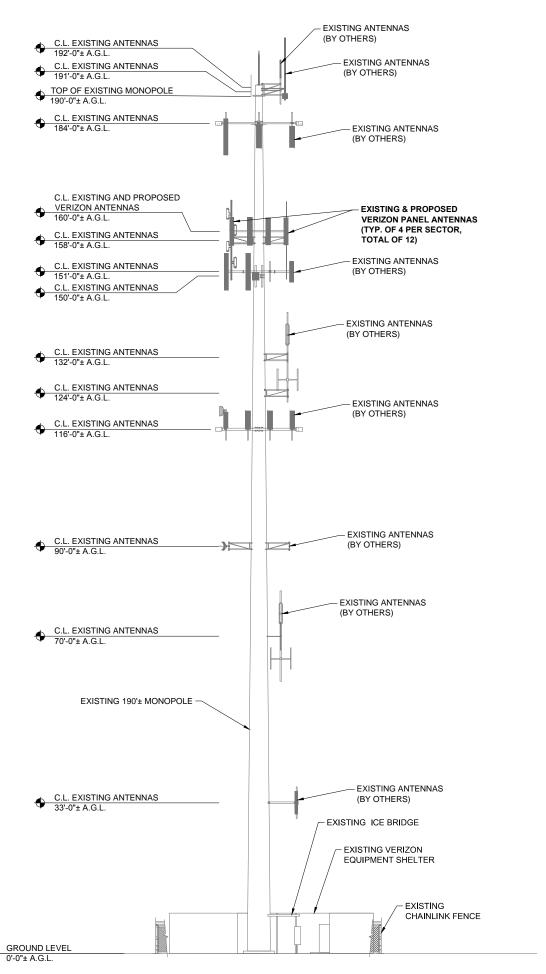

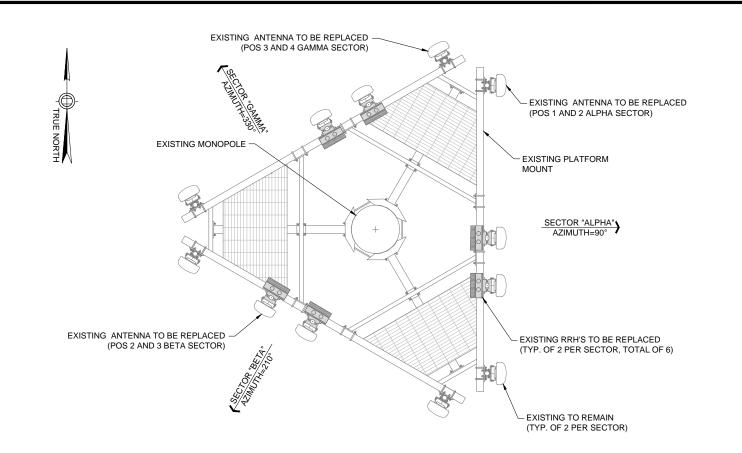

EXISTING ANTENNA LAYOUT SCALE: 1/2" = 1'-0"

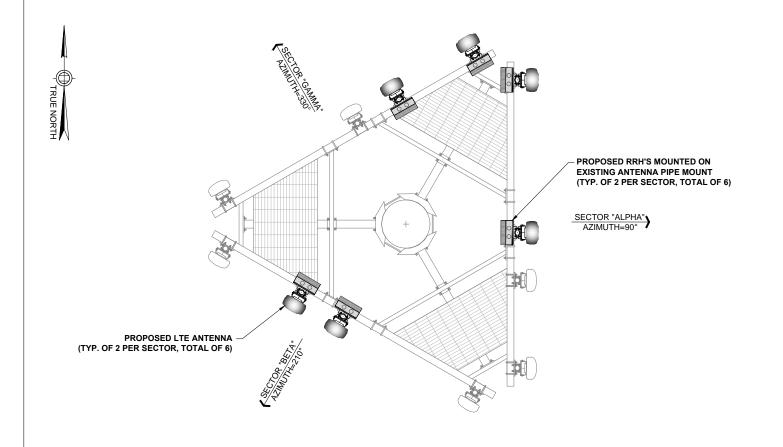

vertzor

C CROWN CASTLE 3 CORPORATE PARK DRIVE, SUITE 10 CLIFTON PARK, NEW YORK, 12065



APPROVALS LANDLORD. LEASING _ ZONING CONSTRUCTION

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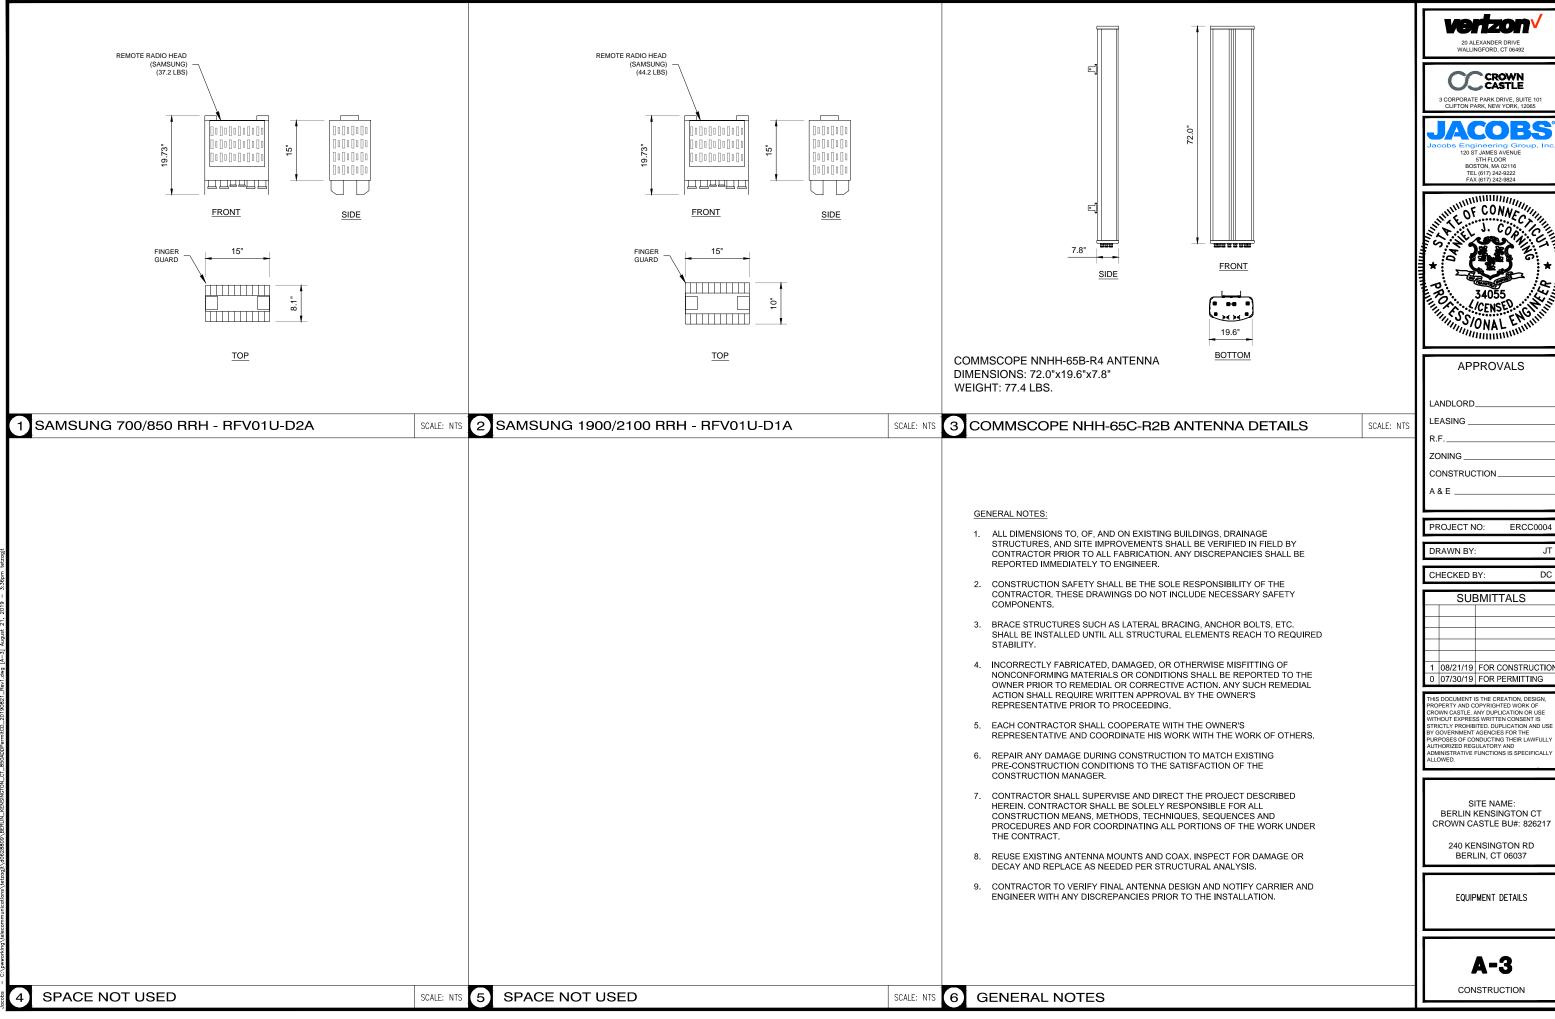
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SITE ELEVATION AND ANTENNA LAYOUT

A-2

CONSTRUCTION

SCALE: 3/32" = 1'-0"



Venzon

3 CORPORATE PARK DRIVE, SUITE 101 CLIFTON PARK, NEW YORK, 12065



APPROVALS

ERCC0004

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SUBMITTALS

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