

**From:** Aja Chase <aja.chase@ericsson.com>  
**Sent:** Wednesday, May 10, 2023 2:51 PM  
**To:** CSC-DL Siting Council <Siting.Council@ct.gov>  
**Cc:** Joseph Carbonell <joseph.carbonell@ericsson.com>  
**Subject:** EM-CING-007-220513

Good Afternoon CSC,

Please find the CCA attached for the below site, which completed construction as of 4/27/23. A photo of the overall work is also attached, please let me know if you have any additional questions!

10034969	CTL01014	MRCTB051296	260 BECKLEY ROAD	BERLIN	6037
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Kindly,



Aja Chase  
Construction Manager I  
AT&T NE Market  
401-952-6205



Dewberry Engineers Inc.  
99 Summer Street, Suite 700  
Boston, MA 02110-1200  
617.695.3400  
617.695.3310 fax  
www.dewberry.com

May 10, 2023

Building Department  
Town of Berlin  
240 Kensington Rd.  
Berlin, CT 06037

### Construction Closeout Letter

**ATC Site Name:** BRLN - Berlin  
**ATC Asset#:** 302483  
**AT&T Site#:** CTLO1014  
**Site Address:** 286 Beckley Rd.  
Berlin, CT 06037

To Whom It May Concern:

In accordance with the requirements of the 2018 Connecticut State Building Code, Dewberry Engineers Inc. (Dewberry) reviewed the completed installation at the above location based on Rev-2 Construction Drawings dated 10/05/22. A structural analysis report dated 11/04/21 was completed by CLS Engineering PLLC, and a mount analysis report dated 09/12/22 was completed by Telamon Tower Engineering PLLC.

Please see the attached reports and documentation for the completed site.


- May 10, 2023 – Contractor Report by Dewberry
- April 10, 2023 – As-Built drawings by Phoenix United
- September 21, 2022 –Statement of Special Inspections by Dewberry

Based on visual observations, it appears that the project is constructed in general conformance with the applicable plans and specifications. If you have any questions, please do not hesitate to contact Dewberry Engineers Inc.

Sincerely,

**Dewberry Engineers Inc.**

Benjamin Revette, P.E.  
Associate Vice President

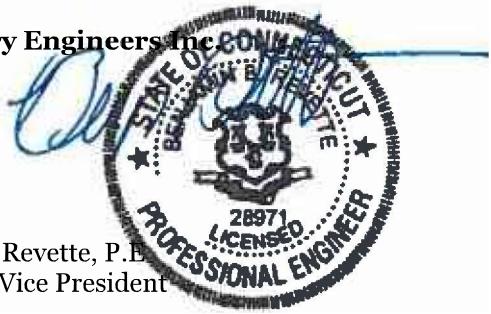

## Statement of Special Inspections

### Contractor Report #1

Attn: Mr. Blake Paynter  
Project Manager  
American Tower Corporation  
10 Presidential Way  
Woburn, MA 01801

ATC Site Name:	BRLN - Berlin
ATC Site#/Project#:	302483 / 13682691
Site Address:	286 Beckley Road Berlin, CT 06037
CM / Contractor:	Ericsson / Phoenix United

Dewberry Engineers Inc. (Dewberry) has reviewed the photos and as-built drawings provided by the general contractor of the recently completed site improvements at the aforementioned location. The site review was performed based on Rev-2 Construction Drawings dated 10/05/22. A structural analysis report dated 11/04/21 was completed by CLS Engineering PLLC, and a mount analysis report dated 09/12/22 was completed by Telamon Tower Engineering PLLC.

The following are on-site photos from the inspection:

Figure 1: View of installed alpha sector antennas on new mount platform

Figure 2: View of installed beta sector antennas on new mount platform

Figure 3: Overview of installed equipment on tower

Figure 4: View(s) of installed RRUs and Squids on new mount platform

All notes and items in this field report are a record of observations provided by the photos. Please notify Dewberry Engineers Inc. in writing of any discrepancies, errors or misinterpretations. Please find attached to this report, the figures and photos of construction and items observed.

Prepared By: \_\_\_\_\_



Joseph Mazzeo  
Engineer

**Contractor Photos:**


*Figure 1: View of installed alpha sector antennas on new mount platform*



*Figure 2: View of installed beta sector antennas on new mount platform*




*Figure 3: Overview of installed equipment on tower*

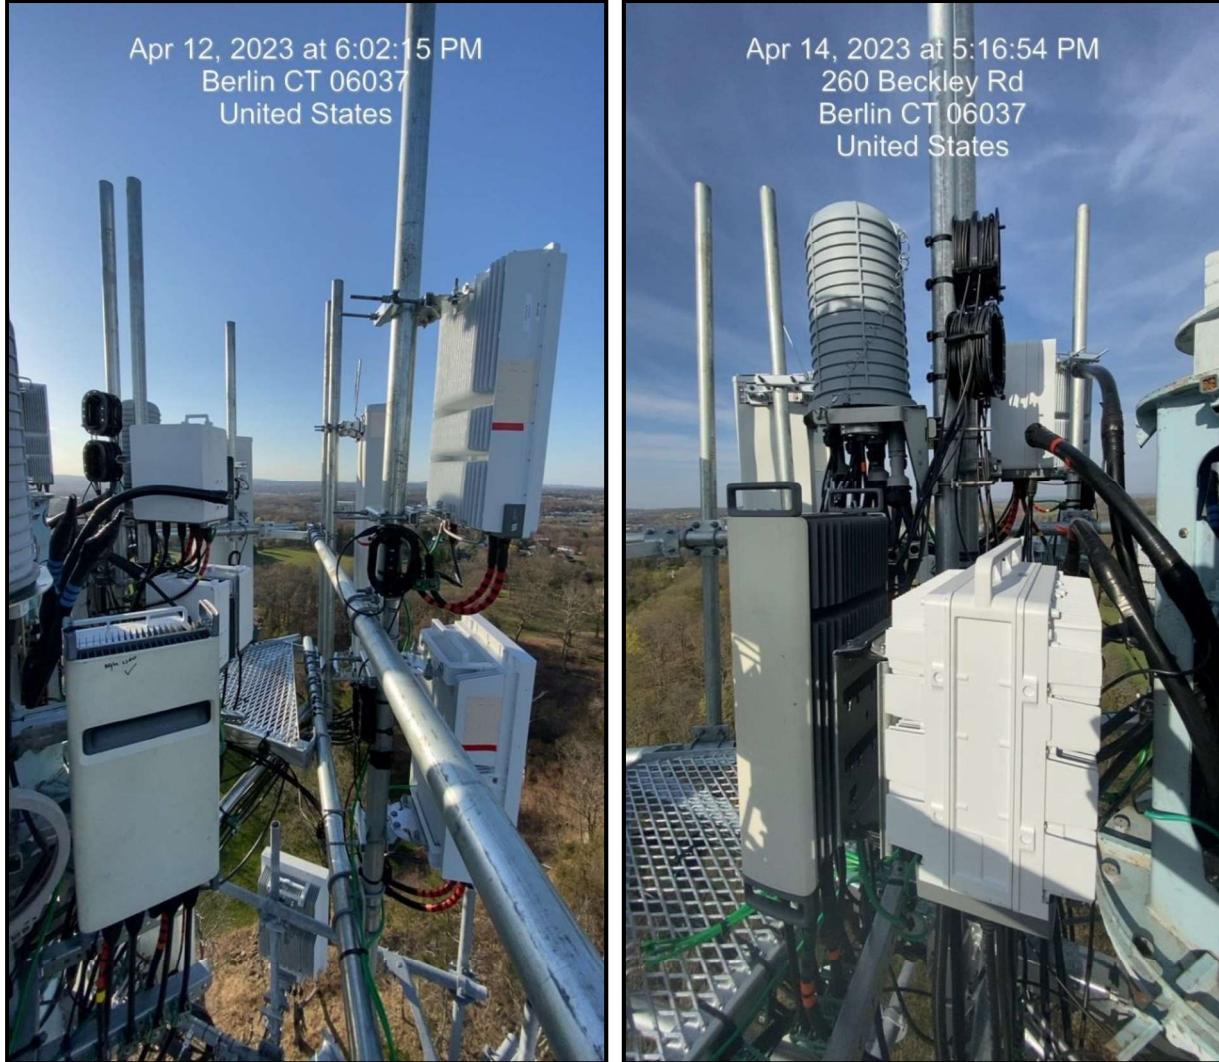

*Figure 4: View(s) of installed RRUs and Squids on new mount platform*



**Dewberry®**  
Dewberry Engineers Inc.  
99 SUMMER STREET  
SUITE 700  
BOSTON, MA 02110  
PHONE: 617.695.3400

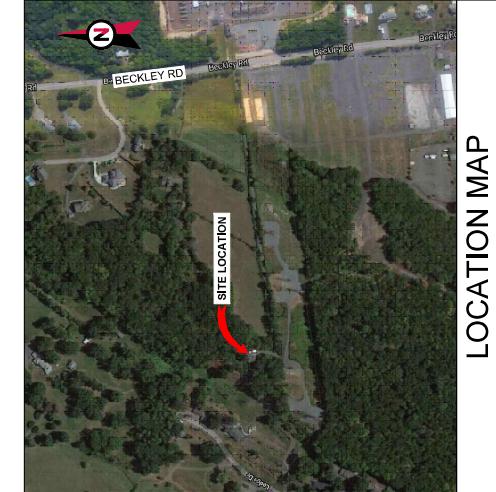

**MA MOD was done as per MA Analysis**  
**dated 11/05/21**

**REDLINED PHOENIX UNITED**  
**04/10/2023**

AT&T MOBILITY SITE NAME:  
BERLIN - BERLIN

ATC SITE NUMBER:  
302483

REV. DATE:

PRELIM. J.W. 11/11/21

FINAL V.L. 04/14/22

FINAL G.M. 09/14/22

FINAL H.M. 10/05/22

FINAL

DATE: 10/05/22

ATC SITE NUMBER:  
302483

ATC SITE NAME:  
BERLIN - BERLIN

AT&T MOBILITY SITE NAME:  
BERLIN NE

ATC SITE NUMBER:  
302483

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302483

ATC SITE NAME:  
BERLIN NE



## AMERICAN TOWER®

ATC SITE NAME: BRLN - BERLIN  
ATC SITE NUMBER: 302483  
AT&T PACE NUMBERS: MRCTB062540 / MRCTB061026 /  
MRCTB054270 / MRCTB061034 / MRCTB054198 /  
MRCTB057692 / MRCTB057696 / MRCTB052343 /  
MRCT051028 / MRCTB051134 / MRCTB051296

AT&T SITE ID: CTL01014

AT&T FA CODE: 10034969

AT&T SITE NAME: BERLIN NE  
SITE ADDRESS: 286 BECKLEY ROAD  
BERLIN, CT 06037

## PROJECT SUMMARY

### PROJECT DESCRIPTION

THE PROPOSED PROJECT INCLUDES MODIFYING GROUND BASED

TO A TOWER MOUNTED EQUIPMENT AS INDICATED PER BELOW:

TO REMOVE (6) ANTENNA(S), (9) RRUI(S), (6) TMAS(S) AND (1) PLATFORM

MOUNT

INSTALL (12) ANTENNA(S), (6) RRUI(S), (1) DC9, (3) BAWG6 DC

TRUNK, (1) FIBER TRUNK, (3) Y-CABLE(S) AND (1) PLATEFORM

MOUNT

EXISTING (6) RRUI(S), (2) FIBER TRUNK, (3) Y-CABLE(S), (4) BAWG6 DC

TRUNKS, (2) FIBER TRUNKS) TO REMAIN, EXISTING (2) RRUI(S)

TO BE RELOCATED FROM GROUND.

GROUND WORK:

REMOVE (8) DIPLEXERS AND DECOM UNITS (B1US)

INSTALL (3) RECTIFIERS, (3) RRUI(S), (6) SURGE ARRESTOR(S), (1)

BB6648 AND (1) DC2/16

PROJECT NOTES

1. THE FACILITY IS UNMANNED.

2. A TECHNICIAN WILL VISIT THE SITE APPROXIMATELY ONCE A

MONTH FOR ROUTINE INSPECTION AND MAINTENANCE.

3. THE PROJECT WILL NOT RESULT IN ANY SIGNIFICANT LAND

DISTURBANCE OR EFFECT OF STORM/WATER FRAZNE.

4. NO SANITARY SEWER, POTABLE WATER OR TRASH DISPOSAL

IS REQUIRED.

5. THE PROJECT CO-ACCESS IS NOT REQUIRED.

6. THE PROJECT IS SUBJECT TO THESE PLANS QUALIFIES AS AN

ELIGIBLE FACILITY REQUEST ENTITLED TO EXPENDED

REVIEW UNDER 47 U.S.C. 156(a) AS A MODIFICATION OF AN

EXISTING MILELESS TOWER THAT INVOLVES THE

COLLOCATION, REMOVAL AND/OR REPLACEMENT OF

TRANSMISSION EQUIPMENT THAT IS NOT A SUBSTANTIAL

CHANGE UNDER CFR § 1.6100 (B)(7).

## PROJECT LOCATION DIRECTIONS

I-91 S MA EXIT 52 TOWARD NEW HAVEN. 10.9 MILES AWAY 15

MILE MARK 10.9 TURN LEFT ON I-91 S TOWARD NEW BRITAIN.

1.22 MILES AWAY 6 TURN LEFT ON CT-32 E/1-21 TOWARD EAST

MINA MILE MARK 8 TURN LEFT ON CT-32 E/1-21 TOWARD EAST

MINA MILE MARK 10 TURN LEFT ON CT-32 E/1-21 TOWARD EAST

MINA MILE MARK 12 TURN LEFT ON CT-32 E/1-21 TOWARD EAST

MINA MILE MARK 14 TURN LEFT ON CT-32 E/1-21 TOWARD EAST

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MINA MILE MARK 232 TURN LEFT ON

## GENERAL CONSTRUCTION NOTES:

REDLINED PHOENIX UNITED  
04/10/2023



## GENERAL NOTES

REVISION SHEET NUMBER: G-002 2

SHEET NUMBER: <b>G-002</b>	REVISION <b>2</b>
<p>FAILURE TO COMMUNICATE DIRECTLY WITH ATC ENGINEERING OR ANY CHANGES FROM THE DESIGN CONDUCTED WITHOUT PRIOR APPROVAL FROM ATC ENGINEERING SHALL BE THE SOLE RESPONSIBILITY OF THE GENERAL CONTRACTOR.</p>	

REVISION SHEET NUMBER: G-002 2

SHEET NUMBER: <b>G-002</b>	REVISION <b>2</b>
<p>FAILURE TO COMMUNICATE DIRECTLY WITH ATC ENGINEERING OR ANY CHANGES FROM THE DESIGN CONDUCTED WITHOUT PRIOR APPROVAL FROM ATC ENGINEERING SHALL BE THE SOLE RESPONSIBILITY OF THE GENERAL CONTRACTOR.</p>	





**AMERICAN TOWER®**

Dewberry®

**Dewberry Engineers Inc.**  
800 SUMMER STREET  
HARTFORD, CONNECTICUT 06103

33 COMMERCIAL STREET  
SUITE 700  
BOSTON, MA 02110  
PHONE: 617.695.3400

REDLINED PHOENIX UNITED  
04/10/2023

**SITE PLAN NOTES:**

1. THIS SITE PLAN REPRESENTS THE BEST PRESENT KNOWLEDGE AVAILABLE TO THE ENGINEER AT THE TIME OF THIS DESIGN. THE CONTRACTOR SHALL VISIT THE SITE PRIOR TO CONSTRUCTION AND VERIFY ALL EXISTING CONDITIONS RELATED TO THE SCOPE OF WORK FOR THIS PROJECT.
2. ICE BRIDGE, CABLE LADDER, COAX PORT, AND COAX CABLE ARE SHOWN FOR REFERENCE ONLY. CONTRACTOR SHALL CONFIRM THE EXACT LOCATION OF ALL PROPOSED AND EXISTING EQUIPMENT AND STRUCTURES DEPICTED ON THIS PLAN, BEFORE UTILIZING EXISTING CABLE SUPPORTS, COAX PORTS, INSTALLING NEW PORTS OR ANY OTHER EQUIPMENT. CONTRACTOR SHALL VERIFY ALL ASPECTS OF THE COMPONENTS MEET THE AT&T SPECIFICATIONS.
3. NO ELECTRICAL SCOPE IS INCLUDED IN THIS PROJECT.

<u>LEGEND</u>	GROUNDING TEST WELL
⑧	ATS
B	BOLLARD
CSC	CABINET, SITE
D	DISCONNECT
E	ELECTRICAL
F	FIBER
GEN	GENERATOR
G	GENERATOR RECEPTACULAR
HH, V	HAND HOLE, VAULT
IB	ICE BRIDGE
K	KENTRO BOX
LC	LIGHTING CONTROL
M	METER
PB	PULL BOX
PP	POWER POLE
T	TELECO
TRN	TRANSFORMER
	CHANNLINK FENCE



The AT&T logo, featuring the company name in a bold, black, sans-serif font above a blue globe icon.

ATC JOB NO:	1368263
CUSTOMER ID:	BERLIN
CUSTOMER #:	1003496

REVISION: 2  
SHEET NUMBER: C-102

SHEET

C-102 2

SHEET NUMBER: C-102  
REVISION: 2

## DETAILED EQUIPMENT LAYOUT

DETAILED EQUIPMENT LAYOUT



AMERICAN TOWER®



**Dewberry**  
Dewberry Engineers Inc.  
98 SUMMER STREET  
SUITE 700  
BOSTON, MA 02110  
PHONE: 617.695.3400

REV.	DESCRIPTION	BY	DATE
▲	PRELIM	J.W.	11/11/21
▲	FINAL	V.L.	04/14/22
▲	FINAL	H.M.	09/14/22
▲	FINAL	H.M.	10/05/22
▼			

ATC SITE NUMBER:  
302483ATC SITE NAME:  
BERLINAT&T MOBILITY SITE NAME:  
BERLIN NESITE ADDRESS:  
206 BECKLEY ROAD

SEAL:




DATE DRAWN:	11/11/21
ATC JOB NO.:	13692831
CUSTOMER ID:	BERLIN NE
CUSTOMER #:	1003499

## TOWER ELEVATION

SHEET NUMBER:	C-201	REVISION:	2
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**REDLINED PHOENIX UNITED**  
**04/10/2023**

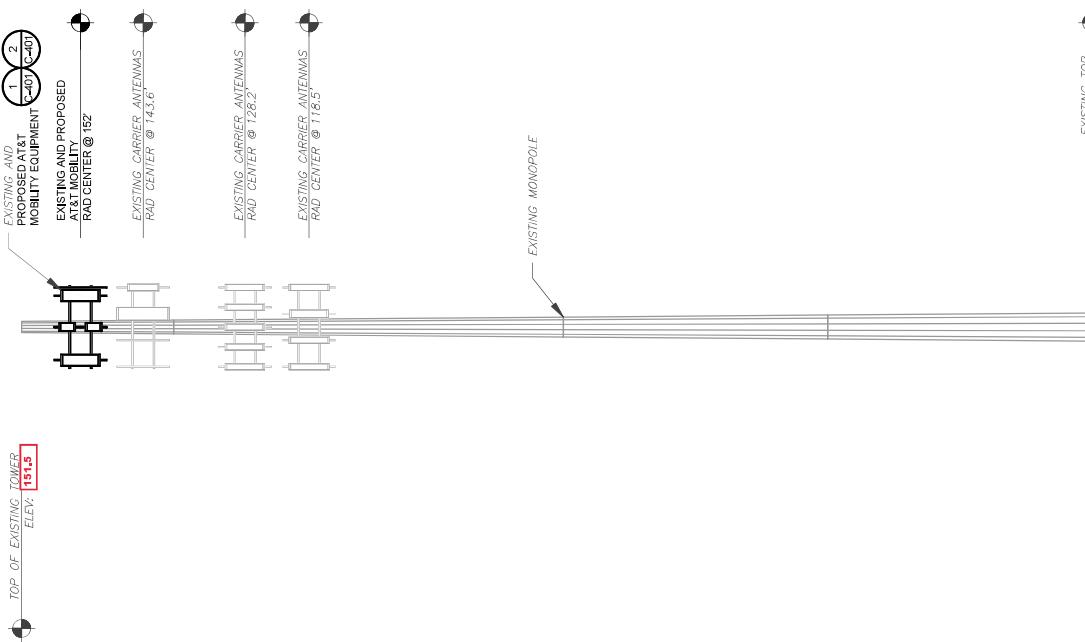

PER MOUNT ANALYSIS COMPLETED BY TELAMON  
DATED 09/12/22. THE EXISTING MOUNT CAN NOT  
ADEQUATELY SUPPORT THE PROPOSED  
LOADING. THE MOUNT REPLACEMENT  
PROPOSED IN THE MOUNT ANALYSIS INCLUDED  
AT THE END OF THIS PLAN SET, MUST BE  
INSTALLED PRIOR TO THE INSTALLATION OF THE  
PROPOSED ANTENNAS AND OTHER EQUIPMENT.

**TOWER NOTE**

1. IT IS THE CONTRACTOR'S RESPONSIBILITY TO CONFIRM WITH THE PROPOSED MANUFACTURER THAT THEY HAVE THE MOST RECENT VERSION OF THE STRUCTURAL ANALYSIS BEFORE COMMENCING WORK. EXISTING AND PROPOSED TOWER APPURTEANCES, MOUNTS, AND ANTENNAS ARE SHOWN BASED ON THE STRUCTURAL ANALYSIS, WHERE APPLICABLE. ALL NEW ANTENNAS, EQUIPMENT MOUNTS, CABLING, ETC. SHALL BE PAINTED/COATED TO MATCH EXISTING EQUIPMENT IN ACCORDANCE WITH FAA JURISDICTION, AND/OR OTHER LOCAL REQUIREMENTS.
2. ROUTE PROPOSED CABLES ALONG SAME PATH AS EXISTING CABLES AND IN ACCORDANCE WITH STRUCTURAL ANALYSIS. IF EQUIPMENT SPACE EAGES DO NOT ALLOW CABLES TO BE ROUTED THROUGH EXISTING HOLE, IF ROUTING OUTSIDE THE MONOPOLE, ATTACH CABLES USING STAND-OFF ADAPTERS MOUNTED TO TOWER USING STAINLESS STEEL BANDING, ADEQUATELY SECURE CABLES USING EITHER APPROPRIATELY SIZED STAINLESS STEEL SNAKES OR MOUNTING HARDWARE AND BRACKETS AS SPECIFIED BY CABLE MANUFACTURER.
3. TOWER ELEVATIONS ARE MEASURED FROM TOP OF BASE PLATE TO MATCH STRUCTURAL ANALYSIS. ELEVATIONS DO NOT REFLECT TRUE ABOVE GROUND LEVEL (AGL).

**1 TOWER ELEVATION**  
SCALE: 1/4" I.M.S.





**Dewberry®**  
Dewberry Engineers Inc.  
98 SUMMER STREET  
SUITE 700  
BOSTON, MA 02110  
PHONE: 617.695.3400

REV.	DESCRIPTION	BY	DATE
▲	PRELIM	JW	11/11/21
▲	FINAL	VL	04/14/22
▲	FINAL	HLB	09/14/22
▲	FINAL	HMP	10/05/22
▼			

ATC SITE NUMBER:  
302483ATC SITE NAME:  
BERLIN

AT&T MOBILITY SITE NAME:  
BERLIN NE  
SITE ADDRESS:  
206 BECKLEY ROAD  
BERLIN, CT 06037  
SEAL:




DATE DRAWN:	11/11/21
ATC JOB NO.:	13682831
CUSTOMER ID:	BERLIN NE
CUSTOMER #:	1003499

## CONSTRUCTION DETAILS

SHEET NUMBER:  
**C-501**


REVISION:  
**2**

**REDLINED PHOENIX UNITED**  
**04/10/2023**

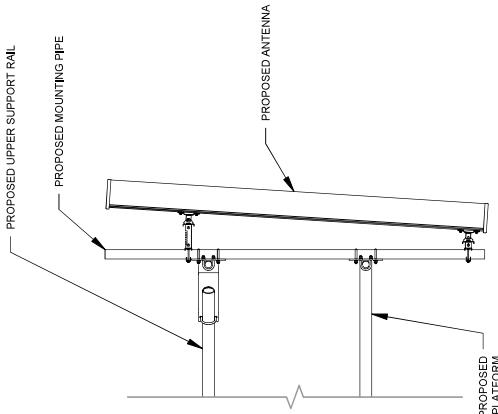


### 1 ANTENNA DETAIL

SCALE: N.T.S.

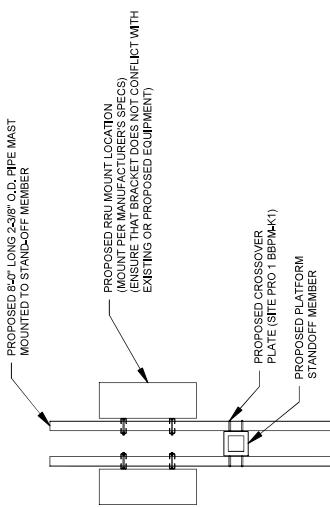


### 3 PROPOSED RRU MOUNTING DETAIL - TYPICAL

SCALE: N.T.S.

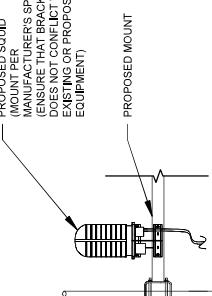

### 4 PROPOSED SQUID MOUNTING

SCALE: N.T.S.

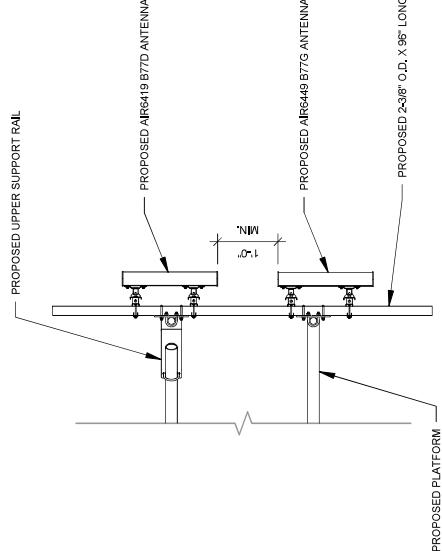

### 2 PROPOSED 5G ANTENNA MOUNTING DETAIL - TYPICAL

SCALE: N.T.S.



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98 SUMMER STREET  
SUITE 700  
BOSTON, MA 02110  
PHONE: 617.695.3400




REV.	DESCRIPTION	BY	DATE
▲	PRELIM.	JW	11/11/21
▲	FINAL	VL	04/14/22
▲	FINAL	HMP	09/14/22
▲	FINAL	HMP	10/05/22
▼			

SHEET NUMBER:	REVISION:
E-501	2

## REDLINED PHOENIX UNITED

04/10/2023

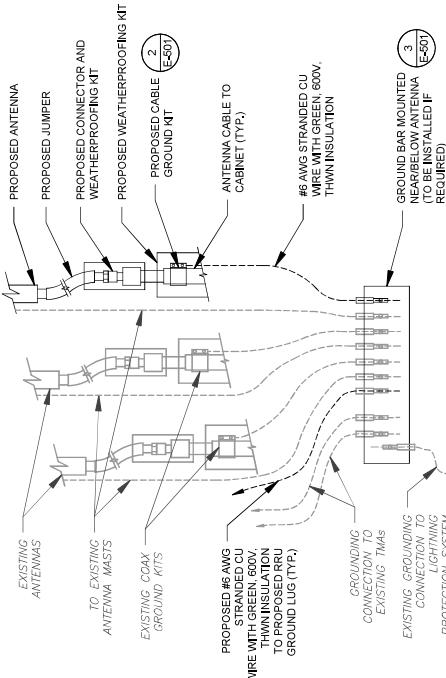

1. THIS DETAIL IS INTENDED TO SHOW THE GENERAL GROUNDING REQUIREMENTS. SLIGHT ADJUSTMENTS MAY BE REQUIRED BASED ON EXISTING SITE CONDITIONS. THE CONTRACTOR SHALL MAKE FIELD ADJUSTMENTS AS NEEDED AND INFORM THE CONSTRUCTION MANAGER OF ANY CONFLICTS.

2. SITE GROUNDS SHALL COMPLY WITH AT&T MOBILITY GROUNDING STANDARDS, LATEST EDITION, AND COMPLY WITH AT&T MOBILITY GROUNDING CHECKLIST, LATEST VERSION. WHEN NATIONAL AND LOCAL GROUNDING CODES ARE MORE STRINGENT THAN THEY SHALL GOVERN.

### 1 TYPICAL ANTENNA GROUNDING DIAGRAM

SCALE: N.T.S.

### 2 CABLE GROUND KIT CONNECTION DETAIL

SCALE: N.T.S.

GROUND AT NOTES:

1. DO NOT INSTALL CABLE GROUND KIT AT A BEND AND ALWAYS DIRECT GROUND WIRE DOWN TO GROUND BAR.
2. CONTRACTOR SHALL PROVIDE WEATHERPROOFING KIT (AND NEW PART NUMBER 221213) AND INSTALL TAPE PER MANUFACTURER'S SPECIFICATIONS.

### GROUND BAR NOTES:

1. GROUND BAR KITS COME WITH ALL HARDWARE, NUTS, BOLTS, WASHERS, ETC. EXCEPT THE STRUCTURAL MOUNTING MEMBER(S).
2. GROUND BAR TO BE BONDED DIRECTLY TO TOWER.

### 3 TOWER GROUND BAR DETAIL

SCALE: N.T.S.

### 4 MAIN GROUND BAR DETAIL


SCALE: N.T.S.

### 5 RRU GROUNDING

SCALE: N.T.S.

### 6 ANTENNA/RRU GROUNDING

SCALE: N.T.S.

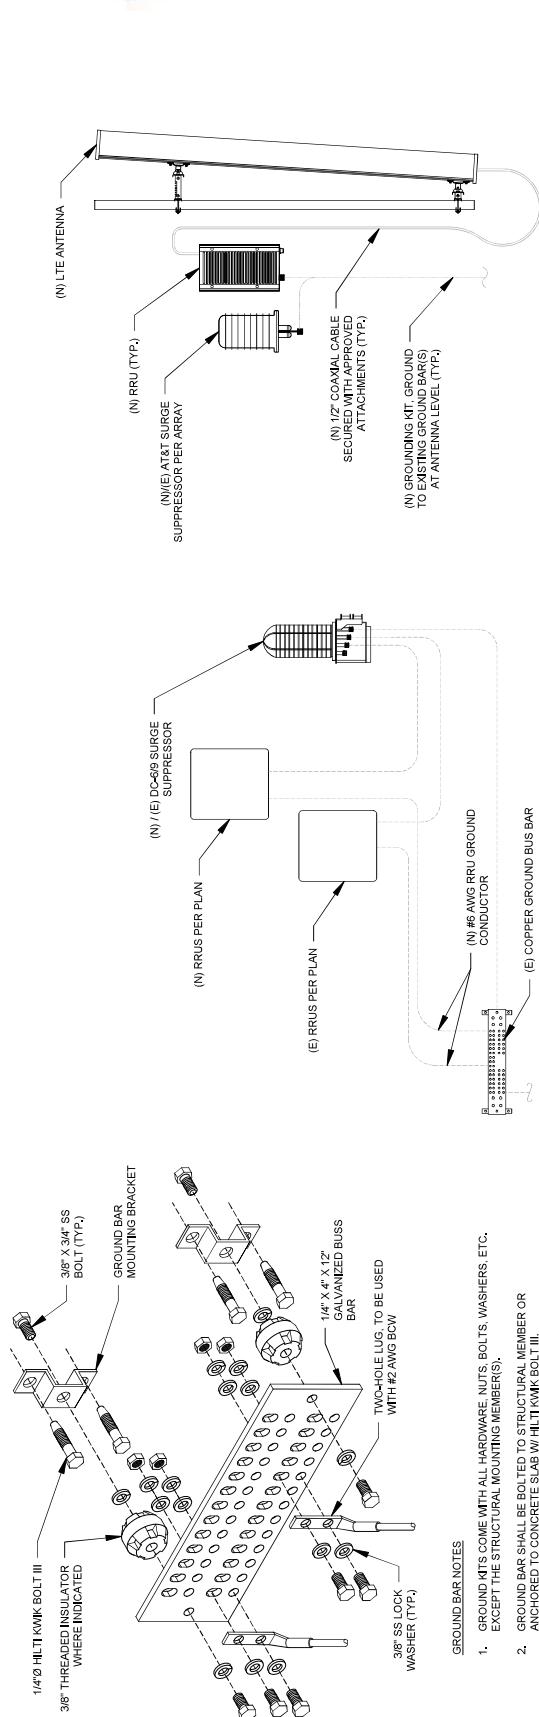

## GROUNDING DETAILS

SCHEMATIC  
SHEET NUMBER: E-501

SCHEMATIC  
REVISION: 2



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PHONE: 617.695.3400

ATC SITE NUMBER:  
302483ATC SITE NAME:  
BERLIN NEATC SITE NUMBER:  
302483ATC SITE NAME:  
BERLIN - BERLIN

DATE DRAWN: 11/11/21

ATC JOB NO.: 13692831


CUST. ID.: BERLIN NE

CUST. #: 1003499

SUPPLEMENTAL

SHEET NUMBER:  
R-601

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04/10/2023


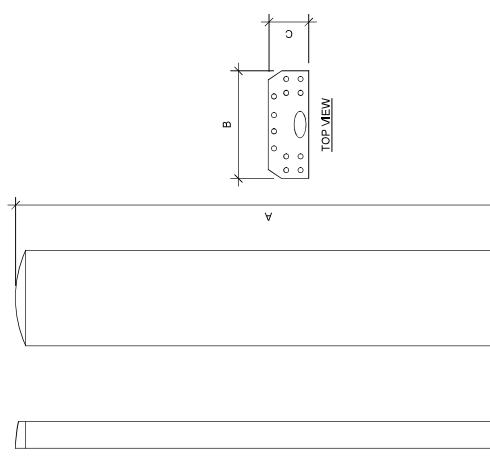


ANTENNA SPECIFICATIONS

ANTENNA MODEL	A	B	C	WEIGHT (LBS)
QD8616-7	72"	22"	9.5"	59.1
ATR649-B77D	30.4"	15.5"	8.1"	81.6
ATR649-B77G	30.0"	15.7"	6.7"	70.0
DMR552-2UD060A	71.2"	20.7"	7.7"	79.4

RRU SPECIFICATIONS

RRU MODEL	A	B	C	WEIGHT (LBS)
4445 B25	16.5"	13.4"	5.9"	46.0
4449 B5 B12	17.9"	13.2"	9.4"	71.0
4478 B14	18.1"	13.4"	8.3"	59.4

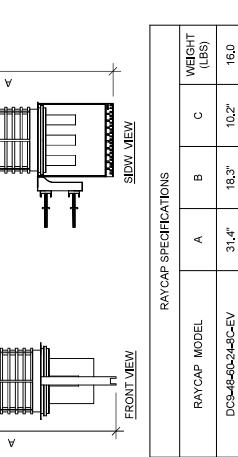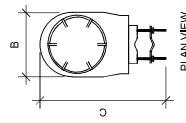


RAYCAP SPECIFICATIONS

RAYCAP MODEL	A	B	C	WEIGHT (LBS)
DCS-48-80-24-90-EV	31.4"	18.3"	10.2"	16.0

1 **EQUIPMENT SPECIFICATIONS**  
SCALE 1:16

## RF REQUIREMENTS FOR 700 B14 FIRSTNET, 700 B12, 700D B29 ANTENNA SEPARATION

- Horizontal separation (side to side of antenna):  $\geq 3'$
- Vertical separation (between the tips of the antennas):  $> 3'$
- Inter-sector separation:  $> 3'$  between the center of the antenna backplanes.

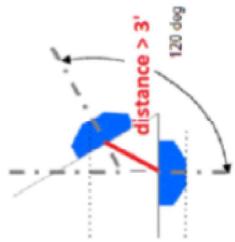

- Please note additional horizontal separation may be required if B14 antennas azimuth are different from others or antennas are severely angled with respect to the mount.
- Typical 3' horizontal separation can tolerate skew angle up to  $6^\circ$ .

 AMERICAN TOWER®	 Dewberry® Dewberry Engineers Inc. 98 SUMMER STREET SUITE 700 BOSTON, MA 02110 PHONE: 617.695.3400	 AT&T
ATC SITE NUMBER: 302483	ATC SITE NAME: BERLIN - BERLIN	DATE DRAWN: 11/11/21 ATC JOB NO: 13692631 SITE ADDRESS: BERLIN NE 206 BECKLEY ROAD BERLIN, CT 06337 CUSTOMER ID: 1003499 CUSTOMER #: 1003499
SUPPLEMENTAL		SHEET NUMBER: <b>R-602</b>

NOTE: THIS SHEET CREATED BY OTHERS AND PROVIDED  
BY REQUEST OF CUSTOMER WITHOUT EDIT.

**REDLINED PHOENIX UNITED**  
**04/10/2023**



**AMERICAN TOWER**  
CORPORATION

This report was prepared for American Tower Corporation by  
**telamon** 

**Antenna Mount Analysis Report**

ATC Site Name : Bln - Berlin

ATC Asset Number : 302483

Engineering Number : 13682691\_C8\_06

Mount Elevation : 151.75 ft

Carrier : AT&T Mobility

Carrier Site Name : MRCIB051296

Carrier Site Number : N/A

Site Location : 268 Beckley Road

Berlin, CT 06037-2419

41.63172222,-72.7299

County : HARTFORD

Date : September 12, 2022

Max Usage : 77%

Result : Contingent Pass\*

\*See conclusion for requirements

Prepared By:  
Prathamesh Padwal  
Telamon Tower Engineering, PLLC

Digitally signed  
By William Holt  
Date: 2022-09-12  
14:35:37-04'00'

**telamon** • 319 Chapanoke Road, Suite 118, Raleigh, NC 27603 • Engineering@telpic.com

**telamon** • 319 Chapanoke Road, Suite 118, Raleigh, NC 27603 • Engineering@telpic.com  
Page 2

Mount Analysis for American Tower  
302483 - Bln - Berlin

September 12, 2022  
Telamon Tower Engineering, PLLC Project#41124-13682691\_C8\_06-02-MA

**Introduction**


The proposed equipment is to be mounted to the existing Site Pro 1RM/QLP-4120-H10 (ANT:44987) platform w/ Support Rails and Kickers. This proposed mounting configuration was analyzed using RISA-3D, a commercially available finite element analysis software package. A selection of input and output from our analysis is attached to the end of this report.

**Supporting Documents**

Structural Data	Site Photos dated July 03, 2019 Spec Sheet by Site Pro 2, DWG. No. RMQLP-4120-H10, dated October 18, 2019
Previous Analyses	Tower Sa by CLS Engineering PLLC, Eng. Number 13732523_C3_02, dated September 23, 2021
Loading Data	ATC Application, Project#13682691, dated October 27, 2021 AT&T RFDS, RFDS ID: 4387644, Version 5.00, dated June 22, 2022

**Analysis**

Codes	TIA-422-H
Basic Wind Speed	118 mph, Va (3-Second Gust)
Basic Wind Speed w/ Ice	50 mph (3-Second Gust) w/ 15" Radial Ic (Escalating)
Exposure Category	B
Topographic Factor Procedure	Method 2
Feature:	Flat
Crash Height [H]:	0 ft
Crash Length [L]:	0 ft
Risk Category	II
Maintenance Live Load	1x: 500 lb
Spectral Response	S: 0.20; S: 0.06; Site Class: D

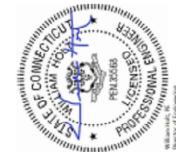

Reviewed By:

Digitally signed  
By William Holt  
Date: 2022-09-12  
14:35:37-04'00'



DATE DRAWN:	11/11/21
ATC JOB NO.:	13682691
CUSTOMER ID:	BERLIN NE
CUSTOMER #:	1003499

**SUPPLEMENTAL**


NOTE: THIS SHEET WAS CREATED BY OTHERS  
AND PROVIDED AT THE REQUEST OF THE  
CUSTOMER WITHOUT EDIT, GENERAL  
CONTRACTOR IS TO CHECK WITH THE AT&T  
MOBILITY CM TO ENSURE THIS IS THE MOST  
RECENT VERSION OF THE RFDS.

**RFDS PLUMBING DIAGRAM**

1

SHEET NUMBER:	R-603
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**REDLINED PHOENIX UNITED**  
04/10/2023

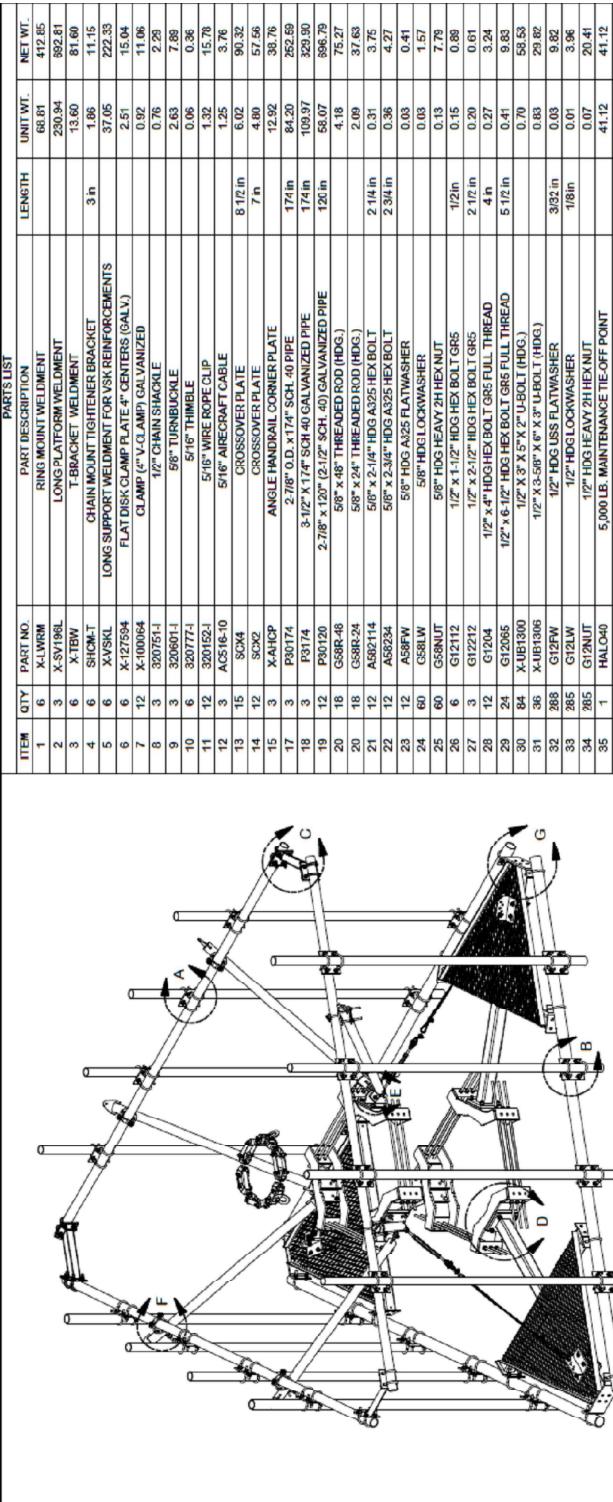

**PARTS LIST**

ITEM	QTY	PART NO.	PART DESCRIPTION	LENGTH	UNIT WT.	NET WT.
1	6	X-LWRM	RING MOUNT WELDMENT		68.81	412.85
2	3	X-SV196L	LONG PLATFORM WELDMENT		230.94	992.81
3	6	X-FRW	TRI-BRACKET WELDMENT		13.60	81.60
4	6	SHCMT	CHAIN MOUNT TIGHTENER BRACKET	3 in	1.06	11.15
5	6	X-PSNL	LONG SUPPORT WELDMENT FOR VSK REINFORCEMENTS		37.05	222.33
6	6	X-27594	FLAT DISK CLAMP PLATE 4" CENTER (GALV)		2.51	15.04
7	12	X-100064	CLAMP (4" V-CLAMP) GALVANIZED		0.92	11.06
8	3	3207514	1/2" CHAIN SHACKLE		0.76	2.28
9	3	3206011	68" TURNBUCKLE		2.83	7.88
10	6	3207771	5/16" THIMBLE		0.66	0.36
11	12	3201521	5/16" WIRE ROPE CLIP		1.32	15.78
12	3	A516-10	5/16" AIRCRAFT CABLE		1.25	3.76
13	15	SCK4	CROSSOVER PLATE	8 1/2 in	6.02	90.32
14	12	SCK2	CROSSOVER PLATE	7 in	4.02	57.56
15	3	XAHCP	ANGLE HANDRAIL CORNER PLATE		12.92	38.76
17	3	P80174	2 7/8" O.D. X 1 1/4" SCH-40 PIPE	17 1/4 in	84.92	252.69
18	3	P8174	3 1/2" X 17 1/4" SCH-40 GALVANIZED PIPE	17 1/4 in	103.97	323.90
19	12	P80120	2 7/8" X 120" (2 1/2" SCH-40) GALVANIZED PIPE	120 in	58.02	896.70
20	18	G8R-48	5/8" X 48" THREADED ROD (HODG)		4.18	75.27
21	12	G8R-24	5/8" X 24" THREADED ROD (HODG)		2.09	37.63
22	12	A582114	5/8" X 2 1/4" NDG A325 HEX BOLT	2 1/4 in	0.31	3.75
23	12	A58234	5/8" X 2 3/8" NDG A325 HEX BOLT	2 3/4 in	0.36	4.27
24	60	A58FW	5/8" HODG A325 FLATWASHER		0.03	0.41
25	60	G58LW	5/8" HODG HEAVY 2H HEX NUT		0.03	1.57
26	6	G12112	1/2" X 1/2" HODG HEX BOLT G56	1/2 in	0.13	7.79
27	3	G12212	1/2" X 2 1/2" HODG HEX BOLT G56	2 1/2 in	0.15	0.88
28	12	G1204	1/2" X 4" HODG HEX BOLT G48 FULL THREAD	4 in	0.20	0.61
29	12	G12065	1/2" X 6 1/2" HODG HEX BOLT G48 FULL THREAD	5 1/2 in	0.27	3.24
30	84	X-UB1390	1/2" X 2 3/8" U-BOLT (HODG)		0.41	5.83
31	36	G121306	1/2" X 5 5/8" X 6" X 6" U-BOLT (HODG)		0.70	58.53
32	285	G12FW	1/2" HODG FLATWASHER		0.83	29.82
33	285	G12LW	1/2" HODG LOCKWASHER		0.83	9.82
34	285	G12NUT	1/2" HODG HEAVY 2H HEX NUT		0.01	3.96
35	1	HALO40	5,000 LB. MAINTENANCE TIE-OFF POINT		0.07	20.41
					41.12	41.12
						TOTAL WT. #
						329.41

**DETAIL C**

**DETAIL D**

**DETAIL E**

**DETAIL F**

**DETAIL G**

ATC SITE NUMBER:  
302483

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BRIN - BERLIN

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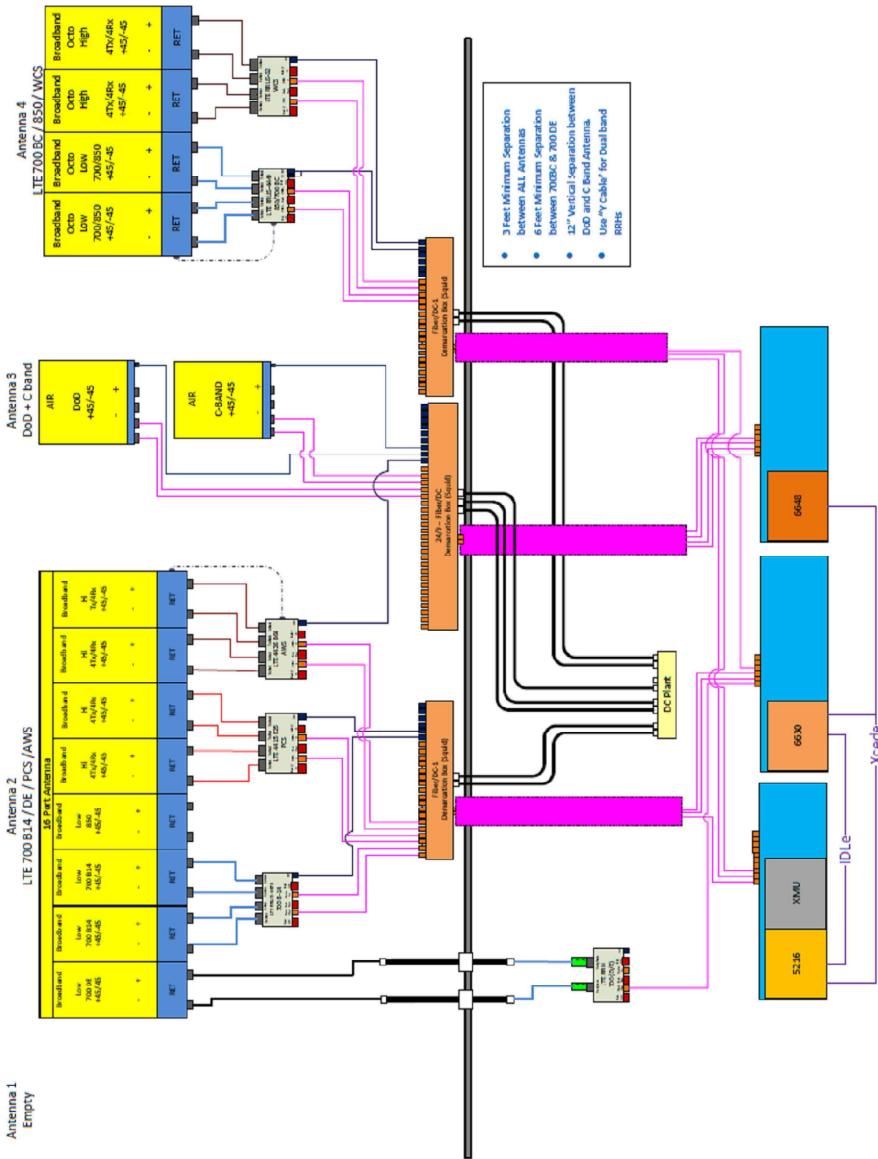
AMERICAN TOWER®

Dewberry Engineers Inc.  
98 SUMMER STREET  
SUITE 700  
BOSTON, MA 02110  
PHONE: 617.695.3400

## REDLINED PHOENIX UNITED 04/10/2023

Diagram - Sector A  
Diagram File Name: C11014 - ABC - CHAND DOD - Red, Red  
Location Name: BERLIN NE  
Market: CONNECTICUT  
Market Cluster: -  
Market Cluster: NEW ENGLAND

Comments: "Important Note: For detailed info to antenna wiring refer to the direct field nodes - Antennas - Radio Connection Drawings - Playbook v1.0 - Emerson."

ATC SITE NUMBER:  
302483ATC SITE NAME:  
BERLIN NEAT&T MOBILITY SITE NAME:  
BERLIN - BERLINSITE ADDRESS:  
206 BECKLEY ROAD

BERLIN, CT 06039

DATE DRAWN: 11/11/21

ATC JOB NO.: 13692831

CUSTOMER ID: BERLIN NE

CUSTOMER #: 1003499

## SUPPLEMENTAL

1 RFDS PLUMBING DIAGRAM

NOTE: THIS SHEET WAS CREATED BY OTHERS  
AND PROVIDED AT THE REQUEST OF THE  
CUSTOMER WITHOUT EDIT, GENERAL  
CONTRACTOR IS TO CHECK WITH THE AT&T  
MOBILITY CMO TO ENSURE THIS IS THE MOST  
RECENT VERSION OF THE RFDS.

SHEET NUMBER:  
R-605

1

Network: Apr 14, 2023 at 8:04:43 AM EDT

Local: Apr 14, 2023 at 8:04:42 AM EDT

