

COMPLIANCE CODE



ATC SITE NAME: BARKHAMSTEDW CT

ATC SITE NUMBER: 411177

PROJECT SUMMARY

VERIZON SITE NAME: BARKHAMSTED W CT

VERIZON SITE NUMBER:468464

SITE ADDRESS: 14 OLD NORTH ROAD

BARKHAMSTED, CT 06063-3440



LOCATION MAP

SHEET INDEX

VERIZON 5G L-SUB6 CARRIER ADD - ANTENNA AMENDMENT DRAWINGS

PROJECT DESCRIPTION

| ALL WORK SHALL BE PERFORMED AND MATERIALS INSTALLED IN ACCORDANCE WITH THE CURRENT EDITIONS OF THE FOLLOWING CODES AS ADOPTED BY THE LOCAL | SITE ADD | | THE PROPOSED PROJECT INCLUDES MODIFYING GROUND BASED AND TOWER MOUNTED EQUIPMENT AS INDICATED PER BELOW: | SHEET NO: | DESCRIPTION: | REV: | DATE: | BY: | |
|--|--|--|---|--------------|-----------------------------------|------|----------|-----|-----|
| GOVERNMENT AUTHORITIES. NOTHING IN THESE PLANS IS TO BE CONSTRUED TO PERMIT WORK NOT CONFORMING TO | 14 OLD NOR | | TOWER WORK: | G-001 | TITLE SHEET | 0 | 09/17/21 | FG | ۱t |
| THESE CODES. | BARKHAMSTED, | | REMOVE (6) ANTENNA(s), (3) RRH(s), (1) OVP, (9) 1-5/8" HYBRID CABLE | G-002 | GENERAL NOTES | 0 | 09/17/21 | FG | |
| 2018 CONNECTICUT STATE BUILDING CODE-AMENDMENTS TO IBC 2015 | COUNTY: LITCHF GEOGRAPHIC C | | INSTALL (9) ANTENNA(s), (6) RRH(s), (1) OVP, (1) 2.02" HYBRID CABLE | C-101 | DETAILED SITE PLAN | 0 | 09/17/21 | FG | 11 |
| INTERNATIONAL BUILDING CODE 2015, INTERNATIONAL | LATITUDE: | | AND MOUNT MODIFICATIONS EXISTING (6) ANTENNA(s) AND (9) 1-5/8" COAX CABLES TO REMAIN | C-201 | TOWER ELEVATION | 0 | 09/17/21 | FG | |
| CODE COUNCIL 3. TIA-222-G-4. STRUCTURAL STANDARD FOR ANTENNA | LONGITUDE | | EXISTING (6) ANTENNA(5) AND (3) 1-3/6 COAX CABLES TO REMAIN | C-401 | ANTENNA INFORMATION & SCHEDULE | 0 | 09/17/21 | FG | 1 |
| SUPPORTING STRUCTURES AND ANTENNAS | GROUND ELEVATION | N: 810' AMSL AMSL | | C-501 | CONSTRUCTION DETAILS | 0 | 09/17/21 | FG | 1 |
| ASCE 7-10 MINIMUM DESIGN LOADS FOR BUILDINGS AND OTHER STRUCTURES, AMERICAN SOCIETY OF CIVIL | | | | E-501 | GROUNDING DETAILS | 0 | 09/17/21 | FG | 11 |
| ENGINEERS 5. STEEL CONSTRUCTION MANUAL 14TH EDITION, AMERICAN | | | | R-601 | SUPPLEMENTAL | | | | 11 |
| INSTITUTE OF STEEL CONSTRUCTION | | | | R-602 | SUPPLEMENTAL | | | | 11 |
| 6. CITY/COUNTY ORDINANCES | PROJEC ⁻ | T TEAM | PROJECT NOTES | | MOUNT MODIFICATION DWG (13 PAGES) | | | | |
| | TOWER OWNER: | APPLICANT: | THE FACILITY IS UNMANNED. | | | | | | |
| | AMERICAN TOWER | VERIZON WIRELESS | A TECHNICIAN WILL VISIT THE SITE APPROXIMATELY ONCE A MONTH FOR ROUTINE INSPECTION AND MAINTENANCE. | | | | | | Ш |
| | 10 PRESIDENTIAL WAY WOBURN, MA 01801 | 118 FLANDERS ROAD WESTBOROUGH, MA 01581 | THE PROJECT WILL NOT RESULT IN ANY SIGNIFICANT LAND DISTURBANCE OR EFFECT OF STORM WATER DRAINAGE. | | | | | | Ш |
| UTILITY COMPANIES | ENGINEER: | , | NO SANITARY SEWER, POTABLE WATER OR TRASH DISPOSAL IS REQUIRED. | | | | | |] [|
| POWER COMPANY: N/A | DEWBERRY ENGINEERS, INC. | | HANDICAP ACCESS IS NOT REQUIRED. THE PROJECT DEPICTED IN THESE PLANS QUALIFIES AS | | | | | | ┨├ |
| PHONE: N/A TELEPHONE COMPANY: N/A | 99 SUMMER STREET SUITE 700 | | AN ELIGIBLE FACILITIES REQUEST ENTITLED TO EXPEDITED REVIEW UNDER 47 U.S.C. 1455(A) AS A | | | | | | ۱ŀ |
| PHONE: N/A | BOSTON, MA 02110 | | MODIFICATION OF AN EXISTING WIRELESS TOWER THAT INVOLVES THE COLLOCATION REMOVAL AND/OR | | | | | | |
| 000 | PROPERTY OWNER: | | REPLACEMENT OF TRANSMISSION EQUIPMENT THAT IS NOT A SUBSTANTIAL CHANGE UNDER CFR 1.61000 (B)(7). | | | | | | 11 |
| | LAVIERI JOHN N & ETHEL C PO BOX 202 | | | | | | | | 11 |
| | BARKHAMSTED, CT 06063 | | PROJECT LOCATION DIRECTIONS | | | | | | 11 |
| | | | FROM EAST HARTFORD I-84 WEST TO RT. 44 RT. PAST RT.318 ON THE RIGHT. LOOK FOR STERLING ENGINEERING. TURN RIGHT IMMEDIATELY | | | | | | 1 F |
| Know what's below. | | | AFTER ANTIQUE STORE ONTO OLD FARM RD. TEN TURN LEFT ONTO PRIVATE DRIVE. TURN RIGHT BEFORE HOUSE ON THE STONE DRIVE. | | | | | | 11 |
| Call before you dig. | | | TAKE ANOTHER LEFT SITE IS AT END OF THE ROAD. THIS SITE HAS | | | | | 1 | 11 |





Dewberry Engineers Inc.
99 SUMMER STREET
SUITE 700
BOSTON, MA 02110
PHONE: 617.695.3400
FAX: 617.695.3310

| REV. | DESCRIPTION | BY | DATE |
|---------------------|-------------|-----|----------|
| <u> </u> | PRELIM | FG | 08/30/21 |
| <u></u> | FINAL | FG_ | 09/17/21 |
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SITE ADDRESS: 14 OLD NORTH ROAD BARKHAMSTED, CT 06063-3440

SEAL:

CONSTRUCTION OF THE PROPERTY OF THE PRO

verizon /

| DATE DRAWN: | 08/26/21 |
|--------------|------------------|
| ATC JOB NO: | 13714920 |
| CUSTOMER ID: | BARKHAMSTED W CT |
| CUSTOMER #: | 468464 |
| | |

TITLE SHEET

SHEET NUMBER:

G-001

REVISION:

GENERAL CONSTRUCTION NOTES:

- OWNER FURNISHED MATERIALS, VERIZON "THE COMPANY" WILL PROVIDE AND THE CONTRACTOR WILL INSTALL
- A. BTS EQUIPMENT FRAME (PLATFORM) AND ICEBRIDGE SHELTER (GROUND BUILD/CO-LOCATE ONLY)
 - AC/TELCO INTERFACE BOX (PPC)
 - ICE BRIDGE (CABLE TRAY WITH COVER) (GROUND BUILD/CO-LOCATE ONLY, GC TO FURNISH AND INSTALL FOR ROOFTOP INSTALLATION)
 - D. TOWERS, MONOPOLES
 - TOWER LIGHTING
 - GENERATORS & LIQUID PROPANE TANK
 - G. ANTENNA STANDARD BRACKETS, FRAMES AND PIPES FOR MOUNTING
 - ANTENNAS (INSTALLED BY OTHERS)
 - TRANSMISSION LINE
 - TRANSMISSION LINE JUMPERS
 - TRANSMISSION LINE CONNECTORS WITH WEATHERPROOFING KITS
 - TRANSMISSION LINE GROUND KITS
 - HANGERS
 - HOISTING GRIPS
 - O. BTS EQUIPMENT
- THE CONTRACTOR IS RESPONSIBLE TO PROVIDE ALL OTHER MATERIALS FOR THE COMPLETE INSTALLATION OF THE SITE INCLUDING, BUT NOT LIMITED TO, SUCH MATERIALS AS FENCING, STRUCTURAL STEEL SUPPORTING SUB-FRAME FOR PLATFORM, ROOFING LABOR AND MATERIALS GROUNDING RINGS GROUNDING WIRES COPPER-CLAD OR XIT CHEMICAL GROUND ROD(S), BUSS BARS, TRANSFORMERS AND DISCONNECT SWITCHES WHERE APPLICABLE, TEMPORARY ELECTRICAL POWER, CONDUIT LANDSCAPING COMPOUND STONE CRANES, CORE DRILLING, SLEEPERS AND RUBBER MATTING, REBAR, CONCRETE CAISSONS, PADS AND/OR AUGER MOUNTS, MISCELLANEOUS FASTENERS, CABLE TRAYS, NON-STANDARD ANTENNA FRAMES AND ALL OTHER MATERIAL AND LABOR REQUIRED TO COMPLETE THE JOB ACCORDING TO THE DRAWINGS AND SPECIFICATIONS. IT IS THE POSITION OF VERIZON TO APPLY FOR PERMITTING AND CONTRACTOR RESPONSIBLE FOR PICKUP AND PAYMENT OF REQUIRED
- ALL WORK SHALL CONFORM TO ALL CURRENT APPLICABLE FEDERAL, STATE, AND LOCAL CODES, INCLUDING ANSI/EIA/TIA-222, AND COMPLY WITH ATC CONSTRUCTION
- CONTRACTOR SHALL CONTACT LOCAL 811 FOR IDENTIFICATION OF UNDERGROUND UTILITIES PRIOR TO START OF CONSTRUCTION.
- CONTRACTOR SHALL BE RESPONSIBLE FOR COORDINATING ALL REQUIRED
- ALL DIMENSIONS TO, OF, AND ON EXISTING BUILDINGS, DRAINAGE STRUCTURES, AND SITE IMPROVEMENTS SHALL BE VERIFIED IN FIELD BY CONTRACTOR WITH ALL DISCREPANCIES REPORTED TO THE ENGINEER.
- DO NOT CHANGE SIZE OR SPACING OF STRUCTURAL ELEMENTS
- DETAILS SHOWN ARE TYPICAL: SIMILAR DETAILS APPLY TO SIMILAR CONDITIONS UNLESS
- THESE DRAWINGS DO NOT INCLUDE NECESSARY COMPONENTS FOR CONSTRUCTION SAFETY WHICH SHALL BE THE SOLE RESPONSIBILITY OF THE CONTRACTOR
- CONTRACTOR SHALL BRACE STRUCTURES UNTIL ALL STRUCTURAL ELEMENTS NEEDED FOR STABILITY ARE INSTALLED. THESE ELEMENTS ARE AS FOLLOWS: LATERAL BRACING,
- CONTRACTOR SHALL DETERMINE EXACT LOCATION OF EXISTING UTILITIES. GROUNDS DRAINS, DRAIN PIPES, VENTS, ETC, BEFORE COMMENCING WORK
- INCORRECTLY FABRICATED, DAMAGED, OR OTHERWISE MISFITTING OR NONCONFORMING MATERIALS OR CONDITIONS SHALL BE REPORTED TO THE VERIZON REP PRIOR TO REMEDIAL OR CORRECTIVE ACTION, ANY SUCH REMEDIAL ACTION SHALL REQUIRE WRITTEN APPROVAL BY THE VERIZON REP PRIOR TO PROCEEDING.
- EACH CONTRACTOR SHALL COOPERATE WITH THE VERIZON REP, AND COORDINATE HIS WORK WITH THE WORK OF OTHERS.
- CONTRACTOR SHALL REPAIR ANY DAMAGE CAUSED BY CONSTRUCTION OF THIS PROJECT TO MATCH EXISTING PRE-CONSTRUCTION CONDITIONS TO THE SATISFACTION
- ALL CABLE/CONDUIT ENTRY/EXIT PORTS SHALL BE WEATHERPROOFED DURING INSTALLATION LISING A SILICONE SEALANT
- WHERE EXISTING CONDITIONS DO NOT MATCH THOSE SHOWN IN THIS PLAN SET. CONTRACTOR SHALL NOTIFY THE VERIZON REP AND ENGINEER OF RECORD
- CONTRACTOR SHALL ENSURE ALL SUBCONTRACTORS ARE PROVIDED WITH A COMPLETE AND CURRENT SET OF DRAWINGS AND SPECIFICATIONS FOR THIS PROJECT.
- CONTRACTOR SHALL REMOVE ALL RUBBISH AND DEBRIS FROM THE SITE AT THE END OF
- CONTRACTOR SHALL COORDINATE WORK SCHEDULE WITH AMERICAN TOWER CORPORATION (ATC) AND TAKE PRECAUTIONS TO MINIMIZE IMPACT AND DISRUPTION OF OTHER OCCUPANTS OF THE FACILITY.
- CONTRACTOR SHALL FURNISH VERIZON AND AMERICAN TOWER CORPORATION (ATC) /ITH A PDF MARKED UP AS-BUILT SET OF DRAWINGS UPON COMPLETION OF WORK
- PRIOR TO SUBMISSION OF BID. CONTRACTOR SHALL COORDINATE WITH VERIZON REP TO DETERMINE WHAT, IF ANY, ITEMS WILL BE PROVIDED. ALL ITEMS NOT PROVIDED SHALL BE PROVIDED AND INSTALLED BY THE CONTRACTOR. CONTRACTOR WILL INSTALL

- 22. PRIOR TO SUBMISSION OF BID, CONTRACTOR SHALL COORDINATE WITH VERIZON REP TO DETERMINE IF ANY PERMITS WILL BE OBTAINED BY CONTRACTOR. ALL REQUIRED PERMITS NOT OBTAINED BY VERIZON MUST BE OBTAINED, AND PAID FOR, BY THE
- 23. CONTRACTOR SHALL INSTALL ALL SITE SIGNAGE IN ACCORDANCE WITH VERIZON SPECIFICATIONS AND REQUIREMENTS.
- 24. CONTRACTOR SHALL SUBMIT ALL SHOP DRAWINGS TO VERIZON FOR REVIEW AND
- ALL EQUIPMENT SHALL BE INSTALLED ACCORDING TO MANUFACTURER'S SPECIFICATIONS AND LOCATED ACCORDING TO VERIZON SPECIFICATIONS, AND AS SHOWN IN THESE PLANS
- 26. THE CONTRACTOR SHALL SUPERVISE AND DIRECT THE PROJECT DESCRIBED HEREIN THE CONTRACTOR SHALL BE SOLELY RESPONSIBLE FOR ALL THE CONSTRUCTION MEANS, METHODS, TECHNIQUES, SEQUENCES AND PROCEDURES AND FOR COORDINATING ALL PORTIONS OF THE WORK UNDER THE CONTRACT.
- CONTRACTOR SHALL NOTIFY VERIZON REP A MINIMUM OF 48 HOURS IN ADVANCE OF POURING CONCRETE OR BACKFILLING ANY UNDERGROUND UTILITIES, FOUNDATIONS OR SEALING ANY WALL, FLOOR OR ROOF PENETRATIONS FOR ENGINEERING REVIEW AND
- CONTRACTOR SHALL BE RESPONSIBLE FOR SITE SAFETY INCLUDING COMPLIANCE WITH ALL APPLICABLE OSHA STANDARDS AND RECOMMENDATIONS AND SHALL PROVIDE ALL NECESSARY SAFETY DEVICES INCLUDING PPE AND PPM AND CONSTRUCTION DEVICES SUCH AS WELDING AND FIRE PREVENTION, TEMPORARY SHORING, SCAFFOLDING, TRENCH BOXES/SLOPING, BARRIERS, ETC.
- THE CONTRACTOR SHALL PROTECT AT HIS OWN EXPENSE, ALL EXISTING FACILITIES AND SPECIAL CONSTRUCTION SUCH OF HIS NEW WORK LIABLE TO INJURY DURING THE CONSTRUCTION PERIOD. ANY DAMAGE CAUSED BY NEGLECT ON THE PART OF THIS CONTRACTOR OR HIS REPRESENTATIVES, OR BY THE ELEMENTS DUE TO NEGLECT ON THE PART OF THIS CONTRACTOR OR HIS REPRESENTATIVES, EITHER TO THE EXISTING WORK, OR TO HIS WORK OR THE WORK OF ANY OTHER CONTRACTOR, SHALL BE REPAIRED AT HIS EXPENSE TO THE OWNER'S SATISFACTION.
- ALL WORK SHALL BE INSTALLED IN A FIRST CLASS, NEAT AND WORKMANLIKE MANNER BY MECHANICS SKILLED IN THE TRADE INVOLVED. THE QUALITY OF WORKMANSHIP SHALL BE SUBJECT TO THE APPROVAL OF THE VERIZON REP. ANY WORK FOUND BY THE VERIZON REP TO BE OF INFERIOR QUALITY AND/OR WORKMANSHIP SHALL BE REPLACED AND/OR REWORKED AT CONTRACTOR EXPENSE UNTIL APPROVAL IS
- 31. IN ORDER TO ESTABLISH STANDARDS OF QUALITY AND PERFORMANCE, ALL TYPES OF MATERIALS LISTED HEREINAFTER BY MANUFACTURER'S NAMES AND/OR
 MANUFACTURER'S CATALOG NUMBER SHALL BE PROVIDED BY THESE MANUFACTURERS
- VERIZON FURNISHED EQUIPMENT SHALL BE PICKED-UP AT THE VERIZON WAREHOUSE AND INSTALLED BY THE CONTRACTOR WITH ALL APPURTENANCES REQUIRED TO PLACE THE EQUIPMENT IN OPERATION, READY FOR USE. THE CONTRACTOR SHALL BE RESPONSIBLE FOR THE EQUIPMENT AFTER PICKING IT UP.
- VERIZON OR HIS ARCHITECT/ENGINEER RESERVES THE RIGHT TO REJECT ANY 33. EQUIPMENT OR MATERIALS WHICH, IN HIS OWN OPINION ARE NOT IN COMPLIANCE WITH THE CONTRACT DOCUMENTS, EITHER BEFORE OR AFTER INSTALLATION AND THE EQUIPMENT SHALL BE REPLACED WITH EQUIPMENT CONFORMING TO THE REQUIREMENTS OF THE CONTRACT DOCUMENTS BY THE CONTRACTOR AT NO COST TO VERIZON OR THEIR ARCHITECT/ENGINEER

STRUCTURAL STEEL NOTES:

- STRUCTURAL STEEL SHALL CONFORM TO THE LATEST EDITION OF THE AISC "SPECIFICATION FOR THE DESIGN, FABRICATION AND ERECTION OF STRUCTURAL STEEL
- STRUCTURAL STEEL ROLLED SHAPES, PLATES AND BARS SHALL CONFORM TO THE FOLLOWING ASTM DESIGNATIONS:
 - A. ASTM A-572, GRADE 50 ALL W SHAPES, UNLESS NOTED OR A992 OTHERWISE
 - B. ASTM A-36 ALL OTHER ROLLED SHAPES, PLATES AND BARS UNLESS NOTED
 - C. ASTM A-500, GRADE B HSS SECTION (SQUARE, RECTANGULAR, AND ROUND)
 - D. ASTM A-325, TYPE SC OR N ALL BOLTS FOR CONNECTING STRUCTURAL
 - E. ASTM F-1554 07 ALL ANCHOR BOLTS, UNLESS NOTED OTHERWISE
- ALL EXPOSED STRUCTURAL STEEL MEMBERS SHALL BE HOT-DIPPED GALVANIZED AFTER FABRICATION PER ASTM A123. EXPOSED STEEL HARDWARE AND ANCHOR BOLTS SHALL BE GALVANIZED PER ASTM A153 OR B695
- ALL FIELD CUT SURFACES, FIELD DRILLED HOLES AND GROUND SURFACES WHERE EXISTING PAINT OR GALVANIZATION REMOVAL WAS REQUIRED SHALL BE REPAIRED WITH (2) BRUSHED COATS OF ZRC GALVILITE COLD GALVANIZING COMPOUND PER ASTM A780 AND MANUFACTURER'S RECOMMENDATIONS.
- DO NOT DRILL HOLES THROUGH STRUCTURAL STEEL MEMBERS EXCEPT AS SHOWN AND DETAILED ON STRUCTURAL DRAWINGS.
- CONNECTIONS:
 - A. ALL WELDING TO BE PERFORMED BY AWS CERTIFIED WELDERS AND CONDUCTED IN ACCORDANCE WITH THE LATEST EDITION OF THE AWS WELDING

- ALL WELDS SHALL BE INSPECTED VISUALLY. 25% OF WELDS SHALL BE INSPECTED WITH DYE PENETRANT OR MAGNETIC PARTICLE TO MEET THE ACCEPTANCE CRITERIA OF AWS D1 1 REPAIR ALL WELDS AS NECESSARY
- C. INSPECTION SHALL BE PERFORMED BY AN AWS CERTIFIED WELD INSPECTOR.
- D. IT IS THE CONTRACTORS RESPONSIBILITY TO PROVIDE BURNING/WELDING PERMITS AS REQUIRED BY LOCAL GOVERNING AUTHORITY AND IF REQUIRED SHALL HAVE FIRE DEPARTMENT DETAIL FOR ANY WELDING ACTIVITY.
- E. ALL ELECTRODES TO BE LOW HYDROGEN, MATCHING FILLER METAL, PER AWS
- F. MINIMUM WELD SIZE TO BE 0.1875 INCH FILLET WELDS, UNLESS NOTED
- G PRIOR TO FIELD WELDING GALVANIZING MATERIAL CONTRACTOR SHALL GRIND OFF GALVANIZING %' BEYOND ALL FIELD WELD SURFACES. AFTER WELD AND WELD INSPECTION IS COMPLETE, REPAIR ALL GROUND AND WELDED SURFACES WITH ZRC GALVILITE COLD GALVANIZING COMPOUND PER ASTM A780 AND MANUFACTURERS RECOMMENDATIONS.
- THE CONTRACTOR SHALL PROVIDE ADEQUATE SHORING AND/OR BRACING WHERE REQUIRED DURING CONSTRUCTION UNTIL ALL CONNECTIONS ARE
- ANY FIELD CHANGES OR SUBSTITUTIONS SHALL HAVE PRIOR APPROVAL FROM THE ENGINEER, AND T- MOBILE PROJECT MANAGER IN WRITING

ANTENNA INSTALLATION NOTES:

- WORK INCLUDED:
 - ANTENNA AND COAXIAL CABLES ARE FURNISHED BY VERIZON UNDER A SEPARATE CONTRACT. THE CONTRACTOR SHALL ASSIST ANTENNA INSTALLATION CONTRACTOR IN TERMS OD COORDINATION AND SITE ACCESS. ERECTION SUBCONTRACTOR SHALL BE RESPONSIBLE FOR THE PROTECTION OF PERSONNEL AND
 - B. INSTALL ANTENNA AS INDICATE ON DRAWINGS AND VERIZON SPECIFICATIONS.
 - C. INSTALL GALVANIZED STEEL ANTENNA MOUNTS AS INDICATED ON DRAWINGS
 - D. INSTALL FURNISHED GALVANIZED STEEL OR ALUMINUM WAVEGUIDE AND PROVIDE PRINTOUT OF THAT TEST
 - F CONTRACTOR SHALL PROVIDE FOUR (4) SETS OF SWEEP TESTS USING ANRITZU-PACKARD 8713B RF SCALAR NETWORK ANALYZER. SUBMIT FREQUENCY DOMAIN REFLECTOMETER(FDR) TESTS RESULTS TO THE PROJECT MANAGER. SWEEP TESTS SHALL BE AS PER ATTACHED RES "MINIMUM FIELD TESTING RECOMMENDED FOR ANTENNA AND HELIAX COAXIAL CABLE SYSTEMS" DATED 10/5/93, TESTING SHALL BE PERFORMED BY AN INDEPENDENT TESTING SERVICE AND BE BOUND AND SUBMITTED WITHIN ONE WEEK OF WORK COMPLETION.
 - INSTALL COAXIAL CABLES AND TERMINATING BETWEEN ANTENNAS AND EQUIPMENT PER MANUFACTURER'S RECOMMENDATIONS. WEATHERPROOF ALL CONNECTIONS BETWEEN THE ANTENNA AND EQUIPMENT PER MANUFACTURER'S REQUIREMENTS. TERMINATE ALL COAXIAL CABLE THREE (3) FEET IN EXCESS OF ENTRY PORT LOCATION UNLESS OTHERWISE STATED.
 - G. ANTENNA AND COAXIAL CABLE GROUNDING:
- ALL EXTERIOR #6 GREED GROUND WIRE "DAISY CHAIN" CONNECTIONS ARE TO BE WEATHER SEALED WITH RFS CONNECTORS/SPLICE WEATHERPROOFING KIT #221213 OR
- ALL COAXIAL CABLE GROUNDING KITS ARE TO BE INSTALLED ON STRAIGHT RUNS OF COAXIAL CABLE (NOT WITHIN BENDS)

ALL DISCREPANCIES FROM WHAT IS SHOWN ON THESE CONSTRUCTION DRAWINGS SHALL BE COMMUNICATED TO ATC ENGINEERING IMMEDIATELY FOR CORRECTION OR RE-DESIGN. FAILURE TO COMMUNICATE DIRECTLY WITH ATC ENGINEERING OR ANY CHANGES FROM THE DESIGN CONDUCTED WITHOUT PRIOR APPROVAL FROM ATC ENGINEERING SHALL BE THE SOLE RESPONSIBILITY OF THE GENERAL CONTRACTOR.





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| ATE /30/21 |
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| 30/21 |
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| 17/21 |
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ATC SITE NUMBER: 411177

ATC SITE NAME: **BARKHAMSTEDW CT**

VERIZON SITE NAME:

BARKHAMSTED W CT

SITE ADDRESS: 14 OLD NORTH ROAD BARKHAMSTED, CT 06063-3440





DATE DRAWN: 08/26/21 ATC JOB NO: 13714920 CUSTOMER ID: BARKHAMSTED W CT CUSTOMER #: 468464

GENERAL NOTES

SHEET NUMBER:

G-002

REVISION

SITE PLAN NOTES:


- 1. THIS SITE PLAN REPRESENTS THE BEST PRESENT KNOWLEDGE AVAILABLE TO THE ENGINEER AT THE TIME OF THIS DESIGN. THE CONTRACTOR SHALL VISIT THE SITE PRIOR TO CONSTRUCTION AND VERIFY ALL EXISTING CONDITIONS RELATED TO THE SCOPE OF WORK FOR THIS PROJECT.
- ICE BRIDGE, CABLE LADDER, COAX PORT, AND COAX CABLE ARE SHOWN FOR REFERENCE ONLY. CONTRACTOR SHALL CONFIRM THE EXACT LOCATION OF ALL PROPOSED AND EXISTING EQUIPMENT AND STRUCTURES DEPICTED ON THIS PLAN. BEFORE UTILIZING EXISTING CABLE SUPPORTS, COAX PORTS, INSTALLING NEW PORTS OR ANY OTHER EQUIPMENT, CONTRACTOR SHALL VERIFY ALL ASPECTS OF THE COMPONENTS MEET THE ATC SPECIFICATIONS.
- 3. NO ELECTRICAL SCOPE IS INCLUDED IN THIS PROJECT.


LEGEND GROUNDING TEST WELL ATS AUTOMATIC TRANSFER SWITCH BOLLARD CSC CELL SITE CABINET DISCONNECT D ELECTRICAL **FIBER** GEN GENERATOR GENERATOR RECEPTACAL HH, V HAND HOLE, VAULT ICE BRIDGE KENTROX BOX LC LIGHTING CONTROL РΒ PULL BOX PP POWER POLE TELCO TRN TRANSFORMER

CHAINLINK FENCE

PROPOSED CABLE LENGTH:

- ESTIMATED LENGTH OF PROPOSED CABLE IS <u>226'</u>.
 ESTIMATED LENGTH OF CABLE WAS PROVIDED BY
 CUSTOMER OR CALCULATED BY ADDING THE RAD
 CENTER AND THE DISTANCE FROM THE SHELTER
 ENTRY PLATE TO THE TOWER (ALONG THE ICE
 BRIDGE) AND A SAFETY FACTOR MEASUREMENT OF
 15% (OF THE TWO PREVIOUS VALUES), CDS DEFER
 TO GREATEST CABLE LENGTH.
- 2. ROUTE PROPOSED CABLES ALONG SAME PATH AS EXISTING CABLES AND IN ACCORDANCE WITH STRUCTURAL ANALYSIS. WHERE POSSIBLE UTILIZE EXISTING CABLE SUPPORT STRUCTURES AS PROVIDED FOR CARRIER TO ADEQUATELY SECURE CABLES, USING EITHER APPROPRIATELY SIZED STAINLESS STEEL SNAP-INS OR MOUNTING HARDWARE AND BRACKETS AS SPECIFIED BY CABLE MANUFACTURER. OTHERWISE, ATTACH CABLES TO HORIZONTAL OR DIAGONAL TOWER MEMBERS USING PROPOSED STAINLESS STEEL ADAPTERS (DO NOT ATTACH TO TOWER LEG).

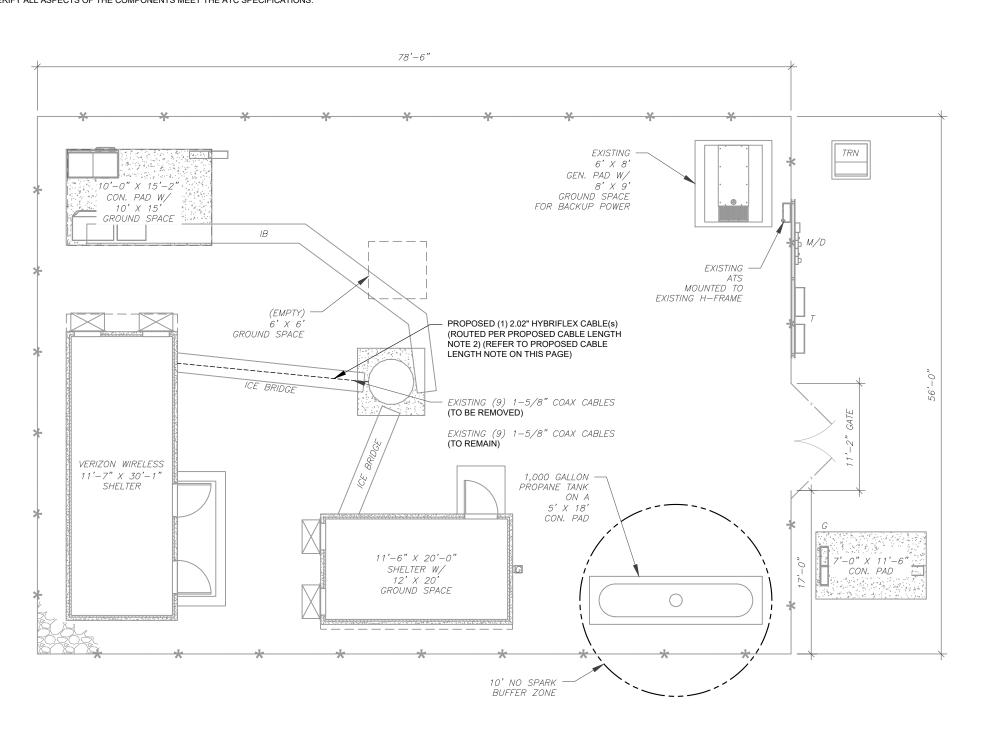

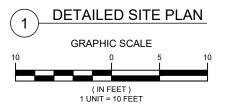







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VERIZON SITE NAME:

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SITE ADDRESS: 14 OLD NORTH ROAD BARKHAMSTED, CT 06063-3440

SEAL






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| | ATC JOB NO: | 13714920 |
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| | CUSTOMER #: | 468464 |
| | | |

DETAILED SITE PLAN

SHEET NUMBER:

C-101

REVISION

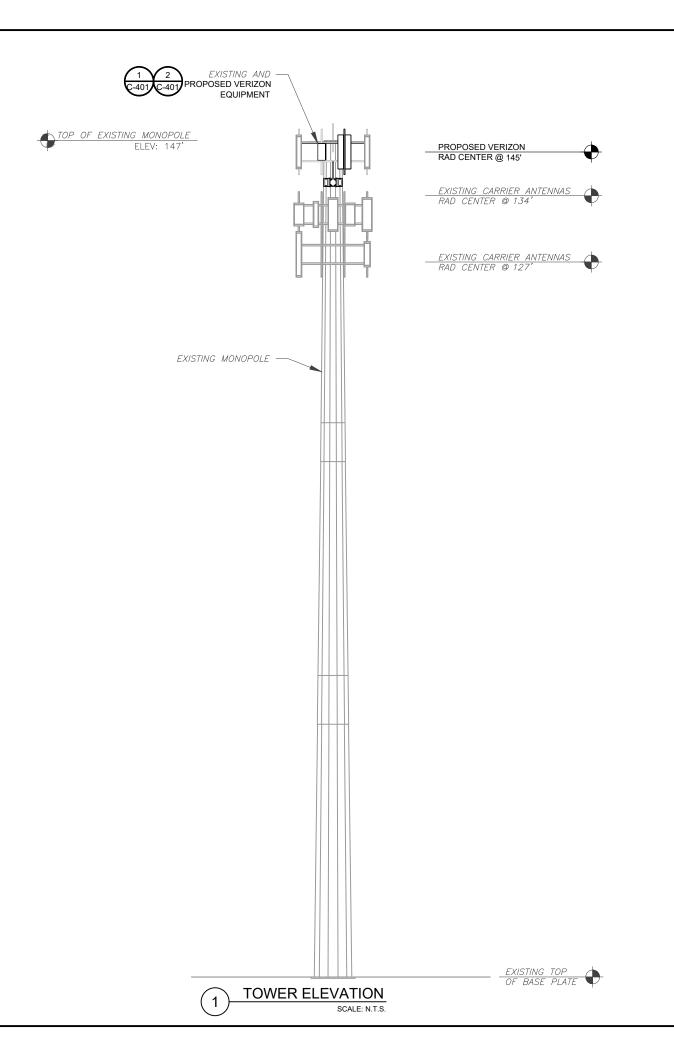

THE INSTALLATION OF THE PROPOSED ANTENNAS AND OTHER EQUIPMENT.

PER MOUNT ANALYSIS COMPLETED BY MASER CONSULTING CONNECTICUT, DATED 07/02/21, THE EXISTING MOUNT MUST BE MODIFIED TO ADEQUATELY SUPPORT THE PROPOSED LOADING. THE MOUNT MODIFICATION DETAILED AT THE END OF THIS PLAN SET, MUST BE INSTALLED PRIOR TO

- TOWER NOTE:

 1. IT IS THE CONTRACTOR'S RESPONSIBILITY TO CONFIRM WITH THE PROJECT MANAGER THAT THEY HAVE THE MOST RECENT VERSION OF THE STRUCTURAL ANALYSIS BEFORE COMMENCING WORK. EXISTING AND PROPOSED TOWER APPURTENANCES, MOUNTS, AND ANTENNAS ARE SHOWN BASED ON THE STRUCTURAL ANALYSIS.
- 2. WHERE APPLICABLE, ALL NEW ANTENNAS, EQUIPMENT, MOUNTS, CABLING, ETC. SHALL BE PAINTED/SOCKED TO MATCH EXISTING EQUIPMENT IN ACCORDANCE WITH FAA, JURISDICTION, AND/OR OTHER LOCAL REQUIREMENTS.
- ROUTE PROPOSED CABLES ALONG SAME PATH AS EXISTING CABLES AND IN ACCORDANCE WITH STRUCTURAL ANALYSIS. IF ADEQUATE SPACE EXISTS, ROUTE CABLES THROUGH ENTRY PORT HOLE, UP INSIDE OF MONOPOLE, AND THROUGH EXIT PORT HOLE. IF ROUTING OUTSIDE THE MONOPOLE, ATTACH CABLES USING STAND-OFF ADAPTERS MOUNTED TO TOWER USING STAINLESS STEEL BANDING. ADEQUATELY SECURE CABLES USING EITHER APPROPRIATELY SIZED STAINLESS STEEL SNAP-INS OR MOUNTING HARDWARE AND BRACKETS AS SPECIFIED BY CABLE MANUFACTURER.
- 4. TOWER ELEVATIONS ARE MEASURED FROM TOP OF BASE PLATE TO MATCH STRUCTURAL ANALYSIS. ELEVATIONS DO NOT REFLECT TRUE ABOVE GROUND LEVEL (A.G.L.)





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| | | | |

ATC SITE NUMBER: 411177

ATC SITE NAME: BARKHAMSTEDW CT

VERIZON SITE NAME:

BARKHAMSTED W CT

SITE ADDRESS: 14 OLD NORTH ROAD BARKHAMSTED, CT 06063-3440






| DATE DRAWN: | 08/26/21 |
|--------------|------------------|
| ATC JOB NO: | 13714920 |
| CUSTOMER ID: | BARKHAMSTED W CT |
| CUSTOMER #: | 468464 |
| | |


TOWER ELEVATION

SHEET NUMBER:

REVISION:

C-201

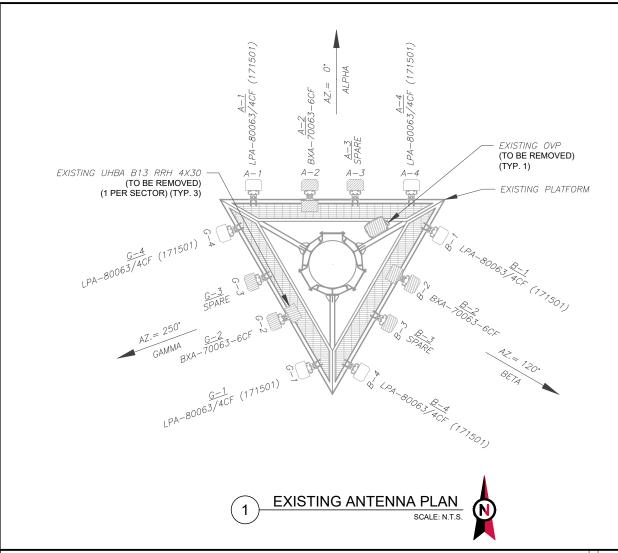

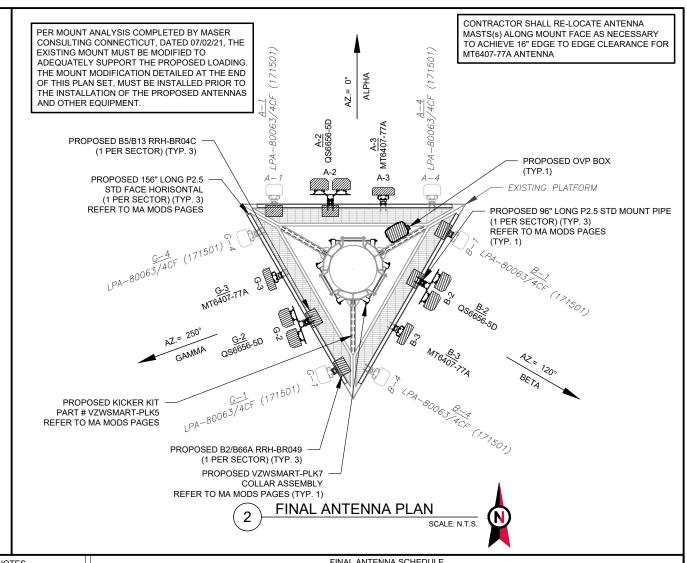

| | EXISTING ANTENNA SCHEDULE | | | | | | | | |
|----------|---------------------------|------|-----|------------------------|----------|---------------------|--------|------------------------------------|--------|
| LOC | LOCATION | | | ANTENNA S | SUMMARY | | | NON ANTENNA SUMMA | ARY |
| SECTOR | RAD | AZ | POS | ANTENNA | BAND | MECH/ELEC D-TILT | STATUS | ADDITIONAL TOWER MOUNTED EQUIPMENT | STATUS |
| | | | A1 | LPA-80063/4CF (171501) | 850 CDMA | 0/0 | RMN | _ | - |
| 41.07.74 | ۱,,, | ٥. | A2 | BXA-70063-6CF | 700 | 0/2 | RMV | UHBA B13 RRH 4X30 | RMV |
| ALPHA | 145' | 0° | A3 | SPARE | _ | _ | RMV | _ | - |
| | | | A4 | LPA-80063/4CF (171501) | 850 CDMA | 0/0 | RMN | _ | - |
| | | | B1 | LPA-80063/4CF (171501) | 850 CDMA | 4/0 | RMN | = | - |
| DETA | 145' | 120° | B2 | BXA-70063-6CF | 700 | 4/2 | RMV | UHBA B13 RRH 4X30 | RMV |
| BETA | | 120 | В3 | SPARE | _ | _ | RMV | _ | - |
| | | | B4 | LPA-80063/4CF (171501) | 850 CDMA | 4/0 | RMN | _ | - |
| | | | G1 | LPA-80063/4CF (171501) | 850 CDMA | 3/0 | RMN | - | - |
| C414144 | 1,45, | 2400 | G2 | BXA-70063-6CF | 700 | 3/2 | RMV | UHBA B13 RRH 4X30 | RMV |
| GAMMA | 145' | 240° | G3 | SPARE | _ | _ | RMV | _ | _ |
| | | | G4 | LPA-80063/4CF (171501) | 850 CDMA | 3/0 | RMN | _ | _ |

| NOTES | | FINAL ANTENNA SCHEDULE | | | | | | | | |
|---|-----------|--------------------------|------|-----|------------------------|-------------------|---------------------|-----------------|------------------------------------|--------|
| CONFIRM WITH VERIZON REP | L | LOCATION ANTENNA SUMMARY | | | | | | NON ANTENNA SUM | NON ANTENNA SUMMARY | |
| FOR APPLICABLE UPDATES/REVISIONS AND MOST RECENT RFDS FOR NSN | SECTOR | RAD | AZ | POS | ANTENNA | BAND | MECH/ELEC D-TILT | STATUS | ADDITIONAL TOWER MOUNTED EQUIPMENT | STATUS |
| CONFIGURATION (CONFIG). GC | | | | A1 | LPA-80063/4CF (171501) | 850 CDMA | 0/0 | RMN | B2/B66A RRH-BR049 | ADD |
| TO CAP ALL UNUSED PORTS. 2. CONFIRM SPACING OF | AL DUA | 145' | 0° | A2 | (2) QS6656-5D | 700/850/1900/2100 | 0/2,2,2,2 | ADD | B5/B13 RRH-BR04C | ADD |
| PROPOSED EQUIP DOES NOT | ALPHA | 145 | | A3 | MT6407-77A | L-SUB6 | 0/3 | ADD | - | - |
| CAUSE TOWER CONFLICTS NOR IMPEDE TOWER CLIMBING | | | | A4 | LPA-80063/4CF (171501) | 850 CDMA | 0/0 | RMN | - | - |
| PEGS. | | | | B1 | LPA-80063/4CF (171501) | 850 CDMA | 4/0 | RMN | B2/B66A RRH-BR049 | ADD |
| | BETA | 145' | 1200 | B2 | (2) QS6656-5D | 700/850/1900/2100 | 0/6,6,3,3 | ADD | B5/B13 RRH-BR04C | ADD |
| STATUS ABBREVIATIONS | DETA | 145 | 120° | В3 | MT6407-77A | L-SUB6 | 0/3 | ADD | - | - |
| | | | | B4 | LPA-80063/4CF (171501) | 850 CDMA | 4/0 | RMN | - | - |
| RMV: TO BE REMOVED RMN: TO REMAIN | | | | G1 | LPA-80063/4CF (171501) | 850 CDMA | 3/0 | RMN | B2/B66A RRH-BR049 | ADD |
| REL: TO BE RELOCATED | GAMMA | 145' | 250° | G2 | (2) QS6656-5D | 700/850/1900/2100 | 0/5,5,3,3 | ADD | B5/B13 RRH-BR04C | ADD |
| ADD: TO BE ADDED | GAIVIIVIA | 145 | 250 | G3 | MT6407-77A | L-SUB6 | 0/3 | ADD | - | - |
| | | | | G4 | LPA-80063/4CF (171501) | 850 CDMA | 3/0 | PMN | | |

CABLE LENGTHS FOR JUMPERS

JUNCTION BOX TO RRU: 15' RRU TO COMBINER: 10' COMBINER TO ANTENNA: 10'

| EXISTING FIBER DISTRIBUTION/O | /P BOX | EXISTI | NG CABLING SUMMARY | |
|-------------------------------|--------|------------|--------------------|--------|
| MODEL NUMBER | STATUS | COAX | HYBRID | STATUS |
| (1) OVP | RMV | (9) 1-5/8" | _ | RMV |
| _ | _ | (9) 1-5/8" | _ | RMN |

| \bigcirc | EQUIPMENT SCHEDULES |
|------------|----------------------------|
| (3) | |

| FINAL FIBER DISTRIBUTION / OVE | PBOX | FINAL | FINAL CABLING SUMMARY | |
|--------------------------------|--------|------------|-----------------------|--------|
| MODEL NUMBER | STATUS | COAX | HYBRID | STATUS |
| (1) DB-C1-12C-24AB-0Z | ADD | - | (1) 2.02" | ADD |
| - | - | (9) 1-5/8" | _ | RMN |





Dewberry Engineers Inc.
99 SUMMER STREET
SUITE 700
BOSTON, MA 02110
PHONE: 617.695.3400
FAX: 617.695.3310

| ı | REV. | DESCRIPTION | BY | DATE |
|---|---------------------|-------------|----|----------|
| | A_ | PRELIM | FG | 08/30/21 |
| | <u></u> | FINAL | FG | 09/17/21 |
| | \triangle | | | |
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| ı | $\overline{\wedge}$ | | | |

ATC SITE NUMBER: 411177

ATC SITE NAME:
BARKHAMSTEDW CT

VERIZON SITE NAME:

BARKHAMSTED W CT

SITE ADDRESS: 14 OLD NORTH ROAD BARKHAMSTED, CT 06063-3440

SEAL:

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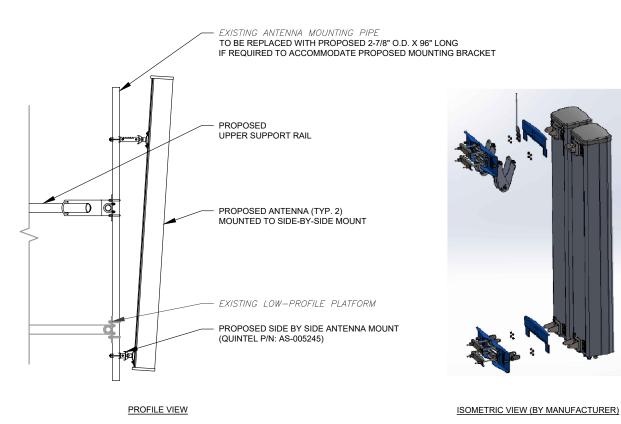
verizon /

| DATE DRAWN: | 08/26/21 |
|--------------|------------------|
| ATC JOB NO: | 13714920 |
| CUSTOMER ID: | BARKHAMSTED W CT |
| CUSTOMER #: | 468464 |


ANTENNA INFORMATION & SCHEDULE

| SHEET NUMBER: | |
|---------------|--|
| C-401 | |

REVISION:




PROPOSED SIDE-BY-SIDE MOUNT
SCALE: NOT TO SCALE

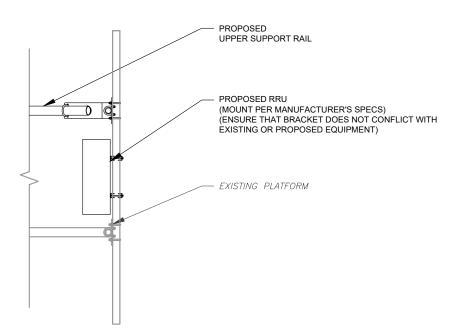


PROPOSED RRU MOUNTING DETAIL - TYPICAL

SCALE: N.T.S.

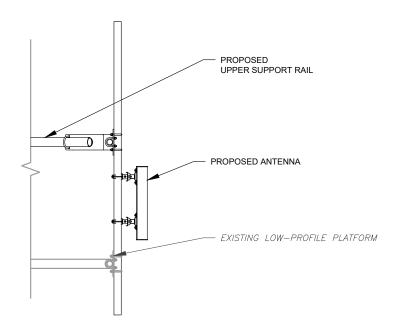

PROPOSED 5G ANTENNA MOUNTING DETAIL - TYPICAL

SCALE: N.T.S.

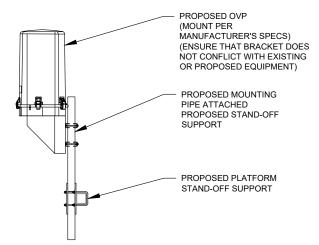

4 PROPOSED OVP MOUNTING SCALE: N.T.S.





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BOSTON, MA 02110
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| REV. | DESCRIPTION | BY | DATE |
|-------------------------|-------------|----|----------|
| <u> </u> | PRELIM | FG | 08/30/21 |
| <u></u> ∕0\ | FINAL | FG | 09/17/21 |
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| $\overline{\wedge}^{-}$ | | | |
| $\overline{\wedge}$ | | | |

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SITE ADDRESS: 14 OLD NORTH ROAD BARKHAMSTED, CT 06063-3440

CENSONAL ENGINE




| DATE DRAWN: | 08/26/21 |
|--------------|------------------|
| ATC JOB NO: | 13714920 |
| CUSTOMER ID: | BARKHAMSTED W CT |
| CUSTOMER #: | 468464 |
| | |

CONSTRUCTION DETAILS

SHEET NUMBER:


C-501

REVISION

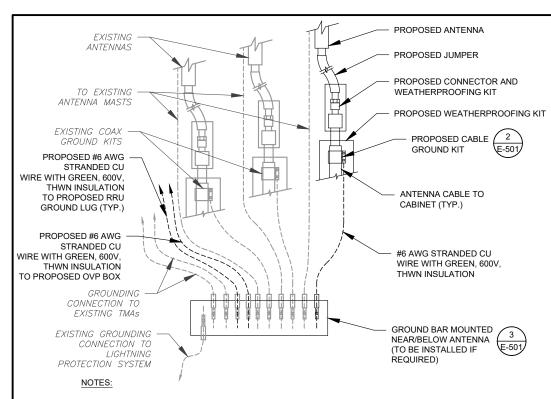

- 1. THIS DETAIL IS INTENDED TO SHOW THE GENERAL GROUNDING REQUIREMENTS. SLIGHT ADJUSTMENTS MAY BE REQUIRED BASED ON EXISTING SITE CONDITIONS. THE CONTRACTOR SHALL MAKE FIELD ADJUSTMENTS AS NEEDED AND INFORM THE CONSTRUCTION MANAGER OF ANY CONFLICTS.
- 2. SITE GROUNDING SHALL COMPLY WITH VERIZON GROUNDING STANDARDS, LATEST EDITION, AND COMPLY WITH VERIZON GROUNDING CHECKLIST, LATEST VERSION. WHEN NATIONAL AND LOCAL GROUNDING CODES ARE MORE STRINGENT THEY SHALL GOVERN.




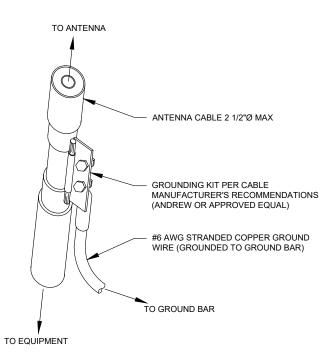

- GROUND KIT NOTES:

 1. DO NOT INSTALL CABLE GROUND KIT AT A BEND AND ALWAYS DIRECT GROUND WIRE DOWN TO GROUND BAR.
- 2. CONTRACTOR SHALL PROVIDE WEATHERPROOFING KIT (ANDREW PART NUMBER 221213) AND INSTALL/TAPE PER MANUFACTURER'S SPECIFICATIONS.

CABLE GROUND KIT CONNECTION DETAIL

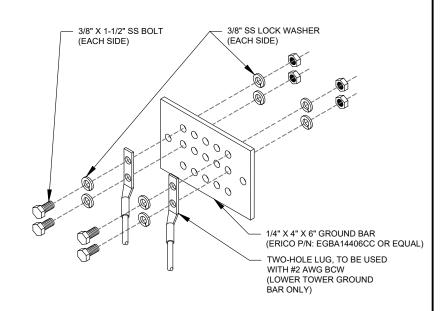

GROUND BAR NOTES:

- GROUND BAR KITS COME WITH ALL HARDWARE, NUTS, BOLTS, WASHERS, ETC. EXCEPT THE STRUCTURAL MOUNTING MEMBER(S).
- 2. GROUND BAR TO BE BONDED DIRECTLY TO TOWER.







Dewberry Engineers Inc. 99 SUMMER STREET SUITE 700 BOSTON, MA 02110 PHONE: 617.695.3400 FAX: 617.695.3310

| REV. | DESCRIPTION | BY | DATE |
|---------------------|-------------|----|----------|
| <u> </u> | PRELIM | FG | 08/30/21 |
| <u> </u> | FINAL | FG | 09/17/21 |
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| $\overline{\wedge}$ | | | |

ATC SITE NUMBER: 411177

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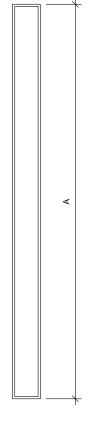
| DATE DRAWN: | 08/26/21 |
|--------------|------------------|
| ATC JOB NO: | 13714920 |
| CUSTOMER ID: | BARKHAMSTED W CT |
| CUSTOMER #: | 468464 |
| | |


GROUNDING DETAILS

SHEET NUMBER:

E-501

REVISION:




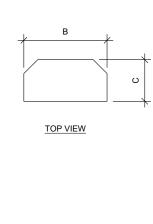

FRONT VIEW

1 ANTENNA SPECIFICATIONS FOR ILLUSTRATIVE PURPOSES ONLY - NOT TO SCALE

| ANTENNA SPECIFICATIONS | | | | |
|------------------------|-------|-------|------|-----------------|
| ANTENNA MODEL | А | В | С | WEIGHT (LBS) |
| MT6407-77A | 35.1" | 16.1" | 5.5" | 81.6 |
| QS6656-5D | 72.0" | 12.0" | 9.6" | 88.0 |

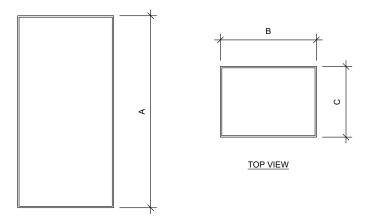

FRONT VIEW

2 RRU SPECIFICATIONS FOR ILLUSTRATIVE PURPOSES ONLY - NOT TO SCALE

| RRU SPECIFICATIONS | | | | |
|--------------------|-------|-------|-------|-----------------|
| RRU MODEL | А | В | С | WEIGHT (LBS) |
| B2/B66A RRH-BR049 | 15.0" | 15.0" | 10.0" | 84.4 |
| B5/B13 RRH-BR04C | 15.0" | 15.0" | 8.1" | 70.3 |





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SEAL



| DATE DRAWN: | 08/26/21 |
|--------------|------------------|
| ATC JOB NO: | 13714920 |
| CUSTOMER ID: | BARKHAMSTED W CT |
| CUSTOMER #: | 468464 |
| | |

SUPPLEMENTAL

SHEET NUMBER:

R-601





Maser Consulting Connecticut 2000 Midlantic Drive, Suite 100 Mt. Laurel, NJ 08054 856.797.0412 peter.albano@colliersengineering.com

Post-Mod Antenna Mount Analysis Report and PMI Requirements

Mount Fix

SMART Tool Project #: 10068723 Maser Consulting Connecticut #: 21777223A (Rev 0)

July 2, 2021

Site ID: 468464-VZW / BARKHAMSTED W CT Site Information

Site Name: BARKHAMSTED W CT Carrier Name: Verizon Wireless

Address: 5 Old Farm Road

Barkhamsted, Connecticut 06057

Litchfield County 41.914525° Latitude: -73.022331° Longitude:

Structure Information Tower Type: 147-Ft Monopole

14.17-Ft Platform Mount Type:

FUZE ID # 16272040

Analysis Results

Platform: 43.0% Pass

***Contractor PMI Requirements:

Included at the end of this MA report Available & Submitted via portal at https://pmi.vzwsmart.com Contractor - Please Review Specific Site PMI Requirements Upon Award Requirements also Noted on Mount Modification Drawings Requirements may also be Noted on A & E drawings

Report Prepared By: Cody Sherman



Mount Post-Modification Analysis Report (1) 14.17-Ft Platform

July 2, 2021 Site ID: 468464-VZW / BARKHAMSTED W CT Page | 4

7. Structural Steel Grades have been assumed as follows, if applicable, unless otherwise noted in this

o Channel, Solid Round, Angle, Plate ASTM A36 (Gr. 36) HSS (Rectangular) ASTM 500 (Gr. B-46) ASTM A53 (Gr. B-35) Pipe Threaded Rod F1554 (Gr. 36) ASTM A325 Bolts

Discrepancies between in-field conditions and the assumptions listed above may render this analysis invalid unless explicitly approved by Maser Consulting.

Analysis Results:

| Component | Utilization % | Pass/Fail |
|------------------------|---------------|-----------|
| Proposed Support Rail | 22.0% | Pass |
| Proposed Support Angle | 12.0% | Pass |
| Proposed Kicker | 12.0% | Pass |
| Standoff Horizontal | 23.0% | Pass |
| Face Horizontal | 17.0% | Pass |
| Mount Pipe | 27.0% | Pass |
| Dual Mount Pipe | 26.0% | Pass |
| Mount Connection | 42.2% | Pass |

| Structure Rating – (Controlling Utilization of all Components) | 42.2% |
|--|-------|

Recommendation:

The existing mount(s) will be SUFFICIENT for the final loading after the proposed modifications are successfully

ANSI/ASSP rigging plan review services compliant with the requirements of ANSI/TIA 322 are available for a Construction Class IV site or other, if required. Separate review fees will apply.

Attachments:

- Mount Photos
- 2. Mount Mapping Report (for reference only)
- 3. Analysis Calculations
- 4. Contractor Required PMI Report Deliverables
- 5. Antenna Placement Diagrams





Dewberry Engineers Inc. SUITE 700 BOSTON, MA 02110 PHONE: 617.695.3400 FAX: 617.695.3310

> ATC SITE NUMBER: 411177

ATC SITE NAME: BARKHAMSTEDW CT

VERIZON SITE NAME:

BARKHAMSTED W CT

SITE ADDRESS: 14 OLD NORTH ROAD BARKHAMSTED, CT 06063-3440

SEAL:

DATE DRAWN: 08/26/21 ATC JOB NO: 13714920 CUSTOMER ID: BARKHAMSTED W CT CUSTOMER #: 468464

SUPPLEMENTAL

SHEET NUMBER:

R-602

PROIECT NOTES

- SEE MODIFICATION NOTES
- THE CONTRACTOR SHALL COMPLY WITH ALL APPLICABLE CODES, ORDINANCES, LAWS AND REGULATIONS OF ALL MUNICIPALITIES, UTILITY COMPANIES OR OTHER PUBLIC/GOVERNING AUTHORITIES
- THE CONTRACTOR SHALL BE RESPONSIBLE FOR OBTAINING ALL PERMITS AND INSPECTIONS THAT MAY BE REQUIRED BY ANY
- THE CONTRACTOR SHALL NOTIFY THE CONSTRUCTION MANAGER, IN WRITING, OF ANY CONFLICTS, ERRORS OR OMISSIONS PRIOR TO THE SUBMISSION OF BIDS OR PERFORMANCE
- THE CONTRACTOR SHALL BE RESPONSIBLE FOR PROTECTING ALL EXISTING SITE IMPROVEMENTS PRIOR TO COMMENCING CONSTRUCTION. THE CONTRACTOR SHALL REPAIR ANY DAMAGE AS A RESULT OF CONSTRUCTION OF THIS FACILITY AT THE CONTRACTOR'S EXPENSE TO THE SATISFACTION OF THE OWNER
- THE SCOPE OF WORK FOR THIS PROJECT SHALL INCLUDE PROVIDING ALL MATERIALS, EQUIPMENT AND LABOR REQUIRED TO COMPLETE THIS PROJECT. ALL EQUIPMENT SHALL BE INSTALLED IN ACCORDANCE WITH MANUFACTURER'S RECOMMENDATIONS.
- THE CONTRACTOR SHALL VISIT THE PROJECT SITE PRIOR TO SUBMITTING THE BID TO VERIFY THAT THE PROJECT CAN BE CONSTRUCTED IN ACCORDANCE WITH THE CONTRACT DOCUMENTS AND CONSTRUCTION DRAWINGS
- THE CONTRACTOR SHALL VERIFY ALL EXISTING DIMENSIONS AND CONDITIONS PRIOR TO COMMENCING ANY WORK. ALL DIMENSIONS OF EXISTING CONSTRUCTION SHOWN ON THESE DRAWINGS MUST BE VERIFIED. THE CONTRACTOR SHALL NOTIFY THE CONSTRUCTION MANAGER OF ANY DISCREPANCIES PRIOR TO ORDERING MATERIAL OR PROCEEDING WITH CONSTRUCTION.
- SINCE THE CELL SITE MAY BE ACTIVE, ALL SAFETY PRECAUTIONS MUST BE TAKEN WHEN WORKING AROUND HIGH LEVELS OF ELECTROMAGNETIC RADIATION. EQUIPMENT SHOULD BE SHUTDOWN PRIOR TO PERFORMING ANY WORK THAT COULD EXPOSE THE WORKERS TO DANGER. PERSONAL RF EXPOSURE MONITORS ARE REQUIRED TO BE WORN TO ALERT OF ANY POTENTIALLY DANGEROUS EXPOSURE LEVELS.
- NO NOISE, SMOKE, DUST OR ODOR WILL RESULT FROM THIS FACILITY AS TO CAUSE A NUISANCE.
- THE FACILITY IS UNMANNED AND NOT FOR HUMAN HABITATION (NO HANDICAP ACCESS IS REQUIRED).

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MOUNT MODIFICATION DRAWINGS **EXISTING 14.17' PLATFORM**

SITE NAME: BARKHAMSTED W CT **SITE NUMBER: 468464**

> **5 OLD FARM ROAD** BARKHAMSTED, CT 06057 LITCHFIELD COUNTY

PROJECT INFORMATION

SITE INFORMATION

41.914525° N 73.022331° W LITCHFIELD COUNTY LATITUDE: LONGITUDE: JURISDICTION:

APPLICANT/LESSEE

COMPANY: **VERIZON WIRELESS**

CLIENT REPRESENTATIVE

VERIZON WIRELESS

I 18 FLANDERS ROAD, THIRD FLOOR CITY, STATE, ZIP:

WESTBOROUGH, MA 01581 ANDREW CANDIELLO CONTACT

ANDREW.CANDIELLO@VERIZONWIRELESS.COM EMAIL:

PROJECT MANAGER

COMPANY: MASER CONSULTING CONNECTICUT PETER ALBANO

CONTACT PHONE:

PETER.ALBANO@COLLIERSENGINEERING.COM E-MAIL:

| | SHEET INDEX |
|-------|----------------------|
| SHEET | DESCRIPTION |
| T-I | TITLE SHEET |
| S-I | BILL OF MATERIALS |
| S-2 | MODIFICATION NOTES |
| S-3 | MODIFICATION NOTES |
| S-4 | MODIFICATION DETAILS |
| S-5 | MODIFICATION DETAILS |
| S-6 | MODIFICATION DETAILS |
| S-7 | MOUNT PHOTOS |
| | SPECIFICATION SHEETS |
| | |
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| | |
| | |
| | |

OTTERE TAMES

CONTRACTOR PMI REQUIREMENTS

PMI LOCATION: HTTPS://PMI.VZWSMART.COM

SMART TOOL PROJECT #: VZW LOCATION CODE (PSLC): 10068723 468464

PMI REQUIREMENTS EMBEDDED WITHIN MOUNT MODIFICATION REPORT

REFERENCED DOCUMENTS

FAILING MOUNT ANALYSIS REPORT SMART TOOL PROJECT #: MASER CONSULTING PROJECT #: 10044564 21777223A

ANALYSIS DATE:



NEW YORK PENNSYLVANIA

■ NEW MEXICO ■ MARYLAND ■ GEORGIA ■ TEXAS

VIRGINIA FLORIDA NORTH CAROLINA

SOUTH CAROLINA





| | SCALE : | AS SHO\ | ΜN | JOB NUMBER : 21777223A | | | |
|---|---------|----------|----------------------------|------------------------|-------------|---------------|--|
| ĺ | | | | | | | |
| | | | | | | | |
| | - | | | | | | |
| | 0 | 7/2/2021 | ISSUED FOR CONSTRUCTION | ON | JRF | DL | |
| | REV | DATE | DESCRIPTIO | Z | DRAWN BY | CHECKED BY | |



IT IS A VIOLATION OF LAW FOR ANY PERSON UNLESS THEY ARE ACTING UNDER THE DIRECTI

SITE NAME:

BARKHAMSTED W CT 468464

5 OLD FARM ROAD BARKHAMSTED, CT 06057 LITCHFIELD COUNTY



MT. LAUREL OFFICE

TITLE SHEET

T-I

BILL OF MATERIALS

| | | | BILL OF MAT | ENIALS |
|----------|----------------|---------------|--------------------------------|--|
| | | | VZWSMART I | KITS |
| QUANTITY | MANUFACTURER | PART NUMBER | DESCRIPTION | NOTES |
| 3 | | VZWSMART-PLK3 | SUPPORT RAIL CORNER BRACKET | |
| 1 | - | VZWSMART-PLK5 | KICKER KIT | CONTRACTOR TO VERIFY THE LENGTH REQUIRED AND TRIM AS NECESSARY IN ACCORDANCE WITH THE 'STRUCTURAL STEEL' NOTES ON SHEET S-2 |
| I | - | VZWSMART-PLK7 | MONOPOLE COLLAR MOUNT ASSEMBLY | |
| 12 | | VZWSMART-MSK1 | CROSSOVER PLATE | |
| | VZWSMART | | | |
| | | | | |
| | - | | | |
| | - | | | |
| | - | | | |
| | 1 | | OTHER REQUIRE | D PARTS |
| QUANTITY | MANUFACTURER | PART NUMBER | DESCRIPTION | NOTES |
| 3 | PERFECT VISION | PV-XP-40ST25 | CROSSOVER PLATE | OR EOR APPROVED EQUAL, CONTACT MASER CONSULTING FOR APPROVAL OF SUBSTITUTION. |
| 3 | - | - | 156" LONG, P2.5 STD PIPE | GALVANIZED |
| 3 | - | - | 24" LONG, L3X3X1/4 | GALVANIZED, CONTRACTOR TO VERIFY THE LENGTH REQUIRED AND TRIM AS NECESSARY IN ACCORDANCE WITH THE 'STRUCTURAL STEEL' NOTES ON SHEET S-2. |
| 3 | - | - | 96" LONG, P2.5 STD PIPE | GALVANIZED |
| | | | | |
| | | | | |
| | | | | |
| | | | | |
| | | | | |
| | | | | |
| | | | | |

NOTE: ALL MATERIALS REQUIRED FOR THE DESIGNED MODIFICATIONS BUT NOT LISTED IN THIS SHEET ARE ASSUMED TO BE PROVIDED BY THE CONTRACTOR

| VZWSMART KITS - APPROVED VENDORS | | | | | |
|---------------------------------------|--|--|--|--|--|
| COMMSCOPE | | | | | |
| CONTACT | SALVADOR ANGUIANO | | | | |
| PHONE | (817) 304-7492 | | | | |
| email salvador.anguiano@commscope.com | | | | | |
| WEBSITE | WWW.COMMSCOPE.COM | | | | |
| N | IETROSITE FABRICATORS, LLC | | | | |
| CONTACT | KENT RAMEY | | | | |
| PHONE | (706) 335-7045 (O), (706) 982-9788 (M) | | | | |
| EMAIL | KENT@METROSITELLC.COM | | | | |
| WEBSITE | METROSITEFABRICATORS.COM | | | | |
| | PERFECTVISION | | | | |
| CONTACT | WIRELESS SALES | | | | |
| PHONE | (844) 887-6723 | | | | |
| EMAIL | WWW.PERFECT-VISION.COM | | | | |
| WEBSITE | WIRELESSSALES@PERFECT-VISION.COM | | | | |
| | SABRE INDUSTRIES, INC. | | | | |
| CONTACT | ANGIE WELCH | | | | |
| PHONE | (866) 428-6937 | | | | |
| EMAIL | AKWELCH@SABREINDUSTRIES.COM | | | | |
| WEBSITE | www.sabresitesolutions.com | | | | |
| | SITE PRO 1 | | | | |
| CONTACT | PAULA BOSWELL | | | | |
| PHONE | (972) 236-9843 | | | | |
| EMAIL | PAULA.BOSWELL@VALMONT.COM | | | | |
| WEBSITE | WWW.SITEPROI.COM | | | | |

NOTE: WHEN SPECIFIED, VZWSMART KITS SHALL BE REQUIRED AND WILL BE VERIFIED DURING THE DESKTOP PMI



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SITE NAME:

BARKHAMSTED W CT 468464

5 OLD FARM ROAD BARKHAMSTED, CT 06057 LITCHFIELD COUNTY



Phone: 856.797.0412 Fax: 856.722.1120

BILL OF MATERIALS

S-I

GENERAL NOTES

- I. THESE MODIFICATIONS HAVE BEEN DESIGNED IN ACCORDANCE WITH THE GOVERNING PROVISIONS OF THE TELECOMMUNICATIONS INDUSTRY STANDARD TIA-222-H MATERIALS AND SERVICES PROVIDED BY THE CONTRACTOR SHALL CONFORM TO THE ABOVE MENTIONED CODES.
- 2. CONTRACTOR SHALL TAKE ALL PRECAUTIONS NECESSARY TO PREVENT DAMAGE TO EXISTING STRUCTURES, ANY DAMAGE TO EXISTING STRUCTURES AS A RESULT OF THE CONTRACTOR'S WORK OR FROM DAMAGE DUE TO OTHER CAUSES SHALL BE REPAIRED AT THE CONTRACTOR'S EXPENSE TO THE SATISFACTION OF THE OWNER.
- CONTRACTOR SHALL VERIFY ALL DIMENSIONS AND EXISTING CONDITIONS BEFORE BEGINNING WORK, ORDERING MATERIAL, AND PREPARING OF SHOP DRAWINGS, ANY DISCREPANCIES BETWEEN FIELD CONDITIONS AND THE CONTRACT DOCUMENTS SHALL BE BROUGHT TO THE IMMEDIATE ATTENTION OF THE ENGINEER. IF THE CONTRACTOR DISCOVERS ANY EXISTING CONDITIONS THAT ARE NOT REPRESENTED ON THESE DRAWINGS, OR ANY CONDITIONS THAT WOULD INTERFERE WITH THE INSTALLATION OF THE MODIFICATIONS, NOTIFY THE ENGINEER IMMEDIATELY
- 4. IT IS ASSUMED THAT ANY STRUCTURAL MODIFICATION WORK SPECIFIED ON THESE PLANS WILL BE ACCOMPLISHED BY KNOWLEDGEABLE WORKMEN WITH TOWER CONSTRUCTION EXPERIENCE.
- 5. THE CONTRACTOR SHALL SUPERVISE AND DIRECT THE WORK AND SHALL BE SOLELY RESPONSIBLE FOR ALL CONSTRUCTION METHODS, MEANS, TECHNIQUES, SEQUENCES, AND PROCEDURES.
- ALL CONSTRUCTION MEANS AND METHODS; INCLUDING BUT NOT LIMITED TO, ERECTION PLANS, RIGGING PLANS, CLIMBING PLANS, AND RESCUE PLANS SHALL BE THE RESPONSIBILITY OF THE GENERAL CONTRACTOR RESPONSIBLE FOR THE EXECUTION OF THE WORK CONTAINED HEREIN AND SHALL MEET ANSI/TIA-322 (LATEST EDITION), OSHA, AND GENERAL INDUSTRY STANDARDS ALL RIGGING PLANS SHALL ADHERE TO ANSI/TIA-322 (LATEST EDITION) INCLUDING THE REQUIRED INVOLVEMENT OF A QUALIFIED ENGINEER FOR CLASS IV CONSTRUCTION.
- 7. THE CONTRACTOR IS SOLELY RESPONSIBLE FOR INITIATING, MAINTAINING, AND SUPERVISING ALL SAFETY PROGRAMS IN ACCORDANCE WITH APPLICABLE SAFETY CODES.
- WORK SHALL ONLY BE PERFORMED DURING CALM DRY DAYS (WINDS LESS THAN 30-MPH). THE STRUCTURE SHOWN ON THE DRAWINGS IS STRUCTURALLY SOUND ONLY IN THE COMPLETED FORM, THE CONTRACTOR SHALL BE RESPONSIBLE FOR THE STRENGTH AND STABILITY OF THE STRUCTURE DURING ERECTION. CONTRACTOR SHALL PROVIDE TEMPORARY SUPPORT, SHORING, BRACING AND ANY OTHER STRUCTURAL SYSTEMS AS REQUIRED TO RESIST ALL FORCES THAT MAY OCCUR DURING HANDLING AND ERECTION UNTIL THE STRUCTURE IS FULLY COMPLETED. TEMPORARY SUPPORTS, BRACING AND OTHER STRUCTURAL SYSTEMS REQUIRED DURING CONSTRUCTION SHALL REMAIN THE CONTRACTOR'S PROPERTY AFTER THEIR USE.
- ALL INSTALLATIONS PERFORMED ON THIS STRUCTURE SHALL BE COMPLETED IN ACCORDANCE WITH THE GOVERNING PROVISIONS OF THE STANDARD FOR INSTALLATION, ALTERATION AND MAINTENANCE OF ANTENNA SUPPORTING STRUCTURES AND ANTENNAS, ANSI/TIA-322
- 10. CONTRACTOR SHALL SECURE SITE BACK TO EXISTING CONDITION UNDER SUPERVISION OF OWNER, ALL FENCE, STONE, GEOFABRIC, GROUNDING, AND SURROUNDING GRADE SHALL BE REPLACED AND REPAIRED AS REQUIRED TO ACHIEVE OWNER APPROVAL. POSITIVE DRAINAGE AWAY FROM TOWER SITE SHALL BE MAINTAINED.
- II. CONNECTIONS BETWEEN ITEMS SUPPORTED BY THE STRUCTURE AND THE STRUCTURE NOT SPECIFICALLY DETAILED IN THE CONTRACT DOCUMENTS ARE THE RESPONSIBILITY OF THE CONTRACTOR, SUCH CONNECTIONS SHALL BE DESIGNED, COORDINATED AND INSPECTED BY A PROFESSIONAL STRUCTURAL ENGINEER LICENSED IN THE STATE OF THE PROJECT. SUBMIT SIGNED AND SEALED CALCULATIONS DURING SHOP DRAWING REVIEW.
- 12. DO NOT SCALE DRAWINGS.
- 13. DO NOT USE THESE DRAWINGS FOR ANY OTHER SITE.
- 14 ALL MATERIAL UTILIZED FOR THIS PROJECT MUST BE NEW AND FREE OF ANY DEFECTS. ANY MATERIAL SUBSTITUTIONS, INCLUDING BUT NOT LIMITED TO ALTERED SIZE AND/OR STRENGTHS, MUST BE APPROVED BY THE OWNER AND ENGINEER IN WRITING.
- 15. THE MOUNT UNDER NO CIRCUMSTANCES SHOULD BE USED AS A TIE OFF

DESIGN LOADS

WIND LOADS

- a. BASIC WIND SPEED (3 SECOND GUST), V = 115 MPH
- b. EXPOSURE CATEGORY B
- c. TOPOGRAPHIC CATEGORY I
- d. MEAN BASE ELEVATION (AMSL) = 813'

- a. ICE WIND SPEED (3 SECOND GUST), V = 50 MPH
- b. ICE THICKNESS = 1.00 IN

SEISMIC LOADS

- a. SEISMIC DESIGN CATEGORY B
- b. SHORT TERM MCER GROUND MOTION, S_s = .169
- c. LONG TERM MCER GROUND MOTION, S_I = .054

STRUCTURAL STEEL

- I. DESIGN, DETAILING, FABRICATION AND ERECTION OF STRUCTURAL STEEL SHALL CONFORM TO THE FOLLOWING PUBLICATIONS EXCEPT AS SPECIFICALLY INDICATED IN THE CONTRACT DOCUMENTS.
 - a. AMERICAN INSTITUTE OF STEEL CONSTRUCTION (AISC) MANUAL OF STEEL CONSTRUCTION (15TH EDITION)
 - b. SPECIFICATION FOR STRUCTURAL IOINTS USING ASTM A325 OR A490 **BOLTS**
 - c. AISC CODE OF STANDARD PRACTICE
- 2. STRUCTURAL STEEL SHALL CONFORM TO THE FOLLOWING UNLESS OTHERWISE SHOWN:

CHANNELS, ANGLES, PLATES, ETC. ASTM A36 (GR 36) STEEL PIPE ASTM A53 (GR 35) **BOLTS** ASTM A325 NUTS ASTM A563

LOCK WASHERS LOCKING STRUCTURAL GRADE

- 3. ALL SUBSTITUTIONS PROPOSED BY THE CONTRACTOR SHALL BE APPROVED IN WRITING BY THE ENGINEER. CONTRACTOR SHALL PROVIDE DOCUMENTATION TO ENGINEER FOR VERIFYING THE SUBSTITUTE IS SUITABLE FOR USE AND MEETS ORIGINAL DESIGN CRITERIA. DIFFERENCES FROM THE ORIGINAL DESIGN, INCLUDING MAINTENANCE, REPAIR AND REPLACEMENT, SHALL BE NOTED, ESTIMATES OF COSTS/CREDITS ASSOCIATED WITH THE SUBSTITUTION (INCLUDING RE-DESIGN COSTS AND COSTS TO SUB-CONTRACTORS) SHALL BE PROVIDED TO THE ENGINEER. CONTRACTOR SHALL PROVIDE ADDITIONAL DOCUMENTATION AND/OR SPECIFICATIONS TO THE ENGINEER AS REQUESTED.
- 4. PROVIDE STRUCTURAL STEEL SHOP DRAWINGS TO ENGINEER FOR APPROVAL PRIOR TO FABRICATION.
 - a SUBMIT SHOP DRAWINGS TO
 - PETER.ALBANO@COLLIERSENGINEERING.COM
 - b. PROVIDE MASER CONSULTING PROJECT # AND MASER CONSULTING PROJECT ENGINEER CONTACT IN THE BODY OF THE EMAIL.
- 5. DRILL NO HOLES IN ANY NEW OR EXISTING STRUCTURAL STEEL MEMBERS OTHER THAN THOSE SHOWN ON STRUCTURAL DRAWINGS WITHOUT THE APPROVAL OF THE ENGINEER OF RECORD.
- 6. GALVANIZED ASTM A325 BOLTS SHALL NOT BE REUSED.
- 7. ALL NEW STEEL SHALL BE HOT BE DIPPED GALVANIZED FOR FULL WEATHER PROTECTION. IN ADDITION ALL NEW STEEL SHALL BE PAINTED TO MATCH EXISTING STEEL, CONTRACTOR SHALL OBTAIN WRITTEN PERMISSION TO PROTECT STEEL BY ANY OTHER MEANS.
- 8. ALL BOLT ASSEMBLIES FOR STRUCTURAL MEMBERS REPRESENTED IN THIS DRAWING REQUIRE LOCKING DEVICES TO BE INSTALLED IN ACCORDANCE WITH TIA-222-H SECTION 4.9.2 REQUIREMENTS.
- 9. WHERE CONNECTIONS ARE NOT FULLY DETAILED ON THESE DRAWINGS, FABRICATOR SHALL DESIGN CONNECTIONS TO RESIST LOADS AND FORCES WHERE SHOWN ON DRAWINGS AND AS OUTLINED IN SPECIFICATIONS.
- 10. FOR MEMBERS BEING REPLACED, PROVIDE NEW BOLTS AND MATCH EXISTING SIZE AND GRADE. MAINTAIN AISC REQUIREMENTS FOR MINIMUM BOLT DISTANCE AND SPACING.
- II. ALL PROPOSED AND/OR REPLACED BOLTS SHALL BE OF SUFFICIENT LENGTH SUCH THAT THE END OF THE BOLT IS AT LEAST FLUSH WITH THE FACE OF THE NUT. IT IS NOT PERMITTED FOR THE BOLT END TO BE BELOW THE FACE OF THE NUT AFTER TIGHTENING IS COMPLETED.
- 12. GALVANIZED ASTM A325 BOLTS SHALL NOT BE REUSED.
- 13. ALL NEW STEEL SHALL BE HOT BE DIPPED GALVANIZED FOR FULL WEATHER PROTECTION, CONTRACTOR SHALL OBTAIN WRITTEN PERMISSION TO

PROTECT STEEL BY ANY OTHER MEANS.

- 14 ALL EXISTING PAINTED/GALVANIZED SURFACES DAMAGED DURING REHAB INCLUDING AREAS UNDER STIFFENER PLATES SHALL BE WIRE BRUSHED CLEAN, REPAIRED BY COLD GALVANIZING (ZINGA OR ZINC COTE), AND REPAINTED TO MATCH THE EXISTING FINISH (IF APPLICABLE).
- 15. ALL HOLES IN STEEL MEMBERS SHALL BE SIZED 1/16" LARGER THAN THE BOLT DIAMETER, STANDARD HOLES SHALL BE USED UNLESS NOTED OTHERWISE.

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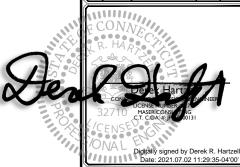
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SITE NAME:

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5 OLD FARM ROAD BARKHAMSTED, CT 06057 LITCHFIELD COUNTY



MT. LAUREL OFFICE

Phone: 856.797.0412 Fax: 856.722.1120

MODIFICATION NOTES

NOTE: DO NOT SCALE DRAWINGS FOR CONSTRUCTIO

S-2

MODIFICATION INSPECTION NOTES

| | MI CHECKLIST | | | |
|--|---|--|--|--|
| CONSTRUCTION/ INSTALLATION INSPECTIONS AND TESTING REPORT ITEM REQUIRED (COMPLETED BY EOR) | | | | |
| PRE-CONSTRUCTION | | | | |
| X MI CHECKLIST DRAWING | | | | |
| X | EOR APPROVED SHOP DRAWINGS | | | |
| NA | FABRICATION INSPECTION | | | |
| NA | FABRICATOR CERTIFIED WELD INSPECTION | | | |
| X | MATERIAL TEST REPORT (MTR) | | | |
| NA FABRICATOR NDE INSPECTION | | | | |
| X PACKING SLIPS | | | | |
| | | | | |
| DITIONAL TESTING AND INSPEC | CTIONS: | | | |
| ditional testing and inspec | CONSTRUCTION | | | |
| DITIONAL TESTING AND INSPEC | | | | |
| | CONSTRUCTION | | | |
| X | CONSTRUCTION CONSTRUCTION INSPECTIONS | | | |
| X NA | CONSTRUCTION CONSTRUCTION INSPECTIONS CONTRACTOR'S CERTIFIED WELD INSPECTION AND NDE REPORTS | | | |
| X NA X | CONSTRUCTION CONSTRUCTION INSPECTIONS CONTRACTOR'S CERTIFIED WELD INSPECTION AND NDE REPORTS ON SITE COLD GALVANIZING VERIFICATION GC AS-BUILT DOCUMENTS | | | |
| X NA X X | CONSTRUCTION CONSTRUCTION INSPECTIONS CONTRACTOR'S CERTIFIED WELD INSPECTION AND NDE REPORTS ON SITE COLD GALVANIZING VERIFICATION GC AS-BUILT DOCUMENTS CTIONS: | | | |
| X NA X X DITIONAL TESTING AND INSPEC | CONSTRUCTION CONSTRUCTION INSPECTIONS CONTRACTOR'S CERTIFIED WELD INSPECTION AND NDE REPORTS ON SITE COLD GALVANIZING VERIFICATION GC AS-BUILT DOCUMENTS | | | |
| X NA X X DITIONAL TESTING AND INSPEC | CONSTRUCTION CONSTRUCTION INSPECTIONS CONTRACTOR'S CERTIFIED WELD INSPECTION AND NDE REPORTS ON SITE COLD GALVANIZING VERIFICATION GC AS-BUILT DOCUMENTS CTIONS: POST-CONSTRUCTION | | | |
| X NA X X DITIONAL TESTING AND INSPEC | CONSTRUCTION CONSTRUCTION INSPECTIONS CONTRACTOR'S CERTIFIED WELD INSPECTION AND NDE REPORTS ON SITE COLD GALVANIZING VERIFICATION GC AS-BUILT DOCUMENTS CTIONS: POST-CONSTRUCTION MI INSPECTOR REDLINE OR RECORD DRAWING(S) | | | |

NOTE: X DENOTES A DOCUMENT REQUIRED FOR THE MI REPORT NA DENOTES A DOCUMENT THAT IS NOT REQUIRED FOR THE MI REPORT THE MODIFICATION INSPECTION (MI) IS A VISUAL INSPECTION OF MODIFICATIONS AND A REVIEW OF CONSTRUCTION INSPECTIONS AND OTHER REPORTS TO ENSURE THE INSTALLATION WAS CONSTRUCTED IN ACCORDANCE WITH THE CONTRACT DOCUMENTS, NAMELY THE MODIFICATION DRAWINGS, AS DESIGNED BY THE ENGINEER OF RECORD (EOR).

THE MI IS TO CONFIRM INSTALLATION CONFIGURATION AND WORKMANSHIP ONLY AND IS NOT A REVIEW OF THE MODIFICATION DESIGN ITSELF, NOR DOES THE MI INSPECTOR TAKE OWNERSHIP OF THE MODIFICATION DESIGN. OWNERSHIP OF THE STRUCTURAL MODIFICATION DESIGN EFFECTIVENESS AND INTEGRITY RESIDES WITH THE EOR AT ALL TIMES.

TO ENSURE THAT THE REQUIREMENTS OF THE MI ARE MET, IT IS VITAL THAT THE GENERAL CONTRACTOR (GC) AND THE MI INSPECTOR BEGIN COMMUNICATING AND COORDINATING AS SOON AS A PURCHASE ORDER (PO) IS RECEIVED. IT IS EXPECTED THAT EACH PARTY WILL BE PROACTIVE IN REACHING OUT TO THE OTHER PARTY

MI INSPECTOR

THE MI INSPECTOR IS REQUIRED TO CONTACT THE GC AS SOON AS RECEIVING A PO FOR THE MI

- REVIEW THE REQUIREMENTS OF THE MI CHECKLIST
- WORK WITH THE GC TO DEVELOP A SCHEDULE TO CONDUCT ON-SITE INSPECTIONS

THE MI INSPECTOR IS RESPONSIBLE FOR COLLECTING ALL GC INSPECTION AND TEST REPORTS, REVIEWING THE DOCUMENTS FOR ADHERENCE TO THE CONTRACT DOCUMENTS, CONDUCTING THE IN-FIELD INSPECTIONS, AND SUBMITTING THE MI REPORT TO EOR.

GENERAL CONTRACTOR

THE GC IS REQUIRED TO CONTACT THE MI INSPECTOR AS SOON AS RECEIVING A PO FOR THE MODIFICATION INSTALLATION OR TURNKEY PROJECT TO, AT A MINIMUM:

- REVIEW THE REQUIREMENTS OF THE MI CHECKLIST
- WORK WITH THE MI INSPECTOR TO DEVELOP A SCHEDULE TO CONDUCT ON-SITE MI INSPECTIONS, INCLUDING FOUNDATION INSPECTIONS
- BETTER UNDERSTAND ALL INSPECTION AND TESTING REQUIREMENTS

THE GC SHALL PERFORM AND RECORD THE TEST AND INSPECTION RESULTS IN ACCORDANCE WITH THE REQUIREMENTS OF THE MI CHECKLIST.

RECOMMENDATIONS

THE FOLLOWING RECOMMENDATIONS AND SUGGESTIONS ARE OFFERED TO ENHANCE THE EFFICIENCY AND EFFECTIVENESS OF DELIVERING AN MI REPORT:

- IT IS SUGGESTED THAT THE GC PROVIDE A MINIMUM OF 5 BUSINESS DAYS NOTICE. PREFERABLY 10, TO THE MI INSPECTOR AS TO WHEN THE SITE WILL BE READY FOR THE MI
- THE GC AND MI INSPECTOR COORDINATE CLOSELY THROUGHOUT THE ENTIRE PROJECT.
- WHEN POSSIBLE, IT IS PREFERRED TO HAVE THE GC AND MI INSPECTOR ON-SITE SIMULTANEOUSLY FOR ANY GUY WIRE TENSIONING OR RE-TENSIONING OPERATIONS.
- IT MAY BE BENEFICIAL TO INSTALL ALL MODIFICATIONS PRIOR TO CONDUCTING THE FOUNDATION INSPECTIONS TO ALLOW THE FOUNDATION AND MI INSPECTION(S) TO COMMENCE WITH ONE SITE VISIT.
- WHEN POSSIBLE, IT IS PREFERRED TO HAVE THE GC AND MI INSPECTOR ON-SITE DURING THE MI TO HAVE ANY DEFICIENCIES CORRECTED DURING THE INITIAL MI. THEREFORE, THE GC MAY CHOOSE TO COORDINATE THE MI CAREFULLY TO ENSURE ALL CONSTRUCTION FACILITIES ARE AT THEIR DISPOSAL WHEN THE MI INSPECTOR IS ON SITE.

CORRECTION OF FAILING MI'S

IF THE MODIFICATION INSTALLATION WOULD FAIL THE MI ("FAILED MI"), THE GC SHALL WORK WITH THE OWNER TO COORDINATE A REMEDIATION PLAN-


CORRECT FAILING ISSUES TO COMPLY WITH THE SPECIFICATIONS CONTAINED IN THE ORIGINAL CONTRACT DOCUMENTS AND COORDINATE A SUPPLEMENT MI.

REQUIRED PHOTOS

BETWEEN THE GC AND THE MI INSPECTOR THE FOLLOWING PHOTOGRAPHS, AT A MINIMUM, ARE TO BE TAKEN AND INCLUDED IN THE MI REPORT:


- PRE-CONSTRUCTION GENERAL SITE CONDITION
 PHOTOGRAPHS DURING THE REINFORCEMENT MODIFICATION CONSTRUCTION/ERECTION AND INSPECTION
- RAW MATERIALS
- PHOTOS OF ALL CRITICAL DETAILS
- FOUNDATION MODIFICATIONS WELD PREPARATION
- BOLT INSTALLATION
- FINAL INSTALLED CONDITION
- SURFACE COATING REPAIR
 POST CONSTRUCTION PHOTOGRAPHS
- FINAL INFIELD CONDITION

PHOTOS OF ELEVATED MODIFICATIONS TAKEN ONLY FROM THE GROUND SHALL BE CONSIDERED INADEQUATE.

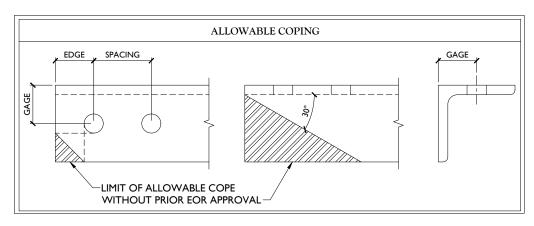

| BOLT SCHEDULE (IN.) | | | | | | | | |
|--|--------|-----------------|-------|-------|--|--|--|--|
| BOLT STANDARD SHORT MIN. EDGE DISTANCE SPACING | | | | | | | | |
| 1/2 | 9/16 | 9/16 x 11/16 | 7/8 | 1 1/2 | | | | |
| 5/8 | 11/16 | 11/16 x 7/8 | 1 1/8 | I 7/8 | | | | |
| 3/4 | 13/16 | 13/16 x 1 | 1 1/4 | 2 1/4 | | | | |
| 7/8 | 15/16 | 15/16 x 1 1/8 | 1 1/2 | 2 5/8 | | | | |
| I | 1 1/16 | 1 1/16 x 1 5/16 | I 3/4 | 3 | | | | |

| WORKABLE GAGES (IN.) | | | | | |
|----------------------|-------|--|--|--|--|
| LEG GAGE | | | | | |
| 4 | 2 1/2 | | | | |
| 3 1/2 | 2 | | | | |
| 3 | I 3/4 | | | | |
| 2 1/2 | I 3/8 | | | | |
| 2 | I I/8 | | | | |

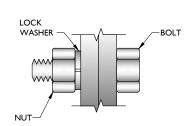

TYP. BOLT ASSEMBLY

NOTES:

- ALL DIMENSIONS REPRESENTED IN THE ABOVE TABLES ARE ALSO MINIMUM REQUIREMENTS. CONTRACTOR SHALL VERIFY EXISTING CONDITIONS IN FIELD AND NOTIFY ENGINEER IF DISTANCES ARE LESS THAN THOSE PROVIDED.
- THE DIMENSIONS PROVIDED ARE MINIMUM REQUIREMENTS. ACTUAL DIMENSIONS OF PROPOSED MEMBERS WITHIN THESE DRAWINGS MAY VARY FROM THE AISC MINIMUM REQUIREMENTS.
- 3. SHORT SLOT HOLES SHALL ONLY BE USED WHEN DEPICTED IN THE DRAWINGS
- MATCH EXISTING GAGES WHEN APPLICABLE, UNLESS MINIMUM EDGE DISTANCES ARE COMPROMISED



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REV DATE DESCRIPTION



Digitally signed by Derek R. Hartz

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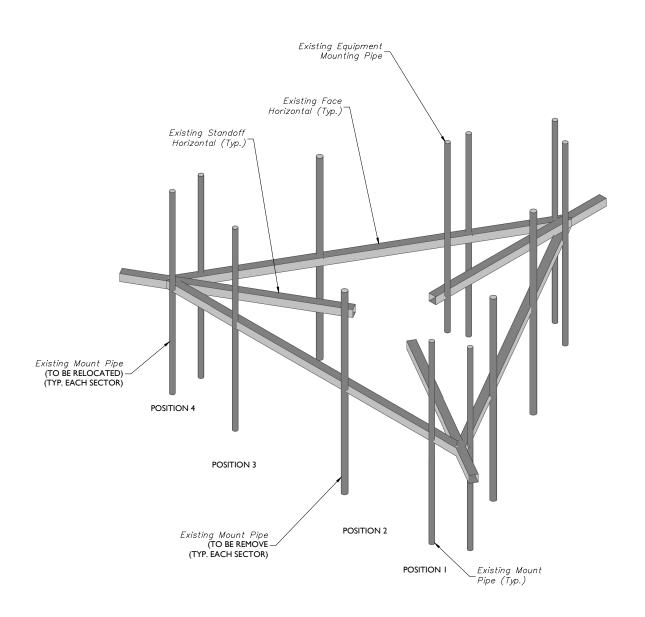



MT. LAUREL OFFICE

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MODIFICATION NOTES

S-3



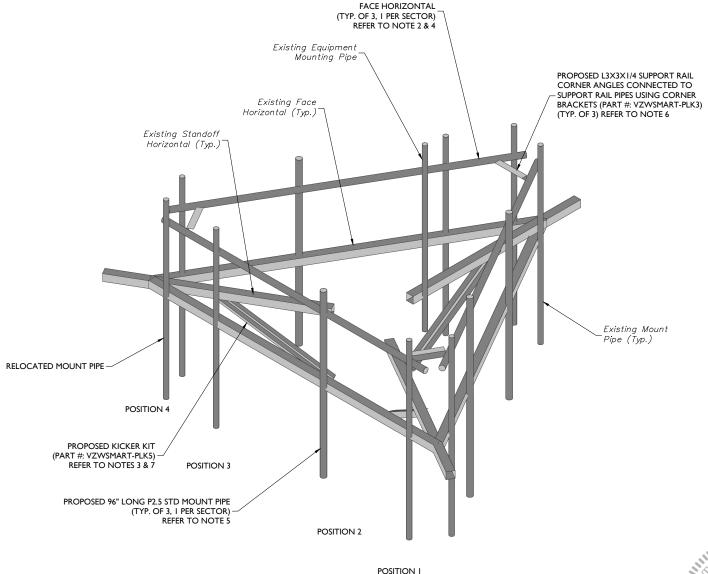

PROPOSED 156" LONG P2.5 STD

EXISTING PLATFORM ISOMETRIC VIEW

STRUCTURAL NOTES:

- PER THE MOUNT MAPPING COMPLETED BY ROAMING NETWORKS INC. ON 3/30/2021, THE SAFETY CLIMB AND CLIMBING FACILITIES UP TO THE VERIZON MOUNT ELEVATION (142'-10") ARE IN GOOD CONDITION. MASER DOES NOT WARRANT THIS INFORMATION.
- 2. INSTALL SHALL NOT CAUSE HARM TO THE STRUCTURE, CLIMBING FACILITY, SAFETY CLIMB, OR ANY SYSTEM INSTALLED ON THE STRUCTURE. TIMELY NOTICE AND DOCUMENTATION SHALL BE PROVIDED BY CONTRACTORS TO THE EOR (OF STRUCTURAL DESIGN) IF AN OBSTRUCTION WAS REQUIRED TO MEET THE RF SYSTEM DESIGN REQUIREMENTS AND PERFORMANCES.

PROPOSED PLATFORM ISOMETRIC VIEW

MODIFICATION NOTES:

2

- MOUNT MEMBERS NOT SHOWN FOR CLARITY U.N.O.
- RADIO AND/OR TME POSITIONS SHALL BE ADJUSTED VERTICALLY AS NEEDED IN ORDER TO ACHIEVE INSTALLATION OF HORIZONTAL AS SHOWN. EOR SHALL BE NOTIFIED IF EQUIPMENT NEEDS TO BE RELOCATED TO ANOTHER MOUNT PIPE.
- CONTRACTOR TO VERIFY THE LENGTH REQUIRED AND TRIM AS NECESSARY IN ACCORDANCE WITH THE 'STRUCTURAL STEEL' NOTES ON SHEET S-2.
- CONNECT NEW HORIZONTAL TO ALL EXISTING AND NEW VERTICAL MOUNT PIPES WITH CROSSOVER PLATES (PART #: VZWSMART-MSKI).
- CONNECT NEW MOUNT PIPE TO EXISTING HORIZONTAL WITH CROSSOVER PLATES (PERFECT VISION PART #: PV-XP-40ST25 OR EOR APPROVED EQUAL).
- CONTRACTOR SHALL CONNECT PROPOSED L3X3X1/4 ANGLES TO CORNER BRACKETS USING THE PROVIDED (8) 5/8" DIA. BOLTS, (4) BOLTS PER CONNECTION.
- CONNECT OTHER END OF KICKER KIT TO MONOPOLE COLLAR MOUNT ASSEMBLY (PART #: VZWSMART-PLK7).

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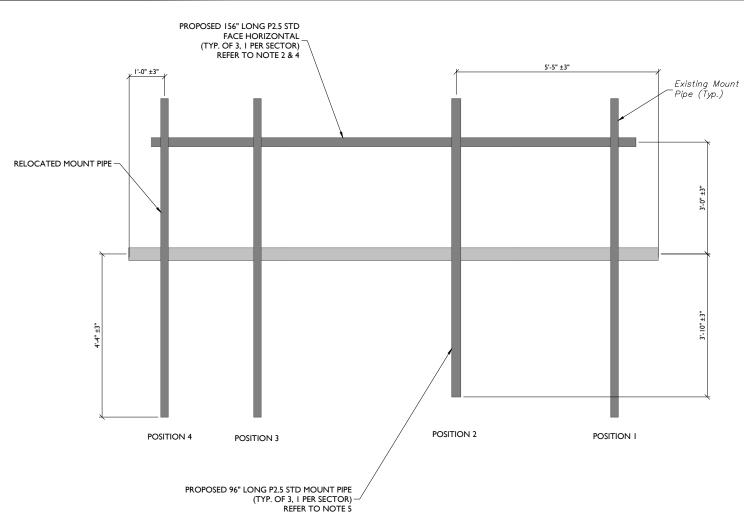
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MT. LAUREL OFFICE 2000 Midlantic Drive

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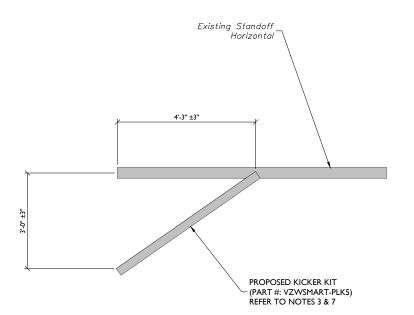
MODIFICATION DETAILS



PROPOSED FRONT ELEVATION VIEW (TYP. EACH SECTOR) SCALE: N.T.S.


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- MOUNT MEMBERS NOT SHOWN FOR CLARITY U.N.O.
- RADIO AND/OR TME POSITIONS SHALL BE ADJUSTED VERTICALLY AS NEEDED IN ORDER TO ACHIEVE INSTALLATION OF HORIZONTAL AS SHOWN. EOR SHALL BE NOTIFIED IF EQUIPMENT NEEDS TO BE RELOCATED TO ANOTHER MOUNT PIPE.
- CONTRACTOR TO VERIFY THE LENGTH REQUIRED AND TRIM AS NECESSARY IN ACCORDANCE WITH THE 'STRUCTURAL STEEL' NOTES ON SHEET S-2.
- CONNECT NEW HORIZONTAL TO ALL EXISTING AND NEW VERTICAL MOUNT PIPES WITH CROSSOVER PLATES (PART #: VZWSMART-MSKI).
- CONNECT NEW MOUNT PIPE TO EXISTING HORIZONTAL WITH CROSSOVER PLATES (PERFECT VISION PART #: PV-XP-40ST25 OR EOR APPROVED EQUAL).
- CONTRACTOR SHALL CONNECT PROPOSED L3X3X1/4 ANGLES TO CORNER BRACKETS USING THE PROVIDED (8) 5/8" DIA. BOLTS, (4) BOLTS PER CONNECTION.
- 7. CONNECT OTHER END OF KICKER KIT TO MONOPOLE COLLAR MOUNT ASSEMBLY (PART #: VZWSMART-PLK7).



PROPOSED SIDE ELEVATION VIEW (TYP. EACH SECTOR)

SCALE: N.T.S.

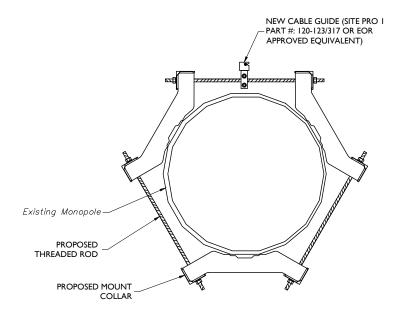

PROPOSED SAFETY CLIMB TO THREADED ROD ATTACHMENT DETAIL SCALE: N.T.S.



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SITE NAME:

BARKHAMSTED W CT 468464

5 OLD FARM ROAD BARKHAMSTED, CT 06057 LITCHFIELD COUNTY




MT. LAUREL OFFICE 2000 Midlantic Drive

Phone: 856.797.0412 Fax: 856.722.1120

MODIFICATION DETAILS

S-5

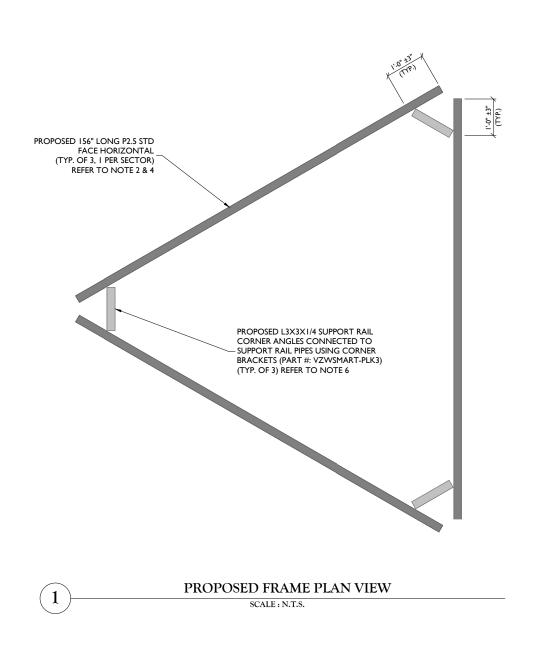

MODIFICATION NOTES:

- MOUNT MEMBERS NOT SHOWN FOR CLARITY U.N.O.
- RADIO AND/OR TME POSITIONS SHALL BE ADJUSTED VERTICALLY AS NEEDED IN ORDER TO ACHIEVE INSTALLATION OF HORIZONTAL AS SHOWN. EOR SHALL BE NOTIFIED IF EQUIPMENT NEEDS TO BE RELOCATED TO ANOTHER MOUNT PIPE.
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- 7. CONNECT OTHER END OF KICKER KIT TO MONOPOLE COLLAR MOUNT ASSEMBLY (PART #: VZWSMART-PLK7).



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5 OLD FARM ROAD BARKHAMSTED, CT 06057 LITCHFIELD COUNTY



Phone: 856.797.0412 Fax: 856.722.1120

MODIFICATION DETAILS



MOUNT PHOTO 1



MOUNT PHOTO 3

MOUNT PHOTO 2



MOUNT PHOTO 4



W W W III as P C O III
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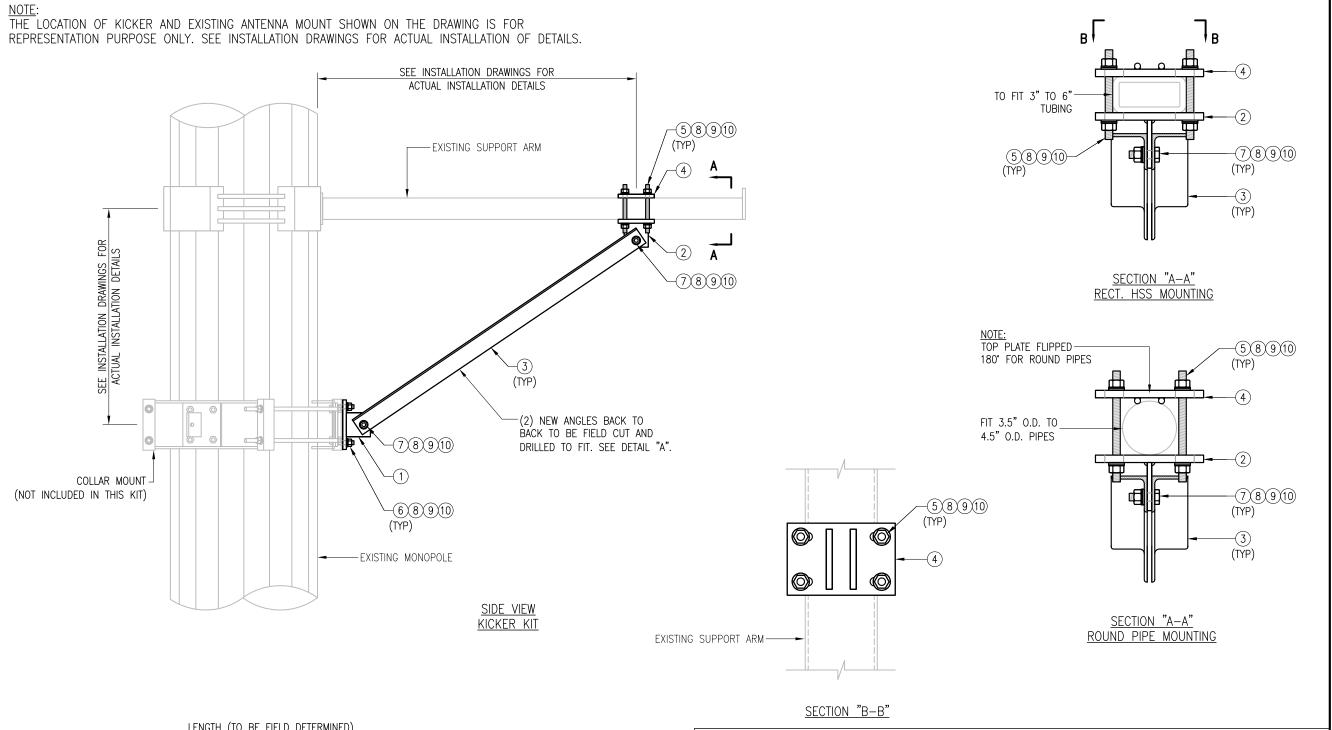
SITE NAME:

BARKHAMSTED W CT 468464

5 OLD FARM ROAD BARKHAMSTED, CT 06057 LITCHFIELD COUNTY



MOUNT PHOTOS



| _ | LENGTH (TO BE FIELD DETERMI | NED) | |
|----------|-----------------------------|--------------|--------------------------|
| | | 1 1/8" (TYP) | 1 3/4" |
| + | | | , in |
| | <u>DETAIL "A"</u> | | FIELD DRILL 11/16"Ø HOLE |

- 1. ALL HOLES ARE 11/16" DIA. U.N.O
- 2. HOT-DIPPED GALVANIZED PER ASTM A123. 3. FIT UP TO 6" SQ. TUBING OR 4 1/2" O.D. PIPE

| VZWSMART-PLK5 (KICKER KIT) | | | | | | |
|----------------------------|------|-----------|---|---------------|-------|--|
| ITEM NO. | QTY. | PART NO. | DESCRIPTION | SHEET # | WT | |
| 1 | 3 | BRKW-XXX | BRACKET WELDMENT A36 | PLK5-F3 | 43.8 | |
| 2 | 3 | BRKW-XXXX | BRACKET WELDMENT A36 | PLK5-F2 | 35.7 | |
| 3 | 6 | L331875-8 | L 3" X 3" X 3/16" X 8'-0" A36 | PLK5-F4 | 182.9 | |
| 4 | 3 | PL-KI | PL 5/8" X 6" X 9" A36 | PLK5-F1 | 29.0 | |
| 5 | 12 | | THREADED ROD 5/8" DIA. X 1'-0" F1554-36 HDG | | | |
| 6 | 6 | | BOLT 5/8" X 2" A325 | | | |
| 7 | 12 | | BOLT 5/8" X 2 1/2" A325 | | | |
| 8 | 42 | FW-625 | 5/8" HDG USS FLAT WASHER | | 3 | |
| 9 | 42 | LW-625 | 5/8" HDG LOCK WASHER | | 1 | |
| 10 | 42 | NUT-625 | 5/8" HDG HEX NUT | | 5 | |
| | • | | • | GALVANIZED WT | 291 | |


VzW SMART Tool[©] Vendor


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| SHEET TITLE: | |
| | |
| VZWSMAF | RT-PLK5 |
| | |

SHEET NUMBER: REV #: VZWSMART-PLK5

KICKER KIT



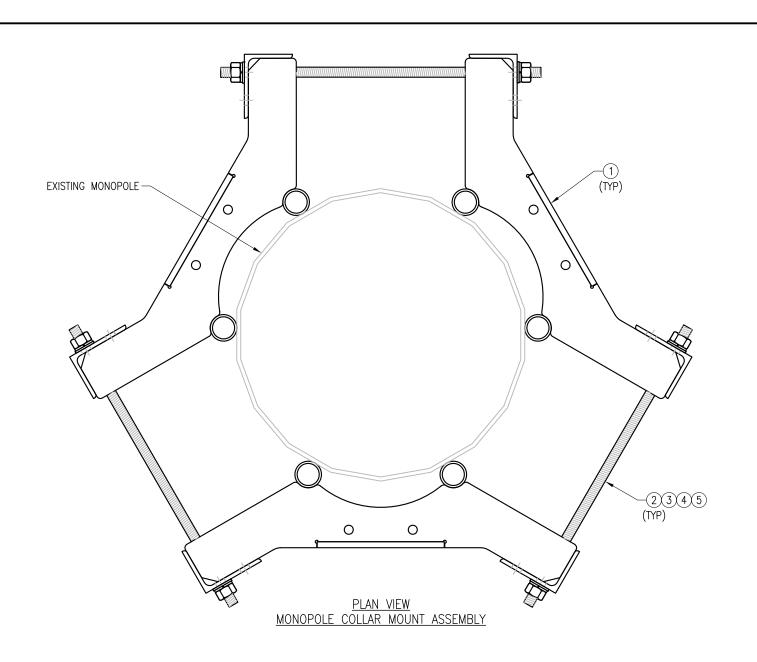
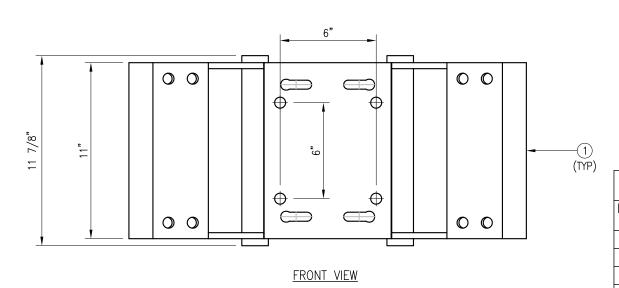
| | VZWSMART-PLK7 (MONOPOLE COLLAR MOUNT ASSEMBLY) | | | | | | |
|-------------|--|----------|-----------------------------------|---------|-----|--|--|
| ITEM NO. | QTY. | PART NO. | DESCRIPTION | SHEET # | WT | | |
| 1 | 3 | CM-1245 | COLLAR MOUNT ASSEMBLY | PLK7-F1 | 147 | | |
| 2 | 6 | | THREADED ROD 5/8" X 4'-0" A193-B7 | | | | |
| 3 | 12 | FW-625 | 5/8" HDG USS FLAT WASHER | | 1 | | |
| 4 | 12 | LW-625 | 5/8" HDG LOCK WASHER | | 0 | | |
| 5 | 12 | NUT-625 | 5/8" HDG HEX NUT | | 1 | | |

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VZWSMART-PLK7 MONOPOLE COLLAR MOUNT ASSEMBLY


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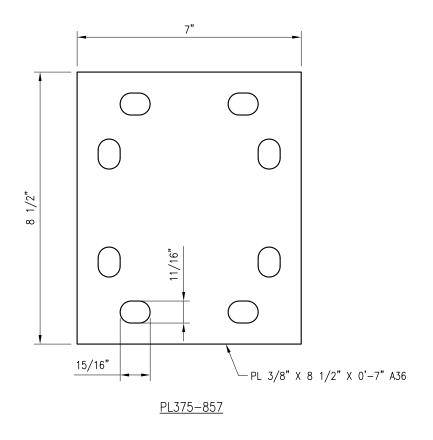
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GALVANIZED WT

1. FIT 12" TO 45" DIA MONOPOLE.

2. HOT-DIPPED GALVANIZED PER ASTM A123.



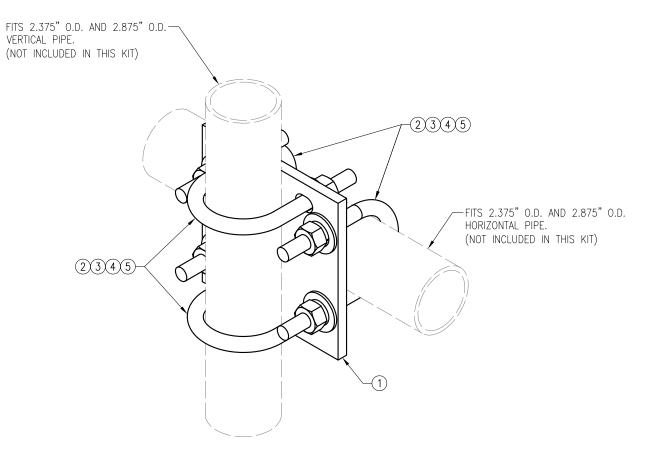

| | VZWSMART-MSK1 (CROSSOVER PLATE) | | | | | |
|---------------|---------------------------------|------------------|--|---------|----|--|
| ITEM NO. | QTY. | PART NO. | DESCRIPTION | SHEET # | WT | |
| 1 | 1 | PL375-857 | PL 3/8" X 8 1/2" X 0'-7" A36 | MSK1-F1 | 6 | |
| 2 | 4 | MS02-625-300-500 | RU-BOLT 5/8" X 3" I.W. X 5" I.L. A36 (OR EQUIV.) | RBC-1 | 5 | |
| 3 | 8 | FW-625 | 5/8" HDG USS FLAT WASHER | | 1 | |
| 4 | 8 | LW-625 | 5/8" HDG LOCK WASHER | | 0 | |
| 5 | 8 | NUT-625 | 5/8" HDG HEX NUT | | 1 | |
| GALVANIZED WT | | | | | 14 | |

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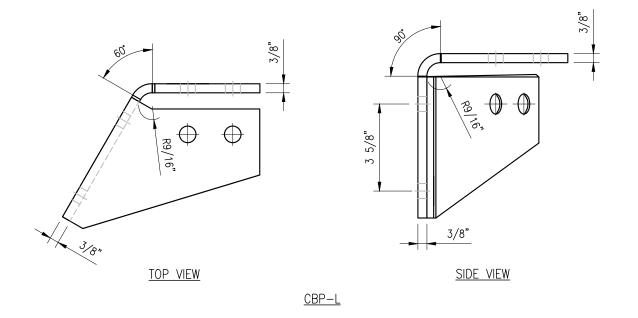
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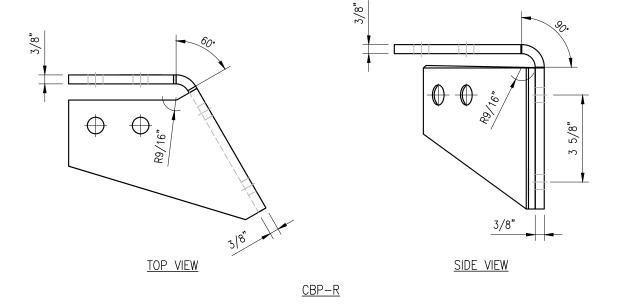
VZWSMART-MSK1 CROSSOVER PLATE

SHEET NUMBER: REV #:

VZWSMART-MSK1

NOTES:
1. HOT-DIPPED GALVANIZED PER ASTM A123.





NOTES:
1. HOT-DIPPED GALVANIZED PER ASTM A123.

| VZWSMART-PLK3 (SUPPORT RAIL CORNER BRACKET) | | | | | | |
|---|------------------|------------------|--|---------|----|--|
| ITEM NO. | QTY. | PART NO. | DESCRIPTION | SHEET # | WT | |
| 1 | 1 | CBP-L | CORNER BENT PLATE BRACKET | PLK3-F1 | 9 | |
| 2 | 1 | CBP-R | CORNER BENT PLATE BRACKET | PLK3-F1 | 9 | |
| 3 | 4 | MS02-625-300-500 | RU-BOLT 5/8" X 3" I.W. X 5" I.L. A36 (OR EQUIV.) | RBC-1 | 5 | |
| 4 | 8 | | BOLT 5/8" X 2" A325 | | 3 | |
| 5 | 16 | FW-625 | 5/8" HDG USS FLAT WASHER | | 1 | |
| 6 | 16 | LW-625 | 5/8" HDG LOCK WASHER | | 0 | |
| 7 | 16 | NUT-625 | 5/8" HDG HEX NUT | | 2 | |
| | GALVANIZED WT 30 | | | | | |


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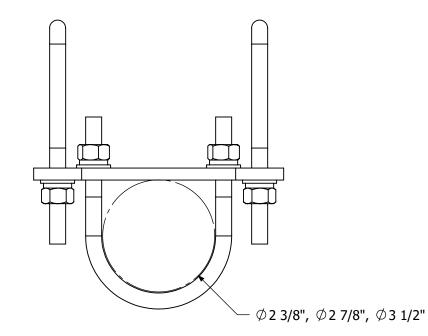
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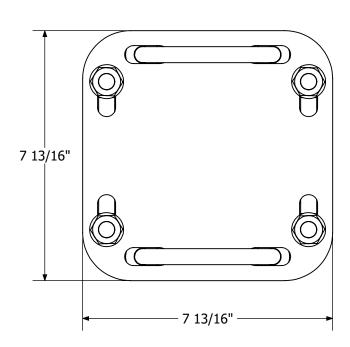
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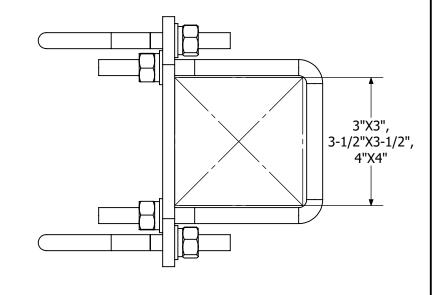
PV-XP-ST SQUARE TUBE TO ROUND PIPE CROSSOVER



PV-XP-ST SQUARE TUBE TO ROUND PIPE CROSSOVER WEIGHT: SEE TABLE 1





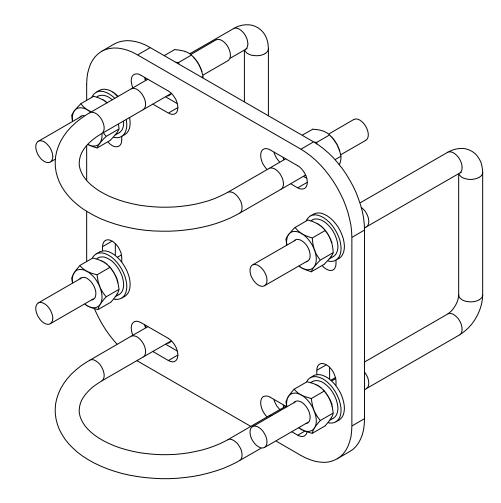



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| REVI | SIONS | S: | | | | |
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| | | | | | INITIAL RELEASE | DESCRIPTION |
| | | | | | 9/27/16 | DATE |
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| 1 | SITE INFORMATION: | |
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| Table 1: Crossover Configurations | | | |
|-----------------------------------|-------------|-----------------------|--------------|
| Part Number | Square Tube | Round Pipe | Weight (lbs) |
| PV-XP-30ST20 | 3" | NPS 2 (2-3/8" OD) | 10 |
| PV-XP-30ST25 | 3" | NPS 2-1/2 (2-7/8" OD) | 10 |
| PV-XP-30ST30 | 3" | NPS 3 (3-1/2" OD) | 10 |
| PV-XP-35ST20 | 3-1/2" | NPS 2 (2-3/8" OD) | 10 |
| PV-XP-35ST25 | 3-1/2" | NPS 2-1/2 (2-7/8" OD) | 10 |
| PV-XP-35ST30 | 3-1/2" | NPS 3 (3-1/2" OD) | 10 |
| PV-XP-40ST20 | 4" | NPS 2 (2-3/8" OD) | 10 |
| PV-XP-40ST25 | 4" | NPS 2-1/2 (2-7/8" OD) | 10 |
| PV-XP-40ST30 | 4" | NPS 3 (3-1/2" OD) | 10 |