



July 1, 2014

Melanie Bachman
Acting Executive Director
Connecticut Siting Council
10 Franklin Square
New Britain, CT 06051

RECEIVED
JUL - 7 2014
CONNECTICUT
SITING COUNCIL

RE: EM# -AT&T- 003-131209B Notice of Completion of Construction & PE Certification
New Cingular Wireless/ AT&T 142 Fitts Road, Ashford, CT

Dear Ms. Bachman:

The purpose of this letter is to notify you that construction activity associated with the above-referenced decision has been completed.

As part of the decision conditions, a PE letter confirming that the construction was in conformity with the structural modification design is attached.

If you have any questions or need any additional information regarding this facility, please do not hesitate to contact me.

Sincerely,

A handwritten signature in black ink, appearing to read "Jonathan McNeal", is written over the typed name.


Jonathan McNeal
Zoning Lead
SAI Communications
Agent for New Cingular Wireless/AT&T Mobility, Inc.
27 Northwestern Avenue
Salem, New Hampshire 03079

Cc: Christine Vergati, Cuddy Feder (via email only)
SAI Construction (via email only)

27 Northwestern Drive
Salem, NH 03079
603-421-0470

260 Cedar Hill Street
Marlborough, MA 01752
603-421-0470

2400 Ownby Lane
Richmond, VA 23220
804-273-9220

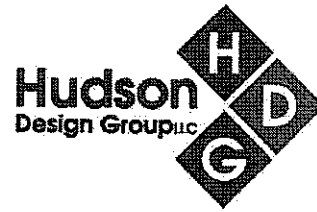

Final Report of Special Inspections

Project: CT5702 Ashford Southeast, AT&T Mobility Telecommunication Facility Upgrade (LTE)

Location: 142 Fitts Road, Ashford, CT 06278

Owner: AT&T Wireless (New Cingular Wireless)

Engineer of Record: Daniel P. Hamm, P.E.

Hudson Design Group, LLC.

To the best of my information, knowledge and belief, the Special Inspections required for this project have been performed and all discovered discrepancies have been reported and resolved.

Representatives of Hudson Design Group LLC performed inspections following the construction of the AT&T telecommunications facility at the above-referenced address. The Final Inspection was conducted on September 09, 2013.

Comments: Based on my knowledge, information and belief the completed LTE installation substantially conforms to the approved plans, Connecticut State Building Code, Structural Standards for Steel Antenna Towers and Antenna Supporting Structures (ANSI/TIA/EIA-222-F), the equipment manufacturer's installation guidelines, and the following:


1. Final LTE Construction Drawings dated 10-02-2012, prepared by Hudson Design Group LLC, entitled "Ashford Southeast".

All deviations from the approved plans do not endanger the intended occupancy of the facility and equipment substitutions are approved as equivalent to the original specifications. Construction has been satisfactorily completed.

Respectfully submitted,
Special Inspector

Daniel P. Hamm, P.E.


(Type or print name)

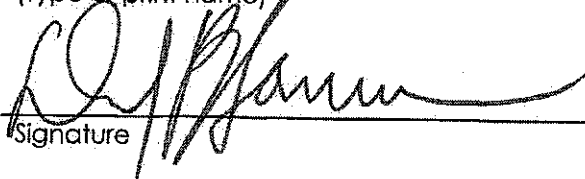
Signature

9-18-13

Date



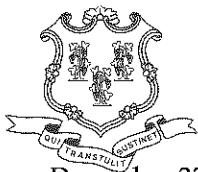

STATE OF CONNECTICUT
CONNECTICUT SITING COUNCIL

Ten Franklin Square, New Britain, CT 06051

Phone: (860) 827-2935 Fax: (860) 827-2950

E-Mail: siting.council@ct.gov

www.ct.gov/csc

December 27, 2013

Matt Burke
Tower Resource Management, Inc.
16 Chestnut Street, Suite 220
Foxboro, MA 02035

RE: **EM-AT&T-003-131209B** - American Telephone and Telegraph Company (AT&T) notice of intent to modify an existing telecommunications facility located at 142 Fitts Road, Ashford, Connecticut.

Dear Mr. Burke:


The Connecticut Siting Council (Council) hereby acknowledges your notice to modify this existing telecommunications facility, pursuant to Section 16-50j-73 of the Regulations of Connecticut State Agencies with the following conditions:

- Any deviation from the proposed modification as specified in this notice and supporting materials with the Council shall render this acknowledgement invalid;
- Any material changes to this modification as proposed shall require the filing of a new notice with the Council;
- Within 45 days after completion of construction, the Council shall be notified in writing that construction has been completed;
- The validity of this action shall expire one year from the date of this letter; and
- The applicant may file a request for an extension of time beyond the one year deadline provided that such request is submitted to the Council not less than 60 days prior to the expiration.

The proposed modifications including the placement of all necessary equipment and shelters within the tower compound are to be implemented as specified here and in your notice received December 9, 2013. The modifications are in compliance with the exception criteria in Section 16-50j-72 (b) of the Regulations of Connecticut State Agencies as changes to an existing facility site that would not increase tower height, extend the boundaries of the tower site, increase noise levels at the tower site boundary by six decibels, and increase the total radio frequencies electromagnetic radiation power density measured at the tower site boundary to or above the standard adopted by the State Department of Environmental Protection pursuant to General Statutes § 22a-162. This facility has also been carefully modeled to ensure that radio frequency emissions are conservatively below State and federal standards applicable to the frequencies now used on this tower.

This decision is under the exclusive jurisdiction of the Council. Please be advised that the validity of this action shall expire one year from the date of this letter. Any additional change to this facility will require explicit notice to this agency pursuant to Regulations of Connecticut State Agencies Section 16-50j-73. Such notice shall include all relevant information regarding the proposed change with cumulative worst-case modeling of radio frequency exposure at the closest point of uncontrolled access to the tower base, consistent with Federal Communications Commission, Office of Engineering and Technology, Bulletin 65. Thank you for your attention and cooperation.

Very truly yours,


Melanie A. Bachman
Acting Executive Director

MAB/CDM/laf

c: The Honorable, Michael J. Zambo, First Selectman, Town of Ashford
Michael Gardner, Zoning Enforcement Officer, Town of Ashford
Sean Gormley, SBA





Matt Burke

16 Chestnut Street, Suite 220
Foxboro, MA 02035
Tel (508) 930-0974
Fax (774) 215-5423

Melanie Bachman
Acting Executive Director
Connecticut Siting Council
10 Franklin Square
New Britain, CT 06051

Re: **Notice of Exempt Modification - Emergency Backup Generator**
142 Fitts Road, Ashford, CT 06278 (FA# 10070913)

Dear Ms. Bachman:

American Telephone and Telegraph Company ("AT&T") currently maintains a wireless telecommunications facility at the above referenced address. AT&T's facility consists of antennas at the 167' level of an existing 176' tower and a 200-square-foot lease area. The tower and AT&T's shelter are located within an existing, fenced-in compound area. The shelter houses AT&T's equipment and space for a back-up generator. AT&T does not currently maintain a generator at this cell site.

In an effort to further enhance multiple tenants' network reliability, AT&T intends to modify its facility by installing a new diesel-fueled generator outside in a designated 4' x 8' ground space. The generator incorporates a built-in fuel tank as part of the unit. The diesel fuel tanks are double walled for added safety and will be filled by a licensed fuel filling company. The proposed modification will remain within the existing, fenced-in compound. The new generator and tank will be surrounded by a security fence and gate and will be placed on a 4' x 8' concrete pad. (See Facility Compound Plan attached).

Please accept this letter as notification pursuant to R.C.S.A Section 16-50j-73, for construction that constitutes modification pursuant to R.C.S.A Section 16-50j-72(b)(2). In accordance with R.C.S.A Section 16-50j-73, a copy of this submission is being sent to the Town of Ashford. A copy of this submission is also being sent to Conn Rivers Council, Inc. BSA, the property owner on which the tower is located.

AT&T's Proposed Wireless Modifications Constitute An "Exempt Modification"

The proposed modification to the above mentioned Facility constitutes an exempt modification of an existing facility provided for in R.C.S.A Section 16-50j-72(b)(2) and Council regulations promulgated pursuant thereto.

- 1) The proposed modification will not result in an increase in the height of the existing tower.
- 2) The generator and attached fuel tank will remain entirely within the limits of the leased area. The modifications therefore, will not require the extension of the boundary.
- 3) The proposed modification does not increase the noise levels at the boundary by six (6) decibels or more under normal conditions. Proposed modification is only used during emergency power failure.
- 4) The installation of a new generator and attached fuel tank will not change, in any way, radio frequency (RF) emissions at the facility.
- 5) The facility has received all municipal zoning approvals and building permits. (Regs., Conn. State Agencies Section 16-50j-72))

For all the foregoing reasons, American Telephone and Telegraph Company respectfully submits that the proposed modifications to the above-referenced telecommunications facility constitutes an exempt modification under R.C.S.A Section 16-50j-72(b)(2)

Respectfully submitted,

Matt Burke 508.930.0974


On behalf of AT&T

c/o Tower Resource Management, Inc.
16 Chestnut Street, Suite 220
Foxboro, MA 02035

cc: **Town of Ashford, CT**
Conn Rivers Council, Inc. BSA

Exhibit 1

Site Plan

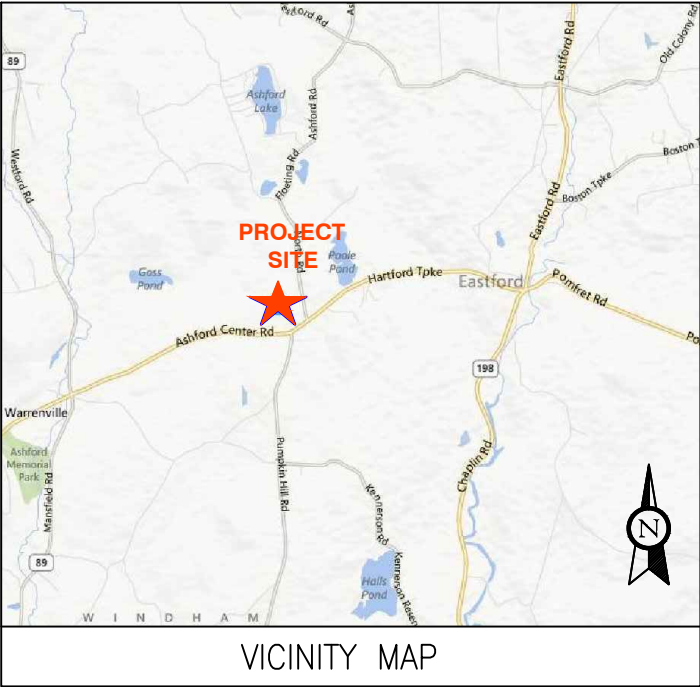

VICINITY MAP




THIS FACILITY SHALL MEET OR EXCEED ALL FAA AND FCC REGULATORY REQUIREMENTS.



BACKUP POWER PROJECT

SITE IDENTIFICATION:

SITE NUMBER: 10070913
SITE NAME: ASHFORD SOUTHEAST
SITE ADDRESS: 142 FITTS ROAD
ASHFORD, CT 06278

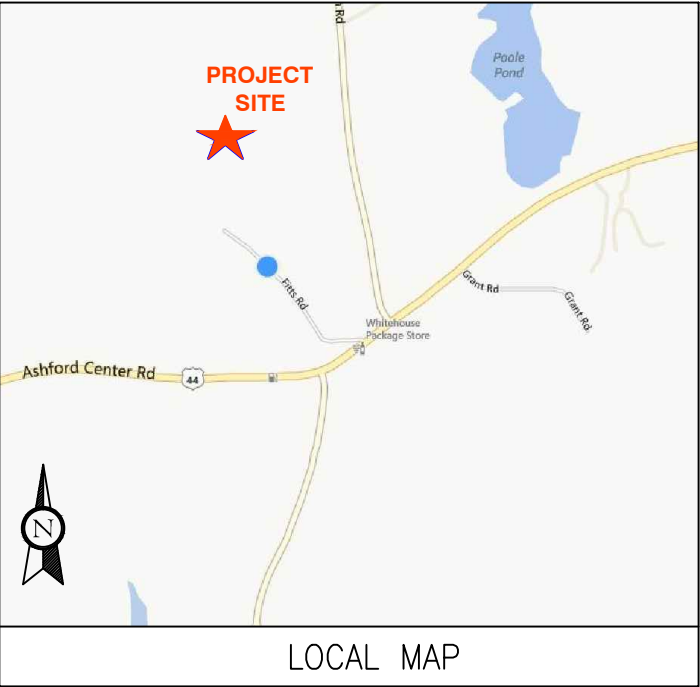

LOCAL MAP

CONTRACTOR TO VERIFY EXISTING MUX LOCATION. IF MUX LOCATION IS OUTSIDE OF AT&T EQUIPMENT AREA, CONTRACTOR IS TO FIELD VERIFY THE PRESENCE OF EMERGENCY BACK-UP SERVICE TO THE MUX. IF EMERGENCY BACK-UP SERVICE IS NOT PRESENT, CONTRACTOR IS TO ROUTE NEW SERVICE FROM AT&T EQUIPMENT AREA.

PROJECT DESCRIPTION:

THE PROPOSED PROJECT INCLUDES PLACING A 50 KW GENERATOR IN AN EXISTING CELLULAR TOWER COMPOUND.

PROJECT TEAM	PROJECT SUMMARY	PROJECT NOTES	SHEET INDEX				
<div>ENGINEER</div> <div>ADVANCED ENGINEERING GROUP, P.C. 500 NORTH BROADWAY EAST PROVIDENCE, RI 02914 TEL: 401-354-2403</div> <div>CUSTOMER REPRESENTATIVE:</div> <div>SABRE INDUSTRIES PEGGY POOR MARKET LEAD – AT&T NE GENERATOR PROGRAM 13010 MORRIS ROAD, 6TH FLOOR, BLDG 1 ALPHARETTA, GA 30004 CELL 770-990-0137</div> <div>LANDLORD:</div> <div>SBA 5900 BROKEN SOUND PARKWAY NW, 2ND FLOOR BOCA RATON, FL 33487</div> <div>UTILITIES:</div> <div>POWER COMPANY:</div> <div>NORTHEAST UTILITIES (NU) P.O. BOX 270 HARTFORD, CT 06141-0270 PHONE: 1-800-286-5000</div>	<div>GEOGRAPHIC COORDINATES:</div> <div>LATITUDE: 41° 52' 50" N LONGITUDE: 72° 07' 43" W</div> <div>CODE BLOCK:</div> <div>BUILDING CODE: 2009 INTERNATIONAL BUILDING CODE</div>	<div>1. THE FACILITY IS UNMANNED.</div> <div>2. A TECHNICIAN WILL VISIT THE SITE APPROXIMATELY ONCE A MONTH FOR ROUTINE INSPECTION AND MAINTENANCE.</div> <div>3. THE PROJECT WILL NOT RESULT IN ANY SIGNIFICANT LAND DISTURBANCE OR EFFECT OF STORM WATER DRAINAGE.</div> <div>4. NO SANITARY SEWER, POTABLE WATER OR TRASH DISPOSAL AS REQUIRED.</div> <div>5. HANDICAP ACCESS IS NOT REQUIRED.</div>	<div>SHT NO:</div>				
		T-1	TITLE SHEET, VICINITY MAP AND GENERAL INFORMATION	1	11-26-2013	JG	
		A-1	COMPOUND PLAN	1	11-26-2013	JG	
		A-2	CONCRETE PAD DETAILS	1	11-26-2013	JG	
		E-1	WIRING DIAGRAM & SIZING CHARTS	1	11-26-2013	JG	
		E-2	ELECTRICAL & ATS MOUNTING DETAILS	1	11-26-2013	JG	
		G-1	GROUNDING DETAILS	1	11-26-2013	JG	

ADVANCED
ENGINEERING GROUP, P.C.
Civil Engineering - Site Development
Surveying - Telecommunications
500 NORTH BROADWAY
EAST PROVIDENCE, RI 02914
PH: 401-354-2403 FAX: 401-633-6354

TRM
Convergent Network Solutions
TOWER RESOURCE MANAGEMENT
16 CHESTNUT STREET, SUITE 220
FOXBORO, MA 02035
WWW.TRMCOM.COM

at&t
550 COCHITUATE ROAD, SUITE 13 & 14
FRAMINGHAM, MA 01701-4681


Sabre Industries
13010 MORRIS ROAD, 6TH FLOOR, BLDG 1
ALPHARETTA, GA 30004

SITE NUMBER:
10070913
SITE NAME:
ASHFORD SOUTHEAST
SITE ADDRESS:
142 FITTS ROAD
ASHFORD, CT 06278

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DATE DRAWN:	11-26-13
JOB NO:	10070913
SHEET TITLE: TITLE SHEET,VICINITY MAP AND GENERAL INFORMATION	
SHEET NUMBER:	REV. #
T-1	1



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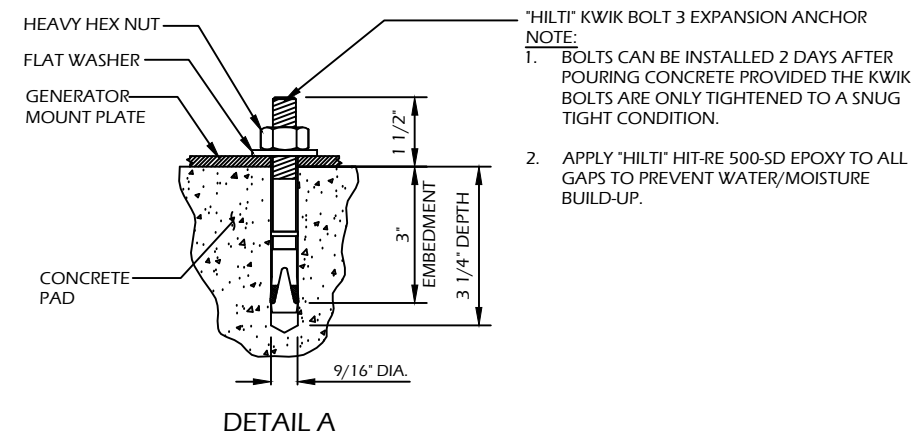
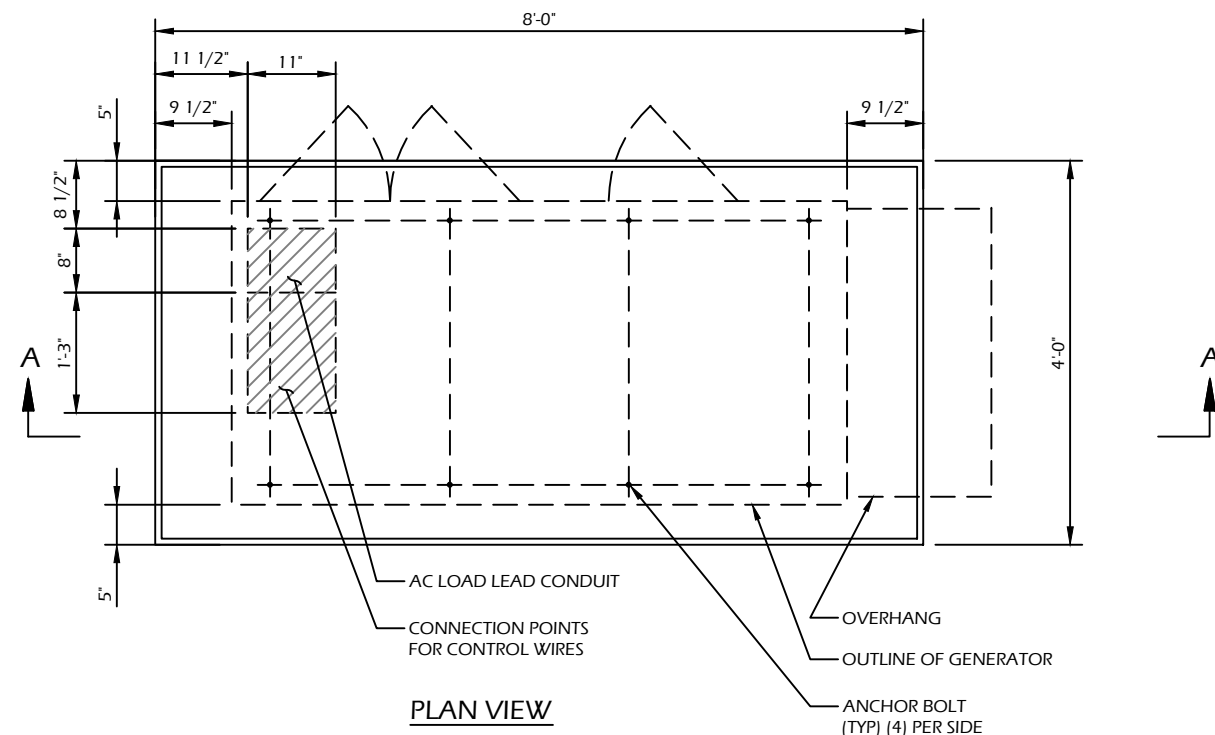
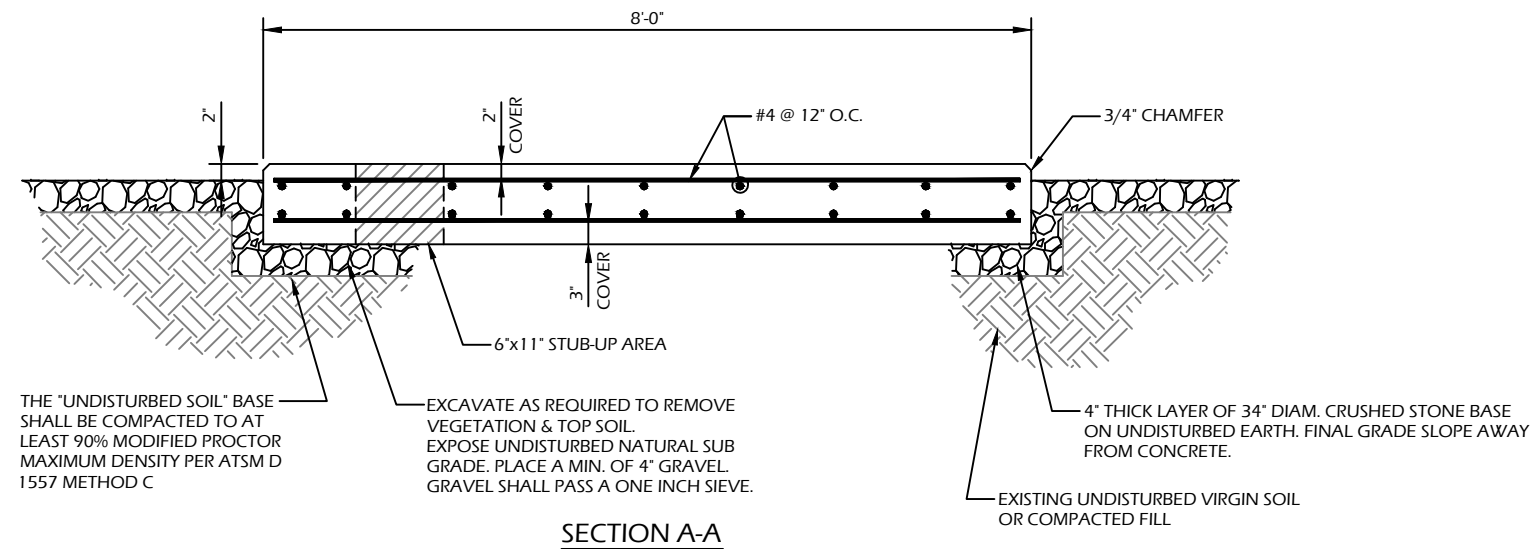
at&t
550 COCHITUATE ROAD, SUITE 13 & 14
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SHEET TITLE:	
COMPOUND PLAN	
SHEET NUMBER:	REV. #
A-1	1

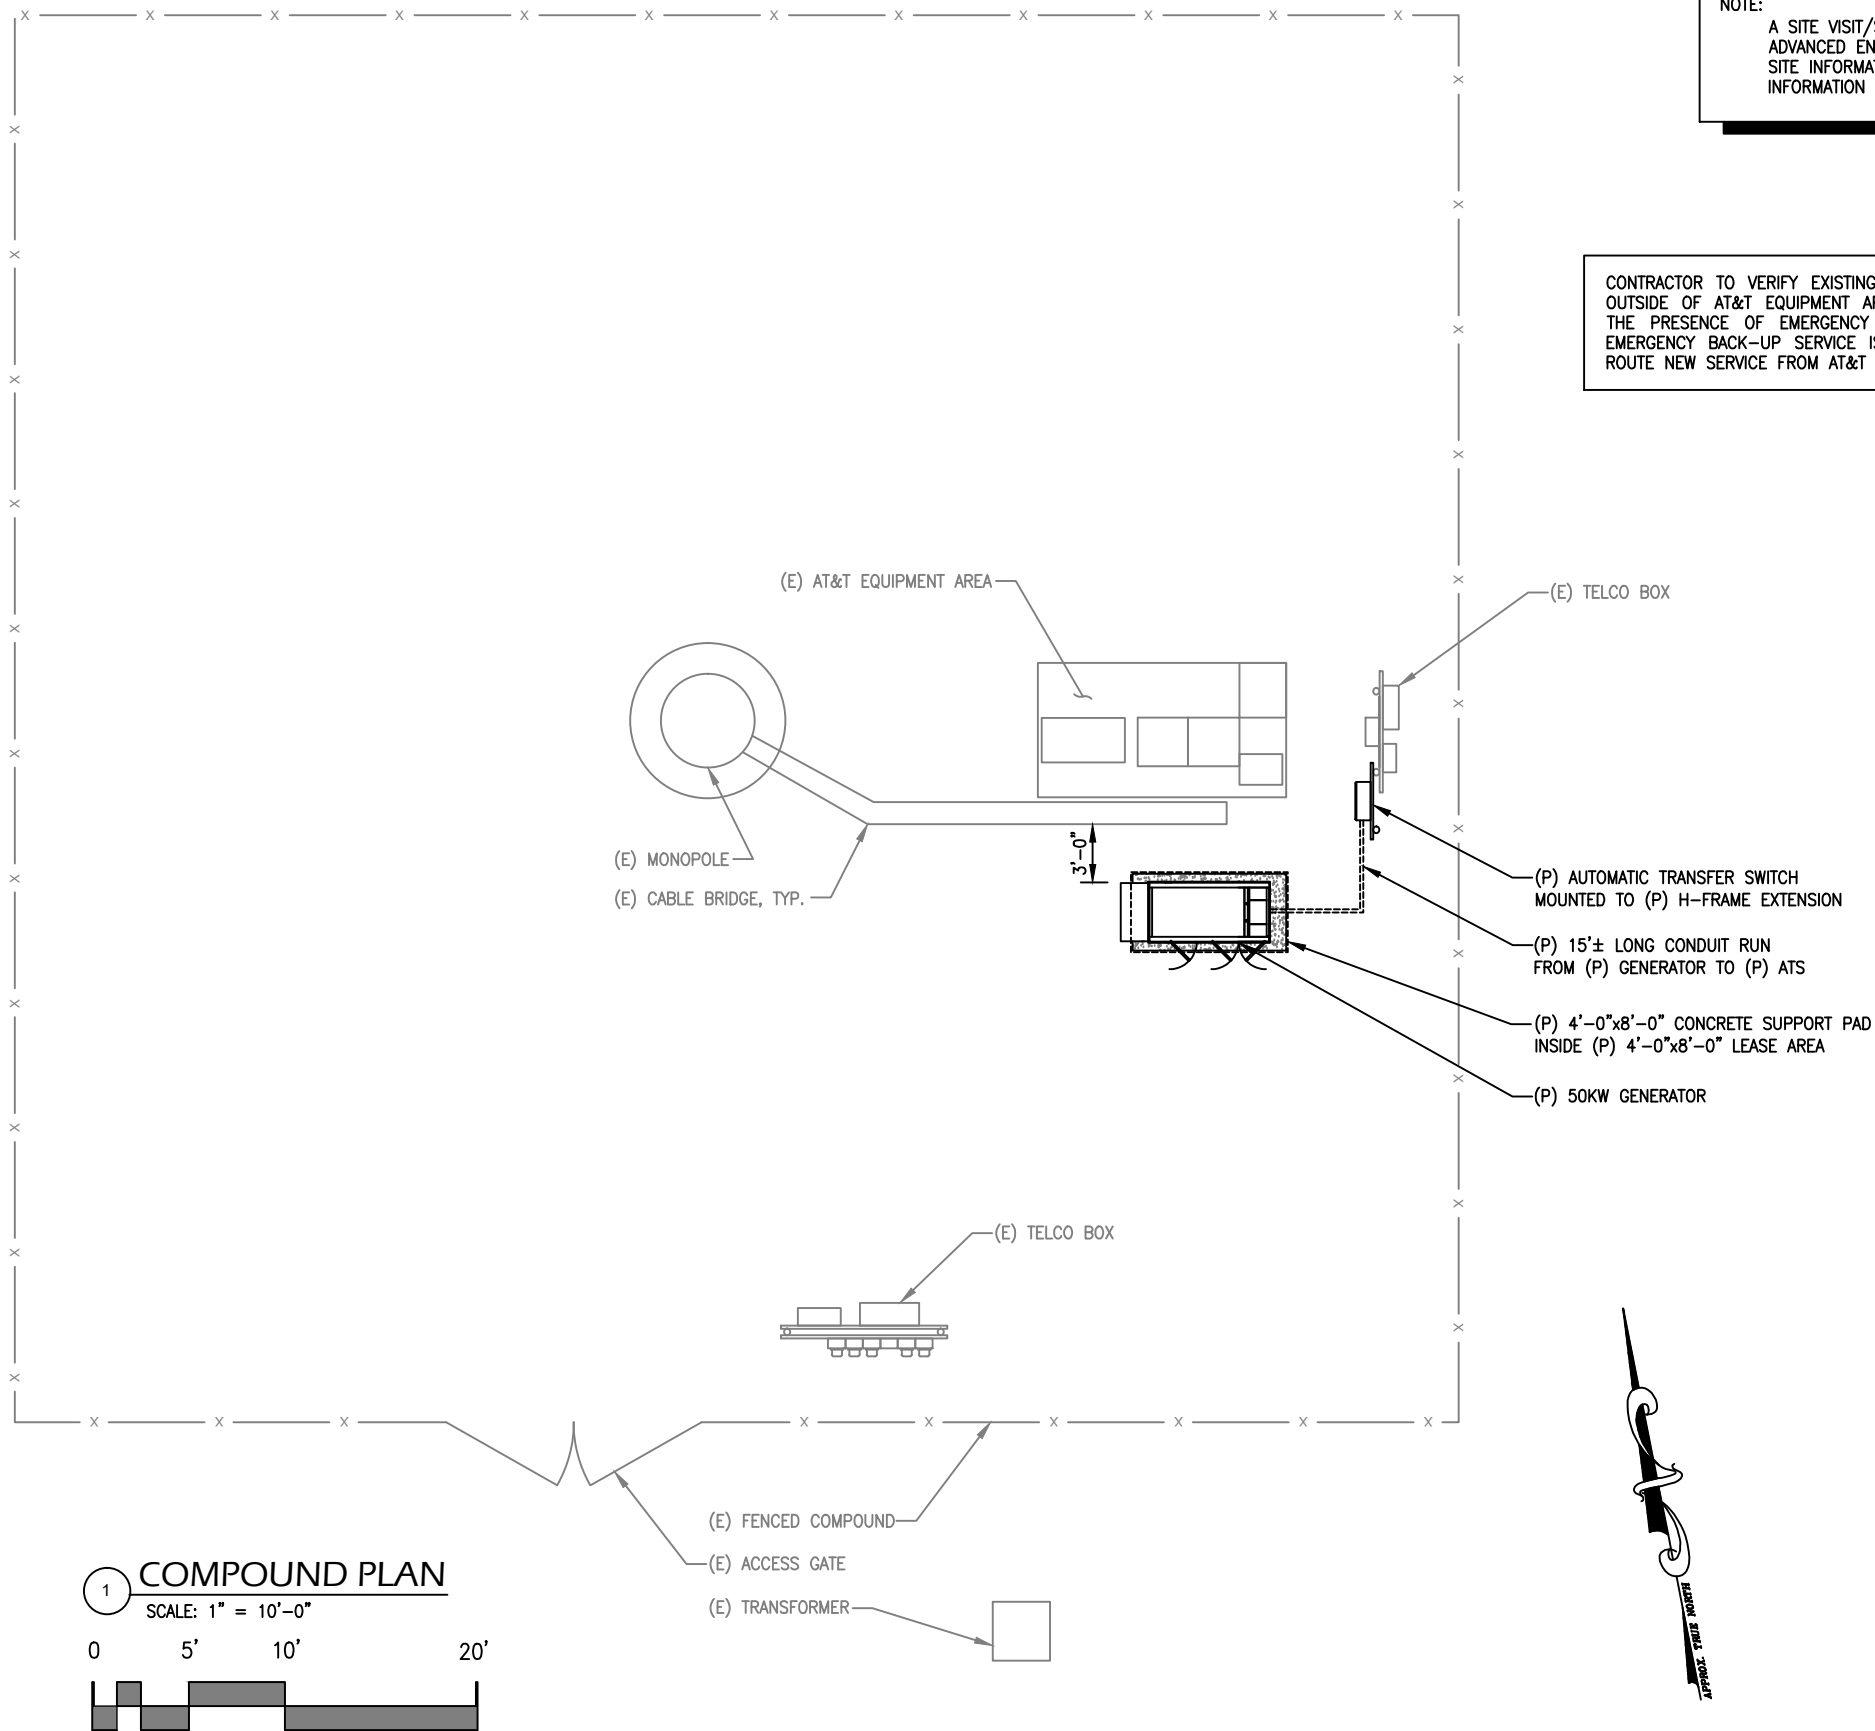

CONTRACTOR TO VERIFY EXISTING MUX LOCATION. IF MUX LOCATION IS OUTSIDE OF AT&T EQUIPMENT AREA, CONTRACTOR IS TO FIELD VERIFY THE PRESENCE OF EMERGENCY BACK-UP SERVICE TO THE MUX. IF EMERGENCY BACK-UP SERVICE IS NOT PRESENT, CONTRACTOR IS TO ROUTE NEW SERVICE FROM AT&T EQUIPMENT AREA.

CONCRETE PAD CONSTRUCTION NOTES

1. ALL REBAR (HORIZONTAL & VERTICAL) SHALL BE SECURELY WIRE TIED TO PREVENT DISPLACEMENT DURING POURING OF CONCRETE.
2. CONCRETE TO HAVE A MINIMUM COMPRESSIVE STRENGTH OF 4000 PSI.
3. REINFORCED CONCRETE CONSTRUCTION AND MATERIALS SHALL BE IN ACCORDANCE WITH ACI STANDARDS 318.
4. MINIMUM CONCRETE COVER OVER REBAR IS 2 1/2".
5. REINFORCING MATERIAL SHALL BE IN ACCORDANCE WITH ASTM SPECIFICATION A615-85.

CONCRETE PAD AND EMBEDMENT TOLERANCES

1. CONCRETE DIMENSIONS: PLUS OR MINUS 1/4".
2. REINFORCING STEEL PLACEMENT: PLUS OR MINUS 1/4" INCLUDING CONCRETE COVER.

NOTES

1. FOUNDATION WAS DESIGNED BY ASSUMING ALLOWABLE SOIL BEARING CAPACITY OF 1000 PSI. THE SOIL BEARING CAPACITY FOR EACH SITE MUST BE VERIFIED USING THE SITE SPECIFIC GEOTECH REPORT. IF SHALLOW GROUNDWATER (≤ 3 FT.) WAS REPORTED, A FURTHER REVIEW OF THE DESIGN OR SPECIAL DESIGN MAY BE REQUIRED.
2. THE SOIL UNDERNEATH THE CONCRETE PAD MUST BE FREE OF ORGANIC MATTER OR OTHER DELETERIOUS SUBSTANCES, AND SHOULD BE COMPACTED AND LEVELED BEFORE PLACING THE FOUNDATION.
3. CONCRETE SLUMPS: 1"~3".
4. CONCRETE VOLUME: 2.4 CUBIC YARDS.

DESIGN

1. MAXIMUM DESIGN BASIC WIND SPEED (3-SECOND GUST): 155 MPH FOR GENERATOR MODELS SD050 AND SD080.

PRE-CAST GENERATOR PAD

ADVANCED
ENGINEERING GROUP, P.C.
Civil Engineering - Site Development
Surveying - Telecommunications
500 NORTH BROADWAY
EAST PROVIDENCE, RI 02914
PH: 401-354-2403 FAX: 401-633-6354

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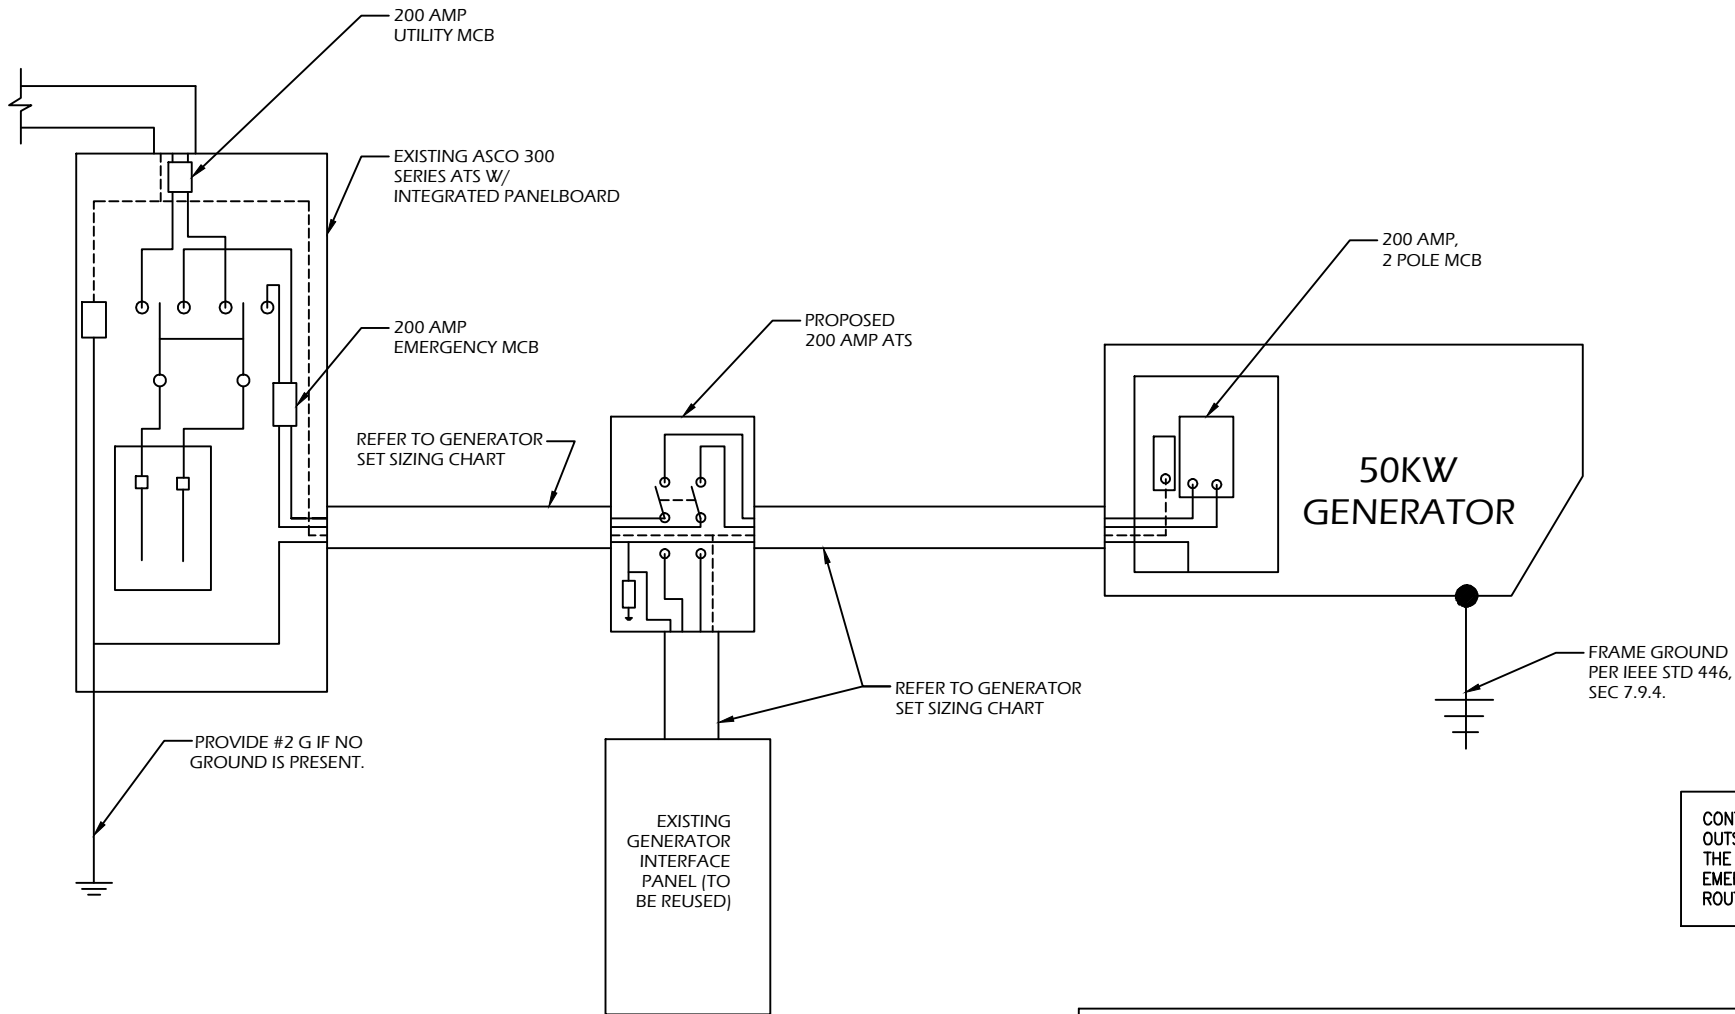
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JOB NO:	10070913
SHEET TITLE:	CONCRETE PAD DETAILS
SHEET NUMBER:	A-2
REV. #	1



1 SINGLE CARRIER WIRING DIAGRAM
SCALE: NOT TO SCALE

- NOTES:
1. ALL UNDERGROUND CABLE TO BE BURIED AT 36" MIN. SHIELD TAPED AT 12" AND STUBBED OUT OF GROUND IN SCH 40 PVC CONDUIT.
 2. LOW VOLTAGE CONTROL WIRE PROVIDED BY MONITORING PROVIDER IN SEPARATE 1/2" CONDUIT FROM ATS TO GENERATOR.
 3. BTS SITES: THE TENANT CONTRACTOR TO COMPLETE CUSTOMER ELECTRICAL CONDUIT TO CUSTOMER METER PER STANDARD COLLOCATION INSTALL.
 4. TENANT CONTRACTOR HAS NOTHING TO INSTALL OR COMPLETE FOR ATC SHARED GEN DURING CUSTOMER COLLOCATION ON ATC TOWER.
 5. ATC SHARED GEN INSTALL IS COMPLETED AFTER CUSTOMER TOWER COLLOCATION IS COMPLETE WITH LOAD ON CUSTOMER METER.
 6. ALL CONDUCTORS ARE SIZED FOR COPPER, BUT ALUMINUM CONDUCTORS ARE ALLOWED FOR FEEDERS PROVIDED THEY ARE UPSIZED PER NEC TABLE 310.16.
 7. ALL ELECTRICAL WORK SHALL BE PER THE NATIONAL ELECTRICAL CODE (NFPA 70) AND ALL APPLICABLE LOCAL CODES.
 8. MAINTAIN 36" CLEAR WORKSPACE IN FRONT OF METER, TRANSFER SWITCH, GENERATOR, PANELS, ETC.
 9. 800A PANEL HAS A COMMON NEUTRAL BUS. NEUTRALS BACK TO EACH CARRIER METER ARE SIZED ACCORDING TO THE DISTRIBUTION PANEL BRANCH BREAKER RATING. NEUTRAL IS BONDED AT THE PRIMARY SERVICE MAIN BONDING JUMPER ONLY.
 10. GENERATOR CONTROLS AND SENSORS SHALL HAVE GFCI SENSING CAPABILITY PER NEC 700-6(D).

CONTRACTOR TO VERIFY EXISTING MUX LOCATION. IF MUX LOCATION IS OUTSIDE OF AT&T EQUIPMENT AREA, CONTRACTOR IS TO FIELD VERIFY THE PRESENCE OF EMERGENCY BACK-UP SERVICE TO THE MUX. IF EMERGENCY BACK-UP SERVICE IS NOT PRESENT, CONTRACTOR IS TO ROUTE NEW SERVICE FROM AT&T EQUIPMENT AREA.


FEEDER SIZING CHART FOR GENERATOR

GEN SET SIZE	VOLTS - PHASE	PRIME RATING KW - AMPS	SIZE OF INLINE BREAKER (AT GENERATOR)	MAIN BREAKER SIZE SERVING ANCHOR TENANT:	FEEDER SIZES FROM GEN SET BREAKER TO DISTRIBUTION PANEL / ATS.
50KW	120/240V - 1-PH	48KW - 200A	200A	200A 2-P C/B INTEGRAL TO GEN SET	3#3/0, 1#6G, IN 2"C

- NOTES:
1. SERVICE VOLTAGE FOR EACH CARRIER IS 120/240 1-PHASE, AND SERVICE SIZES ARE TYPICAL 200A PER CARRIER.
 2. DISTRIBUTION PANEL IS 800A, 120/240V 1-PHASE, WITH 200A C/B FOR THE LISTED CARRIER OUTPUT. PANEL HAS (3) 200A BREAKER SPACES FOR FUTURE CARRIERS.
 3. AUTOMATIC TRANSFER SWITCH (ATS) ARE 200A 2-POLES, 120/240V 1-PHASE WITH SOLID NEUTRAL PER CARRIER.
 4. ALL ELECTRICAL EQUIPMENT IS NEMA 3R RATED.
 5. THE GENERATOR ELECTRICAL LOADS ARE ADEQUATE FOR THE CONNECTED LOADS.
 6. ALL EQUIPMENT FURNISHED SHALL BE PROVIDED WITH EQUIPMENT RATED TO WITHSTAND FAULT CURRENT AVAILABLE AT PROJECT SITE.
 7. ALL WIRE AND PANEL BUSSING SHALL BE COPPER UNLESS ALLOWED ELSEWHERE IN THIS DOCUMENT SET, WIRE SIZES ARE BASED ON COPPER.
 8. A NEW SET OF PLANS WILL BE PROVIDED AND SUBMITTED FOR ADDITIONAL CARRIERS.
 9. ALL WORK SHALL CONFORM WITH THE CURRENT VERSION OF THE NEC AND ALL OTHER APPLICABLE CODES.
 10. FIRST OVER-CURRENT PROTECTION DEVICE IS INTEGRAL TO GENERATOR. FEEDER SIZES INDICATED IN TABLE ABOVE ARE DOWNSTREAM OF THE FIRST OVER-CURRENT PROTECTION DEVICE.
 11. INLINE BREAKER AT GENERATOR IS FACTORY INSTALLED, AND IS THE MANUFACTURER'S RECOMMENDED SIZE.


2 GENERATOR SET SIZING CHARTS

NOTE: UTILITY POWER FEEDS SHALL BE CONNECTED TO THE TRANSFER SWITCH FROM THE LOAD SIDE OF THE EXISTING SERVICE DISCONNECT. NO MODIFICATIONS SHALL BE MADE ON THE LINE SIDE OF THE EXISTING SERVICE DISCONNECT.

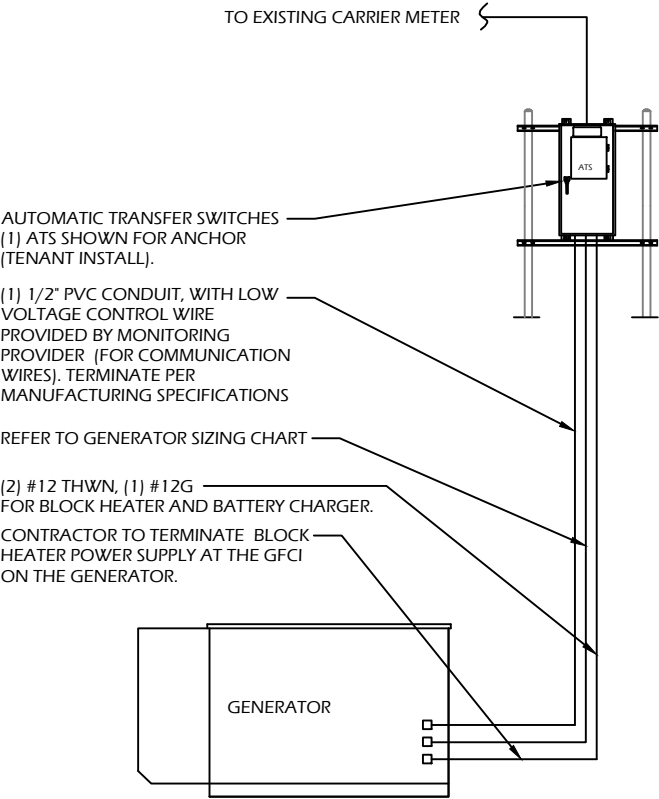

DISCONNECT POWER FEED FROM EXISTING METER TO EXISTING SHELTER. ROUTE NEW FEEDERS (SIZED BELOW) FROM METER TO NEW TRANSFER SWITCH AND BACK. RECONNECT NEW RETURN FEED FROM TRANSFER SWITCH TO SUPPLY POWER (UTILITY AND BACK-UP POWER) TO EXISTING SHELTER.

1 METER CONFIGURATION

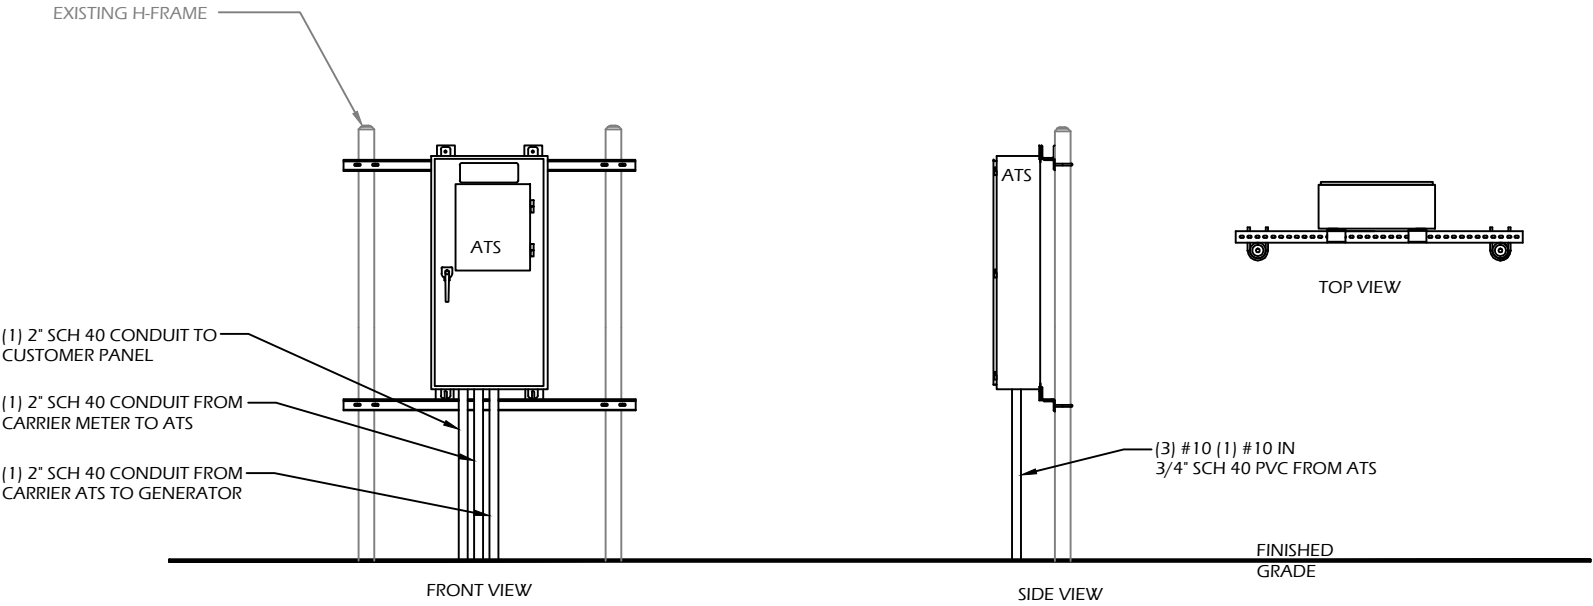

2 H-FRAME LAYOUT
SCALE: NOT TO SCALE

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Convergent Network Solutions
TOWER RESOURCE MANAGEMENT
16 CHESTNUT STREET, SUITE 220
FOXBORO, MA 02035
WWW.TRMCOM.COM


at&t
550 COCHITUATE ROAD, SUITE 13 & 14
FRAMINGHAM, MA 01701-4681

Sabre Industries
13010 MORRIS ROAD, 6TH FLOOR, BLDG 1
ALPHARETTA, GA 30004

SITE NUMBER:
10070913
SITE NAME:
**ASHFORD
SOUTHEAST**
SITE ADDRESS:
142 FITTS ROAD
ASHFORD, CT 06278


THESE DRAWINGS AND/OR THE ACCOMPANYING SPECIFICATION AS INSTRUMENTS OF SERVICE ARE THE EXCLUSIVE PROPERTY OF ATC TOWER SERVICES, INC. THEIR USE AND PUBLICATION SHALL BE RESTRICTED TO THE ORIGINAL SITE FOR WHICH THEY ARE PREPARED. ANY USE OR DISCLOSURE OTHER THAN THAT WHICH RELATES TO ATC TOWER SERVICES, INC. OR THE SPECIFIED CARRIER IS STRICTLY TITLE TO THESE DOCUMENTS SHALL REMAIN THE PROHIBITED. PROPERTY OF ATC TOWER SERVICES, INC. WHETHER OR NOT THE PROJECT IS EXECUTED. NEITHER THE ARCHITECT NOR THE ENGINEER WILL BE PROVIDING ON-SITE CONSTRUCTION REVIEW OF THIS. CONTRACTOR(S) MUST VERIFY ALL DIMENSIONS AND ADVISE PROJECT. ATC TOWER SERVICES, INC. OF ANY DISCREPANCIES. ANY PRIOR ISSUANCE OF THIS DRAWING IS SUPERSEDED BY THE LATEST VERSION ON FILE WITH ATC TOWER SERVICES, INC.

STAMP HERE:	
DRAWN BY:	JTG
CHECKED BY:	SNA
DATE DRAWN:	11-26-13
JOB NO:	10070913
SHEET TITLE: ELECTRICAL & ATS MOUNTING DETAILS	
SHEET NUMBER: E-2	REV. # 1

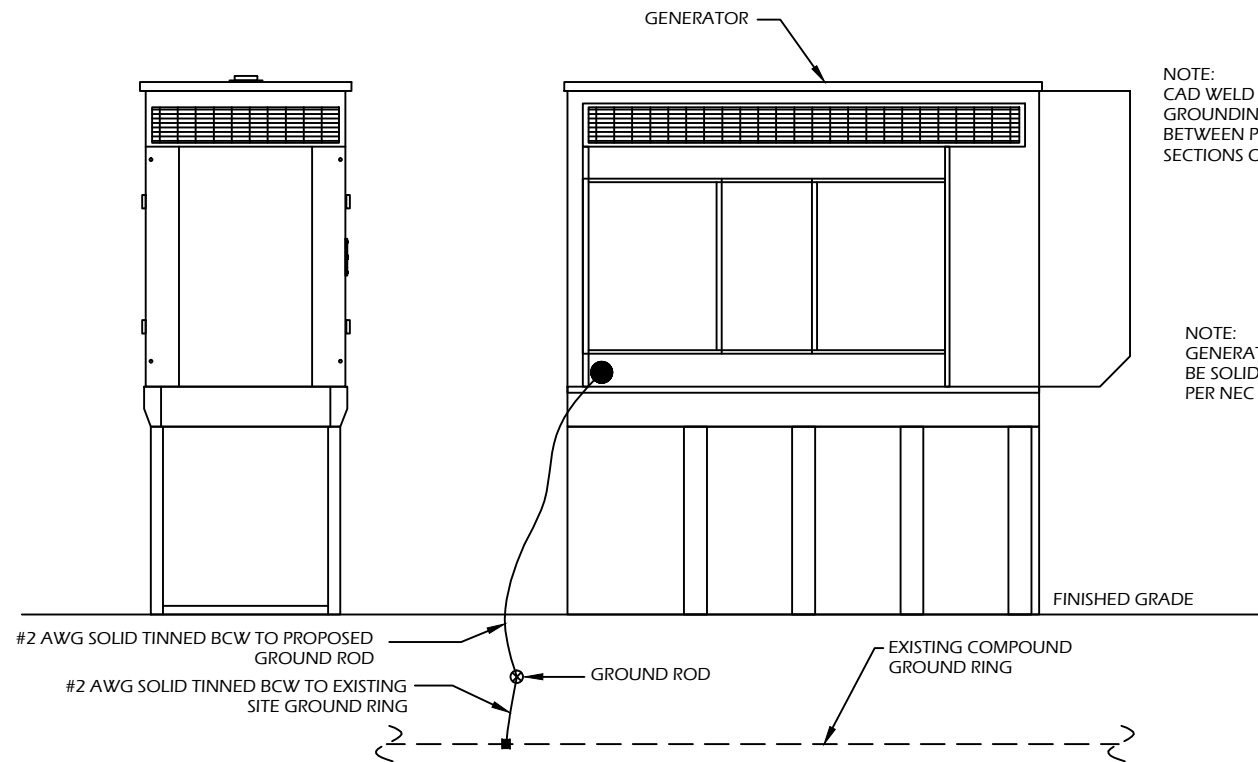


1 GENERATOR ELEVATION

CONTRACTOR TO VERIFY EXISTING MUX LOCATION. IF MUX LOCATION IS OUTSIDE OF AT&T EQUIPMENT AREA, CONTRACTOR IS TO FIELD VERIFY THE PRESENCE OF EMERGENCY BACK-UP SERVICE TO THE MUX. IF EMERGENCY BACK-UP SERVICE IS NOT PRESENT, CONTRACTOR IS TO ROUTE NEW SERVICE FROM AT&T EQUIPMENT AREA.

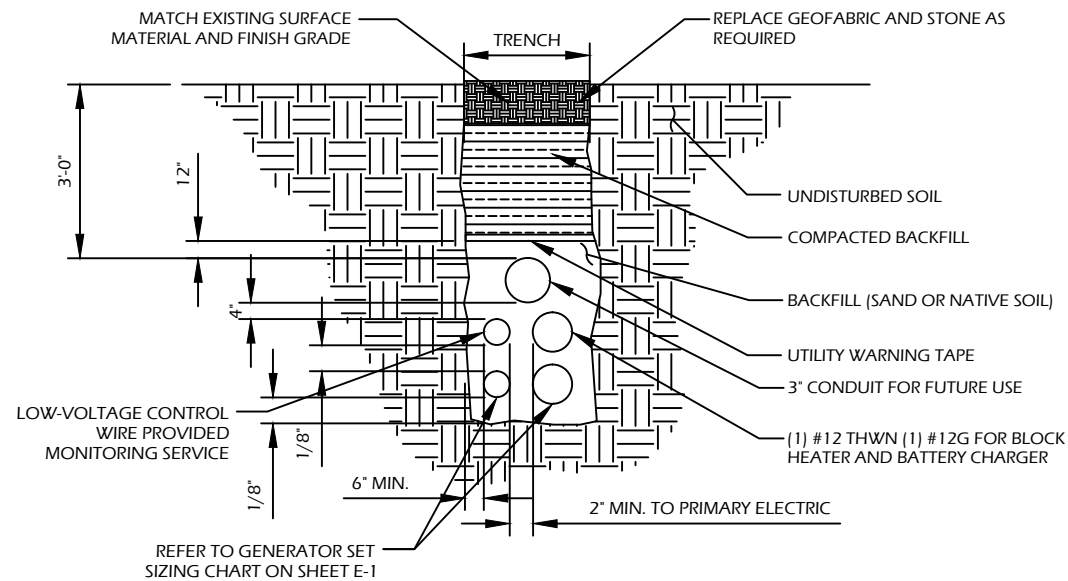


2 TRENCH DETAIL
SCALE: NOT TO SCALE

- NOTES:
- 1) GENERATOR TO BE CONNECTED TO EXISTING GROUNDING RING (MIN 1 LOCATION).
 - 2) ALL EXISTING FENCE POST/EQUIPMENT WITHIN 6' OF PROPOSED EQUIPMENT IS TO BE GROUNDED TO EXISTING GROUNDING RING. (CADWELD CONNECTIONS)
 - 3) GENERATOR SYSTEM SHALL BE SOLIDLY GROUNDED PER NEC 250.20.
- CONNECT GROUNDING ELECTRODE FROM GENERATOR FRAME TO PROPOSED GROUND ROD.

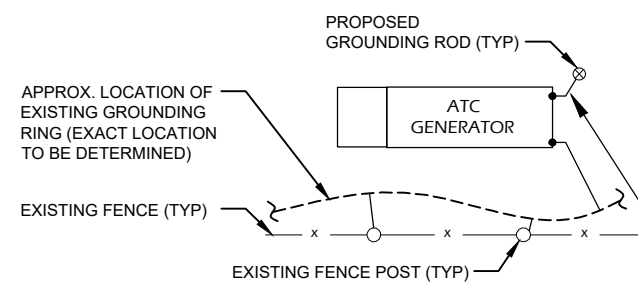


5 GENERATOR GROUND RING DETAIL

- NOTES:
1. ELECTRICIAN SHALL VERIFY THAT GENERATOR IS INSTALLED SO THAT ELECTRICAL BACK-FEEDS ARE NOT POSSIBLE.
 2. ELECTRICIAN SHALL VERIFY THAT GROUNDING IS INSTALLED SO THAT NO CIRCULATING CURRENTS ARE POSSIBLE BY FOLLOWING DETAIL 3 SO GROUNDING IS CONNECTED TO EXISTING TOWER GROUND FIELD.
 3. ALL LIGHTNING GROUNDING SHALL BE FREE OF KINKS AND SHALL HAVE LONG RADIUS BENDS (MINIMUM 8").
 4. ALL GROUNDING SHOULD BE INSTALLED PER CURRENT NEC, SECTION 250.
 5. USE #2 AWG SOLID TINNED COPPER WIRE TO EXISTING (2) FENCE POSTS AND CADWELD FROM GENERATOR GROUND RING

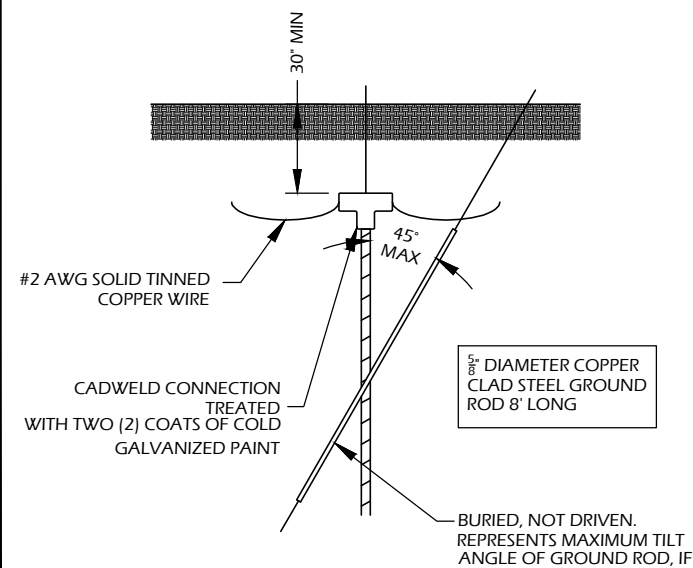

4 GROUND ROD DETAIL

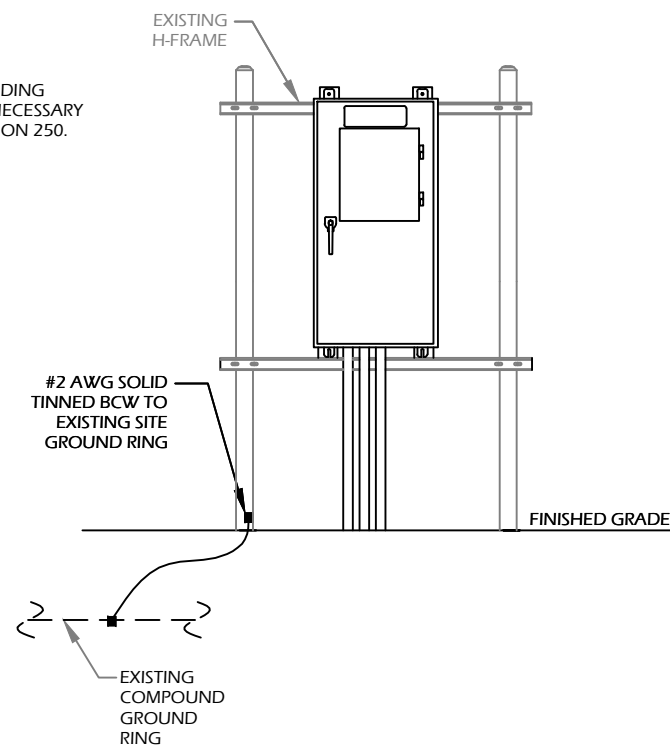

3 H-FRAME ELEVATION

NOTES:

1. CONTRACTOR TO HAND DIG ALL NEW TRENCHES INSIDE COMPOUND.
2. SEPARATION DIMENSION TO BE VERIFIED WITH LOCAL UTILITY COMPANY REQUIREMENTS.

ADVANCED
ENGINEERING GROUP, P.C.
Civil Engineering - Site Development
Surveying - Telecommunications
500 NORTH BROADWAY
EAST PROVIDENCE, RI 02914
PH: 401-354-2403 FAX:
401-633-6354

TRM
Convergent Network Solutions
TOWER RESOURCE MANAGEMENT
16 CHESTNUT STREET, SUITE 220
FOXBORO, MA 02035
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at&t
550 COCHITUATE ROAD, SUITE 13 & 14
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SITE NUMBER:

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SITE NAME:

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DRAWN BY:	JTG
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DATE DRAWN:	11-26-13
JOB NO:	10070913

SHEET TITLE:
GROUNDING
DETAILS

SHEET NUMBER:	REV. #
G-1	1



STATE OF CONNECTICUT

CONNECTICUT SITING COUNCIL

Ten Franklin Square, New Britain, CT 06051

Phone: (860) 827-2935 Fax: (860) 827-2950

E-Mail: siting.council@ct.gov

www.ct.gov/csc

November 3, 2015

Daniel M. Laub, Esq.
Cuddy & Feder LLP
445 Hamilton Avenue, 14th Floor
White Plains, NY 10601

RE: Request for Extension of Time for Construction for Previously Approved Exempt Modifications. Fixed Generator Deployments.

Dear Attorney Laub:

The Connecticut Siting Council (Council) is in receipt of the request from New Cingular Wireless, PCS, LLC (AT&T) for an extension of construction time for the attached exempt modifications requesting fixed generator deployments, dated October 29, 2015. Pursuant to the Council's decision letters for the attached list of previously approved exempt modifications, I have considered your request for an extension of construction time for these exempt modifications and grant an extension of time until June 30, 2016, to complete the construction of these projects.

This extension is granted with the understanding that the Council will be notified should New Cingular Wireless PCS, LLC (AT&T) decide not to proceed with construction of any of the exempt modifications on the attached list.

Sincerely,

Melanie A. Bachman
Acting Executive Director

MAB/cm

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EM-AT&T-039-140203	35 Old Route 44	Eastford
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EM-AT&T-164-131216	50 Pine Lane	Windsor
EM-AT&T-167-140227	1116 Johnson Road	Woodbridge
EM-AT&T-168-140127	103 Great Hollow Road	Woodbury
EM-AT&T-168-140203	478 Good Hill Road	Woodbury
EM-AT&T-169-140109	215 Coatney Hill Road	Woodstock

October 29, 2015

VIA EMAIL & FIRST CLASS MAIL

Melanie Bachman, Esq.
Executive Director
Connecticut Siting Council
10 Franklin Square
New Britain, CT 06051


Re: New Cingular Wireless PCS, LLC (AT&T)
Exempt Modification Approvals
Extension Request

Dear Executive Director Bachman:

We are writing on behalf of our client, New Cingular Wireless PCS, LLC ("AT&T"), to request another one-year extension of various exempt modification acknowledgements (EM's) issued by the Siting Council in response to AT&T filings during the period of December 2013 through March 2014, which were previously extended to December 31, 2015. These filings all relate to fixed generator deployments by AT&T at tower sites in Connecticut which have largely been deferred until 2016. The list of EM sites is the attachment to your letter dated November 20, 2014. Accordingly, we respectfully request that all of the EM's listed be extended for one-year to the end of 2016.

Thank you in advance for your consideration of this request.

Very truly yours,

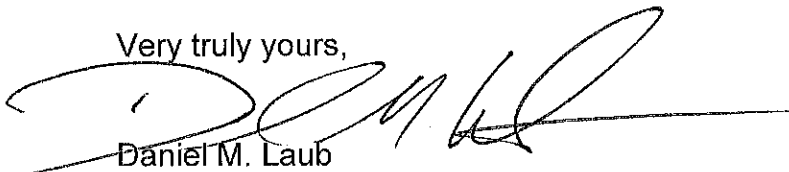

Daniel M. Laub

Enclosures

cc: Michele Briggs, AT&T
Richard Detch, AT&T



STATE OF CONNECTICUT
CONNECTICUT SITING COUNCIL

Ten Franklin Square, New Britain, CT 06051

Phone: (860) 827-2935 Fax: (860) 827-2950

E-Mail: siting.council@ct.gov

www.ct.gov/csc

November 20, 2014

Christopher B. Fisher, Esq.
Cuddy & Feder LLP
445 Hamilton Avenue, 14th Floor
White Plains, NY 10601

RE: **Request for Extension of Time for Construction for Previously Approved Exempt Modifications. Fixed Generator Deployments.**

Dear Attorney Fisher:

The Connecticut Siting Council (Council) is in receipt of the request from New Cingular Wireless, PCS, LLC (AT&T) for an extension of construction time for the attached exempt modifications requesting fixed generator deployments, dated November 18, 2014. Pursuant to the Council's decision letters for the attached list of previously approved exempt modifications, I have considered your request for an extension of construction time for these exempt modifications and grant an extension of time until December 31, 2015, to complete the construction of these projects.

This extension is granted with the understanding that the Council will be notified should New Cingular Wireless PCS, LLC (AT&T) decide not to proceed with construction of any of the exempt modifications on the attached list.

Sincerely,

Melanie A. Bachman
Acting Executive Director

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CUDDY & FEDER^{LLP}

445 Hamilton Avenue, 14th Floor
White Plains, New York 10601
Tel 914.761.1300 Fax 914.761.5372
www.cuddyfeder.com

November 18, 2014

VIA EMAIL & FIRST CLASS MAIL

Melanie Bachman, Esq.
Executive Director
Connecticut Siting Council
10 Franklin Square
New Britain, CT 06051

RECEIVED
NOV 21 2014

**CONNECTICUT
SITING COUNCIL**

Re: New Cingular Wireless PCS, LLC (AT&T)
Exempt Modification Approvals
Extension Request


ORIGINAL

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Thank you in advance for your consideration of this request.

Very truly yours,


Christopher B. Fisher
Enclosures

cc: Michele Briggs, AT&T
Richard Detch, AT&T
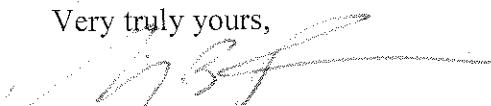
<u>Address</u>	<u>City</u>	<u>CSC Zoning Submit</u>	<u>CSC Zoning Approved</u>	<u>EM#</u>
CHESTNUT HILL ROAD	COLCHESTER	1/23/2014	2/18/2014	028-140127
213 HIGH STREET	PORTLAND	12/6/2013	12/27/2013	113-131209
130 VERNON ROAD	BOLTON	12/17/2013	1/10/2014	012-131223
145 MANOR ROAD	GUILFORD	2/26/2014	3/24/2014	060-140303
525 PLAINS ROAD	HADDAM	1/28/2014	2/18/2014	061-140131
719 AMITY ROAD	BETHANY	1/28/2014	2/19/2014	008-140131
10 MAIN STREET	ESSEX	1/31/2014	2/21/2014	050-140203
290 PRESTON AVENUE	MIDDLETOWN	1/8/2014	2/6/2014	083-140114
47 MAIN STREET	TALCOTTVILLE	1/31/2014	2/21/2014	146-140203
99 CEDARWOOD LANE	NEWINGTON	1/23/2014	2/19/2014	094-140127
57 COOK DRIVE	UNCASVILLE	2/6/2014	3/4/2014	086-140210
28 BREWER DRIVE (CEMETARY)	BLOOMFIELD	2/24/2014	3/19/2014	011-140227
525 ORANGE CENTER ROAD	ORANGE	2/27/2014	3/21/2014	107-140303
90 INDUSTRIAL PARK ROAD	MIDDLETOWN	1/29/2014	2/24/2014	083-140203
60 ADAMS STREET	MANCHESTER	1/14/2014	2/7/2014	077-140117
1021 STRAITS TURNPIKE	MIDDLEBURY	1/23/2014	2/18/2014	081-140127
FFYLER ROAD	SUFFIELD	12/27/2013	1/22/2014	139-131230
482 PIGEON HILL ROAD	WINDSOR	12/19/2013	1/2/2014	164-131213
GRIST MILL ROAD	SIMSBURY	12/11/2013	1/2/2014	128-131213
36 JANOSKI ROAD	ASHFORD	1/23/2014	2/18/2014	003-140127
1967 SAYBROOK ROAD	MIDDLETOWN	2/4/2014	2/24/2014	083-140207
300 PLAIN HILL ROAD	NORWICH	2/25/2014	3/21/2014	104-140303
127 NEW HARTFORD ROAD	BARKHAMSTED	1/28/2014	2/18/2014	005-140131
338 OXFORD ROAD	OXFORD	2/3/2014	2/24/2014	108-140206
104 BUNKER HILL ROAD	ANDOVER	1/28/2014	2/18/2014	001-140131
151 SAND HILL ROAD DUP 1	SOUTH WINDSOR	12/27/2013	1/23/2014	132-131230
BURR MOUNTAIN ROAD	TORRINGTON	1/14/2014	2/7/2014	143-140117
154 SAYLE AVENUE	PUTNAM	12/6/2013	12/27/2013	116-131209
307 INDIAN PARK LEDGE ROAD	TRUMBULL	2/6/2014	3/4/2014	144-140210
1116 JOHNSON ROAD	WOODBIDGE	2/24/2014	3/19/2014	167-140227
94 EAST HIGH STREET	EAST HAMPTON	2/4/2014	2/21/2014	042-140207
400 RILEY MOUNTAIN ROAD	COVENTRY	12/30/2013	1/23/2014	032-140102
103 GREAT HOLLOW ROAD	WOODBURY	1/23/2014	2/18/2014	168-140127
719 GEORGE WASHINGTON TUR	BURLINGTON	1/8/2014	2/6/2014	020-140114
175 SOUTH MAIN STREET	MARLBOROUGH	12/6/2013	12/27/2013	079-131209
1825 SOUTH MAIN STREET	MIDDLETOWN	12/13/2013	1/6/2014	083-131216
123 COSTELLO ROAD	NEWINGTON	12/13/2013	1/6/2014	094-131216
1925 EAST MAIN STREET	TORRINGTON	1/27/2014	2/18/2014	143-140130
50 PINE LANE	WINDSOR	12/13/2013	1/6/2014	164-131216
46 MEADOW ROAD	CLINTON	12/9/2013	2/24/2014	027-131213
856 MIDDLETOWN ROAD	COLCHESTER	2/27/2014	3/21/2014	028-140303
62 BABBITT HILL ROAD	POMFRET	1/8/2014	2/7/2014	112-140114
577 BELL STREET	GLASTONBURY	1/23/2014	2/18/2014	054-140127
215 COATNEY HILL ROAD	WOODSTOCK	1/6/2014	2/7/2014	169-140109
10 NORTH RIDGE DRIVE	WINDHAM	12/6/2013	12/27/2013	163-131209
142 FITTS ROAD	ASHFORD	12/6/2013	12/27/2013	003-131209B
60 RICE LANE	BEACON FALLS	1/14/2014	2/7/2014	006-140117
49 SOUTH ROAD	BOLTON	1/28/2014	2/19/2014	012-140131
47 INWOOD ROAD	ROCKY HILL	12/27/2013	1/22/2014	119-131230
10 PENT ROAD	DEEP RIVER	1/23/2014	2/19/2014	036-140127
130 BIRDSEYE ROAD	FARMINGTON	12/6/2013	12/27/2013	052-131209
2577 MAIN STREET	GLASTONBURY	12/27/2013	1/22/2014	054-131230
36 RITCH AVENUE WEST	GREENWICH	1/27/2014	2/18/2014	057-140130

181 A NORMAN ROAD	JEWETT CITY	2/19/2014	3/19/2014	058-140224
107 BUCK ROAD	HEBRON	12/27/2013	1/23/2014	067-131230
79 PUTnam PIKE	DAYVILLE	1/9/2014	2/6/2014	069-140114
43 CONNECTICUT MILLS ROAD	DANIELSON	1/24/2014	2/19/2014	069-140127
450-478 WEST MAIN STREET	MERIDEN	2/7/2014	3/4/2014	080-140210
393 JACKSON HILL ROAD	MIDDLEFIELD	12/30/2013	1/23/2014	082-140102
484 MERIDEN ROAD	MIDDLEFIELD	12/9/2013	1/2/2014	082-131213
1428 MONROE TURNPIKE	MONROE	1/16/2014	2/7/2014	085-140121
108 FOXON ROAD	NORTH BRANFORD	1/23/2014	2/19/2014	099-140127
ONE HARTFORD SQUARE	NEW BRITAIN	1/16/2014	1/22/2014	089-140121
130 BALD HILL ROAD	TOLLAND	1/23/2014	2/19/2014	142-140127
60 INDUSTRIAL PARK ROAD	VERNON ROCKVILLE	1/8/2014	2/10/2014	146-140114
478 GOOD HILL ROAD	WOODBURY	1/29/2014	2/21/2014	168-140203
491 SOUTH QUAKER LANE	WEST HARTFORD	1/28/2014	2/18/2014	155-140131
99 KNOWLTON HILL ROAD	ASHFORD	12/6/2013	12/27/2013	003-131209A
12 NEPAUG ROAD	BURLINGTON	1/29/2014	2/24/2014	020-140203
66 WALL STREET	HEBRON	1/2/2014	1/28/2014	067-140106
188 MOODY ROAD	ENFIELD	1/9/2014	2/7/2014	049-140114
3 EDMOND ROAD	NEWTOWN	1/16/2014	2/7/2014	097-140121
200 STANLEY STREET	NEW BRITAIN	12/5/2013	12/20/2013	089-131205A
178 LESTER STREET	NEW BRITAIN	12/5/2013	12/27/2013	089-131205B
370 ROCKLAND ROAD	GUILFORD	1/23/2014	2/19/2014	060-140127
6 PROGRESS AVENUE	SEYMOUR	1/29/2014	2/24/2014	124-140203
277 HUCKLEBERRY HILL ROAD	AVON	12/27/2013	1/23/2014	004-131230
350 HARTLAND BOULEVARD	EAST HARTLAND	2/26/2014	3/24/2014	065-140303
22 WAYSIDE LANE	REDDING	2/26/2014	3/24/2014	117-140303
285 CHAMBERLAIN HILL ROAD	HADDAM	12/6/2013	2/24/2014	061-131209
382 COLEBROOK RIVER ROAD	COLEBROOK	1/16/2014	2/7/2014	029-140121
157 CHESTNUT MOUNTAIN ROAD	STAFFORD SPRINGS	1/7/2014	2/7/2014	134-140110
35 OLD ROUTE 44	EASTFORD	1/29/2014	2/24/2014	039-140203
699 OLD MAIN STREET	ROCKY HILL	2/6/2014	2/28/2014	119-140210