October 18, 2018

Connecticut Siting Counsel 10 Franklin Square New Britain, CT 06051

RE: **DOCKET NO. 480** – SectorSite LLC Certificate of Environmental Compatibility and Public Need for the construction, maintenance, and operation of a telecommunications facility on town-owned property behind the Southwest Fire Station located at 2 Westwoods Drive, Farmington, Connecticut. Development and Management Plan.

Dear Ms. Bachman:

Please find below SectorSite's responses to the interrogatories and referenced documents attached. Also, enclosed are 15 copies, an original and a copy will be sent via electronic mail.

1. CSC question/comment: Indicate what Town of Farmington officials received a copy of the D&M Plan.

Response: Town of Farmington Clerk and William Warner, Town Planner

2. CSC question/comment: D&M Plan Sheet C-4 depicts 4 FAA required floodlights within the compound. Provide specifications of the FAA lighting, light mounts, placement of power wiring and emergency backup power source.

Response: Updated drawings attached.

3. CSC question/comment: Provide procedures for notifying the FAA of the presence of an unlit structure in the event the FAA lighting emergency power systems fails or runs out of fuel.

Response: SectorSite will follow the FAA Light Outage Reporting requirements. Ass required in the attached. As such, any failure or malfunction that lasts more than thirty (30) minutes and affects a top light or flashing obstruction light, regardless of its position, will be reported immediately to (877) 487-6867 so a Notice to Airmen. (NOTAM) can be issued. Start of Activity/End of Validity will be provided to the same number when reporting. As soon as the normal operation is restored, notification will be sent.

4. CSC question/comment: Provide specifications of the flag to be installed on the facility.

Response: Specifications attached

CSC question/comment: Indicate what entity is responsible for the daily maintenance of the flag, and replacement of the flag, when necessary.

Response: Town of Farmington is responsible for the daily maintenance of the flag and SectorSite is responsible for replacement of the flag when necessary.

5. CSC question/comment: Provide specifications/fuel source of the proposed "community generator".

Response: Specifications attached

CSC question: Is the community generator intended to be a shared emergency generator for future

carriers? *Response: Yes*

CSC questions: What is the anticipated run time before refueling, assuming two carriers were using the community generator?

Response: Run time for the generator is approximately 121 hours.

6. CSC question: What is the composition (e.g. grass-lined, rip rap, fiber blankets) of the proposed swales?

Response: The proposed Swales will be Grass-Lined

7. CSC question: Is any landscaping proposed?

Response: Landscape is not proposed. The site is located within a cornfield and the property will continue to be used for farming while the tower is constructed and operating.

8. CSC question: When does SectorSite intend to have the flagpole and compound fully constructed?

Response: SectorSite will commence construction within 2 weeks from receipt of all required permits and approval. The estimated completion of the flagpole and compound is 45-60 days from start of construction.

CSC question: When does T-Mobile intend to locate on the facility?

Response: T-Mobile will be installing their equipment upon construction completion of the proposed tower.

Question: What entity would install T-Mobile's ground equipment and antennas?

Response: T-Mobile does not have any specific contractor under contract to perform the installation of their antennas and ground equipment. Upon approval of the proposed tower, T-Mobile will pursue competitive bids from experienced industry general contractors and award according to costs, experience and crew availability.

Please contact me should you have any questions or comments.

Very truly yours,

Lynn Toomey Dir. Real Estate 908-4560-485





PO Box 118, Convent Station, NJ 07961
Office (973) 543-0611 • Fax (973) 543-7232
www.SectorSiteLLCROPORD
RECEIVED FOR RECEIVED FOR MINISTRY CLERK
FARMINGTON TOWN CLERK

2011 SEP 25 AM 9: 39

September 24, 2018

Town of Farmington Town Clerk One Monteith Drive Farmington, CT 06032

Re: Docket 480 Development and Management Plan submission in compliance with Sections 16-50j-75 through 16-50j-77 of the Regulations of Connecticut State Agencies

To Whom It May Concern:

For your review, enclosed are the following documents submitted to Connecticut Siting Counsel prepared for the Development and Management Plan (D & M Plan):

- 1. One full sized sets of drawings.
- 2. Geotechnical Report
- 3. Tower and foundation design

The site work shall start after SectorSite receives Siting Council approval of the D&M Plan. The work shall be performed during the hours of 8 am to 5 pm, Monday through Saturday.

In Andover, MA OTES

The supervisor of the site work will be:

Scott Murdoch
Director of Construction
SectorSite, LLC
(732) 232-4083
Smurdoch@sectorsite.com

Please contact me should you have any questions or comments.

Very truly yours,

Lyon Toomey Dir. Real Estate 908-456-0485

Cc: Town of Farmington

PROJECT SUMMARY SCOPE OF WORK: SectorSite, LLC. IS PROPOSING TO INSTALL THE 130' FLAGPOLE 48'x48' FENCED COMPOUND POWER. AND TELCO UTILITIES T-MOBILE EQUIPMENT CABINET & COMMUNITY GENERATOR ON (2) CONCRETE PADS (6) T-MOBILE ANTENNAS, WITH ASSOCIATED CABLING AND APPURTENANCES INSIDE THE FLAGPOLE. SITE ADDRESS: 2 WESTWOODS DRIVE FARMINGTON, CT 06032 LATITUDE: LONGITUDE: 41° 42' 37.40" N 72° 52' 54.90" W 41.710389 N PROPERTY OWNER: TOWN OF FARMINGTON 1 MONTEITH DRIVE FARMINGTON, CT 06032 TAX MAP#: POWER COMPANY: EVERSOURCE FRONTIER COMMUNICATIONS TELEPHONE COMPANY: TOWER OWNER/APPLICANT: SectorSite, LLC CONVENT STATION, NJ 07961 CO APPLICANT: 35 GRIFFIN ROAD SOUTH BLOOMFIELD, CT 06002 DOUG ROBERTS, AIA. HUDSON DESIGN GROUP, LLC. PROJECT ENGINEERING: 45 BEECHWOOD DRIVE NORTH ANDOVER, CT 01845 GENERAL NOTES:

- THIS DOCUMENT IS THE CREATION, DESIGN, PROPERTY AND COPYRIGHTED WORK OF SectorSite, LLC. ANY DUPLICATION OR USE WITHOUT EXPRESS WRITTEN CONSENT IS STRICTLY PROHIBITED. DUPLICATION AND USE BY GOVERNMENT AGENCIES FOR THE PURPOSES OF CONDUCTING THEIR LAWFULLY AUTHORIZED REGULATORY AND ADMINISTRATIVE FUNCTIONS IS SPECIFICALLY ALLOWED.
- THE FACILITY IS AN UNMANNED PRIVATE AND SECURED EQUIPMENT INSTALLATION. IT IS ONLY ACCESSED BY TRAINED TECHNICIANS FOR PERIODIC ROUTINE MAINTENANCE AND THEREFORE DOES NOT REQUIRE ANY WATER OR SANITARY SEWER SERVICE. THE FACILITY IS NOT GOVERNED BY REGULATIONS REQUIRING PUBLIC ACCESS PER ADA REQUIREMENTS.

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SECTOR SITE SITE AQUISITION

SECTOR SITE SITE AQUISITION

ATTORNEY

OTHER




T·-Mobile


SITE NUMBER: CT-119

SITE NAME: FARMINGTON SOUTHWEST FIRE DEPT. **DEVELOPMENT & MANAGEMENT PLAN - DOCKET NO.480**

WORK WILL BE PERFORMED MONDAY THRU SATURDAY, FROM 8AM TO 5PM

T-MOBILE SITE ID: CTHA112A

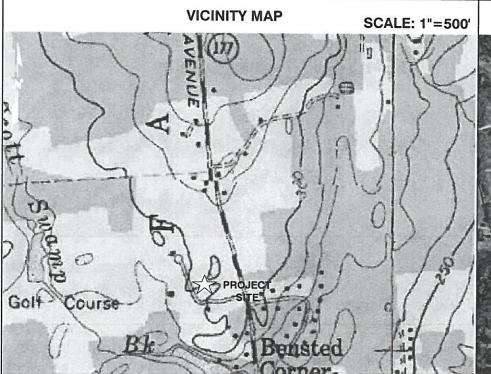

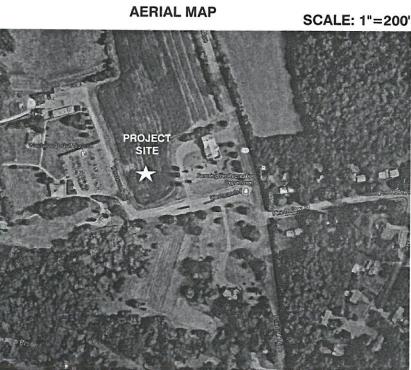

州 SECTORSITE

SectorSite, LLC. 53 SOUTH JEFFERSON ROAD, SUITE M. WHIPPANY, NJ 07981





CHECKED BY:

APPROVED BY: DPH

DJR

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	REV.	DATE	DESCRIPTION	BY				
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	3	10/17/18	REVISED PER COMMENTS	KAM				
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FARMINGTON SOUTHWEST FIRE DEPT. SITE NUMBER CT-119


T-MOBILE SITE ID: CTHA112A

SITE ADDRESS: 2 WESTWOODS DRIVE FARMINGTON, CT 06032

SHEET TITLE

TITLE SHEET

| -

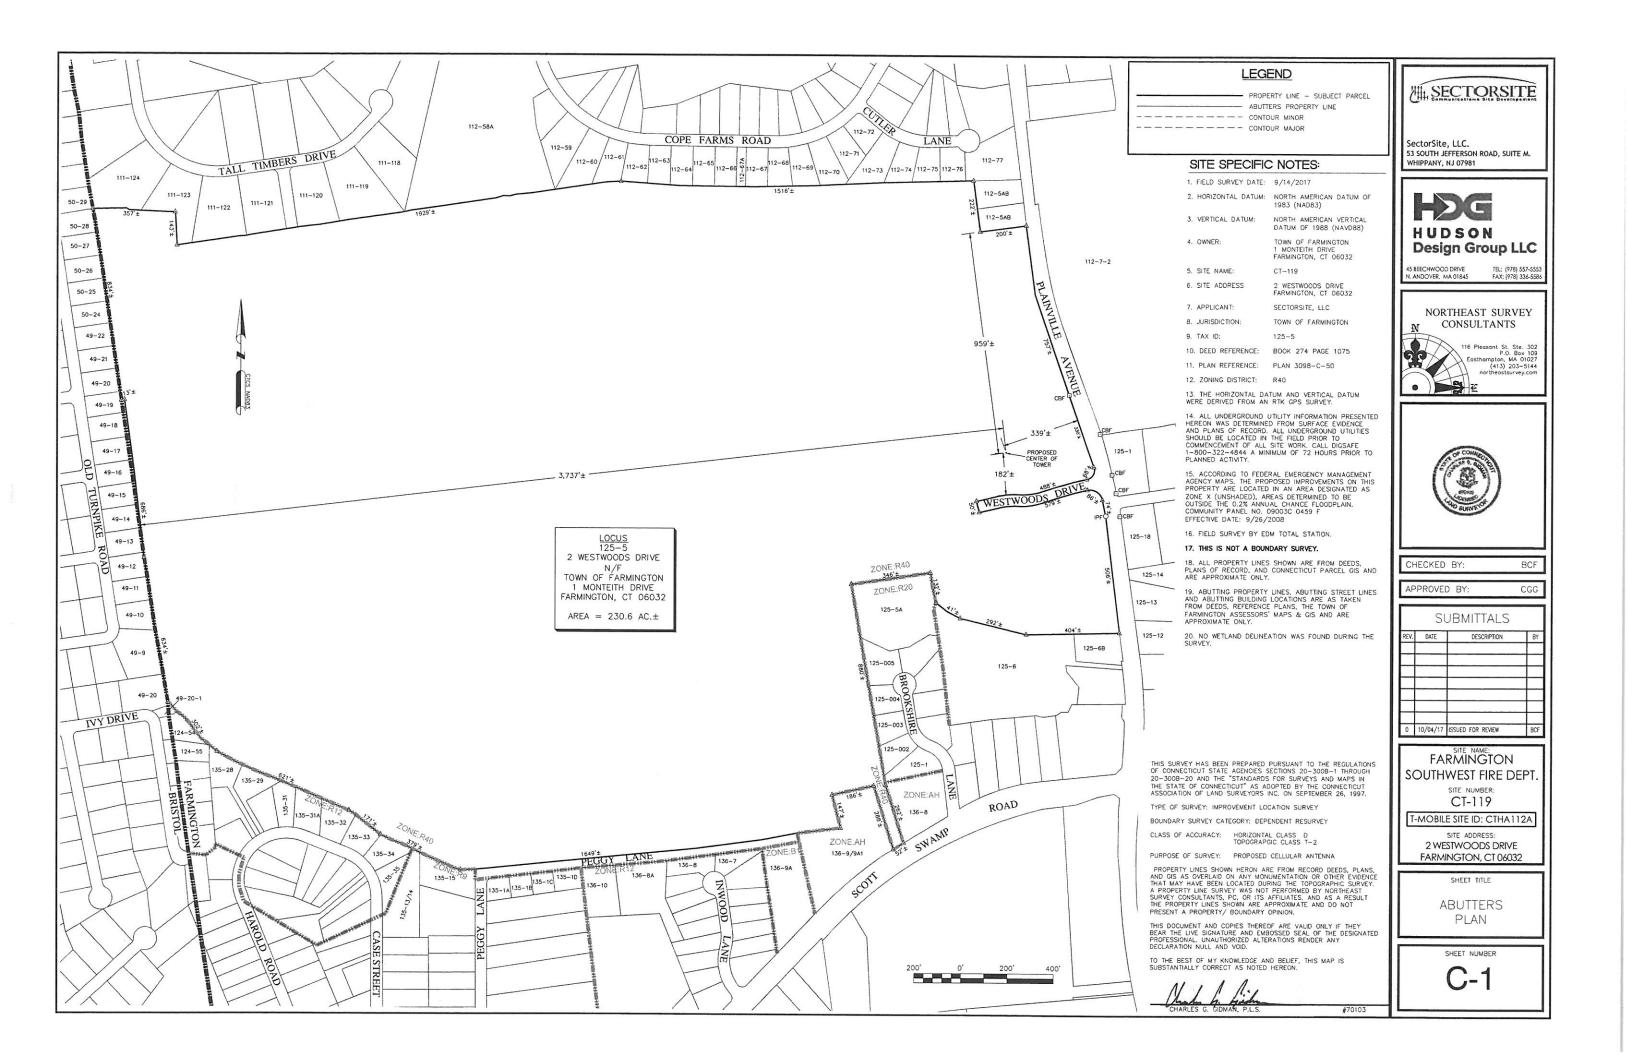

BRISTOL ABUTTER PARCELS

50-25 148 OLD TURNPIKE RD GRASSO, GERARD F & JAYNE 148 OLD TURNPIKE RD BRISTOL, CT 06010

50-26 158 OLD TURNPIKE RD COTE, PAUL F & SANDRA J 158 OLD TURNPIKE RD

BRISTOL CT 06010

50-27 168 OLD TURNPIKE RD CLEMENT, JOYCE 168 OLD TURNPIKE RD BRISTOL, CT 06010

GOULET, ALLAN & AMY

188 OLD TURNPIKE RD

LLOYD, ROYCE W & CLAUDETTE A 188 OLD TURNPIKE RD BRISTOL, CT 06010

49-9
2 OLD TURNPIKE RD
PAWELCZYK, GEORGE T & JUDITH L
2 OLD TURNPIKE RD
BRISTOL, CT 06010

49-10 6 OLD TURNPIKE RD CARLSON, GARY R & MARIANNE E 6 OLD TURNPIKE RD BRISTOL, CT 06010

49-11
16 OLD TURNPIKE RD
KANDYBOWICZ, KRYSTYNA & TADEUSZ
16 OLD TURNPIKE RD
BRISTOL, CT 06010

49-12
26 OLD TURNPIKE RD
FOX, LAURENCE J & JANICE M
26 OLD TURNPIKE RD
BRISTOL. CT 06010

49-13
36 OLD TURNPIKE RD
RONDEAU, KENNTH A II & CAROL E
36 OLD TURNPIKE RD
BRISTOL, CT 06010

49-14
46 OLD TURNPIKE RD
DIMATTIA, ULDERICO & ROSINA I
46 OLD TURNPIKE RD
BRISTOL, CT 06010

49-15 58 OLD TURNPIKE RD DOBRYNSKI, JOAN L ESTATE OF 174 RED OAK HILL RD FARMINGTON, CT 06032

49–16 68 OLD TURNPIKE RD ADORNO, SEBASTIAN & JENNIFER A 68 OLD TURNPIKE RD BRISTOL, CT 06010

49-17 78 OLD TURNPIKE RD BURKE, SEAN & JESSICA V 78 OLD TURNPIKE RD BRISTOL, CT 06010

49-18 88 OLD TURNPIKE RD LEVINS, JAMES R & ROCHELLE O 88 OLD TURNPIKE RD BRISTOL, CT 06010

49-19
98 OLD TURNPIKE RD
DEMAREST, JEFFREY S & JESSICA M
98 OLD TURNPIKE RD
BRISTOL, CT 06010

49-20 108 OLD TURNPIKE RD BRUNI, THOMAS J 108 OLD TURNPIKE RD BRISTOL, CT 06010

49-20 327 IVY DR LOWREY, JAMES J & LESLIE R 327 IVY DR BRISTOL, CT 06010

49-20-1 IVY DR BRISTOL, CITY OF 111 NORTH MAIN ST BRISTOL, CT 0601

49-21 118 OLD TURNPIKE RD WASHBURN, GORDON W & TEXIE, ANN L U 118 OLD TURNPIKE RD BRISTOL, CT 06010

49-22 128 OLD TURNPIKE RD GENEST, MARC 128 OLD TURNPIKE RD BRISTOL, CT 06010

50-24 138 OLD TURNPIKE RD GRADY, LAURIE H & PETER M 138 OLD TURNPIKE RD BRISTOL, CT 06010

FARMINGTON ABUTTER PARCELS

111-58A 8138 COPE FARMS RD FARMINGTON TOWN OF 1 MONTEITH DR FARMINGTON, CT 06032

111-59 49 COPE FARMS RD WALLACE, JUDY R. 49 COPE FARMS RD FARMINGTON, CT 060.

111-118
56 TALL TIMBERS DR
DOYON FAMILY LIVING TRUST
56 TALL TIMBERS DR
FARMINGTON, CT 06032

111–119 52 TALL TIMBERS DR HAYHURST, WILLIAREM 52 TALL TIMBERS DR FARMINGTON, CT 06032

111-120 48 TALL TIMBERS DR TOMLINSON, DOUGLAS W & PATRICIA A 48 TALL TIMBERS DR FARMINGTON, CT 06032

111—121 44 TALL TIMBERS DR DADDARIO, SUSAN T 44 TALL TIMBERS DR FARMINGTON, CT 06032

111-122 40 TALL TIMBERS DR GILL, CAROL A 40 TALL TIMBERS DR FARMINGTON, CT 06032

111-123 36-TALL TIMBERS DR BLUM, MICHAEL C 36-TALL TIMBERS DR FARMINGTON, CT 06032

111-124
32 TALL TIMBERS DR
ARLAUSKAS, JOHN A &
694 LNKE SCENE DR
VENICE, FL 34293

112-5AB 740 PLAINVILLE AVE SCB HOLDINGS LLC 70 SANFORD AVE UNIONVILLE, CT 06085

112-7-2 9364 PLAINVILLE AVE FARMINGTON TOWN OF 1 MONTEITH DR FARMINGTON, CT 06032

112-7/8A 741 PLAINVILLE AVE KRELL, PATRICIA A 397 MEADOW RD FARMINGTON, CT 06032

112-60 47 COPE FARMS RD PRICE, DAVID K 47 COPE FARMS RD FARMINGTON, CT 06032

112-61 45 COPE FARMS RD SILVA, ARMENIO & JOAQUINA 45 COPE FARMS RD FARMINGTON, CT 06032

112-62 43 COPE FARMS RD STIERER, JACK G & 43 COPE FARMS RD FARMINGTON, CT 06032

112-63 41 COPE FARMS RD KU, WENDY 41 COPE FARMS RD FARMINGTON, CT 06032

112-64 39 COPE FARMS RD SIMONEAU, PAUL J & JOANNE M 1250 MORSE BLVD SINGER ISLNND FL 33404 112-65 37 COPE FARMS RD BYER, JANET I 37 COPE FARMS DR FARMINGTON, CT 06032

112-66 35 COPE FARMS RD FEEHAN, KEVIN T 35 COPE FARMS RD FARMINGTON, CT 06032

112-67 33 COPE FARMS RD DALY, GERALD E & 33 COPE FARMS RD FARMINGTON, CT 06032

112-67A 8139 COPE FARMS RD FARMINGTON, TOWN OF 1 MONTEITH DR FARMINGTON, CT 06032

112-68
31 COPE FARMS RD
TIWARI DHIRENDRA, KUMAR & ANUJA
31 COPE FARMS RD
FARMINGTON CT 06032

112-69 29 COPE FARMS RD BERLINSKI, EDWARD J 29 COPE FARMS RD FARMINGTON, CT 06032

112-70 27 COPE FARMS RD KIEVIT, WILLIAM F & KRISTEN P 27 COPE FARMS RD FARMINGTON, CT 06032

112-73 4 CUTLER LN GRAVES, LARRY R 4 CUTLER LN FARMINGTON, CT 06032

112-74 6 CUTLER LN FERN, BRIAN K & AUDREY M 6 CUTLER LN FARMINGTON, CT 06032

112-75 8 CUTLER LN KOZAK, TODD A & 8 CUTLER LN FARMINGTON, CT 06032

112-76 10 CUTLER LN CRUZ, ANGEL N & HELEN L 10 CUTLER LN FARMINGTON, CT 06032

112-77 12 CUTLER LN GALVIN, JOHN J JR & DONNA M 12 CUTLER LN FARMINGTON, CT 06032

124-54 339 IVY DR SUTTER, WILLIAM F III & ROSMARIE 339 IVY DR BRISTOL, CT 06010

124-55 349 IVY DR MCCABE, KELLY W & LEA L 349 IVY DR BRISTOL, CT 06010

125-1 2 PINE HOLLOW RD JOHNSON, KENNETH E & KIMBERLY A 2 PINE HOLLOW RD FARMINGTON, CT 06032

125-1 7 BROOKSHIRE LN FLANDERS, JESSICA M 7 BROOKSHIRE LN FARMINGTON, CT 06032

125-002 15 BROOKSHIRE LN LUTKOWSKI, ANDRZEJ M & BARBARA 15 BROOKSHIRE LN FARMINGTON, CT 06032 125-003 17 BROOKSHIRE LN PENNITO, JAMES W & LORI A 17 BROOKSHIRE LN FARMINGTON, CT 05032

125-004
23 BROOKSHIRE LN
MOLONY, RANDALL C & SHEILA L
23 BROOKSHIRE LN
FARMINGTON, CT 06032

125-005 25 BROOKSHIRE LN HOPKINSON, DAVID A 25 BROOKSHIRE LN FARMINGTON, CT 06032

125-5A 8072 BROOKSHIRE LN FARMINGTON, TOWN OF 1 MONTEITH DR FARMINGTON, CT 06032

125-6 798 PLAINVILLE AVE WETSTONE, SCOTT L & SHUSDOCK, GLORIA A 798 PLAINVILLE AVE FARMINGTON, CT 06032

125-6B 796 PLAINVILLE AVE BERRY, JOAN R & JOHN 796 PLAINVILLE AVE FARMINGTON, CT 06032

125-12 1 GREENCREST DR ORMSBY, DIANE M 1 GREENCREST DR FARMINGTON, CT 06032

125-13 3 GREENCREST DR HELM, WALTER 3 GREENCREST DR FARMINGTON, CT 06032

125-14 5 GREENCREST DR ZIEBKA, MICHAEL A & CHERYL H 5 GREENCREST DR FARMINGTON, CT 06032

125-18 1 PINE HOLLOW RD CHEN, FEI & LI HUI, LNU 1 PINE HOLLOW RD FARMINGTON, CT 06032

135-1A 66 PEGGY LN SLNTER, WILLIAM T 66 PEGGY LN FARMINGTON, CT 06032

135-1B 70 PEGGY LN SILVER, JOHN F & SHANNON L 70 PEGGY LN FARMINGTON, CT 06032

74 PEGGY LN
PELTIER, MICHAEL A & KELLY
74 PEGGY LN
FARMINGTON, CT 06032

135–1D 76 PEGGY LN MNYUKH, YURI 76 PEGGY LN FARMINGTON, CT 06032

46 CASE ST FETERA, THOMAS & KRISTIN 46 CASE ST FARMINGTON, CT 06032

135-15 61 PEGGY LN KOLODZIEJ, HIRONIM 61 PEGGY LN FARMINGTON, CT 06032

135-28 81 HAROLD RD RICHARD, ROBIN M 81 HAROLD RD FARMINGTON, CT 06032 供,SECTORSITE

SectorSite, LLC. 53 SOUTH JEFFERSON ROAD, SUITE M. WHIPPANY, NJ 07981



45 BEECHWOOD DRIVE N ANDOVER MA 01845

135-29 83 HAROLD RD

135-30 85 HAROLD RD

87 HAROLD RD

HOGERTY, JACQUELINE 83 HAROLD RD FARMINGTON, CT 06032

85 HAROLD RD MILLER, COLLEEN A & JAMES E 85 HAROLD RD FARMINGTON, CT 06032

DREZEK, TADEUSZ & TERESE 87 HAROLD RD FARMINGTON, CT 06032

135-32 93 HAROLD RD WILCZAK, RAFAL S & JUSTYNA 93 HAROLD RD FARMINGTON, CT 06032

135-33 99 HAROLD RD MULNWKA, JERZY J & ELZBIETA T

135-34 103 HAROLD RD NGUYEN, DAVID T & DIANE H LE

20 INWOOD LN MACHADO, JORGE A & TATIANA 20 INWOOD LN FARMINGTON, CT 06032

136-8 8770 SCOTT SWAMP RD ROUTE 6 WESTWOODS ASSOCIATES 6 EXECUTIVE DR FARMINGTON, CT 06032

136-9/9A1 312 SCOTT SWAMP RD ROUTE 6 WESTWOODS ASSOC LTD

22 INWOOD LN
WANG, TAO & YAN QIAOMEI
22 INWOOD LN
FARMINGTON, CT 06032

136-8A 8391 INWOOD LN FARMINGTON, TOWN OF 1 MONTEITH DR FARMINGTON, CT 06032

6 EXECUTIVE DR FARMINGTON, CT 06032

136-9A 326 SCOTT SWAMP RD

KOAPA LLC 326 SCOTT SWAMP RD FARMINGTON, CT 06032

8612 PEGGY LN NIMAN, JEFFERY 21 COBBS RD WEST HARTFORD, CT 06107

8772 SCOTT SWAMP RD STAFFORDSHIRE ASSOCIATES 365 BREWSTER R BRISTOL, CT 06010

136-47A

135-31A 8329 HAROLD RD FARMINGTON, TOWN OF 1 MONTEITH DR FARMINGTON, CT 06032

99 HAROLD RD FARMINGTON, CT 06032

103 HAROLD RD FARMINGTON, CT 06032

CERASOLI, GENNARO 105 HAROLD RD FARMINGTON, CT 06032

135-35 105 HAROLD RD N. ANDOVER, MA 01845





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FARMINGTON
SOUTHWEST FIRE DEPT.

SITE NUMBER:
CT-119


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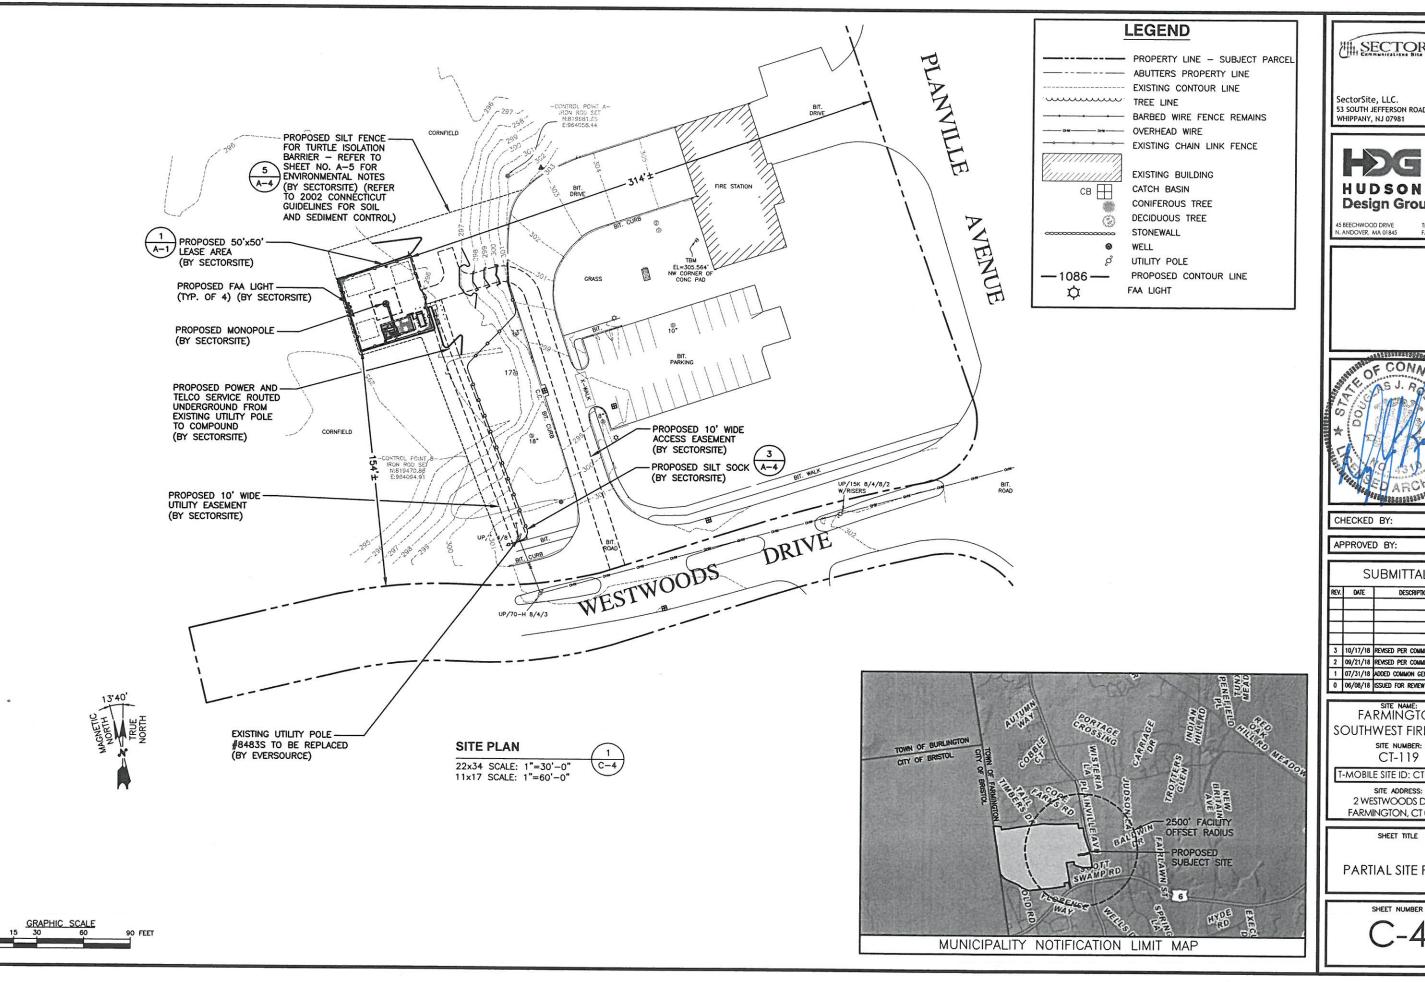
SITE ADDRESS: 2 WESTWOODS DRIVE FARMINGTON, CT 06032

SHEET TITLE
ABUTTERS
LIST

SHEET NUMBER

C-2



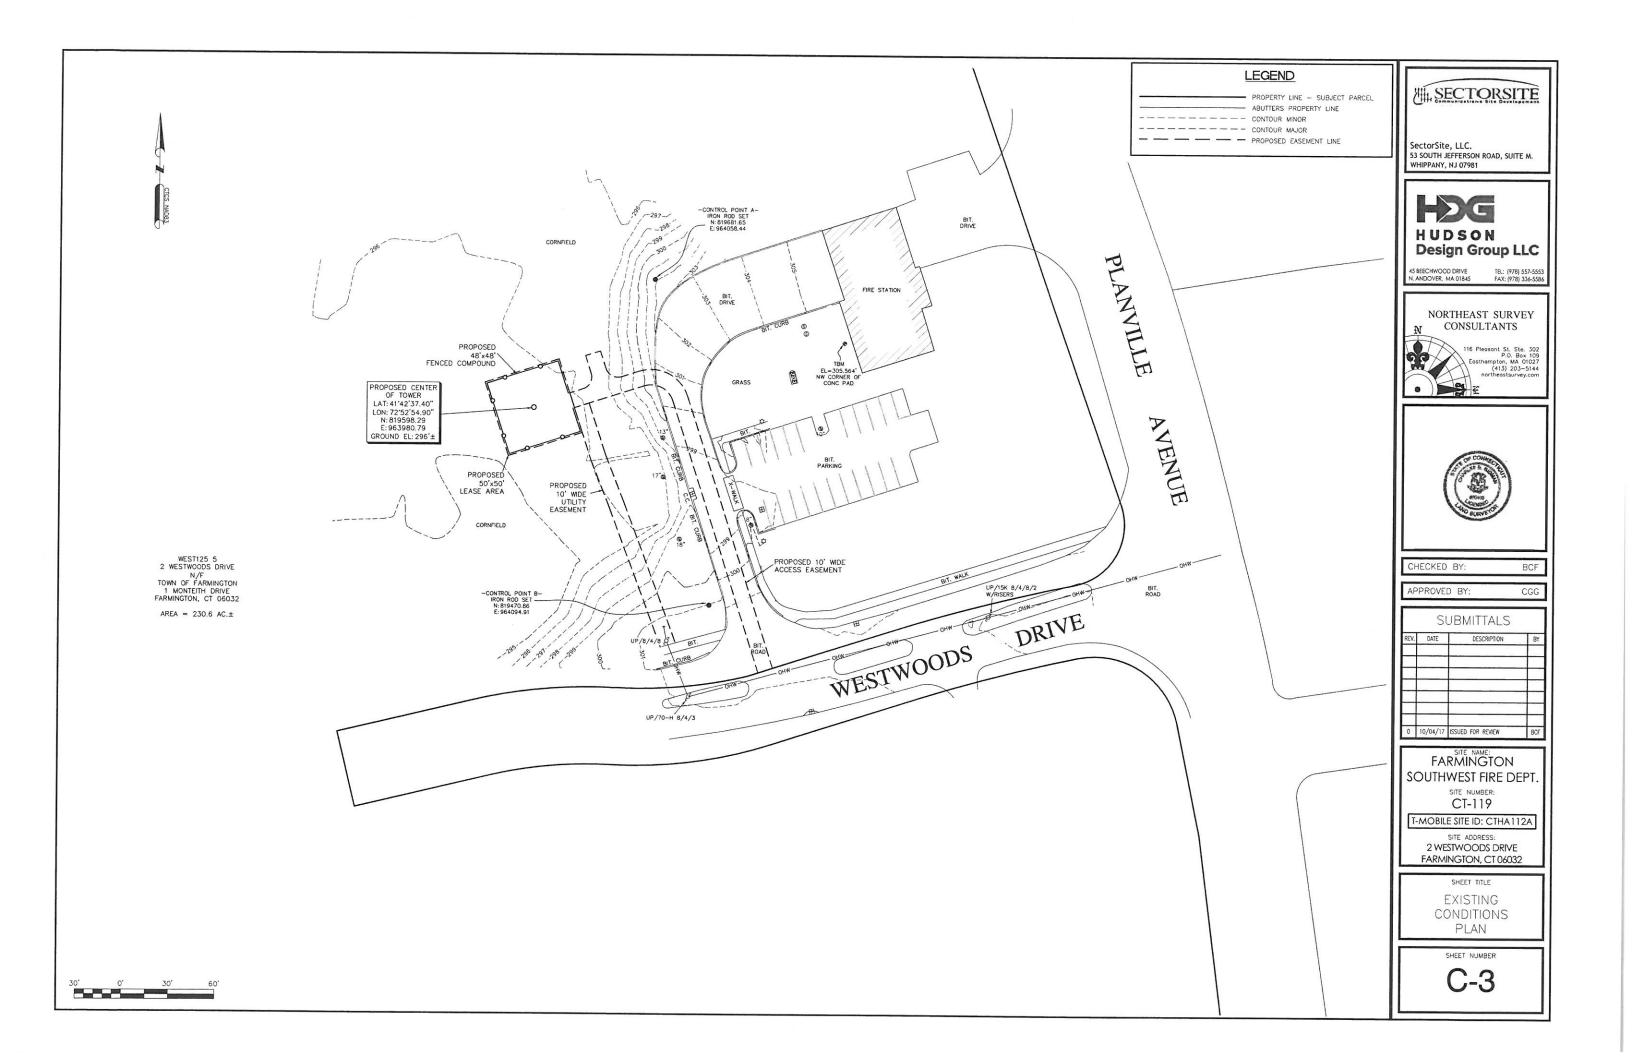

SECTORSITE

53 SOUTH JEFFERSON ROAD, SUITE M. WHIPPANY, NJ 07981



TEL: (978) 557-5553 FAX: (978) 336-5586

DJR

DPH


	SUBMITTALS					
REV.	DATE	DESCRIPTION	BY			
3	10/17/18	REVISED PER COMMENTS	KAM			
2	09/21/18	REVISED PER COMMENTS	KAM			
1	07/31/18	ADDED COMMON GENERATOR	SLY			
0	06/08/18	ISSUED FOR REVIEW	KB/KAM			


SITE NAME: FARMINGTON SOUTHWEST FIRE DEPT. SITE NUMBER:


T-MOBILE SITE ID: CTHA112A

2 WESTWOODS DRIVE FARMINGTON, CT 06032


PARTIAL SITE PLAN

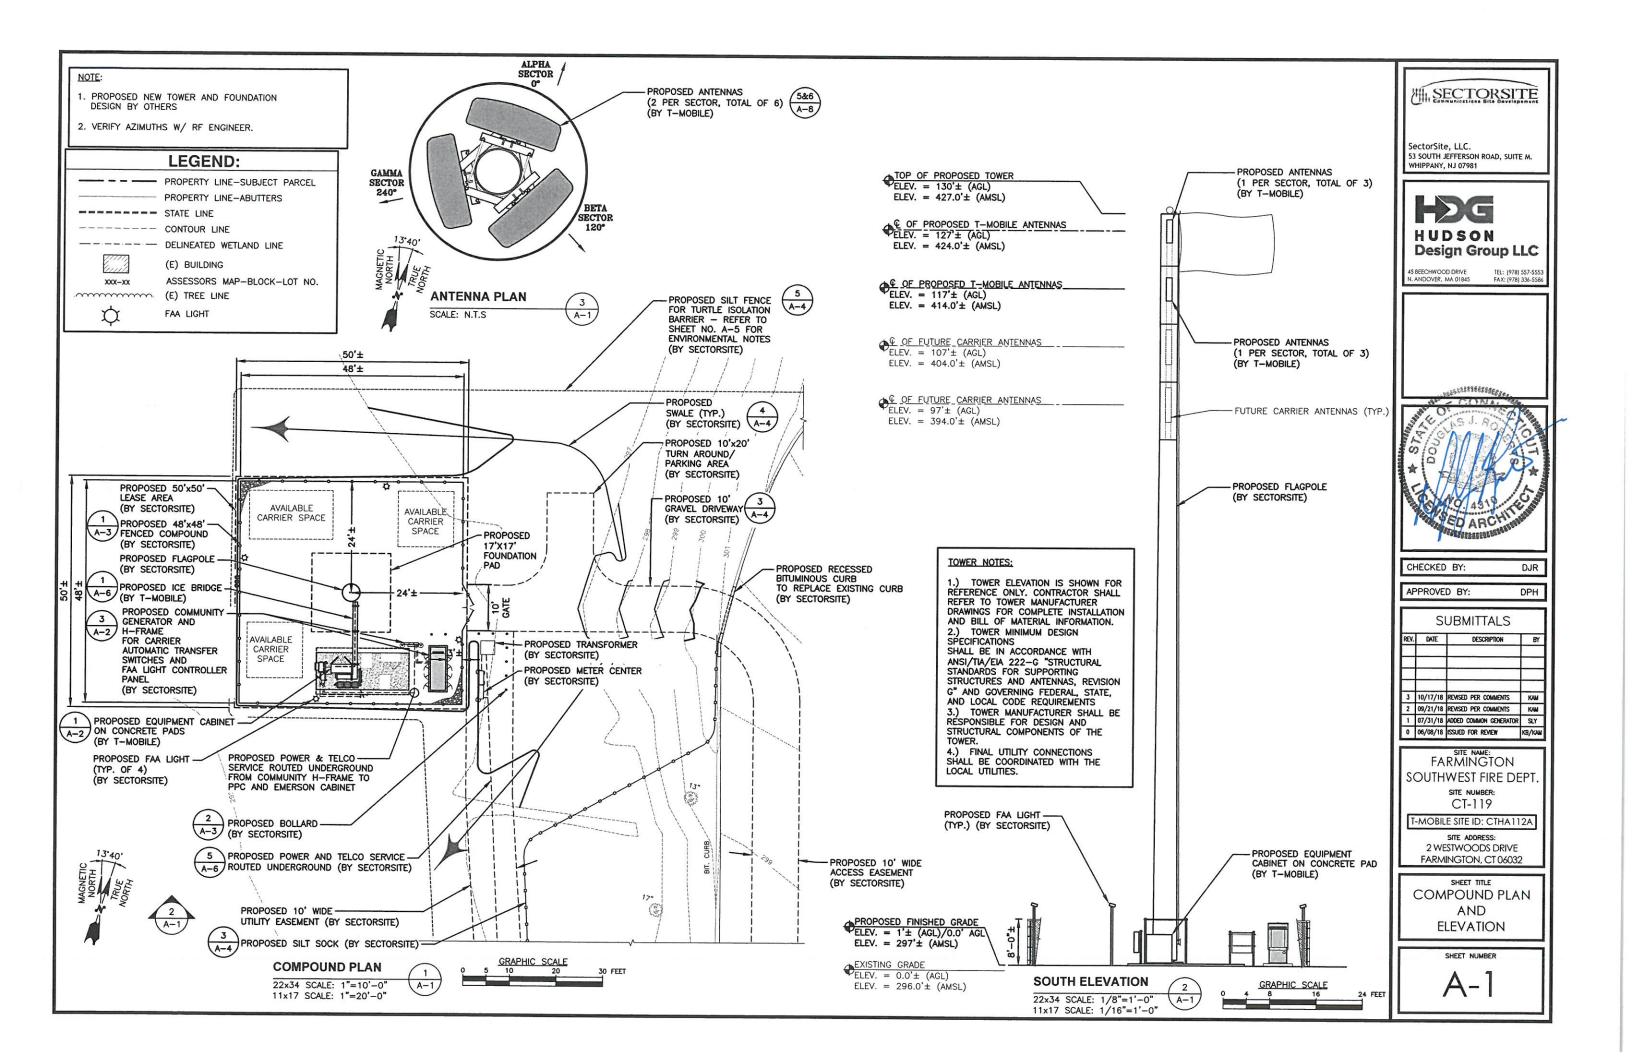

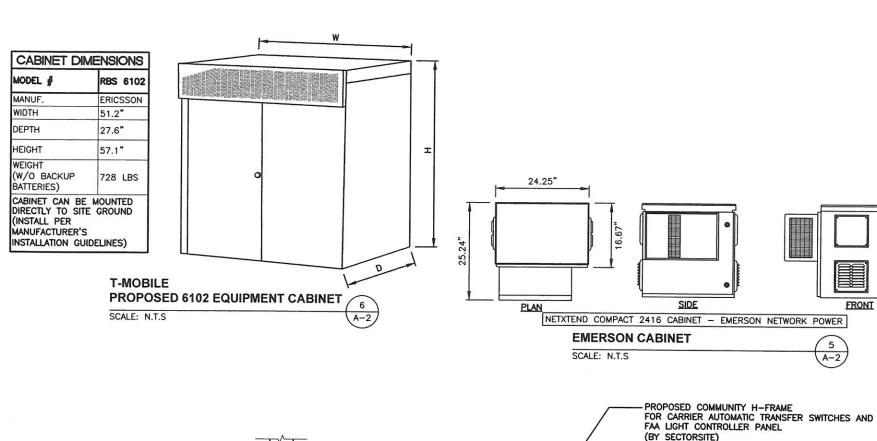


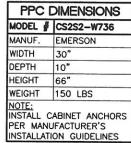

SCALE: N.T.S

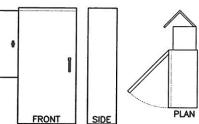


T-MOBILE **POWER PROTECTION CABINET (PPC)**

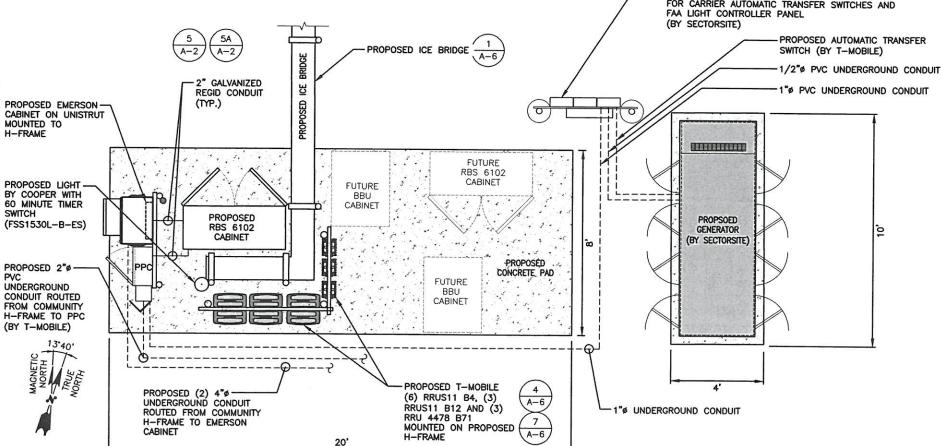

T-MOBILE

EQUIPMENT PLAN

22x34 SCALE: 1/2"=1'-0" 11x17 SCALE: 1/4"=1'-0"

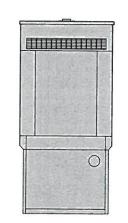

DIESEL GENERATOR MODEL NO: SD100 MANUF. GENERAC HEIGHT 105" WIDTH 47" LENGTH 1.3.3" WEIGHT 4,969 LBS

ANCHOR GENERATOR TO CONCRETE PAD PER MANUFACTURER'S RECOMMENDATIONS

SECTORSITE GENERATOR DETAIL SCALE: N.T.S



SectorSite, LLC. 53 SOUTH JEFFERSON ROAD, SUITE M. WHIPPANY, NJ 07981





CHECKED BY: DJR

DPH

APPROVED BY:

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REV.	DATE	DESCRIPTION	BY
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2	09/21/18	REVISED PER COMMENTS	KAM
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SITE NAME: FARMINGTON SOUTHWEST FIRE DEPT SITE NUMBER: CT-119

T-MOBILE SITE ID: CTHA112A

SITE ADDRESS: 2 WESTWOODS DRIVE FARMINGTON, CT 06032


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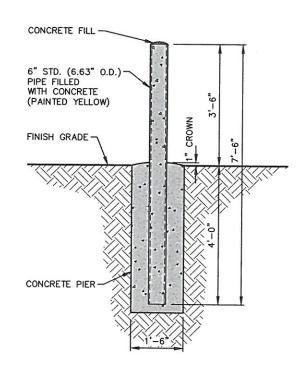
EQUIPMENT DETAILS

FENCE NOTES

1. ALTERNATE FOOTINGS FOR ALL FENCE POSTS IN LEDGE: IF LEDGE IS ENCOUNTERED AT GRADE, OR AT A DEPTH SHALLOWER THAN 3'-6", CORE DRILL AN 8" DIA HOLE 18" INTO THE LEDGE. CENTER POST IN THE HOLE AND FILL WITH CONCRETE OR GROUT. IF LEDGE IS BELOW FINISH GRADE, COAT BACKFILLED SECTION OF POST WITH COAL TAR, AND BACKFILL WITH WELL—DRAINING GRAVEL.

2. ATTACH EACH GATE WITH 1-1/2 PAIR OF NON-LIFT-OFF TYPE, MALLEABLE IRON OR FORGING, PIN-TYPE HINGES. ASSEMBLIES SHALL ALLOW FOR 180° OF GATE TRAVEL.



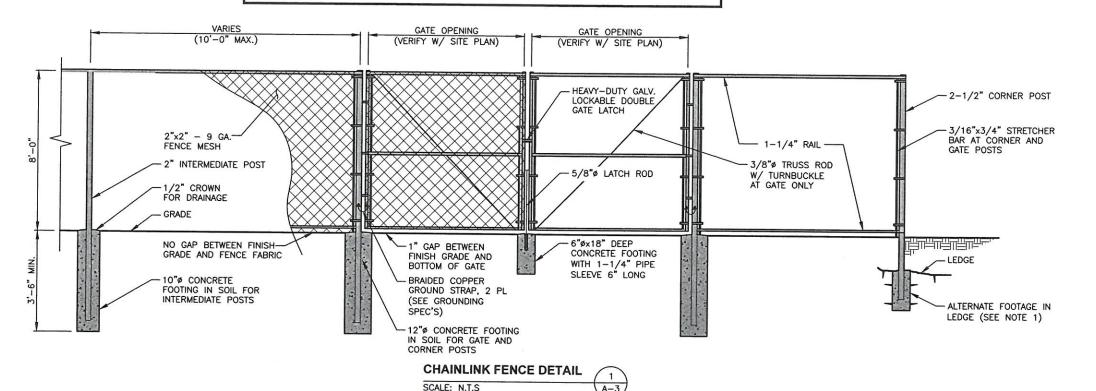

BOLLARD DETAILS

22x34 SCALE: 1/2"=1'-0" 11x17 SCALE: 1/4"=1'-0" SECTORSITE Communications Risa Davide

SectorSite, LLC. 53 SOUTH JEFFERSON ROAD, SUITE M. WHIPPANY, NJ 07981



N. ANDOVER, MA 018

FAX: (978) 336-

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CHECKED BY:

DJR

APPROVED BY: DPH

		SUBMITTALS					
	REV.	DATE	DESCRIPTION	В			
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ı	0	06/08/18	ISSUED FOR REVIEW	KB/K			

FARMINGTON
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T-MOBILE SITE ID: CTHA112A


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SHEET TITLE

FENCE DETAILS


SHEET NUMBER

A-3

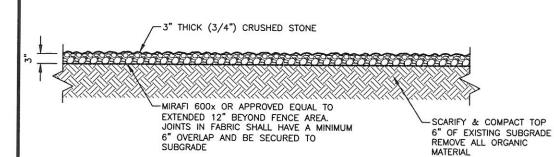


COMPOUND COVERING DETAIL SCALE: N.T.S

CRUSH	ED GRAVEL	PROCESSED AGGREGATE		
SIEVE	% PASSING BY WEIGHT	SIEVE	% PASSING BY WEIGHT	
5"	100	2 1/4"	100	
3 1/2"	90-100	2"	95-100	
1 1/2"	55-95	3/4"	50-75	
1/4"	25-60	1/4"	25-45	
#10	15-45	#40	5-20	
#40	5-25	#100	2-12	
#100	0-10	1.00		
#200	0-5	1	1	

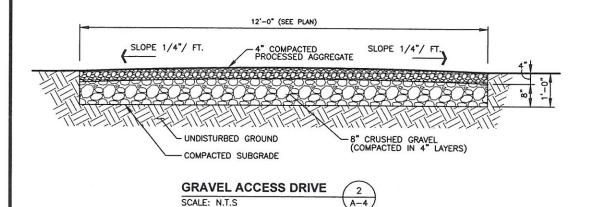


NOTES:

- 1. COMPOST ROLLS MUST BE PLACED ALONG SLOPE CONTOURS.
- 2. STAKES SHOULD BE DRIVEN IN THE MIDDLE OF THE COMPOST LEAVING 2-3 INCHES OF THE STAKE PROTRUDING ABOVE THE COMPOST.
- 3. STAKES SHOULD BE SPACED AT 3'-4' € INTERVALS.
- 4. FIT COMPOST AROUND STORM DRAINS OR INLETS, THE COMPOST SHOULD BE BACK 1-1 1/12 FEET AND SHOULD DIRECT WATER FLOW TOWARD THE ANGLE OF DRAINAGE. IF ALL DRAINAGE ANGLES INTO THE INLET, SNAKE THE COMPOST ALL THE WAY AROUND THE INLET.
- 5. WHEN COMPOST ARE USED FOR FLAT GROUND APPLICATIONS. DRIVE THE STAKES STRAIGHT DOWN; WHEN INSTALLING COMPOST ON SLOPES, DRIVE THE STAKES PERPENDICULAR TO THE SLOPE.
- 6. USE 18" LONG STAKES FOR HARD, ROCKY SOIL. FOR SOFT, LOAMY SOIL, USE 24" STAKE FOR GREATER SECURITY.

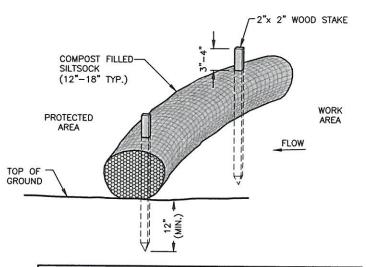



- NOTES:
 1. SILTSOCK SHALL BE FILTREXX SILTSOXX, OR APPROVED EQUAL
- COMPOST MATERIAL SHALL BE DISPERSED ON SITE. AS DETERMINED BY THE ENGINEER.
- SILTSOCK SHALL BE INSPECTED PERIODICALLY AND AFTER ALL STORM EVENTS, AND REPAIR OR REPLACEMENT SHALL BE PERFORMED PROMPTLY AS NEEDED.
- SEE SPECIFICATIONS FOR SOCK SIZE, AND COMPOST FILL.



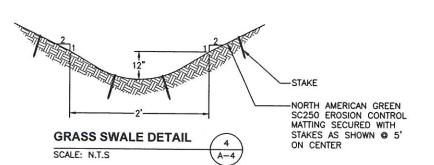

MIRAFI 600x OR APPROVED EQUAL TO EXTENDED 12" BEYOND FENCE AREA. JOINTS IN FABRIC SHALL HAVE A MINIMUM 6" OVERLAP AND BE SECURED TO SUBGRADE

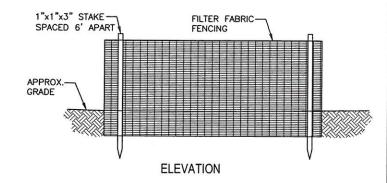

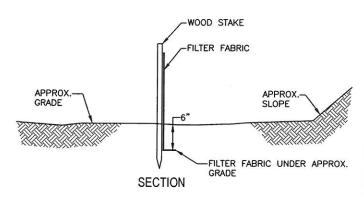

SILT FENCE DETAIL SCALE: N.T.S A-4



SectorSite, LLC. 53 SOUTH JEFFERSON ROAD, SUITE M. WHIPPANY, NJ 07981



TEL: (978) 557-5553 FAX: (978) 336-5586

CHECKED BY:

APPROVED BY: DPH

DJR

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REV.	DATE	DESCRIPTION	BY
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3	10/17/18	REVISED PER COMMENTS	KAM
2		REVISED PER COMMENTS	KAM
1	07/31/18	ADDED COMMON GENERATOR	SLY
0	06/08/18	ISSUED FOR REVIEW	KB/KAM

FARMINGTON SOUTHWEST FIRE DEPT SITE NUMBER: CT-119

T-MOBILE SITE ID: CTHA112A

SITE ADDRESS: 2 WESTWOODS DRIVE FARMINGTON, CT 06032

SHEET TITLE

EROSION CONTROL AND DETAILS

ENVIRONMENTAL NOTES

Eastern Box Turtle Protection Program

Eastern Box Turtle (Terrapenne carolina carolina) and Spotted Turtle (Clemmys guttata), State Special Concern species afforded protection under the Connecticut Endangered Species Act, are known to occur within the vicinity of the proposed communications tower facility at 2 Westwoods Drive in Farmington, Connecticut. The following turtle protection measures satisfy requirements from the Connecticut Department of Energy & Environmental Protection ("DEEP") Wildlife Division in accordance with their Natural Diversity Data Base (NDDB") determination letter (No. 201708898) dated November 8, 2017; this determination is valid until November 8, 2019 provided the scope of the project has not changed and work has begun on the project prior to the expiration date.

It is of the utmost importance that the Contractor complies with the requirement for implementation of these protective measures and the education of its employees and subcontractors performing work on the project site. This protection plan shall be implemented if work will occur during the turtle's active period (April 1st to October 30th). The proposed communications tower facility would be sited in a cultivated agricultural field which does not provide suitable hibernating habitat for either the Eastern Box Turtle or Spotted Turtle; hibernation habitat typically includes woodlands, woodland edges and forested wetlands. Therefore, protection measures during the turtle's inactive period (October 1st through March 30th) are not required for this project.

All-Points Technology Corporation, P.C. ("APT") will serve as the Environmental Monitor for this project to ensure that these protection measures are implemented properly and will provide an education session on rare species that may be encountered and the project's proximity to sensitive habitat prior to the start of construction activities. The Contractor shall contact Dean Gustafson, Senior Environmental Scientist at APT, at least 5 business days prior to the start of any construction activities. Mr. Gustafson can be reached by phone at (860) 663-1697 ext. 201 or via email at dgustafson@allpointstech.com.

The proposed protection program consists of several components: education of all contractors and sub-contractors prior to initiation of work on the site; protective measures; periodic inspection of the construction project; and, reporting.

1. Isolation Measures & Sedimentation and Erosion Controls

- a. Plastic netting used in a variety of erosion control products (i.e., erosion control blankets, fiber rolls [wattles], reinforced silt fence) has been found to entangle wildlife, including reptiles, amphibians, birds and small mammals, but particularly snakes. No permanent erosion control products or reinforced silt fence will be used on the project. Temporary erosion control products will use either erosion control blankets and fiber rolls composed of processed fibers mechanically bound together to form a continuous matrix (netless) or netting composed of planar woven natural biodegradable fiber to avoid/minimize wildlife entanglement.
- b. Installation of sedimentation and erosion controls, required for erosion control compliance and creation of a barrier to possible migrating/dispersing turtles, shall be performed by the Contractor following clearing activities and prior to any earthwork. The Environmental Monitor will inspect the work zone area prior to and following erosion control barrier installation to ensure the area is free of Eastern Box Turtle and Spotted Turtle and document barriers have been satisfactorily installed. The intent of the barrier is to segregate the majority of the work zone and isolate it from foraging/migrating/dispersing turtles, snakes and other herpetofauna. Oftentimes complete isolation of a work zone is not feasible due to accessibility needs and locations of staging/material storage areas, etc. Although the barriers may not completely isolate the work zone, they will be positioned to deflect migrating/dispersal routes away from the work zone to minimize potential encounters with turtles, snakes and other herpetofauna.
- c. The Contractor is responsible for daily inspections of the sedimentation and erosion controls for tears or breeches and accumulation levels of sediment, particularly following storm events that generate a discharge. APT will provide periodic inspections of the sedimentation and erosion controls throughout the duration of construction activities only as it pertains to protection of rare species. Third party monitoring of sedimentation and erosion controls will be performed by other parties, as necessary, under applicable local, state and/or federal regulations.
- d. The extent of the sedimentation and erosion controls will be as shown on the site plans. The Contractor shall have additional sedimentation and erosion controls stockpiled on site should field or construction conditions warrant extending the controls as directed by APT.
- e. No equipment, vehicles or construction materials shall be stored outside of the sedimentation and erosion controls within 100 feet of wetlands or watercourses.
- f. All sedimentation and erosion controls shall be removed within 30 days of completion of work and permanent stabilization of site soils so that reptile and amphibian movement between uplands and wetlands is not restricted.

2.Contractor Education

- a. Prior to work on site, the Contractor shall attend an educational session at the pre-construction meeting with APT. This orientation and educational session will consist of an introductory meeting with APT providing photos of Eastern Box Turtle and Spotted Turtle emphasizing the non-aggressive nature of these species, the absence of need to destroy animals that might be encountered and the need to follow Protective Measures as described in Section 4 below. Workers will also be provided information regarding the identification of other turtles, snakes and common herpetofauna species that could be encountered.
- b. The education session will also focus on means to discriminate between the species of concern and other native species to avoid unnecessary *Talse alarms*2 Encounters with any species of turtles or snakes will be documented.
- c. The Contractor will be provided with cell phone and email contacts for APT personnel to immediately report any encounters with eastern box turtle, spotted turtle or other species. Educational poster materials will be provided by APT and displayed on the job site to maintain worker awareness as the project progresses.

3.Petroleum Materials Storage and Spill Prevention

- a. Certain precautions are necessary to store petroleum materials, refuel and contain and properly clean up any inadvertent fuel or petroleum (i.e., oil, hydraulic fluid, etc.) spill to avoid possible impact to nearby habitats.
- b. A spill containment kit consisting of a sufficient supply of absorbent pads and absorbent material will be maintained by the Contractor at the construction site throughout the duration of the project. In addition, a waste drum will be kept on site to contain any used absorbent pads/material for proper and timely disposal off site in accordance with applicable local, state and federal laws.
- c. The following petroleum and hazardous materials storage and refueling restrictions and spill response procedures will be adhered to by the Contractor.
- i. Petroleum and Hazardous Materials Storage and Refueling
- Refueling of vehicles or machinery shall occur a minimum of 100 feet from wetlands or watercourses and shall take place on an impervious pad with secondary containment designed to contain fuels.
- 2.Any fuel or hazardous materials that must be kept on site shall be stored on an impervious surface utilizing secondary containment a minimum of 100 feet from wetlands or watercourses.
- ii. Initial Spill Response Procedures
- 1. Stop operations and shut off equipment
- 2.Remove any sources of spark or flame.
- 3.Contain the source of the spill.
- 4.Determine the approximate volume of the spill.
- Identify the location of natural flow paths to prevent the release of the spill to sensitive nearby waterways or wetlands.
- 6. Ensure that fellow workers are notified of the spill.

iii.Spill Clean Up & Containment

- Obtain spill response materials from the on-site spill response kit. Place absorbent materials directly on the release area.
- Limit the spread of the spill by placing absorbent materials around the perimeter of the spill.
- 3.Isolate and eliminate the spill source.
- 4.Contact the appropriate local, state and/or federal agencies, as necessary
- Contact a disposal company to properly dispose of contaminated materials in accordance with all local, state and federal regulations.

iv.Reportin

- 1. Complete an incident report.
- Submit a completed incident report to the appropriate Town of Farmington, Connecticut Siting Council and other applicable local, state and federal officials.

4.Turtle Protective Measures

- a. Prior to the start of construction each day, the Contractor shall search the entire work area for turtles.
- b. If a turtle is found, it shall be immediately moved, unharmed, by carefully grasped in both hands, one on each side of the shell, between the turtle's forelimbs and the hind limbs, and placed just outside of the isolation barrier in the same approximate direction it was walking.

c. Special care shall be taken by the Contractor during early morning and evening hours so that possible basking or foraging turtles are not harmed by construction activities.

5.Herbicide and Pesticide Restrictions

a. The use of herbicides and pesticides at the proposed communications tower facility shall be avoided when possible. In the event herbicides and/or pesticides are required at the proposed facility, their use will be used in accordance with Integrated Pest Management (3PM?) principles with particular attention to minimize applications within 100 feet of wetland or watercourse resources. No applications of herbicides or pesticides are allowed within actual wetland or watercourse resources.

6. Reporting

- a. Daily Compliance Monitoring Reports (brief narrative and applicable photos) documenting each APT inspection will be submitted by APT to SectorSite for compliance verification. Any observations of turtles will be included in the reports.
- b. Following completion of the construction project, APT will provide a Compliance Monitoring Summary Report to SectorSite documenting implementation of the rare species and wetland protection program, monitoring and any species observations. SectorSite will provide a copy of the Compliance Monitoring Summary Report to the Connecticut Siting Council for compliance verification.

Any observations of Eastern Box Turtle will be reported to CTDEEP by APT, with photo-documentation (if possible



SectorSite, LLC. 53 SOUTH JEFFERSON ROAD, SUITE M. WHIPPANY, NJ 07981



N. ANDOVER, MA 01845

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APPROVED BY:

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REV.	DATE	DESCRIPTION	BY
3	10/17/18	REVISED PER COMMENTS	KAM
2	09/21/18	REVISED PER COMMENTS	KAM
1	07/31/18	ADDED COMMON GENERATOR	SLY
0	06/08/18	ISSUED FOR REVIEW	KB/KAM

SITE NAME:
FARMINGTON
SOUTHWEST FIRE DEPT.
SITE NUMBER:
CT-119

T-MOBILE SITE ID: CTHA112A SITE ADDRESS:


SITE ADDRESS: 2 WESTWOODS DRIVE FARMINGTON, CT 06032

SHEET TITLE

ENVIRONMENTAL NOTES

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SectorSite, LLC. 53 SOUTH JEFFERSON ROAD, SUITE M. WHIPPANY, NJ 07981

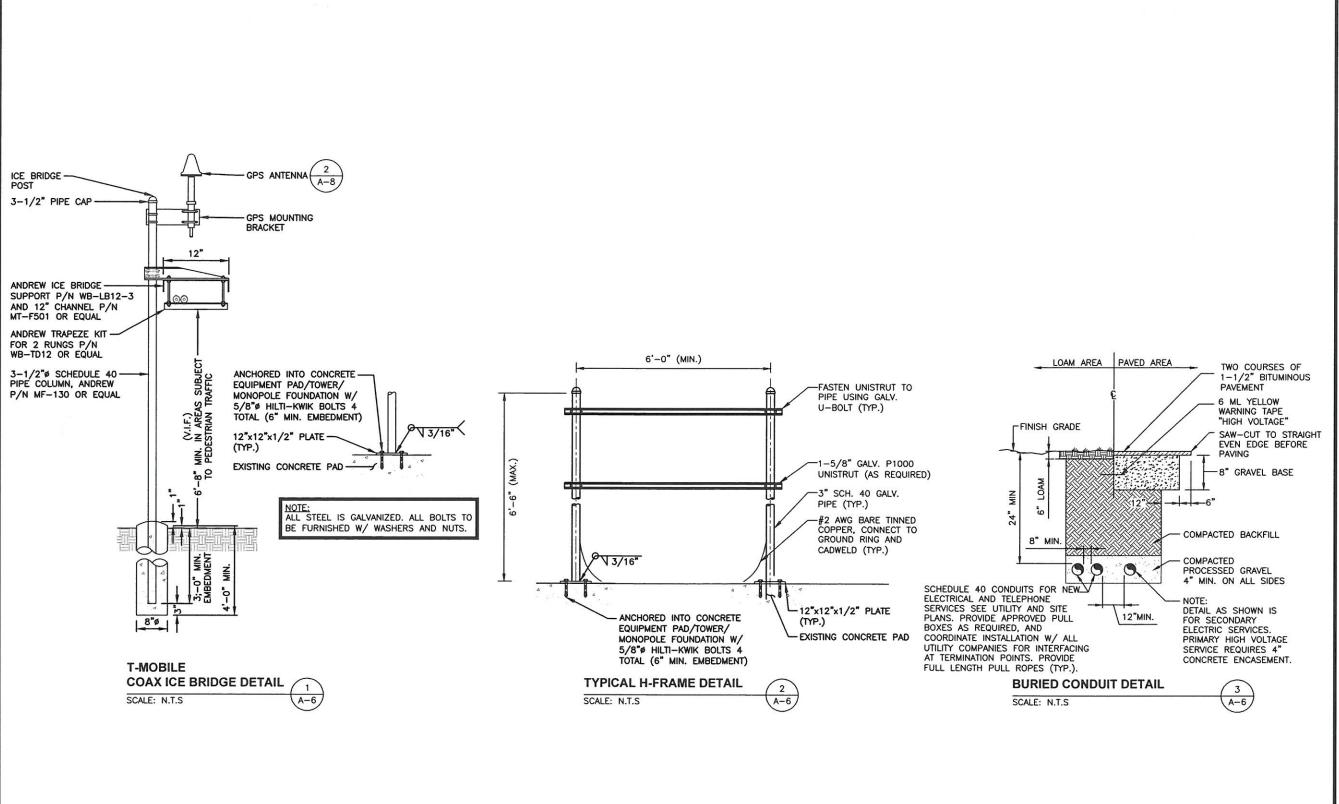

45 BEECHWOOD DRIVE N. ANDOVER, MA 01845



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DETAILS


SHEET NUMBER

PROPOSED CONCRETE PAD #4 REBAR SPACED ® 8" O.C. 88 O.C. 98 O.



FOUNDATION NOTES & CONCRETE SPECIFICATIONS

- FOUNDATION AREA SHALL BE EXCAVATED TO THE DEPTH AND DIMENSIONS SHOWN ON THE PLANS. EXISTING LEDGE AND ALL OTHER EXISTING UNSUITABLE MATERIAL SHALL BE REMOVED AND LEGALLY DISPOSED OF OFF—SITE. THE SUBGRADE SHALL BE ROLLED WITH A 1—TON, VIBRATORY, WALK—BEHIND ROLLER AT A SPEED OF LESS THAN 2 FPS, 6 PASSES MINIMUM, TO PROVIDE UNYIELDING SURFACE.
- UNDERCUT SOFT OR "WEAVING" AREAS A MINIMUM OF 12 INCHES DEEP. BACKFILL UNDERCUT AREA WITH FILL MEETING THE SPECIFICATIONS OF STRUCTURAL FILL.
- CONCRETE TO HAVE A MINIMUM 28 DAY COMPRESSIVE STRENGTH (f'c)=4000 psi. CONCRETE TO BE AIR ENTRAINED, DESIRED AIR CONTENT TO BE 6% (PLUS OR MINUS 2%)
- 4. REINFORCING BAR TO BE ASTM A615 GRADE 60.
- WELDED WIRE FABRIC TO CONFORM TO THE REQUIREMENTS OF ASTM A185.
 WIRES FOR FABRIC TO CONFORM TO THE REQUIREMENTS OF ASTM A82.
- 6. COORDINATE WITH MANUFACTURER OF PREFABRICATED SHELTER FOR LOCATION OF ATTACHMENTS TO BASE SLAB.
- 7. ALL REINFORCING TO HAVE MINIMUM CONCRETE COVER PER ACI SPECIFICATIONS.
- 8. ALL CONCRETE MATERIALS AND WORKMANSHIP SHALL CONFORM TO LATEST EDITION OF ACI 318 AND APPLICABLE STATE BUILDING CODE.

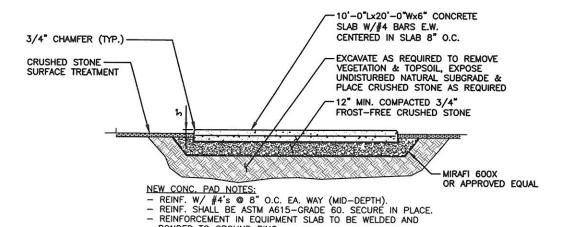

T-MOBILE

CONCRETE PAD DETAIL
SCALE: N.T.S

BONDED TO GROUND RING

2 A-7 SECTORSITE

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FARMINGTON
SOUTHWEST FIRE DEPT

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T-MOBILE SITE ID: CTHA112A

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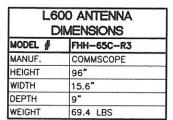
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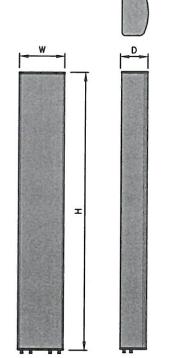
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CONCRETE PAD DETAILS

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A-7





ANTENNA DETAIL	
SCALE: N.T.S	A-8

RRUSTI DIMENSIONS

RRUS11 B12

RRUS11 B4

ERICSSON

50.6 LBS

17"

20"

MODEL #

MODEL #

MANUF.


WIDTH

DEPTH

HEIGHT

WEIGHT


	S 4478 B71 IENSIONS
MODEL #	RRUS 4478 B71
MANUF.	ERICSSON
HEIGHT	15"
WIDTH	13.2"
DEPTH	7.4"
WEIGHT	60 LBS

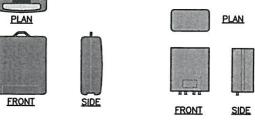


PROPOSED RADIOS DETAIL	3
SCALE: N.T.S	A-8

L19 ANTENNA DIMENSIONS MODEL # APX16DWV-16DWV-S-E-A20 MANUF. RFS WIDTH 13" DEPTH 3.15" HEIGHT 55.9" WEIGHT 40.7 LBS


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ANTENNA DETAIL	$\overline{2}$
CALE: N.T.S	A-8

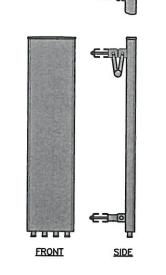



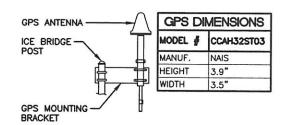

PROPOSED RRU MOUNTING DETAIL ON H-FRAME

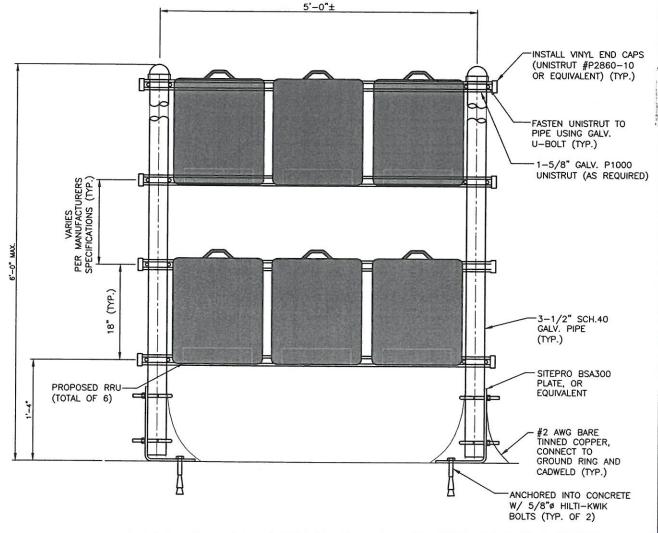SCALE: N.T.S



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45 BEECHWOOD DRIVE N. ANDOVER, MA 01845



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DPH

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APPROVED BY:

SUBMITTALS

REV. DATE DESCRIPTION BY

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1 07/31/18 ADDED COMMON GENERATOR SLY
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FARMINGTON
SOUTHWEST FIRE DEPT.
SITE NUMBER:

CT-119 T-MOBILE SITE ID: CTHA112A


SITE ADDRESS: 2 WESTWOODS DRIVE FARMINGTON, CT 06032

SHEET TITLE

ANTENNA DETAILS

SHEET NUMBER

A-8

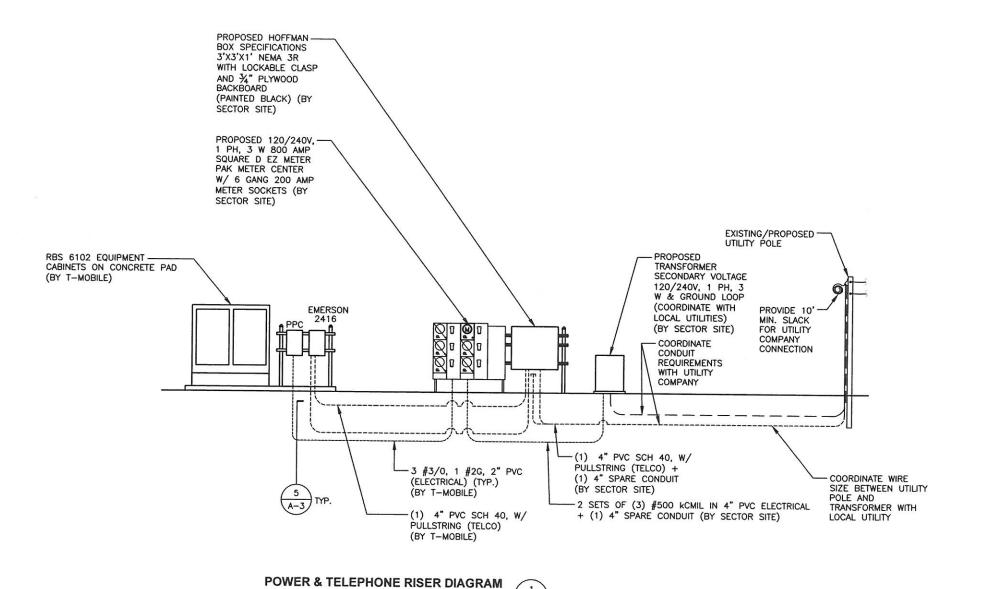

SCALE: N.T.S

ELECTRICAL NOTES

- UTILITY SERVICES SHOWN ARE PROPOSED, THE ELECTRIC CONTRACTOR SHALL COORDINATE EXACT TELEPHONE AND ELECTRIC SERVICE CONNECTION POINTS, PULL BOXES, ROUTING AND ASSOCIATED REQUIREMENTS WITH LOCAL UTILITY COMPANIES.
- 2. VISIT SITE AND EXAMINE CONDITIONS UNDER WHICH WORK MUST BE PERFORMED. REPORT ADVERSE CONDITIONS IN WRITING TO LICENSEE.

 COMMENCEMENT OF WORK SHALL BE CONSTRUED AS COMPLETE ACCEPTANCE OF EXISTING CONDITIONS INCLUDING PREPARATORY WORK DONE BY OTHERS.
- 3. ALL EXISTING UNDERGROUND LINES ON SITE SHALL BE LOCATED PRIOR TO CONSTRUCTION.
- . GIVE NOTICES, FILE PLANS, OBTAIN PERMITS AND LICENSES, PAY FEES AND BACK CHARGES, AND OBTAIN NECESSARY APPROVALS FROM AUTHORITIES THAT HAVE JURISDICTION.
- PERFORM WORK AS REQUIRED BY BOCA AND PER LOCAL LAWS.
- 6. THE ELECTRICAL CONTRACTOR SHALL COORDINATE ALL CONDUIT ROUTING WITH LOCAL UTILITY COMPANIES AND FIELD CONSTRUCTION MANAGER.
- 7. ALL EXTERIOR WALL PENETRATIONS SHALL BE SILICONE SEALED.
- MATERIAL AND EQUIPMENT SHALL BE UL, NEMA, ANSI, IEEE, ADA & CBM APPROVED FOR INTENDED SERVICE. INSTALLATION SHALL MEET REQUIREMENTS OF NATIONAL AND STATE ELECTRICAL CODE.
- ALL ELECTRICAL EQUIPMENT SHALL HAVE AN INTERRUPTING RATING NOT LESS THEN THE MAXIMUM SHORT CIRCUIT CURRENT TO WHICH THEY MAY BE SUBJECTED, AND A MINIMUM OF 10,000 A.I.C..
- 10. ALL NEW WIRING SHALL BE TYPE THWN RATED 75°C., 600 VOLT. WET OR DRY LOCATIONS.
 MINIMUM BRANCH CIRCUIT WIRING SHALL BE #12 AWG SOLID COPPER.
- 11. ALL METALLIC CONDUITS SHALL BE PROVIDED WITH BONDING BUSHINGS.
- 12. ALL BROCHURES, OPERATING MANUALS, CATALOGS, SHOP DRAWINGS, ETC. SHALL BE TURNED OVER TO THE LICENSEE PROJECT MANAGER AT JOB COMPLETION.
- PROVIDE THE OWNER WITH ONE SET OF COMPLETE ELECTRICAL "AS BUILT" DRAWINGS AT THE COMPLETION OF THE JOB.
- 14. GUARANTEE WORK IN WRITING FOR ONE YEAR FROM DATE OF FINAL ACCEPTANCE. REPAIR OR REPLACE DEFECTIVE MATERIALS OR INSTALLATION AT NO COST TO OWNER. CORRECT DAMAGE CAUSED IN MAKING NECESSARY REPAIRS AND REPLACEMENTS UNDER GUARANTEE AT NO COST TO OWNER.
- 15. CONTRACTOR SHALL CONTACT "DIG SAFE" (1-888-DIG-SAFE) PRIOR TO COMMENCEMENT OF WORK.

SECTORSITE

SectorSite, LLC. 53 SOUTH JEFFERSON ROAD, SUITE M. WHIPPANY, NJ 07981



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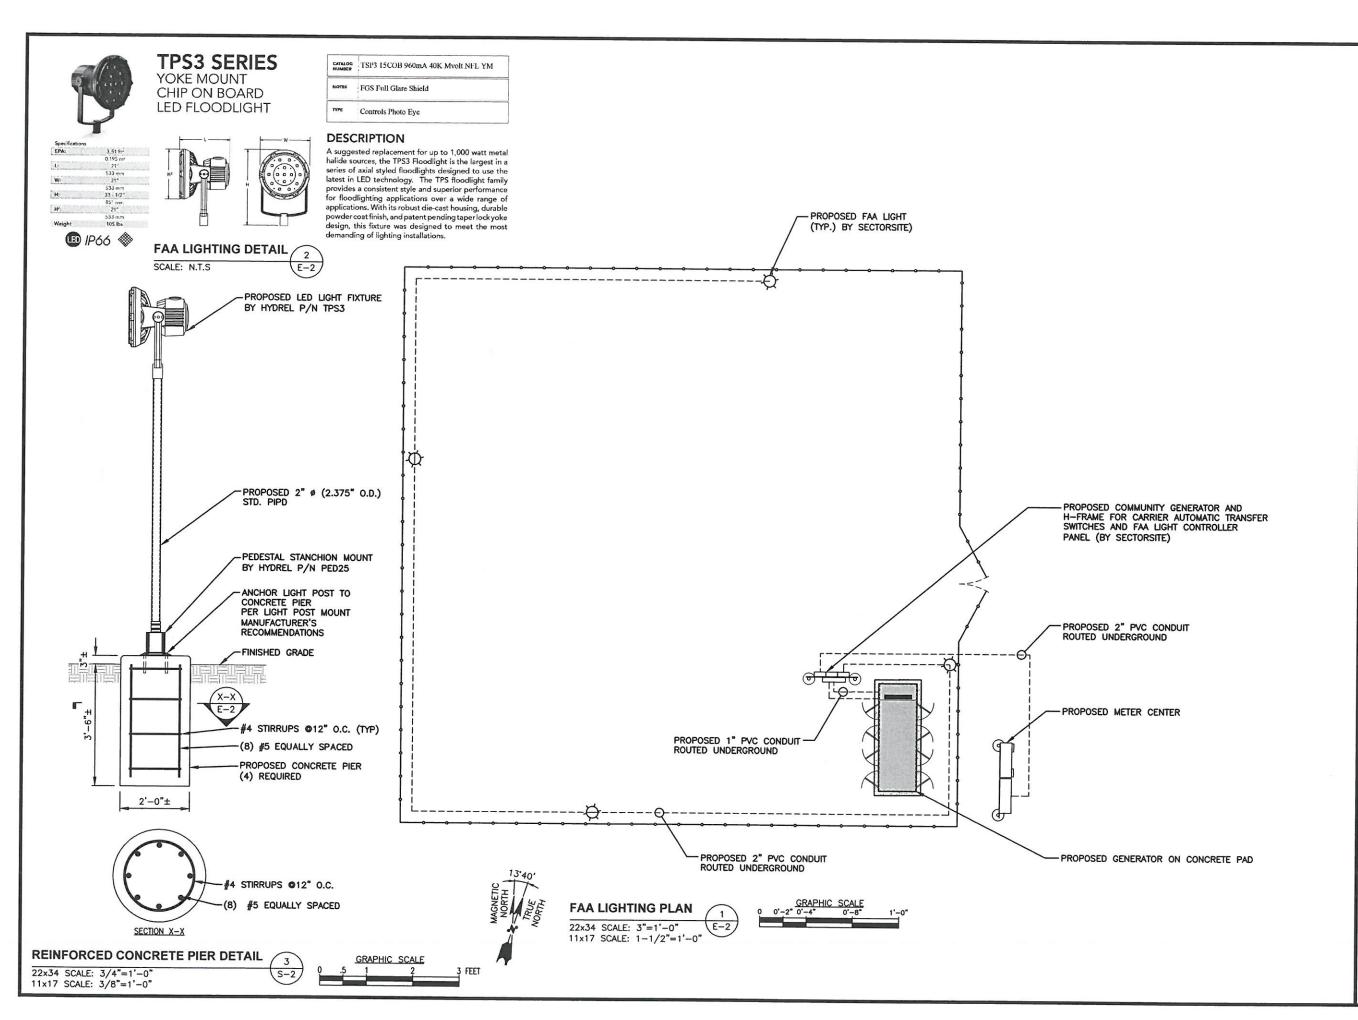
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45 BEECHWOOD DRIVE

FAX: (978) 336-5

DJR

DPH

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FARMINGTON
SOUTHWEST FIRE DEPT.
SITE NUMBER:
CT-119

T-MOBILE SITE ID: CTHA 1 12A

SITE ADDRESS: 2 WESTWOODS DRIVE FARMINGTON, CT 06032

SHEET TITLE

FAA LIGHTING PLAN AND DETAIL

SHEET NUMBER

E-2



« OE/AAA

Light Outage Reporting

Sponsors should keep in mind that conspicuity is achieved only when all recommended lights are working. Partial equipment outages decrease the margin of safety. Any outage should be corrected as soon as possible. Failure of a steady burning side or intermediate light should be corrected as soon as possible,

Any failure or malfunction that lasts more than thirty (30) minutes and affects a top light or flashing obstruction light, regardless of its position, should be reported immediately by either direct entry tool or by calling 877-487-6867, for Alaska 800-478-3576, so a Notice to Airmen (NOTAM) can be issued. Start of Activity/End of Validity must be provided when reporting. FCC receives notification upon Antenna Structure Registration (ASR) NOTAM issuance.

When reporting, please have available:

- Name of persons or organizations reporting light failures, including any title, address and phone number
- The type of Structure
- Location of structure (including latitude/longitude, if known, prominent structures, landmarks, etc...) Height of structure above ground level (AGL)/above mean sea level (AMSL), if known
- **Circle Search may be used to obtain information for items 3. and 4.**
- Start of Activity/End of Validity
- For FCC Towers, the ASR Number, if known. If the ASR is not known indicate ASR UNKNOWN. (This is for structures that are regulated by the FCC)
- For Cranes, Stacks, etc., the Aeronautical Study Number (ASN), if known. If the ASN is not known indicate ASN UNKNOWN. (This is for structures studied by the FAA but not regulated by the FCC)
- For Wind Turbine Farms, if using latitude/longitude, provide the coordinates for the center point of the wind farm, or the coordinates for one of the turbines closest to the center.

As soon as normal operation is restored, or to extend the End of Validity time, report by direct entry tool or by calling 877-487-6867, for Alaska 800-478-3576. Unless extended, NOTAMs will auto-cancel at their End of Validity time (except when indicated as Permanent (PERM). The sponsor is responsible for extending the outage date or reporting an earlier return to service date, if needed.

Advisory Circular 70/7460-1L Change 1, Obstruction Marking and lighting, describes the standards for marking and lighting structures such as buildings, chimneys, antenna towers, cooling towers, storage tanks, supporting structures of overhead wires, etc...

Note: In accordance with the current FAA JO 7930.2, Notices to Airmen (NOTAM), effective 12/18/2015, there is no longer an automatic 15-day expiration for ASR tower light NOTAMs. A realistic time frame to repair the tower light will be determined by the sponsor and provided as the expiration date.

STANDBY POWER RATING

100 kW, 125 kVA, 60 Hz

PRIME POWER RATING*

90 kW, 113 kVA, 60 Hz





*Built in the USA using domestic and foreign parts

*EPA Certified Prime ratings are not available in the U.S. or its Territories.

**Certain options or customization may not hold certification valid.

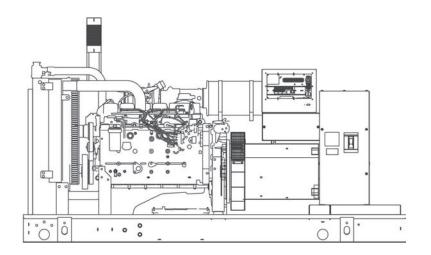


Image used for illustration purposes only

CODES AND STANDARDS

Generac products are designed to the following standards:



UL2200, UL508, UL142, UL498



NFPA70, 99, 110, 37



NEC700, 701, 702, 708



ISO9001, 8528, 3046, 7637, Pluses #2b, 4



NEMA ICS10, MG1, 250, ICS6, AB1



ANSI C62.41

POWERING AHEAD

For over 50 years, Generac has led the industry with innovative design and superior manufacturing.

Generac ensures superior quality by designing and manufacturing most of its generator components, including alternators, enclosures and base tanks, control systems and communications software.

Generac's gensets utilize a wide variety of options, configurations and arrangements, allowing us to meet the standby power needs of practically every application.

Generac searched globally to ensure the most reliable engines power our generators. We choose only engines that have already been proven in heavy-duty industrial application under adverse conditions.

Generac is committed to ensuring our customers' service support continues after their generator purchase.

SD100

| **6.7L** | 100 kW

INDUSTRIAL DIESEL GENERATOR SET

EPA Certified Stationary Emergency

STANDARD FEATURES

ENGINE SYSTEM

General

- · Oil Drain Extension
- Air Cleaner
- · Fan Guard
- · Stainless Steel flexible exhaust connection
- · Critical Exhaust Silencer (enclosed only)
- · Factory Filled Oil
- · Radiator Duct Adapter (open set only)

Fuel System

- · Fuel lockoff solenoid
- · Primary fuel filter

Cooling System

- · Closed Coolant Recovery System
- · UV/Ozone resistant hoses
- · Factory-Installed Radiator
- · Radiator Drain Extension
- 50/50 Ethylene glycol antifreeze
- 120 VAC Coolant Heater

Engine Electrical System

- · Battery charging alternator
- Battery cables
- Battery tray
- Solenoid activated starter motor
- Rubber-booted engine electrical connections

ALTERNATOR SYSTEM

- UL2200 GENprotect™
- 12 leads (3-phase, non 600 V)
- · Class H insulation material
- · Vented rotor
- 2/3 pitch
- Skewed stator
- Auxiliary voltage regulator power winding
- Amortisseur winding
- · Brushless Excitation
- · Sealed Bearings
- · Automated manufacturing (winding, insertion, lacing, varnishing)
- · Rotor dynamically spin balanced
- · Full load capacity alternator
- · Protective thermal switch

GENERATOR SET

- · Internal Genset Vibration Isolation
- · Separation of circuits high/low voltage
- Separation of circuits multiple breakers
- · Silencer Heat Shield
- Wrapped Exhaust Piping
- · Silencer housed in discharge hood (enclosed only)
- · Standard Factory Testing
- · 2 Year Limited Warranty (Standby rated Units)
- 1 Year Limited Warranty (Prime rated Units)
- · Silencer mounted in the discharge hood (enclosed only)

ENCLOSURE (IF SELECTED)

Rust-proof fasteners with nylon washers to protect finish

INDUSTRIAL

- High performance sound-absorbing material
- Gasketed doors

GENERAC

- Stamped air-intake louvers
- Air discharge hoods for radiator-upward pointing
- Stainless steel lift off door hinges
- Stainless steel lockable handles
- Rhino Coat™ Textured polyester powder coat

TANKS (IF SELECTED)

- UL 142
- · Double wall
- Vents
- Sloped top
- Sloped bottom
- Factory pressure tested (2 psi)
- Rupture basin alarm
- Fuel level
- Check valve in supply and return lines
- Rhino Coat[™]- Textured polyester powder coat
- Stainless hardware

CONTROL SYSTEM



Control Panel

- · Digital H Control Panel Dual 4x20 Display
- · Programmable Crank Limiter
- · 7-Day Programmable Exerciser
- · Special Applications Programmable PLC
- RS-232/485
- · All-Phase Sensing DVR
- · Full System Status
- · Utility Monitoring
- · Low Fuel Pressure Indication
- · 2-Wire Start Compatible
- · Power Output (kW)

- Power Factor
- kW Hours, Total & Last Run
- · Real/Reactive/Apparent Power
- All Phase AC Voltage
- · All Phase Currents
- · Oil Pressure
- · Coolant Temperature
- · Coolant Level
- · Engine Speed
- Battery Voltage
- Frequency Date/Time Fault History (Event Log)
- Isochronous Governor Control
- Waterproof/sealed Connectors
- Audible Alarms and Shutdowns
- · Not in Auto (Flashing Light) Auto/Off/Manual Switch
- E-Stop (Red Mushroom-Type)
- NFPA110 Level I and II (Programmable)
- Customizable Alarms, Warnings, and Events
- Modbus protocol
- · Predictive Maintenance algorithm
- · Sealed Boards
- · Password parameter adjustment protection

- Single point ground
- 15 channel data logging
- 0.2 msec high speed data logging
- Alarm information automatically comes up on the display

Alarms

- · Oil Pressure (Pre-programmable Low Pressure Shutdown)
- Coolant Temperature (Pre-programmed High Temp Shutdown)
- Coolant Level (Pre-programmed Low Level Shutdown)
- Low Fuel Pressure Alarm
- Engine Speed (Pre-programmed Over speed Shutdown)
- **Battery Voltage Warning**
- · Alarms & warnings time and date stamped
- Alarms & warnings for transient and steady state conditions
- Snap shots of key operation parameters during alarms & warnings
- Alarms and warnings spelled out (no alarm codes)

SD100

| **6.7L** | 100 kW

INDUSTRIAL DIESEL GENERATOR SET

EPA Certified Stationary Emergency

INDUSTRIAL GENERAC

CONFIGURABLE OPTIONS

ENGINE SYSTEM

General

- O Oil Heater
- O Industrial Exhaust Silencer

Fuel System

- O Flexible fuel lines
- O Primary fuel filter

Engine Electrical System

- O 10A UL battery charger
- O 2.5A UL battery charger
- O Battery Warmer

ALTERNATOR SYSTEM

- O Alternator Upsizing
- O Anti-Condensation Heater
- O Tropical coating
- O Permanent Magnet Excitation

ENGINEERED OPTIONS

ENGINE SYSTEM

- O Coolant heater ball valves
- O Block Heaters
- O Fluid containment pans

ALTERNATOR SYSTEM

O 3rd Breaker Systems

CONTROL SYSTEM

- O Spare inputs (x4) / outputs (x4) H Panel Only
- O Battery Disconnect Switch

CIRCUIT BREAKER OPTIONS

- O Main Line Circuit Breaker
- O 2nd Main Line Circuit Breaker
- O Shunt Trip and Auxiliary Contact
- O Electronic Trip Breaker

GENERATOR SET

- O Gen-Link Communications Software (English Only)
- O IBC Seismic Certification
- O 8 Position Load Center
- O 2 Year Extended Warranty
- O 5 Year Warranty
- O 5 Year Extended Warranty

ENCLOSURE

- O Weather Protected
- O Level 1 Sound Attenuation
- O Level 2 Sound Attenuation
- O Steel Enclosure
- O Aluminum Enclosure
- O 150 MPH Wind Kit
- O 12 VDC Enclosure Lighting Kit
- O 120 VAC Enclosure Lighting Kit
- O AC/DC Enclosure Lighting Kit
- O Door Alarm Switch

TANKS (Size on last page)

- O Electrical Fuel Level
- O Mechanical Fuel Level
- O 8" Fill Extension
- O 13" Fill Extension

CONTROL SYSTEM

- O 21-Light Remote Annunciator
- O Remote Relay Panel (8 or 16)
- O Oil Temperature Sender with Indication Alarm
- O Remote E-Stop (Break Glass-Type, Surface Mount)
- O Remote E-Stop (Red Mushroom-Type, Surface Mount)
- O Remote E-Stop (Red Mushroom-Type, Flush Mount)
- O Remote Communication Modem
- O Remote Communication Ethernet
- O 10A Run Relay
- O Ground Fault Indication and Protection Functions

GENERATOR SET

O Special Testing

ENCLOSURE

- O Motorized Dampers
- O Door switched for intrusion alert
- O Enclosure ambient heaters

TANKS

- O Overfill Protection Valve
- O UL2085 Tank
- O ULC S-601 Tank
- O Stainless Steel Tank
- O Special Fuel Tanks (MIDEQ and FL DEP/DERM, etc.)
- O Vent Extensions

RATING DEFINITIONS

Standby - Applicable for a varying emergency load for the duration of a utility power outage with no overload capability.

Prime - Applicable for supplying power to a varying load in lieu of utility for an unlimited amount of running time. A 10% overload capacity is available for 1 out of every 12 hours. The Prime Power option is only available on International applications. Power ratings in accordance with ISO 8528-1, Second Edition

SD100 | 6.7L | 100 kW

INDUSTRIAL DIESEL GENERATOR SET

EPA Certified Stationary Emergency



APPLICATION AND ENGINEERING DATA

ENGINE SPECIFICATIONS

General	
Make	Iveco/FPT
EPA Emissions Compliance	Stationary Emergency
EPA Emissions Reference	See Emissions Data Sheet
Cylinder #	6
Type	In-Line
Displacement - L (cu In)	6.7 (406.86)
Bore - mm (in)	104 (4.09)
Stroke - mm (in)	128 (5.2)
Compression Ratio	16.5:1
Intake Air Method	Turbocharged/Aftercooled
Cylinder Head Type	2 Valve
Piston Type	Alloy Aluminum
Crankshaft Type	Forged Steel
Engine Governing	
Governor	Electronic Isochronous
Frequency Regulation (Steady State)	+/- 0.25%
Lubrication System	

Gear

Full Flow

17 (18)

Cooling System

Cooling System Type	Closed Recovery		
Water Pump	Belt Driven Centrifugal		
Fan Type	Pusher		
Fan Speed (rpm)	2538		
Fan Diameter mm (in)	599 (23.6)		
Coolant Heater Wattage	1500		
Coolant Heater Standard Voltage	120 V /240 V		

Fuel System

Fuel Type	Ultra Low Sulfur Diesel Fuel
Fuel Specifications	ASTM
Fuel Filtering (microns)	5
Fuel Injection	Stanadyne
Fuel Pump Type	Engine Driven Gear
Injector Type	Mechanical
Fuel Supply Line mm (in)	12.7 (0.5) NPT
Fuel Return Line mm (in)	12.7 (0.5) NPT

Engine Electrical System

System Voltage	12 VDC		
Battery Charging Alternator	Std		
Battery Size	See Battery Index 0161970SBY		
Battery Voltage	12 VDC		
Ground Polarity	Negative		

ALTERNATOR SPECIFICATIONS

Oil Pump Type

Oil Filter Type

Crankcase Capacity - L (qts)

Standard Model	390
Poles	4
Field Type	Revolving
Insulation Class - Rotor	Н
Insulation Class - Stator	Н
Total Harmonic Distortion	<3%
Telephone Interference Factor (TIF)	< 50

Standard Excitation	Synchronous Brushless
Bearings	Single Seated Cartridge
Coupling	Direct, Flexible Disc
Load Capacity - Standby	100%
Prototype Short Circuit Test	Yes
Voltage Regulator Type	Digital
Number of Sensed Phases	All
Regulation Accuracy (Steady State)	±0.25%

EPA Certified Stationary Emergency

OPERATING DATA

POWER RATINGS

	Standby		
Single-Phase 120/240 VAC @1.0pf	100 kW	Amps: 417	
Three-Phase 120/208 VAC @0.8pf	100 kW	Amps: 347	
Three-Phase 120/240 VAC @0.8pf	100 kW	Amps: 301	
Three-Phase 277/480 VAC @0.8pf	100 kW	Amps: 150	
Three-Phase 346/600 VAC @0.8pf	100 kW	Amps: 120	

STARTING CAPABILITIES (sKVA)

sKVA vs. Voltage Dip

		480 VAC					208/24	40 VAC					
<u>Alternator</u>	<u>kW</u>	10%	15%	20%	25%	30%	35%	10%	15%	20%	25%	30%	35%
Standard	100	79	118	157	197	236	200	59	89	118	148	177	206
Upsize 1	130	116	174	323	290	348	406	87	131	174	218	261	305
Upsize 2	150	133	199	265	332	398	464	100	149	199	249	299	348
Upsize 3	200	187	280	373	467	560	653	140	210	280	350	420	490

FUEL CONSUMPTION RATES*

Diesel - gal/hr (l/hr)

Fuel Pump Lift - ft (m)	Percent Load	Standby
3 (1)	25%	2.2 (8.3)
	50%	4.2 (15.9)
Total Fuel Pump Flow (Combustion + Return)	75%	5.9 (22.3)
29.1 gal/hr	100%	7.3 (27.6)

^{*} Fuel supply installation must accommodate fuel consumption rates at 100% load.

COOLING

Standby

Coolant Flow per Minute	gal/min (l/min)	44.6 (168.8)
Coolant System Capacity	gal (L)	5.65 (21.4)
Heat Rejection to Coolant	BTU/hr	269,130
Inlet Air	cfm (m³/hr)	6360 (180)
Max. Operating Radiator Air Temp	Fo (Co)	122 (50)
Max. Ambient Temperature (before derate)	Fo (Co)	110 (43.3)
Maximum Radiator Backpressure	in H ₂ O	0.5

COMBUSTION AIR REQUIREMENTS


			Standby	
Flow at	Rated Power	cfm (m³/min)	325 (9.2)	


ENGINE			EXHAUST		
		Standby			Standby
Rated Engine Speed	rpm	1800	Exhaust Flow (Rated Output)	cfm (m³/min)	1022 (28.94)
Horsepower at Rated kW**	hp	152	Max. Backpressure (Post Silencer)	inHg (Kpa)	1.5 (5.1)
Piston Speed	ft/min (m/min)	1559 (475)	Exhaust Temp (Rated Output)	°F (°C)	885 (474)
BMEP	psi	165	Exhaust Outlet Size (Open Set)	mm (in)	101.6 (4)


^{**}Pefer to "Emissions Data Sheet" for maximum bHP for EPA and SCAQMD permitting purposes.


EPA Certified Stationary Emergency


DIMENSIONS AND WEIGHTS*

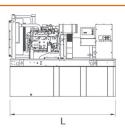


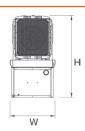


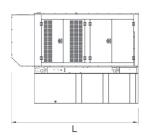


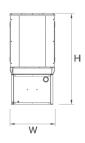

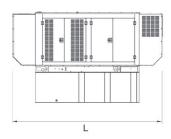

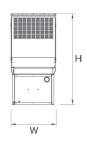

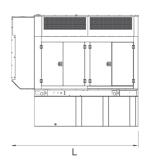

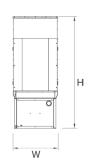

YOUR FACTORY RECOGNIZED GENERAC INDUSTRIAL DEALER

OPEN SET

RUN TIME HOURS	USABLE CAPACITY GAL (L)	L x W x H in (mm)	WT lbs (kg) - Tank & Open Set
NO TANK	-	110 (2794) x 40 (1016) x 65 (1651)	3104 (1408)
12	90 (340.7)	110 (2794) x 40 (1016) x 77 (1955.8)	3813 (1730)
30	220 (832.8)	110 (2794) x 40 (1016) x 89 (2260.6)	4146 (1881)
48	350 (1324.9)	110 (2794) x 40 (1016) x 101 (2565.4)	4488 (2036)
70	510 (1930.6)	110 (2794) x 40 (1016) x 105 (2667)	4469 (2029)
81	589 (2229.6)	128 (3251.2) x 49 (1244.6) x 107 (2717.8)	4948 (2244)
95	693 (2623.3)	136 (3454.4) x 53 (1346.2) x 107 (2717.8)	4667 (2117)

INDUSTRIAL

STANDARD ENCLOSURE

RUN TIME	USABLE CAPACITY L x W x H in (mm)	WT lbs (kg) - I	Enclosure Only	
HOURS	GAL (L)	LX W X IT III (IIIIII)	Steel	Aluminum
NO TANK	-	133 (3378) x 40 (1016) x 64 (1625.6)	_	
12	90 (340.7)	133 (3378) x 40 (1016) x 77 (1956)	_	
30	220 (832.8)	133 (3378) x 40 (1016) x 89 (2261)		
48	350 (1324.9)	133 (3378) x 40 (1016) x 101 (2565)	500 (227)	165 (75)
70	510 (1930.6)	133 (3378) x 47 (1194) x 105 (2667)		
81	589 (2229.6)	133 (3378) x 49 (1125) x 107 (2718)		
95	693 (2623.3)	133 (3378) x 53 (1346) x 107 (2718)		

LEVEL 1 ACOUSTIC ENCLOSURE

RUN TIME	USABLE CAPACITY	L x W x H in (mm)	WT lbs (kg) -	nclosure Only	
HOURS	GAL (L)		Steel	Aluminum	
NO TANK	-	154 (3912) x 40 (1016) x 64 (1626)	_		
12	90 (340.7)	154 (3912) x 40 (1016) x 77 (1956)			
30	220 (832.8)	154 (3912) x 40 (1016) x 89 (2261)	-		
48	350 (1324.9)	154 (3912) x 40 (1016) x 101 (2565)	750 (340)	250 (112)	
70	510 (1930.6)	154 (3912) x 47 (1194) x 105 (2667)			
81	589 (2229.6)	154 (3912) x 49 (1245) x 107 (2718)			
95	693 (2623.3)	154 (3912) x 53 (1346) x 107 (2718)			

LEVEL 2 ACOUSTIC ENCLOSURE

RUN TIME	USABLE	L x W x H in (mm)	WT lbs (kg) - Enclosure Only		
HOURS	CAPACITY GAL (L)		Steel	Aluminum	
NO TANK	-	145 (3683) x 40 (1016) x 81 (2057)			
12	90 (340.7)	145 (3683) x 40 (1016) x 84 (2134)			
30	220 (832.8)	145 (3683) x 40 (1016) x 106 (2692)			
48	350 (1324.9)	145 (3683) x 40 (1016) x 118 (2997)	1000 (454)	330 (150)	
70	510 (1930.6)	145 (3683) x 47 (1194) x 122 (3099)	_		
81	589 (2229.6)	145 (3683) x 49 (1245) x 124 (3150)			
95	693 (2623.3)	145 (3683) x 53 (1346) x 124 (3150)	_		

^{*}All measurements are approximate and for estimation purposes only. Sound dBA can be found on the sound data sheet. Enclosure Only weight is added to Tank & Open Set weight to determine total weight.

Specification characteristics may change without notice. Dimensions and weights are for preliminary purposes only. Please consult a Generac Power Systems Industrial Dealer for detailed installation drawings.

6 OF 6