BRIDGEPORT EAST

380 Horace Street Bridgeport, Connecticut

Description of Proposed Cell Site

Tarpon Towers II, LLC 1001 3rd Avenue West, Suite 420 Bradenton, FL 34205

Cellco Partnership d/b/a Verizon Wireless 99 East River Drive East Hartford, CT 06108

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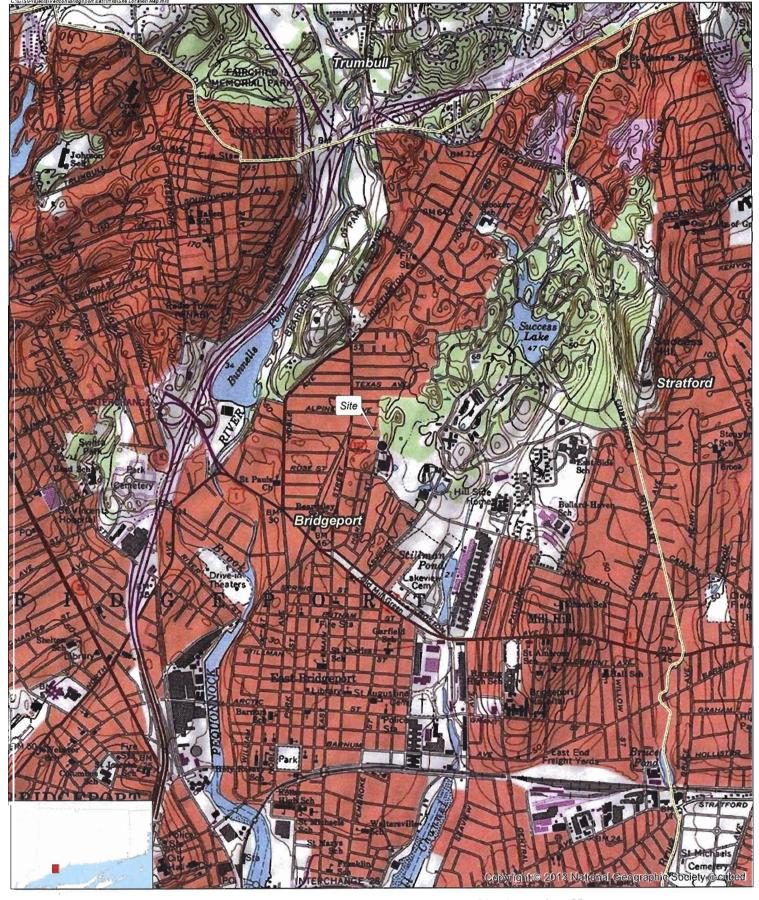
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SITE NAME: BRIDGEPORT EAST – 380 HORACE STREET, BRIDGEPORT, CT

GENERAL CELL SITE DESCRIPTION

The proposed Bridgeport East cell site would be located in the northerly portion of an approximately 13.7 acre parcel owned by MDL Realty LLC. The facility would consist of a 90-foot telecommunications tower and a 9'-4" x 16' equipment platform located near the base of the tower. The platform would support Cellco's radio equipment and a 25 kW natural gas-fueled back-up generator. The tower and equipment shelter will be located within a 2500 square foot fenced compound and leased area.

Cellco would attach twelve (12) antennas and nine (9) remote radio heads to a platform at a centerline height of 90 feet above ground level. The top of Cellco's antennas would extend above the top of the tower to an overall height of approximately 94 feet. Vehicular access to the site would extend from Horace Street over an existing paved driveway and parking area on an adjacent parcel, a distance of approximately 226 feet. Utility service would extend from existing service along Horace Street.




Legend





Municipal Boundary

Map Notes: Base Map Source: USGS 7.5 Minute Topographic Quadrangle Map, Bridgeport (1984), CT Map Scale: 1.24,000 Map Date: July 2017

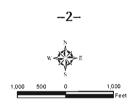

Site Location Map

Proposed Wireless Telecommunications Facility Bridgeport East 380 Horace Street Bridgeport, Connecticut

verizon/





Legend

Subject Property

Proposed Monopole Tower

Proposed Facility Layout

Approximate Parcel Boundary (CTDEEP GIS)

200 100 0 200 Feet

Aerial Photograph

Proposed Wireless Telecommunications Facility Bridgeport East 380 Horace Street Bridgeport, Connecticut

verizon/



SITE EVALUATION REPORT

SITE NAME: BRIDGEPORT EAST - 380 HORACE STREET, BRIDGEPORT, CT

I. TOWER LOCATION

- A. COORDINATES: 41°-12'-15.63" N 73°-10'-35.62" W
- B. GROUND ELEVATION: Approximately 62± feet AMSL
- C. <u>U.S.G.S. QUADRANGLE MAP</u>: Bridgeport, CT
- D. <u>SITE ADDRESS</u>: 380 Horace Street, Bridgeport, CT
- E. <u>ZONING WITHIN 1/4 MILE OF SITE</u>: Land within ¼ mile of the cell site is in Bridgeport's IL Industrial Light Zone and R-B Residential (Two Family) zone districts and R-C Residential (Multi-Family) zone.

II. DESCRIPTION

- A. <u>SITE SIZE</u>: 2,500 Square Foot Leased Area and Facility Compound
- B. <u>LESSOR'S PARCEL</u>: Approximately 13.7 acres
- C. <u>TOWER TYPE/HEIGHT</u>: 90' Monopole Tower 94' Top of Antennas
- D. <u>SITE TOPOGRAPHY AND SURFACE</u>: Topography in the area is generally flat. The facility compound will be installed along the edge of an existing paved parking area. Only eight (8) trees will need to be removed to construct the facility compound or related improvements.
- E. <u>SURROUNDING TERRAIN, VEGETATION, WETLANDS, OR WATER:</u> The tower would be located in the northerly portion of an approximately 13.7 acre industrial parcel. The closest wetland area is located approximately 150 feet to the east of the site. Minor grading in the center portion of the site compound will be required.
- F. <u>LAND USE WITHIN 1/4 MILE OF SITE</u>: The 13.7 acre subject parcel is surrounded by industrial land to the north and east and residential uses to the south and west. (*See* Aerial Photograph and U.S.G.S. Topographic Map at pp. 2 and 3).

III. FACILITIES

- A. <u>POWER COMPANY</u>: United Illuminating
- B. <u>POWER PROXIMITY TO SITE</u>: Approximately 226 feet along Horace Street to the south of the facility compound.
- C. <u>TELEPHONE COMPANY</u>: Frontier Communications
- D. <u>PHONE SERVICE PROXIMITY</u>: Same as power
- E. <u>VEHICLE ACCESS TO SITE</u>: Vehicle access to the site would extend from Horace Street over an existing paved driveway and parking area a distance of approximately 226 feet.
- F. <u>CLEARING AND FILL REQUIRED</u>: Minimal tree clearing and some minor grading in the facility compound would be required for construction of the cell site. Detailed construction plans would be developed if this location is approved by the Siting Council.

IV. LEGAL

- A. PURCHASE [] LEASE [X]
- B. OWNER: MDL Realty LLC.
- C. ADDRESS: 380 Horace Street, Bridgeport, CT
- D. DEED ON FILE AT:

City of Bridgeport, CT Land Records

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FACILITIES AND EQUIPMENT SPECIFICATION (NEW TOWER & EQUIPMENT BUILDING)

SITE NAME: BRIDGEPORT EAST – 380 HORACE STREET, BRIDGEPORT, CT

I. TOWER SPECIFICATIONS:

A. MANUFACTURER: To be determined

B. TYPE: Self-supporting monopole

C. TOWER HEIGHT: 90' DIMENSIONS: Approx. 50" base

Approx. 24" top

II. TOWER LOADING:

A. CELLCO EQUIPMENT:

- 1. Antennas (12) JAHH-65B-R3B 700, 850, 1900 and 2100 MHz
- 2. Remote Radio Heads (RRH) (9) Three (3) B13 RRH 4x30-4R - 700 MHz Three (3) B25 RRH 4x30 - 1900 MHz Three (3) B66A RRH 4x45 - 2100 MHz
- 3. GPS Antenna: Mounted on the top of the equipment platform canopy
- 4. Transmission Lines:
 - a. Two (2) Model: HB158-1-08U8-S8J18 HYBRIFLEX™ fiber optic cables

III. ENGINEERING ANALYSIS AND CERTIFICATION:

The towers will be designed in accordance with Electronic Industries Association Standard EIA/TIA-222-G "Structural Standards for Steel Antenna Towers and Antenna Support Structures." The foundation designs would be based on soil conditions at the site. Details for the towers and foundation designs will be provided as a part of the final D&M Plan.

ENVIRONMENTAL ASSESSMENT STATEMENT

SITE NAME: BRIDGEPORT EAST – 380 HORACE STREET, BRIDGEPORT, CT

I. PHYSICAL IMPACT

A. WATER FLOW AND QUALITY

No water flow and/or water quality changes are anticipated as a result of the construction or operation of the facility. There are no lakes, ponds, rivers, streams, wetlands or other regulated bodies of water located in the area to be used for the access drive, tower or equipment shelter. The equipment used will not discharge any pollutants to area surface or groundwater systems. The closest wetland area is located approximately 150 feet to the east of the fenced compound and lease area.

B. AIR QUALITY

Under ordinary operating conditions, the Cellco equipment at the Bridgeport East Facility would generate no air emissions. During power outages and periodically for maintenance purposes, Cellco would utilize a natural gas-fueled generator to provide emergency back-up power. Cellco's back-up generator will be managed to comply with the "permit by rule" criteria established by the Connecticut Department of Energy and Environmental Protection ("DEEP") Bureau of Air Management, pursuant to R.C.S.A. § 22a-174-3b.

C. LAND

Eight (8) trees will be removed and minor grading in the tower compound will be required. The remaining land of the Lessor would remain unchanged by the construction and operation of the cell site.

D. NOISE

The equipment to be in operation at the site after construction would emit no noise of any kind, except for operation of the heating, air conditioning and ventilation systems installed as a part of the prefabricated equipment cabinets and the occasional operation of the back-up generator which would only run when power to the facility is interrupted and periodically for maintenance purposes. Some noise is anticipated during cell site construction.

E. <u>POWER DENSITY</u>

The worst-case calculation of power density for Cellco's 700 MHz, 850 MHz, 1900 MHz and 2100 MHz antennas at the Bridgeport East Facility would be 48.89% of the FCC Safety Standard.

F. <u>VISIBILITY</u>

See Visibility Report included as Attachment 9.

PROJECT SUMMARY

SCOPE OF WORK:

TARPON TOWERS II, LLC IS PROPOSING TO INSTALL THE

FOLLOWING IMPROVEMENTS:

90 FOOT TOWER

62.5'x40' FENCED COMPOUND

POWER. TELCO AND GAS UTILITIES

VERIZON EQUIPMENT ON 9'-4"x 16' STEEL PLATFORM

TWELVE (12) VERIZON ANTENNAS, SIX (9) RADIOS (RRH) WITH

ASSOCIATED CABLING AND APPURTENANCES

SITE ADDRESS:

BRIDGEPORT, CT 06610

LONGITUDE:

41° 12′ 15.63″ N 73° 10′ 35.62″ W

41.204342 N 73.176561 W

PROPERTY OWNER:

MDL REALTY, LLC. 380 HORACE STREET BRIDGEPORT, CT 06610

TAX MAP#:

62/2050/39/Y

POWER COMPANY:

LINITED ILLUMINATION

TELEPHONE COMPANY: FRONTIER COMMUNICATIONS

TOWER OWNER/APPLICANT:

TARPON TOWERS II, LLC 1001 3RD AVENUE WEST. SUITE 420

BRADENTON, FL 34205

CO APPLICANT:

CELLCO PARTNERSHIP D/B/A/

VERIZON WIRELESS 99 EAST RIVER DRIVE

EAST HARTFORD, CT 06108

PROJECT ENGINEERING:

DOUG ROBERTS, AIA. HUDSON DESIGN GROUP, LLC.

110 WASHINGTON AVENUE

FOURTH FLOOR

NORTH HAVEN, CT 06473

LEGAL/ REGULATORY COUNSEL: KENNETH C. BALDWIN, Esq. ROBINSON + COLE, LLP. 280 TRUMBULL STREET HARTFORD, CT 06103




CELLCO PARTNERSHIP

d.b.a. Verizon

WIRELESS COMMUNICATIONS FACILITY

SITE NUMBER: CT1221 SITE NAME: BRIDGEPORT EAST

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VICINITY MAP

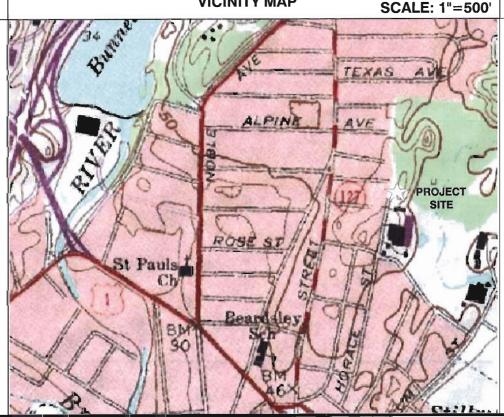GENERAL NOTES

- THIS DOCUMENT IS THE CREATION, DESIGN, PROPERTY AND COPYRIGHTED WORK OF TARPON TOWERS II. ANY DUPLICATION OR USE WITHOUT EXPRESS WRITTEN CONSENT IS STRICTLY PROHIBITED. DUPLICATION AND USE BY GOVERNMENT AGENCIES FOR THE PURPOSES OF CONDUCTING THEIR LAWFULLY AUTHORIZED REGULATORY AND ADMINISTRATIVE FUNCTIONS IS SPECIFICALLY ALLOWED.
- THE FACILITY IS AN UNMANNED PRIVATE AND SECURED EQUIPMENT INSTALLATION. IT IS ONLY ACCESSED BY TRAINED TECHNICIANS FOR PERIODIC ROUTINE MAINTENANCE AND THEREFORE DOES NOT REQUIRE ANY WATER OR SANITARY SEWER SERVICE. THE FACILITY IS NOT GOVERNED BY REGULATIONS REQUIRING PUBLIC ACCESS PER ADA REQUIREMENTS.





BUILDING 20 NORTH, SUITE 3090 TEL: (978) 557-5553 N. ANDOVER, MA 01845 FAX: (978) 336-5586



CHECKED BY: BCF

DFS

SUBMITTALS

APPROVED BY:

REV.	DATE	DESCRIPTION	BY
2	09/14/17	REVISED PER COMMENTS	JS
1	09/08/17	REVISED PER COMMENTS	SLY
0	08/24/17	ISSUED FOR REVIEW	SLY

SITE NAME:

BRIDGEPORT EAST


SITE NUMBER: CT1221

SITE ADDRESS: 380 HORACE STREET BRIDGEPORT, CT 06610

TITLE SHEET

SHEET NUMBER

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PROPERTY LINE - SUBJECT PARCEL

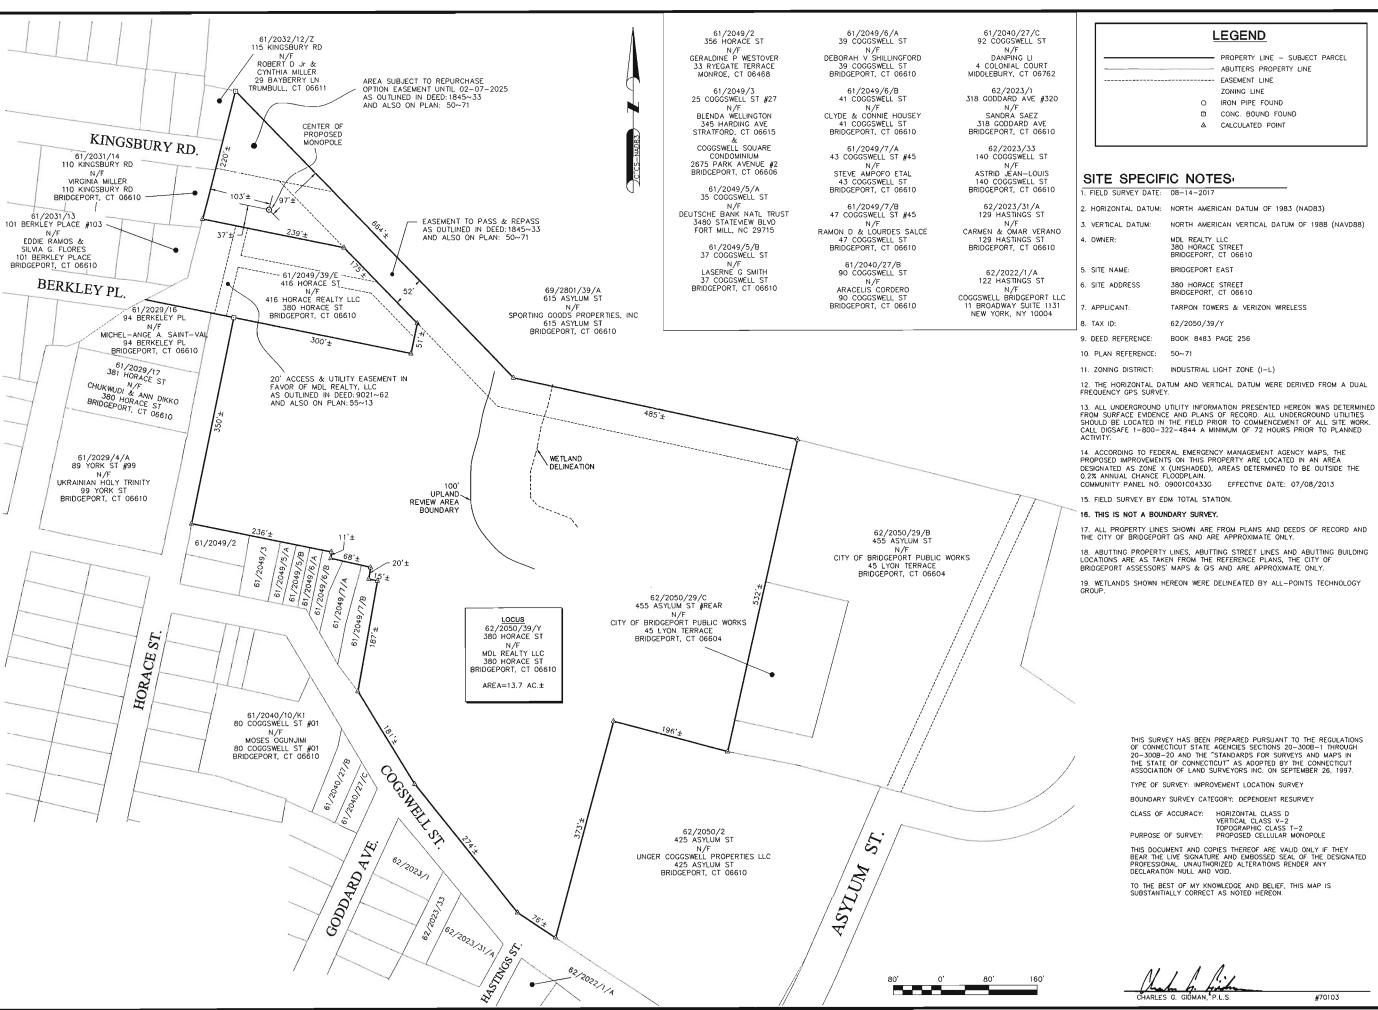2. HORIZONTAL DATUM: NORTH AMERICAN DATUM OF 1983 (NAD83)

NORTH AMERICAN VERTICAL DATUM OF 1988 (NAVD88)

12. THE HORIZONTAL DATUM AND VERTICAL DATUM WERE DERIVED FROM A DUAL

14. ACCORDING TO FEDERAL EMERGENCY MANAGEMENT AGENCY MAPS, THE PROPOSED IMPROVEMENTS ON THIS PROPERTY ARE LOCATED IN AN AREA DESIGNATED AS ZONE X (UNSHADED), AREAS DETERMINED TO BE OUTSIDE THE 0.2% ANNUAL CHANCE FLOODPLAIN.

17. ALL PROPERTY LINES SHOWN ARE FROM PLANS AND DEEDS OF RECORD AND THE CITY OF BRIDGEPORT GIS AND ARE APPROXIMATE ONLY.

18. ABUTTING PROPERTY LINES, ABUTTING STREET LINES AND ABUTTING BUILDING LOCATIONS ARE AS TAKEN FROM THE REFERENCE PLANS, THE CITY OF

19. WETLANDS SHOWN HEREON WERE DELINEATED BY ALL-POINTS TECHNOLOGY

THIS SURVEY HAS BEEN PREPARED PURSUANT TO THE REGULATIONS OF CONNECTICUT STATE AGENCIES SECTIONS 20-300B-1 THROUGH 20-300B-20 AND THE "STANDARDS FOR SURVEYS AND MAPS IN THE STATE OF CONNECTICUT" AS ADOPTED BY THE CONNECTICUT ASSOCIATION OF LAND SURVEYORS INC. ON SEPTEMBER 26, 1997.

TYPE OF SURVEY: IMPROVEMENT LOCATION SURVEY

BOUNDARY SURVEY CATEGORY: DEPENDENT RESURVEY


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NORTHEAST SURVEY CONSULTANTS





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APPROVED BY: CGG

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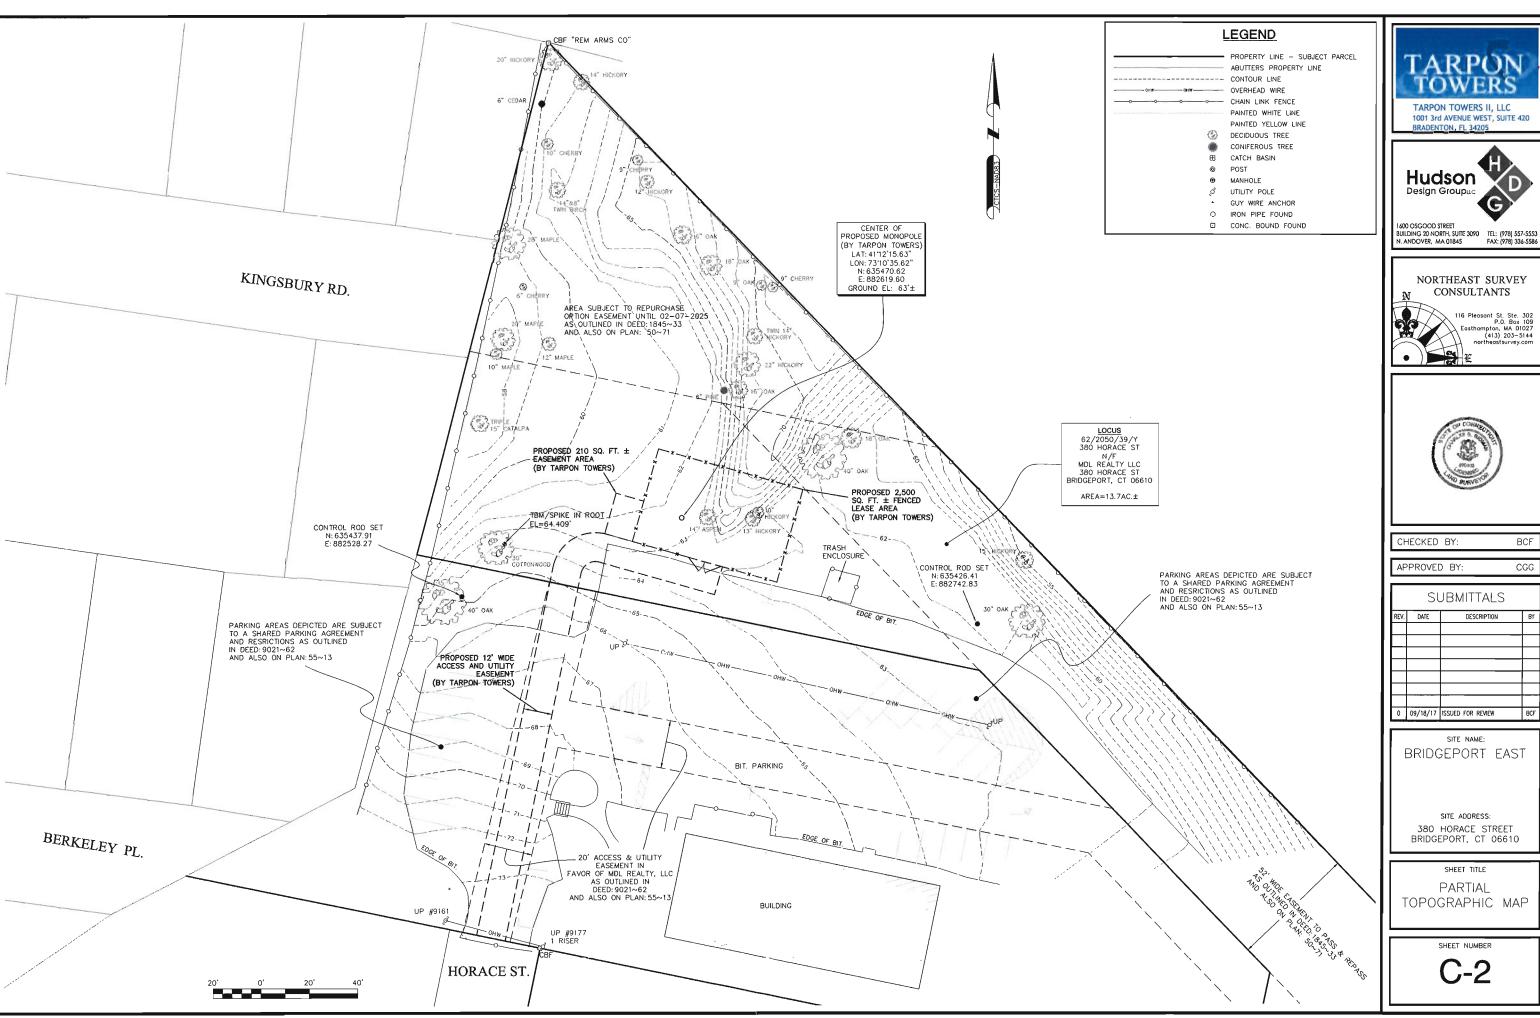
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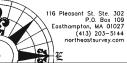
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NORTHEAST SURVEY CONSULTANTS

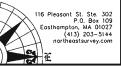



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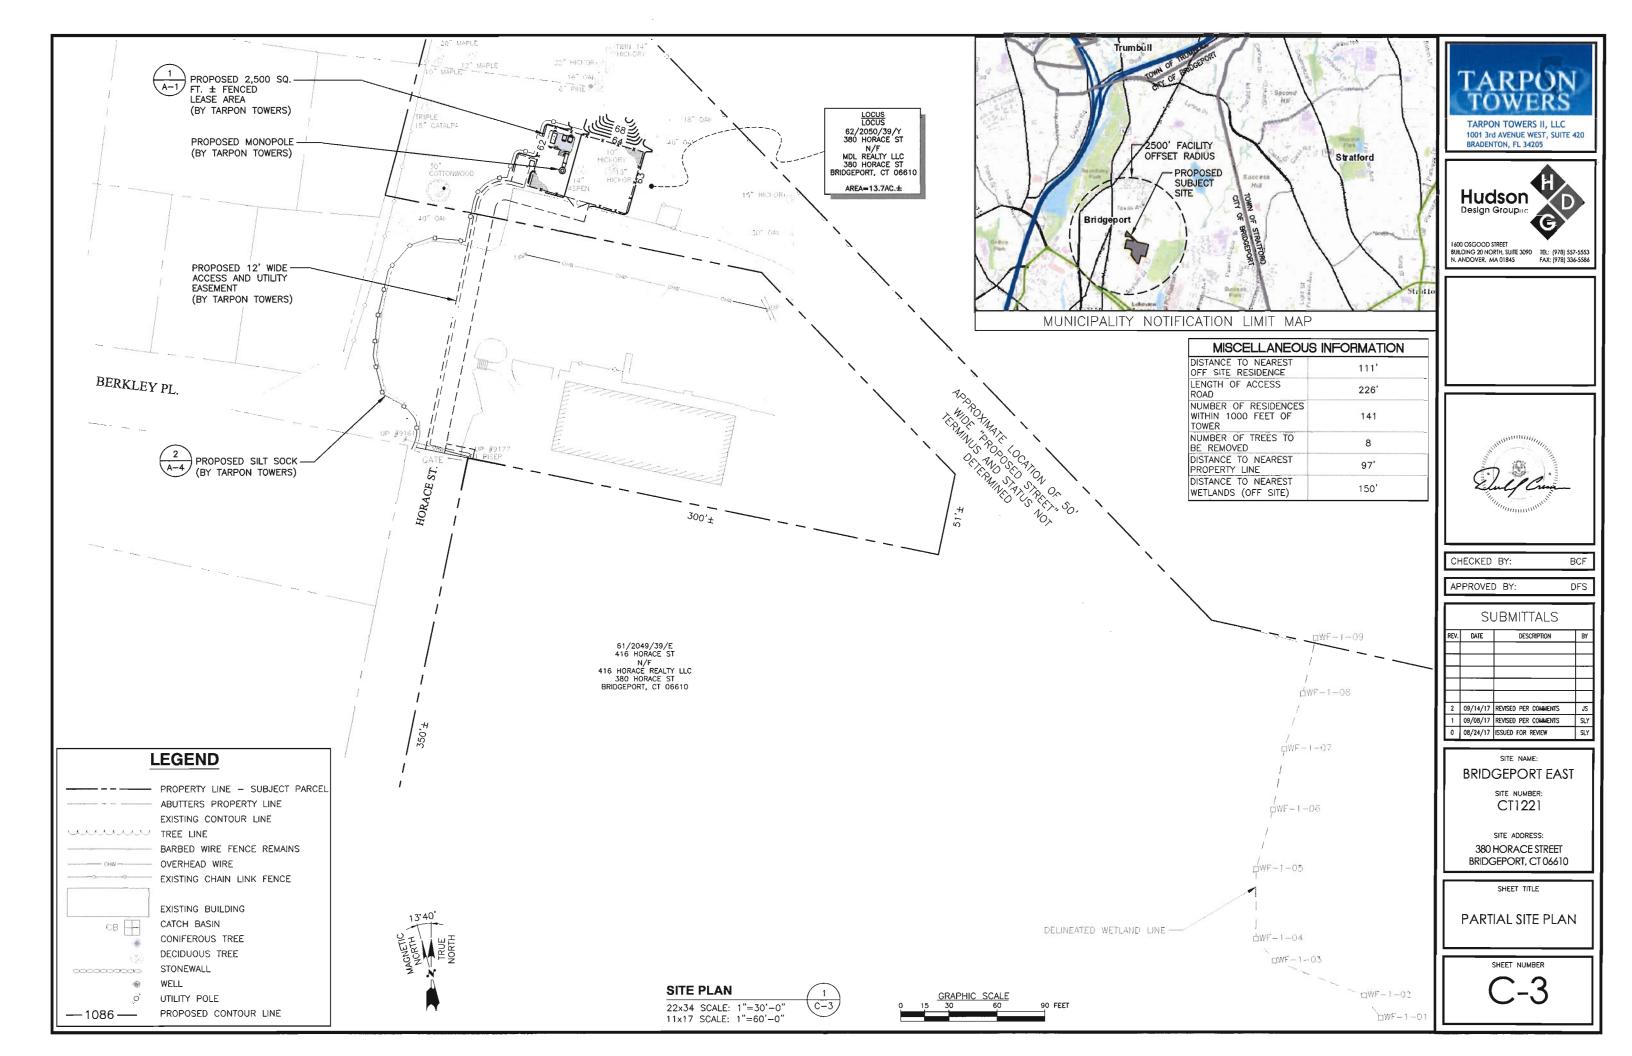
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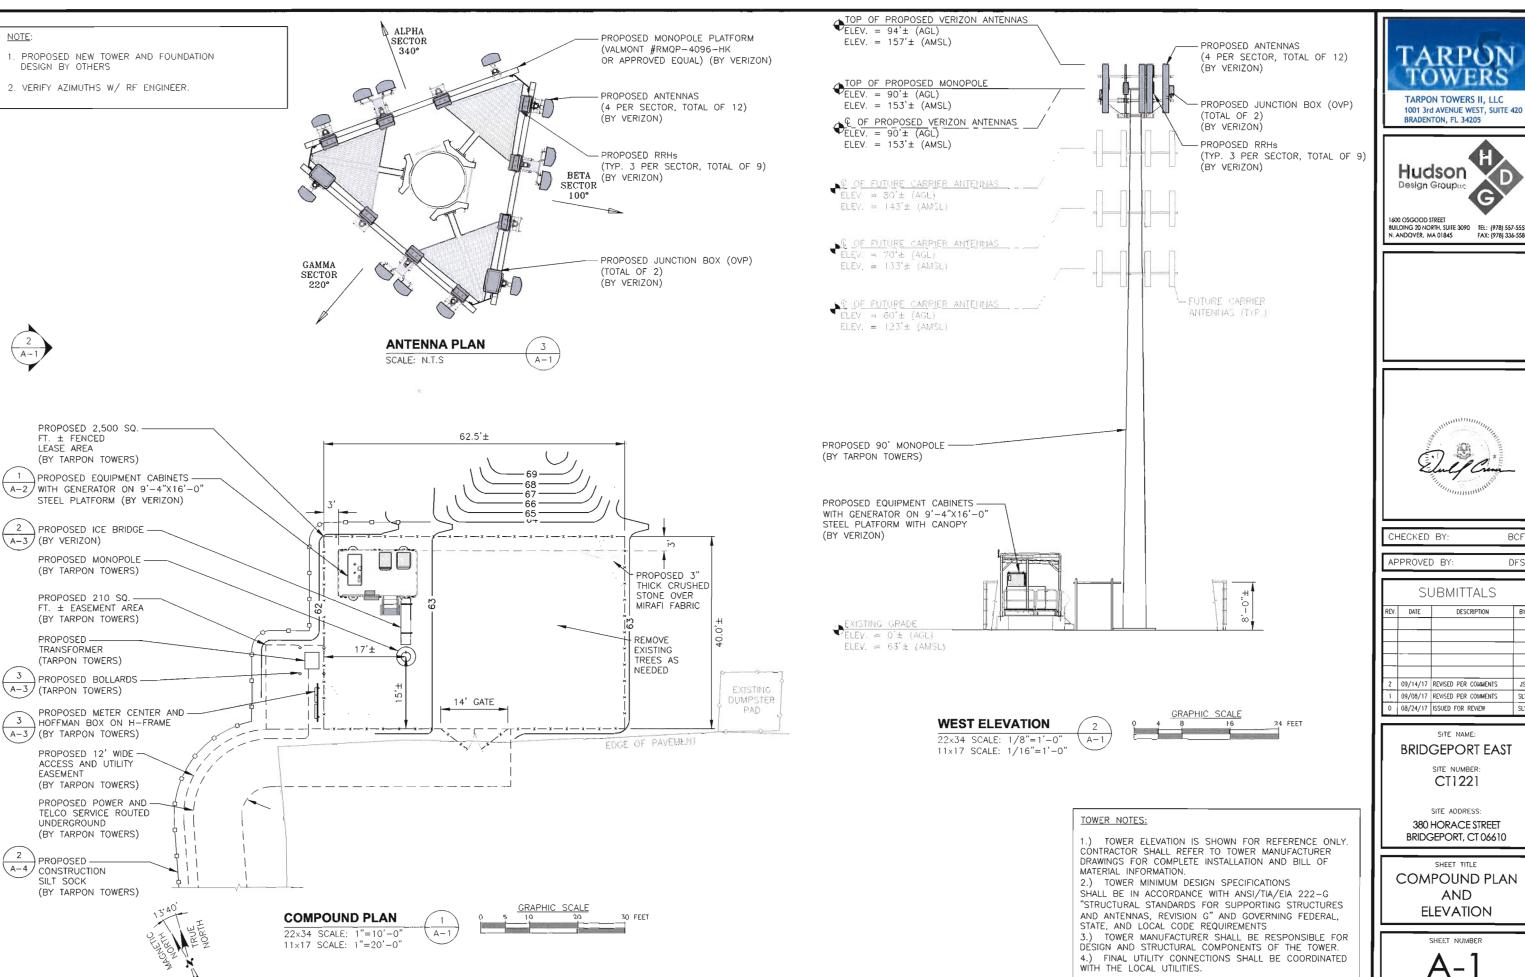
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BRIDGEPORT EAST

380 HORACE STREET BRIDGEPORT, CT 06610

TOPOGRAPHIC MAP







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BRIDGEPORT EAST

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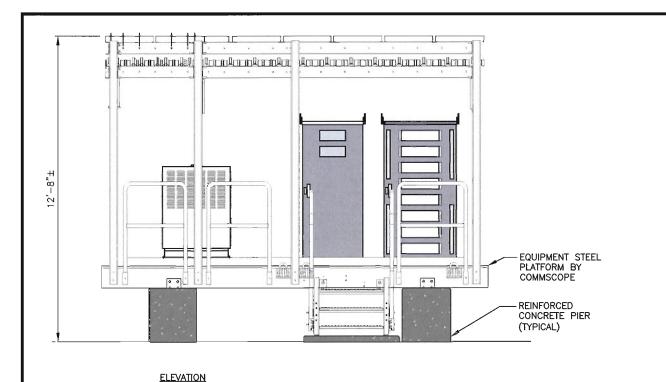
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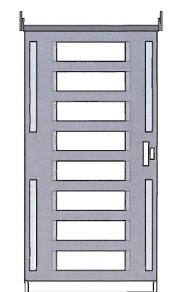
380 HORACE STREET BRIDGEPORT, CT 06610

SHEET TITLE COMPOUND PLAN

AND ELEVATION


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SPECIFICATIONS:
MANUFACTURER: COMMSCOPE
PART NO.: RBA72-36 SIZE: 72"x36"40" WEIGHT: 2,500 LBS

ANCHOR CABINET TO STEEL
PLATFORM PER MANUFACTURERS RECOMMENDATIONS



SCALE: N.T.S

SPECIFICATIONS: MANUFACTURER: COMMSCOPE PART NO.: RBA72-30 SIZE: 72"x30"42" WEIGHT: 740 LBS

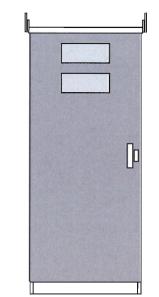
NOTE: ANCHOR CABINET TO STEEL

PLATFORM PER MANUFACTURERS RECOMMENDATIONS



BATTERY CABINET DETAIL


SCALE: N.T.S

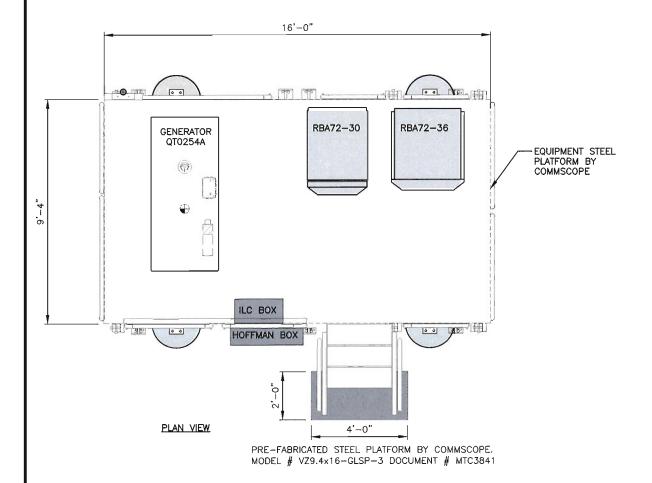

6 FEET

EQUIPMENT PLAN

22x34 SCALE: 1/2"=1'-0" 11x17 SCALE: 1/4"=1'-0"

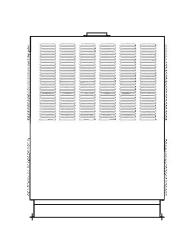

SPECIFICATIONS: MANUFACTURER: GENERAC PART NO.: QT025A SIZE: 77"x34"46" WEIGHT: 1414 LB.

ANCHOR CABINET TO STEEL DUNNAGE OR GRATING PER MANUFACTURERS RECOMMENDATIONS

GENERATOR DETAIL SCALE: N.T.S A-2 BCF

TARPON TOWERS II, LLC 1001 3rd AVENUE WEST, SUITE 420 BRADENTON, FL 34205

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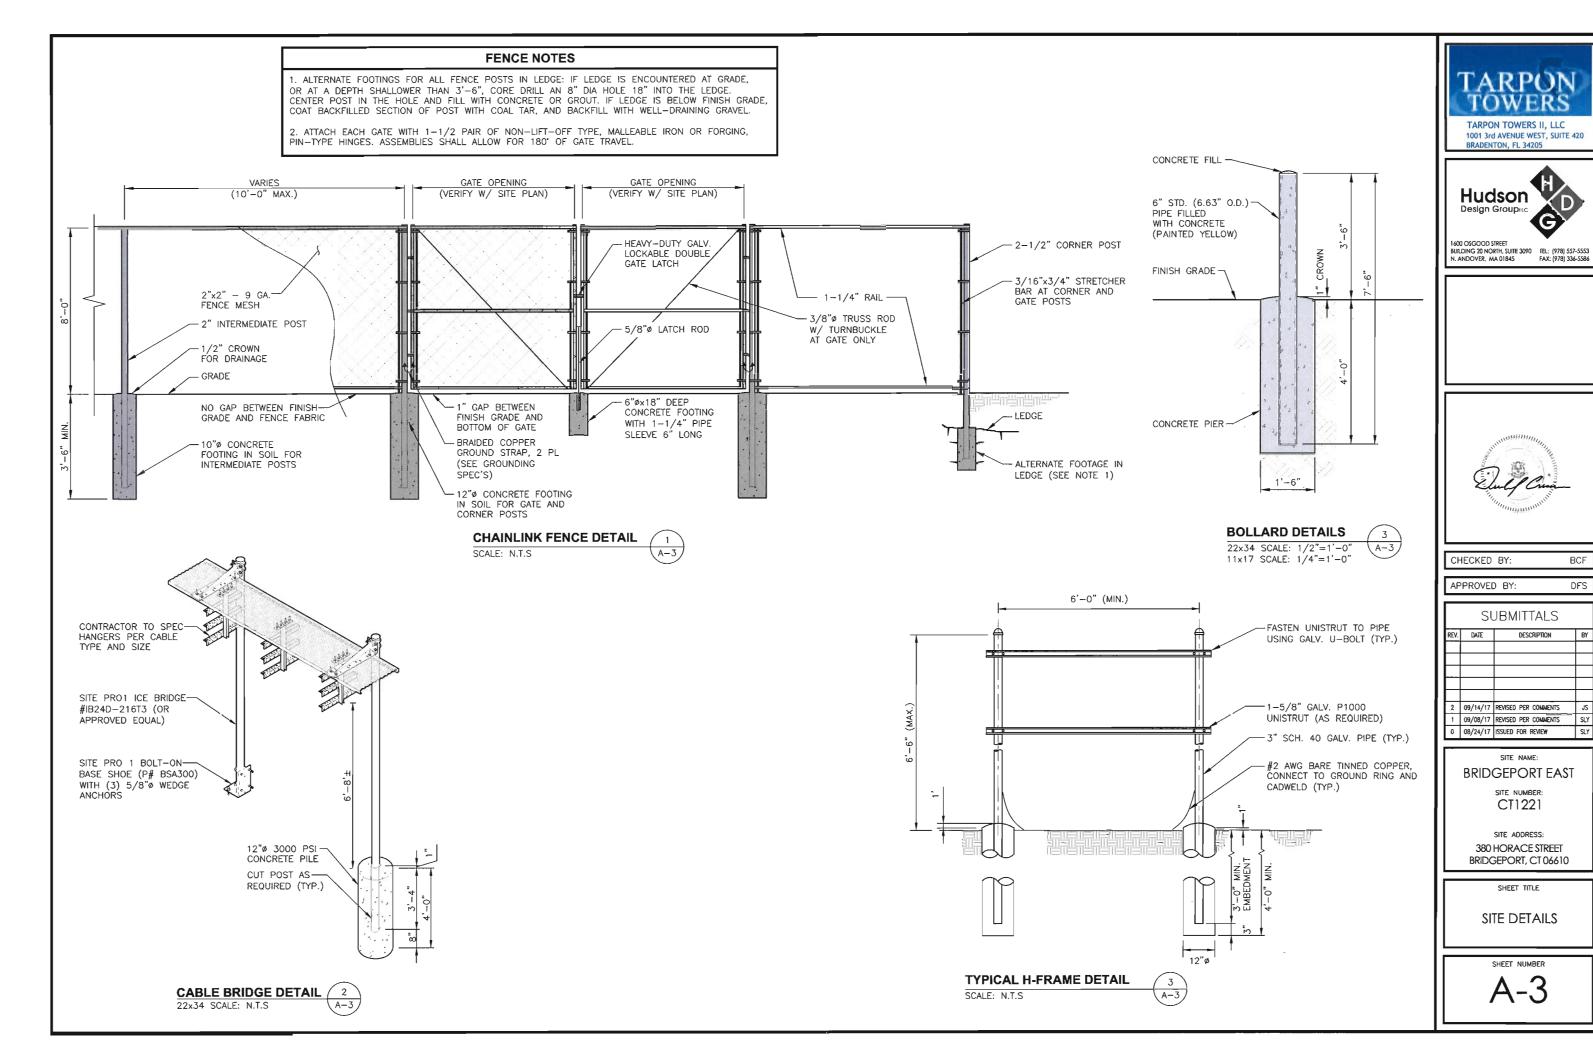
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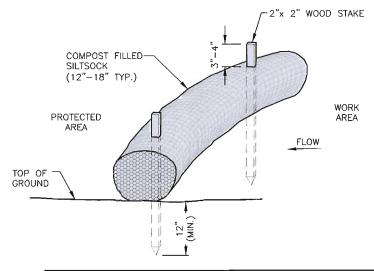
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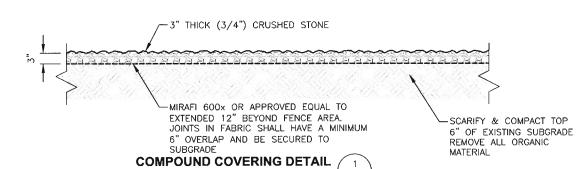
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SHEET TITLE

EQUIPMENT DETAILS







SCALE: N.T.S

NOTES:

- . SILTSOCK SHALL BE FILTREXX SILTSOXX, OR APPROVED EQUAL.
- 2. COMPOST MATERIAL SHALL BE DISPERSED ON SITE, AS DETERMINED BY THE ENGINEER.
- SILTSOCK SHALL BE INSPECTED PERIODICALLY AND AFTER ALL STORM EVENTS, AND REPAIR OR REPLACEMENT SHALL BE PERFORMED PROMPTLY AS NEEDED.
- 4. SEE SPECIFICATIONS FOR SOCK SIZE, AND COMPOST FILL, REQUIREMENTS.



NOTES:

- 1. COMPOST ROLLS MUST BE PLACED ALONG SLOPE CONTOURS.
- 2. STAKES SHOULD BE DRIVEN IN THE MIDDLE OF THE COMPOST LEAVING 2-3 INCHES OF THE STAKE PROTRUDING ABOVE THE COMPOST.
- 3. STAKES SHOULD BE SPACED AT 3'-4' € INTERVALS.
- 4. FIT COMPOST AROUND STORM DRAINS OR INLETS, THE COMPOST SHOULD BE BACK 1-1 1/12 FEET AND SHOULD DIRECT WATER FLOW TOWARD THE ANGLE OF DRAINAGE. IF ALL DRAINAGE ANGLES INTO THE INLET, SNAKE THE COMPOST ALL THE WAY AROUND THE INLET.
- 5. WHEN COMPOST ARE USED FOR FLAT GROUND APPLICATIONS, DRIVE THE STAKES STRAIGHT DOWN; WHEN INSTALLING COMPOST ON SLOPES, DRIVE THE STAKES PERPENDICULAR TO THE SLOPE.
- USE 18" LONG STAKES FOR HARD, ROCKY SOIL. FOR SOFT, LOAMY SOIL, USE 24" STAKE FOR GREATER SECURITY.





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BRIDGEPORT EAST

SITE NUMBER: CT1221

SITE ADDRESS: 380 HORACE STREET BRIDGEPORT, CT 06610

SHEET TITLE

EROSION CONTROL
AND DETAILS

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