# **ATTACHMENT 3**

#### ATTACHMENT 3

#### **General Facility Description**

63 Woodland Street
(Map G11, Block 7800, Lot W0002)
Glastonbury, Connecticut
Owner: Paul Cavanna
177.10 Acre Parcel

The proposed tower site is located on an approximately 177.10 acre parcel located at 63 Woodland Street and owned by Paul Cavanna. It is classified in the Rural Residence – Agricultural Zoning District and is improved with two residences, agricultural farm fields and several out buildings. The proposed telecommunications facility includes an approximately 10,000 s.f. lease area located in the south western section of the host parcel.

The facility consists of a new self-supporting monopole tower 150' in height, with a 5' lightning rod on top extending to an overall height of 155' AGL. T-Mobile would install up to nine (9) panel antennas, one (1) dish antenna and related equipment at a centerline height of 146' above grade level (AGL). The tower would be designed for future shared use of the structure by other FCC licensed wireless carriers. T-Mobile equipment cabinets would be installed on a proposed 10' x 20' concrete equipment pad within the tower compound with separate space for a proposed backup power generator.

The tower compound would consist of a 2,500 s.f area to accommodate T-Mobile's equipment and provide for future shared use of the facility by other carriers. The tower compound would be enclosed by a six (6) foot high chain link fence with an additional one (1) foot of barbed wire at the top for security purposes (remote location). Vehicle access to the facility would be provided from Woodland Street over an existing farm driveway a distance of approximately 4,100' and a proposed 12' wide gravel access driveway approximately 400' to the proposed compound. The final approach to the compound is being finalized as the underlying property owner requested a shift in its final location as provided in the "Alternate Road Configuration Map" after the prepared drawings included in Attachment 3. Utility connections would be routed along the access easement from an existing utility pole located at Woodland Street.

#### **SITE AND FACILITY DESCRIPTION**

#### I. LOCATION

- A. COORDINATES: 41° 39' 38.9" N 72° 34' 26.8" W
- B. GROUND ELEVATION: 319'± AMSL
- C. USGS MAP: USGS 7.5 Quadrangle for Glastonbury, CT
- D. SITE ADDRESS: 63 Woodland Street, Glastonbury, CT 06073
- E. ZONING WITHIN 1/4 MILE OF SITE: Abutting areas are zoned residential, commercial and industrial.


#### II. DESCRIPTION

- A. SITE SIZE: 177.10 acres (VOL 973, PAGE 350)
- B. LEASE AREA/COMPOUND AREA: 10,000 SF/2,500 S.F.
- C. TOWER TYPE/HEIGHT: 150' AGL Monopole
- D. SITE TOPOGRAPHY AND SURFACE: Subject site is located on a large 177+ acre parcel that slopes down from the east. The Parcel is agricultural in use with a farm house, out buildings, farm fields, and wooded areas of land.
- E. SURROUNDING TERRAIN, VEGETATION, WETLANDS, OR

WATER: There are no wetlands within 1,600+ feet of the tower site a nor within its immediate proximity.

F. LAND USE WITHIN 1/4 MILE OF SITE: A mixture of agricultural, municipal (industrially zoned former mill) and residential land uses

Figure 5: Glastonbury GIS Compilation Map

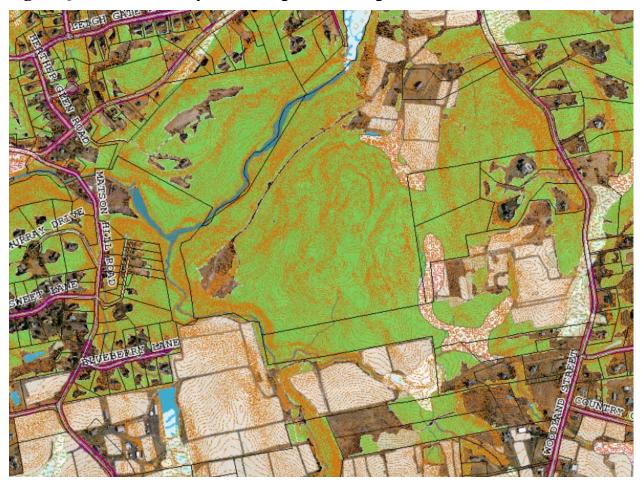

#### III. FACILITIES

A. POWER COMPANY: Eversource

B. POWER PROXIMITY TO SITE: 4,500'±

C. TELEPHONE COMPANY: Frontier

D. PHONE SERVICE PROXIMITY: 4,500'±

E. VEHICLE ACCESS TO SITE: Proposed 20' access easement to the site will be from Woodland Street, over an existing 4,100' access drive and a proposed 400' gravel access drive to tower compound. The final approach to the compound is being finalized as the underlying property owner requested a shift in its final location as provided in the "Alternate Road Configuration Map" after the prepared drawings included in Attachment 3.

F. OBSTRUCTION: None known at this time.

G. AREA OF DISTURBANCE: Total area of disturbance is approximately 18,000 s.f., approximately 50 trees above 6" diameter will need to be removed.

#### IV. LEGAL

A. PURCHASE [] LEASE [X]

B. OWNER: Paul Cavanna

C. ADDRESS: 80 Woodland Street

Glastonbury, CT 06073

D. DEED ON FILE AT: VOLUME 973, PAGE 350

#### **Facilities and Equipment Specification**

#### I. TOWER SPECIFICATIONS:

A. MANUFACTURER: To be determined

B. TYPE: Self-Supporting monopole tower

C. HEIGHT: 150' AGL (with 5' lightning rod extending to 155')

DIMENSIONS: Tower structure tapered/

D. TOWER LIGHTING: None required.

#### II. TOWER LOADING:

- A. T-Mobile up to 9 panel antennas
  - a. Model TBD
  - b. Antenna Dimensions approximately 96"H x 12"W x 9"D
  - c. Position on Tower 146' centerline AGL
  - d. Transmission Lines DC, Fiber and RET lines internal to tower.
  - e. (9) Remote Radio Units behind antennas on proposed pipe mounts
  - f. (1) Microwave dish 2' diameter on proposed pipe mount
- B. Future Carriers To be determined

#### III. ENGINEERING ANALYSIS AND CERTIFICATION:

The tower will be designed in accordance with American National Standards Institute TIA/EIA-222-F "Structural Standards for Steel Antenna Towers and Antenna Support Structures" and the 2003 International Building Code with 2005 Connecticut Amendment. The foundation design would be based on soil conditions at the site. The details of the tower and foundation design will be provided as part of the final D&M plan.

#### PROJECT DESCRIPTION:

CONSTRUCTION OF TELECOMMUNICATION AND PUBLIC UTILITY FACILITY, CONSISTING OF A MONOPOLE TOWER, SPACE FOR CARRIER EQUIPMENT AND A UTILITY BACKBOARD WITHIN A FENCED COMPOUND. NO WATER OR SEWER IS REQUIRED.

#### CODE COMPLIANCE:

ALL WORK AND MATERIALS SHALL BE PERFORMED AND INSTALLED IN ACCORDANCE WITH THE CURRENT EDITIONS OF THE FOLLOWING CODES AS ADOPTED BY THE LOCAL GOVERNING AUTHORITIES. NOTHING IN THESE PLANS IS TO BE CONSTRUED TO PERMIT WORK NOT CONFORMING TO THE LATEST EDITIONS OF THE FOLLOWING:

Hockanum

Wethersfield

CONNECSITE

Hopewell

Cromwell

South

MIDDLESEX

Glastor oury

Bald Hill Range

Elmwood

Newington

Wethersfield

HARTFORD.

SITE ADDRESS:

ZONING JURISDICTION:

MAP/STREET/LOT:

LATITUDE:

LONGITUDE:

ELEVATION:

CONSTRUCTION AREA:

APPROXIMATE, NOT BASED ON 1A SURVEY

ZONING CLASSIFICATION:

160)

East

Berlin

South

Rocky Hill

- 1. CT BUILDING CODE
- 2. UNIFORM BUILDING CODE 3. BUILDING OFFICIALS AND CODE
- ADMINISTRATORS (BOCA) 4. UNIFORM MECHANICAL CODE
- 5. ANSI/TIA/EIA-222-G
- 8. LOCAL BUILDING CODE 9. CITY/COUNTY ORDINANCES

Forest Village

East Hartford Gardens

Addison

East Glastonbury

Terramuggus

Marlborough

Lake

6. UNIFORM PLUMBING CODE NATIONAL ELECTRIC CODE

Bolton

TO

ND

# Eco-Site





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2	REVISED PER COMMENTS	SKB	8/23/17
1	REVISED ACCESS DRIVE	SKB	12/15/16
0	FOR POWER CO. REVIEW	AJD	9/7/16
No.	Submittal / Revision	App'd	Date
Drawn: AJD Date: 9/7/16			
Designed: AJD Date: 9/7/16			

hecked: AJD Date: 9/7/16 roject Number

roject Title:

**GLASTONBURY** 

CT-0007

63-80 WOODLAND STREET GLASTONBURY, CT 06073



rawing Title:

TITLE SHEET

Drawing Scale:

awing Number:

Date: 8/23/17

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T1

# **GLASTONBURY** 63-80 WOODLAND STREET GLASTONBURY, CT 06073

# 150' MONOPOLE TOWER

DRAWING INDEX					
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Z2B	NEAREST MUNICIPALITY MAP	2	8/23/17		
Z2C	WETLAND & WETLAND TYPE SOILS MAP	2	8/23/17		
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Z7	UTILITY RACK DETAIL	2	8/23/17		
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EC1	GRADING & EROSION CONTROL NOTES	2	8/23/17		
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EC3	GRADING PLAN CONTINUED	2	8/23/17		
EC4	GRADING PLAN CONTINUED	2	8/23/17		

Hopewell	DIEWE R. SITE
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PROJECT DIRECTORY				
PROPERTY OWNER:	PAUL CAVANNA 80 WOODLAND STREET GLASTONBURY, CT 06073			
APPLICANT:	ECO-SITE 240 LEIGHT FARM ROAD, SUITE 415 DURHAM, NC 03867			
CONTACT:	COLLEEN CARROLL PHONE: (919) 246–8652			
SITE ACQUISITION:	AIROSMITH DEVELOPMENT 28 CLINTON STREET SARATOGA SPRINGS, NY 12866			
CONTACT:	JON TERRY PHONE: (518) 858-3494			
ENGINEER:	INFINIGY 1033 WATERVLIET SHAKER ROAD ALBANY, NY 12210			
CONTACT:	AJ DESANTIS PHONE: (518) 690-0790			
POWER COMPANY:	EVERSOURCE			
TELCO COMPANY:	SOUTHERN NEW ENGLAND TELCO			

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OWER COMPANY:	EVERSOURCE			
LCO COMPANY:	SOUTHERN NEW ENGLAND TELCO			

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N.7.					
APPROVAL	BLOCK			VED	
PROPERTY OWNER	DATE	APPROVED	APPROVED AS NOTED	DISAPPROVED / REVISE	
PROJECT MANAGER	DATE				
DIRECTOR OF OPERATIONS	DATE				

#### Gildersleeve Fogelmarks Pocotopaug Portland **East Hampton** VICINITY MAP N.T.S. PROJECT INFORMATION GLASTONBURY SITE NAME:

63-80 WOODLAND STREET GLASTONBURY, CT 06073

CONNECTICUT SITING COUNCIL

G11/7800/W0002 PID: 1451

50,000 SQFT. (1.15 ACRES)

41° 39' 38.9" N\*

72° 34' 26.8" W\*

±319' AMSL\*

RURAL RESIDENCE - AGRICULTURAL USE

#### **GENERAL NOTES**

- 1. ALL DIMENSIONS TO, OF, AND ON EXISTING BUILDINGS, DRAINAGE STRUCTURES, AND SITE IMPROVEMENTS SHALL BE VERIFIED IN FIELD BY CONTRACTOR WITH ALL DISCREPANCIES REPORTED TO THE ENGINEER.
- 2. DO NOT CHANGE SIZE NOR SPACING OF STRUCTURAL ELEMENTS.
- 3. DETAILS SHOWN ARE TYPICAL; SIMILAR DETAILS APPLY TO SIMILAR CONDITIONS UNLESS OTHERWISE NOTED.
- 4. THESE DRAWINGS DO NOT INCLUDE NECESSARY COMPONENTS FOR CONSTRUCTION SAFETY.
- 5. BRACE STRUCTURES UNTIL ALL STRUCTURAL ELEMENTS NEEDED FOR STABILITY ARE INSTALLED. THESE ELEMENTS ARE AS FOLLOWS: LATERAL BRACING, ANCHOR BOLTS, ETC.
- 6. DETERMINE EXACT LOCATION OF EXISTING UTILITIES, GROUNDS DRAINS, DRAIN PIPES, VENTS, ETC. BEFORE COMMENCING WORK.
- 7. INCORRECTLY FABRICATED, DAMAGED, OR OTHERWISE MISFITTING OR NONCONFORMING MATERIALS OR CONDITIONS SHALL BE REPORTED TO THE OWNER PRIOR TO REMEDIAL OR CORRECTIVE ACTION. ANY SUCH ACTION SHALL REQUIRE APPROVAL
- 8. EACH CONTRACTOR SHALL COOPERATE WITH THE OWNER'S REPRESENTATIVE. AND COORDINATE HIS WORK WITH THE WORK OF OTHERS.
- 9. IT IS THE CONTRACTOR'S RESPONSIBILITY TO EXAMINE ALL PLAN SHEETS
  AND SPECIFICATIONS AND COORDINATE HIS WORK WITH THE WORK OF ALL CONTRACTORS TO ENSURE THAT WORK PROGRESSION IS NOT
- 10. THE CONTRACTOR IS RESPONSIBLE FOR MAINTAINING A NEAT AND ORDERLY SITE, YARD AND GROUNDS. REMOVE AND DISPOSE OFF SITE ALL RUBBISH, WASTE MATERIALS, LITTER, AND ALL FOREIGN SUBSTANCES. REMOVE PETRO-CHEMICAL SPILLS, STAINS AND OTHER FOREIGN DEPOSITS. RAKE GROUNDS TO A SMOOTH EVEN-TEXTURED SURFACE.
- 11. THE PLANS SHOW SOME KNOWN SUBSURFACE STRUCTURES, ABOVE-GROUND STRUCTURES AND/OR UTILITIES BELIEVED TO EXIST IN THE WORKING AREA, EXACT LOCATION OF WHICH MAY VARY FROM THE LOCATIONS INDICATED. IN PARTICULAR, THE CONTRACTOR IS WARNED THAT THE EXACT OR EVEN APPROXIMATE LOCATION OF SUCH PIPELINES, SUBSURFACE STRUCTURES AND/OR UTILITIES IN THE AREA MAY BE SHOWN OR MAY NOT BE SHOWN; AND IT SHALL BE HIS RESPONSIBILITY TO PROCEED WITH GREAT CARE IN EXECUTION OF THE PROPERTY OF THE PROPERT EXECUTING ANY WORK. 48 HOURS BEFORE YOU DIG, DRILL OR BLAST, CALL 1-800-922-4455.
- 12. THE OWNER OR OWNER'S REPRESENTATIVE SHALL BE NOTIFIED IN WRITING OF ANY CONDITIONS THAT VARY FROM THOSE SHOWN ON THE PLANS.
  THE CONTRACTOR'S WORK SHALL NOT VARY FROM THE PLANS WITHOUT THE EXPRESSED APPROVAL OF THE OWNER OR OWNER'S REPRESENTATIVE.
- 13. THE CONTRACTOR IS INSTRUCTED TO COOPERATE WITH ANY AND ALL OTHER CONTRACTORS PERFORMING WORK ON THIS JOB SITE DURING THE PERFORMANCE OF THIS CONTRACT.
- 14. THE CONTRACTOR SHALL RESTORE ALL PUBLIC OR PRIVATE PROPERTY DAMAGED OR REMOVED TO AT LEAST AS GOOD OF CONDITION AS BEFORE DISTURBED AS DETERMINED BY THE OWNER OR OWNER'S REPRESENTATIVE
- 15. THE CONTRACTOR SHALL COMPLY WITH ALL REQUIRED PERMITS.
- 16. THE CONTRACTOR SHALL BE RESPONSIBLE FOR OBTAINING, AND INCURRING THE COST OF ALL REQUIRED PERMITS. INCLUDING. BUT NOT LIMITED TO, THE BUILDING PERMIT, INSPECTIONS, CERTIFICATES, ETC.
- 17. THE CONTRACTOR SHALL PROTECT EXISTING PROPERTY LINE MONUMENTATION. ANY MONUMENTATION DISTURBED OR DESTROYED, AS JUDGED BY THE OWNER OR OWNER'S REPRESENTATIVE SHALL BE REPLACED AT THE CONTRACTOR'S EXPENSE UNDER THE SUPERVISION OF A LICENSED LAND SURVEYOR.
- 18. ALL TRENCH EXCAVATION AND ANY REQUIRED SHEETING AND SHORING SHALL BE DONE IN ACCORDANCE OSHA REGULATIONS FOR CONSTRUCTION.
- CONTRACTOR SHALL BE RESPONSIBLE FOR DEWATERING AND THE MAINTENANCE OF SURFACE DRAINAGE DURING THE COURSE OF WORK.
- 20. ALL UTILITY WORK INVOLVING CONNECTIONS TO EXISTING SYSTEMS SHALL BE COORDINATED WITH THE OWNER OR OWNER'S REPRESENTATIVE AND THE UTILITY OWNER. NOTIFY THE OWNER OR OWNER'S REPRESENTATIVE AND THE UTILITY OWNER BEFORE EACH AND EVERY CONNECTION TO EXISTING SYSTEMS IS MADE.
- 21. MAINTAIN FLOW FOR ALL EXISTING UTILITIES.
- 22. ALL SITE FILL SHALL MEET SELECTED FILL STANDARDS AS DEFINED BY THE OWNER OR OWNER'S REPRESENTATIVE ON THE DRAWINGS.
- 23. CONTRACTOR SHALL GRADE ALL AREAS ON THE SITE TO PROVIDE POSITIVE DRAINAGE AWAY FROM THE EQUIPMENT PAD AND THE TOWER.
- 24. ALL IMPROVEMENTS TO CONFORM WITH LOCAL JURISDICTION CONSTRUCTION STANDARDS AND SPECIFICATIONS, LATEST EDITION.

#### STRUCTURAL STEEL NOTES

- 1. STRUCTURAL STEEL SHALL CONFORM TO THE LATEST EDITION OF THE AISC "SPECIFICATION FOR THE DESIGN, FABRICATION AND ERECTION OF STRUCTURAL STEEL FOR BUILDINGS"
- 2. ALL INTERIOR STRUCTURAL STEEL USED SHALL BE, WHEN DELIVERED, FINISHED WITH ONE COAT FABRICATOR'S NON-LEAD, RED OXIDE PRIMER. PRIMING SHALL BE PERFORMED AFTER SHOP FABRICATION TO THE GREATEST EXTENT POSSIBLE. ALL DINGS, SCRAPES, MARS, AND WELDS IN THE PRIMED AREAS SHALL BE REPAIRED BY FIELD TOUCH-UP PRIOR TO COMPLETION OF THE WORK.
- 3. ALL EXTERIOR STEEL WORK SHALL BE GALVANIZED IN ACCORDANCE WITH SPECIFICATION ASTM A36 UNLESS OTHERWISE NOTED. GALVANIZING SHALL BE PERFORMED AFTER SHOP FABRICATION TO THE GREATEST EXTENT POSSIBLE. ALL DINGS, SCRAPES, MARS, AND WELDS IN THE GALVANIZED AREAS SHALL BE REPAIRED BY FIELD TOUCH-UP PRIOR TO COMPLETION OF THE WORK.
- 4. DO NOT PLACE HOLES THROUGH STRUCTURAL STEEL MEMBERS EXCEPT AS SHOWN AND DETAILED ON STRUCTURAL DRAWINGS.
- A. ALL WELDING SHALL BE DONE USING E70XX ELECTRODES AND WELDING SHALL CONFORM TO AISC AND AWS D1.1. WHERE FILLET WELD SIZES ARE NOT SHOWN, PROVIDE THE MINIMUM SIZE PER TABLE J2.4 IN THE AISC "MANUAL OF STEEL CONSTRUCTION ", 9TH EDITION. AT THE COMPLETION OF WELDING, ALL DAMAGE TO GALVANIZED COATING SHALL BE REPAIRED.
- B. BOLTED CONNECTIONS SHALL USE BEARING TYPE GALVANIZED ASTM A325 BOLTS (3/4" DIA) AND SHALL HAVE MINIMUM OF TWO BOLTS UNLESS NOTED OTHERWISE.
- C. NON-STRUCTURAL CONNECTIONS FOR STEEL GRATING MAY USE 5/8" DIA. GALVANIZED ASTM A 307 BOLTS UNLESS NOTED OTHERWISE.
- D. CONNECTION DESIGN BY FABRICATOR WILL BE SUBJECT TO REVIEW AND APPROVAL BY FNGINFFR.

#### DESIGN DATA

1. WIND LOADS: PER EIA/TIA G-222 ICE LOADS: 1/2" RADÍAL ON ALL COMPONENTS & CABLE SNOW LOAD: PER CT STATE BLDG. CODE. SEISMIC LOADS: PER CT STATE BLDG CODE.

#### **CONCRETE NOTES**

- 1. DESIGN AND CONSTRUCTION OF ALL CONCRETE ELEMENTS SHALL CONFORM TO THE LATEST EDITIONS OF THE FOLLOWING APPLICABLE CODES: ACI 301 "SPECIFICATIONS FOR STRUCTURAL CONCRETE FOR BUILDINGS": ACI 318. "BUILDING CODE REQUIREMENTS FOR REINFORCED CONCRETE";
- 2. MIX DESIGN SHALL BE APPROVED BY OWNER'S REPRESENTATIVE PRIOR TO PLACING CONCRETE.
- 3. CONCRETE SHALL BE NORMAL WEIGHT, 6% AIR ENTRAINED (±1.5%) WITH A MAXIMUM 4" SLUMP, AND HAVE A MINIMUM 28-DAY COMPRESSIVE STRENGTH OF 3000 PSI UNLESS OTHERWISE NOTED.
- 4. MAXIMUM AGGREGATE SIZE SHALL BE 1".
- 5. THE FOLLOWING MATERIALS SHALL BE USED:

PORTLAND CEMENT: ASTM C 150, TYPE I REINFORCEMENT: ASTM A 185 NORMAL WEIGHT AGGREGATE: WATER ADMIXTURES:

ASTM C 33 DRINKABLE NON-CHLORIDE CONTAINING

- 6. REINFORCING DETAILS SHALL BE IN ACCORDANCE WITH THE LATEST EDITION OF ACI 315.
- 7. REINFORCING STEEL SHALL CONFORM TO ASTM A 615, GRADE 60, DEFORMED UNLESS NOTED OTHERWISE. WELDED WIRE FABRIC SHALL CONFORM TO ASTM A 185 WELDED STEEL WIRE FABRIC UNLESS NOTED OTHERWISE. SPLICES SHALL BE CLASS "B" AND ALL HOOKS SHALL BE STANDARD, UNO.
- 8. THE FOLLOWING MINIMUM CONCRETE COVER SHALL BE PROVIDED FOR REINFORCING STEEL UNLESS SHOWN OTHERWISE ON DRAWINGS:

CONCRETE CAST AGAINST FARTH.................................. IN

CONCRETE EXPOSED TO EARTH OR WEATHER: #6 AND LARGER ... ..2 IN.

#5 AND SMALLER & WWF ......1 1/2 IN.

CONCRETE NOT EXPOSED TO EARTH OR WEATHER OR NOT CAST AGAINST THE GROUND: .....3/4 IN. SLAB AND WALL ..... BEAMS AND COLUMNS .....

- 9. A CHAMFER 3/4" SHALL BE PROVIDED AT ALL EXPOSED EDGES OF CONCRETE, UNO, IN ACCORDANCE WITH ACI 301 SECTION 4.2.4.

  10. INSTALLATION OF CONCRETE EXPANSION/WEDGE ANCHOR, SHALL BE PER
- MANUFACTURES WRITTEN RECOMMENDED PROCEDURE. THE ANCHOR BOLT, DOWEL OR ROD SHALL CONFORM TO MANUFACTURER'S RECOMMENDATION FOR EMBEDMENT DEPTH OR AS SHOWN ON THE DRAWINGS. NO REBAR SHALL BE CUT WITHOUT PRIOR ENGINEERING APPROVAL WHEN DRILLING HOLES IN CONCRETE.
- 11. CURING COMPOUNDS SHALL CONFORM TO ASTM C-309.
- 12. ADMIXTURES SHALL CONFORM TO THE APPROPRIATE ASTM STANDARD AS REFERENCED

**EXISTING** 

- 13. DO NOT WELD OR TACKWELD REINFORCING STEEL.
  14. ALL DOWELS, ANCHOR BOLTS, EMBEDDED STEEL, ELECTRICAL CONDUITS, PIPE SLEEVES, GROUNDS AND ALL OTHER EMBEDDED ITEMS AND FORMED DETAILS SHALL BE IN PLACE BEFORE START OF CONCRETE PLACEMENT.
- 15. LOCATE ADDITIONAL CONSTRUCTION JOINTS REQUIRED TO FACILITATE CONSTRUCTION AS ACCEPTABLE TO ENGINEER. PLACE REINFORCEMENT CONTINUOUSLY THROUGH JOINT.
- 16. REINFORCEMENT SHALL BE COLD BENT WHENEVER BENDING IS REQUIRED
- 17. PLACE CONCRETE IN A UNIFORM MANNER TO PREVENT THE FORMATION OF COLD JOINTS AND OTHER PLANES OF WEAKNESS. VIBRATE THE CONCRETE TO FULLY EMBED REINFORCING. DO NOT USE VIBRATORS TO TRANSPORT CONCRETE THROUGH CHUTES OR FORMWORK.
- 18. DO NOT PLACE CONCRETE IN WATER, ICE, OR ON FROZEN GROUND.
- 19. DO NOT ALLOW CONCRETE SUBBASE TO FREEZE DURING CONCRETE CURING AND SETTING PERIOD, OR FOR A MINIMUM OF 14 DAYS AFTER PLACEMENT.
- 20. FOR COLD-WEATHER AND HOT-WEATHER CONCRETE PLACEMENT, CONFORM TO APPLICABLE ACI CODES AND RECOMMENDATIONS. IN EITHER CASE, MATERIALS CONTAINING CHLORIDE, CALCIUM, SALTS, ETC. SHALL NOT BE USED. PROTECT FRESH CONCRETE FROM WEATHER FOR 7 DAYS MINIMUM.

## CIVII LEGEND

PROPOSED

	FENCE	
UNDERGROUND ELECTRIC	UNDERGROUND ELECTRIC	
UNDERGROUND TELEPHONE	UNDERGROUND TELEPHONE	
OVERHEAD WIRES (	OVERHEAD TELEPHONE	
——	OVERHEAD ELECTRIC	
250	5' OR 10' CONTOUR LINE	250
	1' OR 2' CONTOUR LINE	202
120.5 OR ×	SPOT ELEVATION	120.5 OR x
	PRIMARY PROPERTY OR R.O.W.	
	LEASE LINE	
	EASEMENT	
	UTILITY POLE	Ø
	TELEPHONE PEDESTAL	
	CURB	
	ASPHALT PAVEMENT	
	BUILDING	
	TREES, SHRUBS, BUSHES	<b>⊕</b>
X		



	_	
REVISED PER COMMENTS	SKB	8/23/17
REVISED ACCESS DRIVE	SKB	12/15/16
FOR POWER CO. REVIEW	AJD	9/7/16
Submittal / Revision	App'd	Date
wn:AJD Date	. 9	/7/16
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**GLASTONBURY** 

CT-0007

63-80 WOODLAND STREET GLASTONBURY, CT 06073



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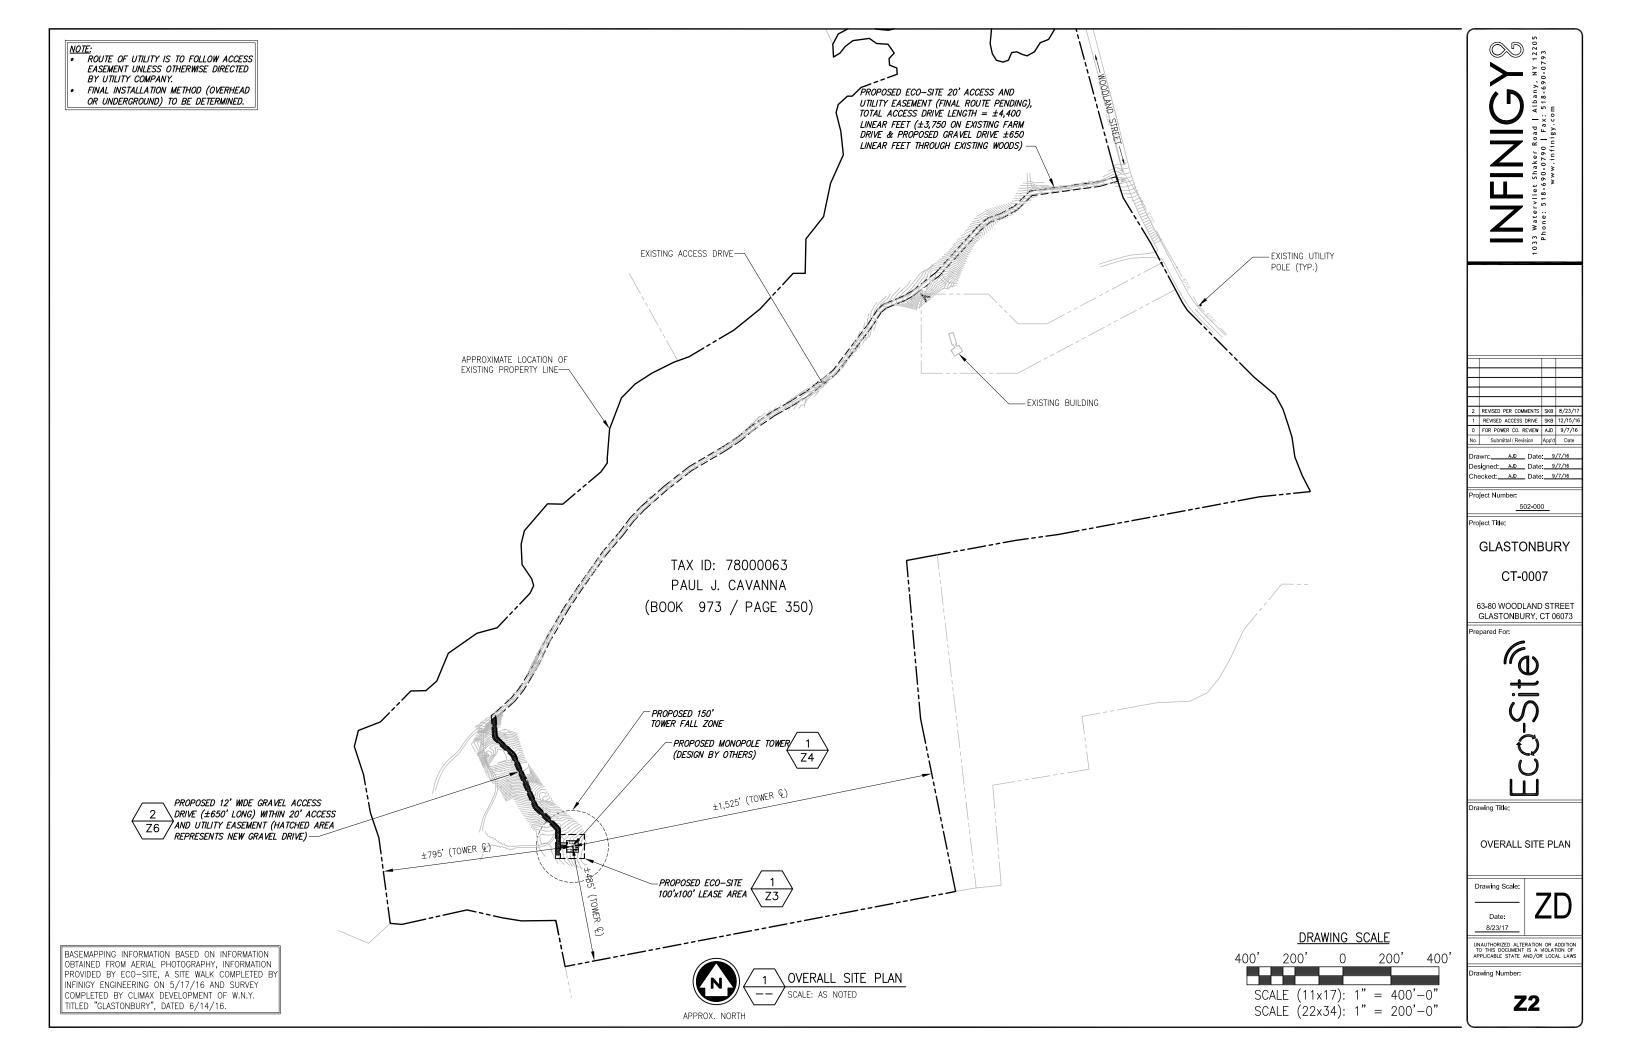
**GENERAL NOTES** & LEGEND

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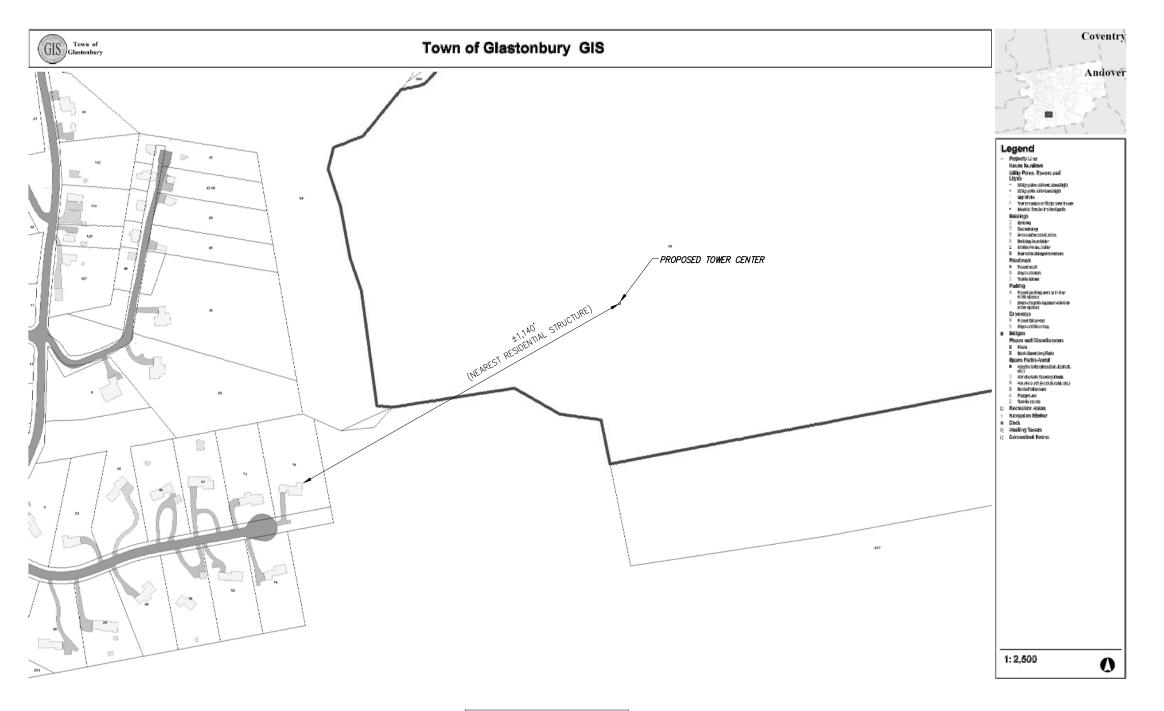
Date: 8/23/17

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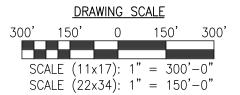


NOTE: BASEMAPPING INFORMATION TAKEN FROM TOWN OF GLASTONBURY, CT GIS MAPPING SOFTWARE AND HAS NOT BEEN FIELD VERIFIED BY INFINIGY



NO RESIDENTIAL STRUCTURES WITHIN 1,000' OF PROPOSED TOWER LOCATION.





1033 Watervliet Shaker Road | Albany, NY 1220)
Phone: 518-690-0790 | Fax: 518-690-0793

REVISED PER COMMENTS SKB	8/23/17
REVISED ACCESS DRIVE SKB	12/15/16
FOR POWER CO. REVIEW AJD	9/7/16
Submittal / Revision App'd	Date

 Drawn:
 AJD
 Date:
 9/7/16

 Designed:
 AJD
 Date:
 9/7/16

 Checked:
 AJD
 Date:
 9/7/16

Project Number: 502-00

Project Title:

GLASTONBURY

CT-0007

63-80 WOODLAND STREET GLASTONBURY, CT 06073

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NEAREST RESIDENTIAL STRUCTURE MAP

Drawing Scale:


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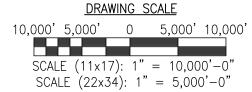
Drawing Number:

Z2A

NOTE: BASEMAPPING INFORMATION TAKEN FROM TOWN OF GLASTONBURY, CT GIS MAPPING SOFTWARE AND HAS NOT BEEN FIELD VERIFIED BY INFINIGY





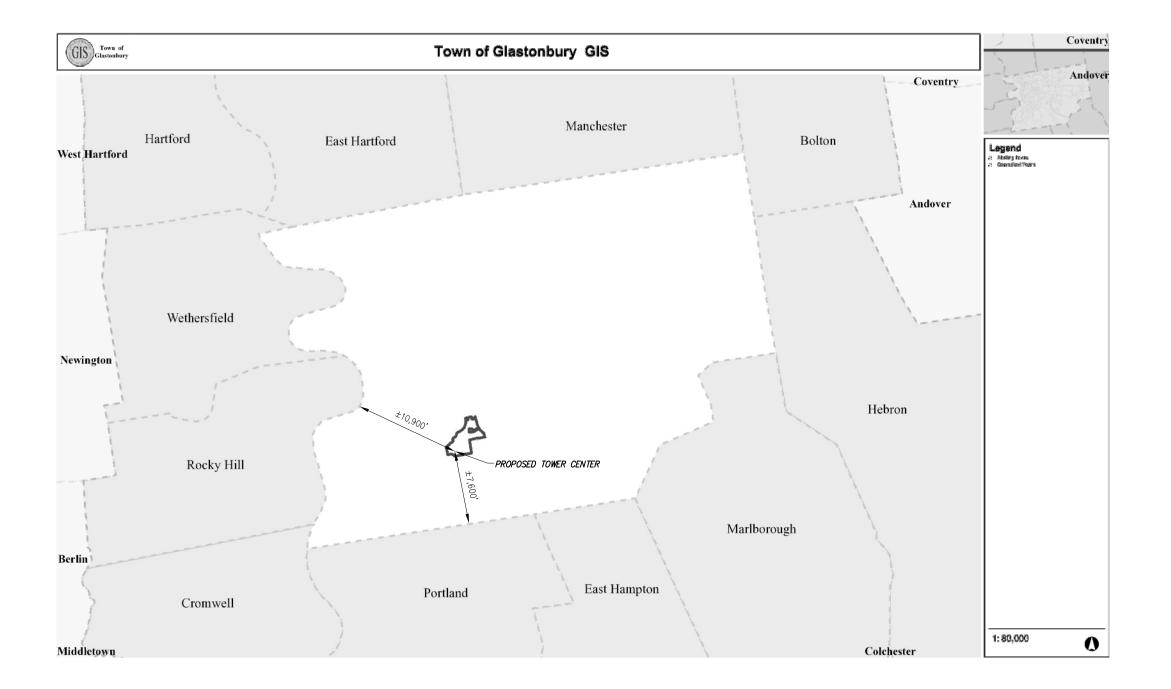

1033 Watervliet Shaker Road | Albany, NY 12205
Phone: 518-690-0790 | Fax: 518-690-0793

2	REVISED PER COMMENTS	SKB	8/23/
1	REVISED ACCESS DRIVE	SKB	12/15/
0	FOR POWER CO. REVIEW	AJD	9/7/1
lo.	Submittal / Revision	App'd	Date

Drawn: \_\_\_\_AJD \_\_\_ Date: \_\_\_9/7/16
Designed: \_\_\_AJD \_\_\_ Date: \_\_\_9/7/16
Checked: \_\_\_AJD \_\_\_ Date: \_\_\_9/7/16

502-000

Project Title:

GLASTONBURY

CT-0007

63-80 WOODLAND STREET GLASTONBURY, CT 06073

repared For:



Drawing Title:

NEAREST MUNICIPALITY MAP

Drawing Scale

Date:
8/23/17

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Drawing Number:

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NOTE:
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OF GLASTONBURY, CT GIS MAPPING SOFTWARE
AND HAS NOT BEEN FIELD VERIFIED BY INFINIGY Coventry GIS Town of Glastonbury Town of Glastonbury GIS Andover BOULDER CIRCLE ECHO LAME SHIPMAN DRIVE Property Line
Streets
White Breaks
White and Type Bells
Author and Type Bells
Property Breaks only party
Property distinct path
West peoply desired path
West Legend LEIGH GATE ROAD Project Title: GLASTONBURY CT-0007 63-80 WOODLAND STREET GLASTONBURY, CT 06073 ±1,630' (WETLAND SOILS) Drawing Title: BLUEBERRY LANE WETLANDS & WETLAND TYPE SOILS MAP PROPOSED TOWER CENTER 1:7,500 0 Drawing Scale: Date: 8/23/17 DRAWING SCALE WETLAND & WETLAND TYPE SOILS UNAUTHORIZED ALTERATION OR ADDITION TO THIS DOCUMENT IS A VIOLATION OF APPLICABLE STATE AND/OR LOCAL LAWS 400' 800' SCALE (11x17): 1" = 800'-0"Z<sub>2</sub>C SCALE  $(22\times34)$ : 1" = 400'-0"

NOTE:
BASEMAPPING INFORMATION TAKEN FROM TOWN
OF GLASTONBURY, CT GIS MAPPING SOFTWARE
AND HAS NOT BEEN FIELD VERIFIED BY INFINIGY

#### SCHOOL NAMES:

HOPEWELL ELEMENTARY

SCHOOLS, CHESTNUT HILL ROAD

3 EASTBURY ELEMENTARY

4 GIDEON WELLES J.H.S.

5 HEBRON AVE ELEMENTARY

SMITH MIDDLE SCHOOL


7 NAUBUC ELEMENTARY

8 GLASTONBURY/EAST HARTFORD MAGNET SCHOOL


9 GLASTONBURY/EAST HARTFORD MAGNET SCHOOL


BUTTONBALL ELEMENTARY

11 NAYAUG ELEMENTARY

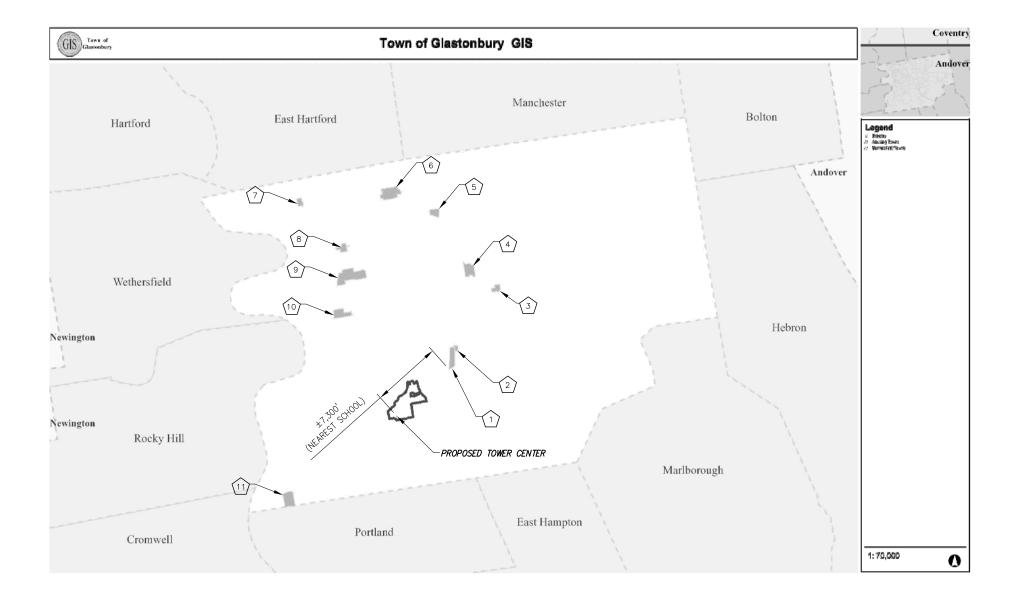



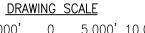

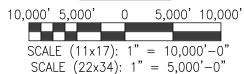

1			
	REVISED PER COMMENTS	SKB	8/23
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	Submittal / Revision	App'd	Dat
-			

Designed: AJD Date: 9/7/16 Checked: AJD Date: 9/7/16

Project Number

Project Title:

**GLASTONBURY** 

CT-0007

63-80 WOODLAND STREET GLASTONBURY, CT 06073



Orawing Title:

**NEAREST SCHOOL MAP** 

Drawing Scale:


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Z<sub>2</sub>D

NOTE: BASEMAPPING INFORMATION TAKEN FROM TOWN OF GLASTONBURY, CT GIS MAPPING SOFTWARE AND HAS NOT BEEN FIELD VERIFIED BY INFINIGY Coventry Town of **Town of Glastonbury GIS** GIS Town of Andover 21) SHIPMAN DRIVE 20) STERET Legend Property Line Streets (19) LEIGH GATE ROAD HOPEWELLI.  $\bigcirc$ 15) (18) 17 16 13 22) 12 11) 10 2 9 8 7 MATSON HILL ACCOUNT NUMBER | MAILING STREET ADDRESS STATE ZIP OWNER NAME: CITY GLASTONBURY TOWN OF 57000006W 2155 MAIN ST GLASTONBURY CT 06033-228 EMERICK ROGER C 33600580 580 HOPEWELL RD S GLASTONBURY CT 06073-241 CT 06033-228 GLASTONBURY TOWN OF 42800068 2155 MAIN ST GLASTONBURY 3 ROSE SANDRA J 42800297 295 MATSON HILL RD S GLASTONBURY CT 06073-341 5 PALMIERI CATHERINE T CO-TR+ 78000004W 10 BELDEN ST E HARTFORD CT 06108-402 6 CT 06460-643 ZWEIBEL STEVEN L+ 78000289 29 MILLWOOD ST MILFORD JASKO-K LLC 78000281 99 HAWTHORNE MEAD DR GLASTONBURY CT 06033-255 BURTON KEVIN J+JANET L 78000275 275 WOODLAND ST S GLASTONBURY CT 06073-272 SCAMUZZI WILLIAM E 78000268 268 WOODLAND ST GLASTONBURY CT 06073-271 10 WOOD FRANK A+CONNIE M 78000258 258 WOODLAND ST S GLASTONBURY CT 06073-271 CANNARIATO ANTHONY A CARLSBAD 78000004F 7160 AVIARA DR CA 92011-490 11 LAJOIE AARON 78000230 GLASTONBURY CT 06073-271 230 WOODLAND ST 13 ZELLER JAMES R 78000210 210 WOODLAND ST S GLASTONBURY CT 06073-271 14 BURNS ALISON S+CAMERON H S GLASTONBURY CT 06073-271 78000200 200 WOODLAND ST HERMSEN JULIE D 78000198 198 WOODLAND ST S GLASTONBURY CT 06073-271 GLASTONBURY CT 06073-271 16 BERNIER JAMES R+NICHOLE 78000194 194 WOODLAND ST GLASTONBURY CT 06073-271 GAUL MATTHEW H+TANYA K 78000184 184 WOODLAND ST CORCORAN MICHAEL P 78000172 172 WOODLAND ST S GLASTONBURY CT 06073-271 4 5 19 ROARING BROOK PARK INC 78000088 PO BOX 308 GLASTONBURY CT 06073-030 CURTIN JANICE L+MARK F 78000077 77 WOODLAND ST S GLASTONBURY CT 06073-272 COELHO HENRIQUE M 78000058 58 WOODLAND ST S GLASTONBURY CT 06073-271 22 CAVANNA PAUL J+CATHERINE 80 WOODLAND ST S GLASTONBURY CT 06073-271 78000095





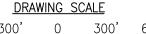

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Project Title:

**GLASTONBURY** 

CT-0007

63-80 WOODLAND STREET GLASTONBURY, CT 06073



rawing Title:


ABUTTERS MAP

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BASEMAPPING INFORMATION BASED ON INFORMATION OBTAINED FROM AERIAL PHOTOGRAPHY, INFORMATION PROVIDED BY ECO—SITE, A SITE WALK COMPLETED BY INFINIGY ENGINEERING ON 5/17/16 AND SURVEY COMPLETED BY CLIMAX DEVELOPMENT OF W.N.Y. TITLED "GLASTONBURY", DATED 6/14/16.



SCALE (11x17): 1" = 20'-0"SCALE (22x34): 1" = 10'-0" 1033 Watervijet Shaker Road | Albany, NY 12205 Phone: 518-690-0790 | Fax: 518-690-0793

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GLASTONBURY

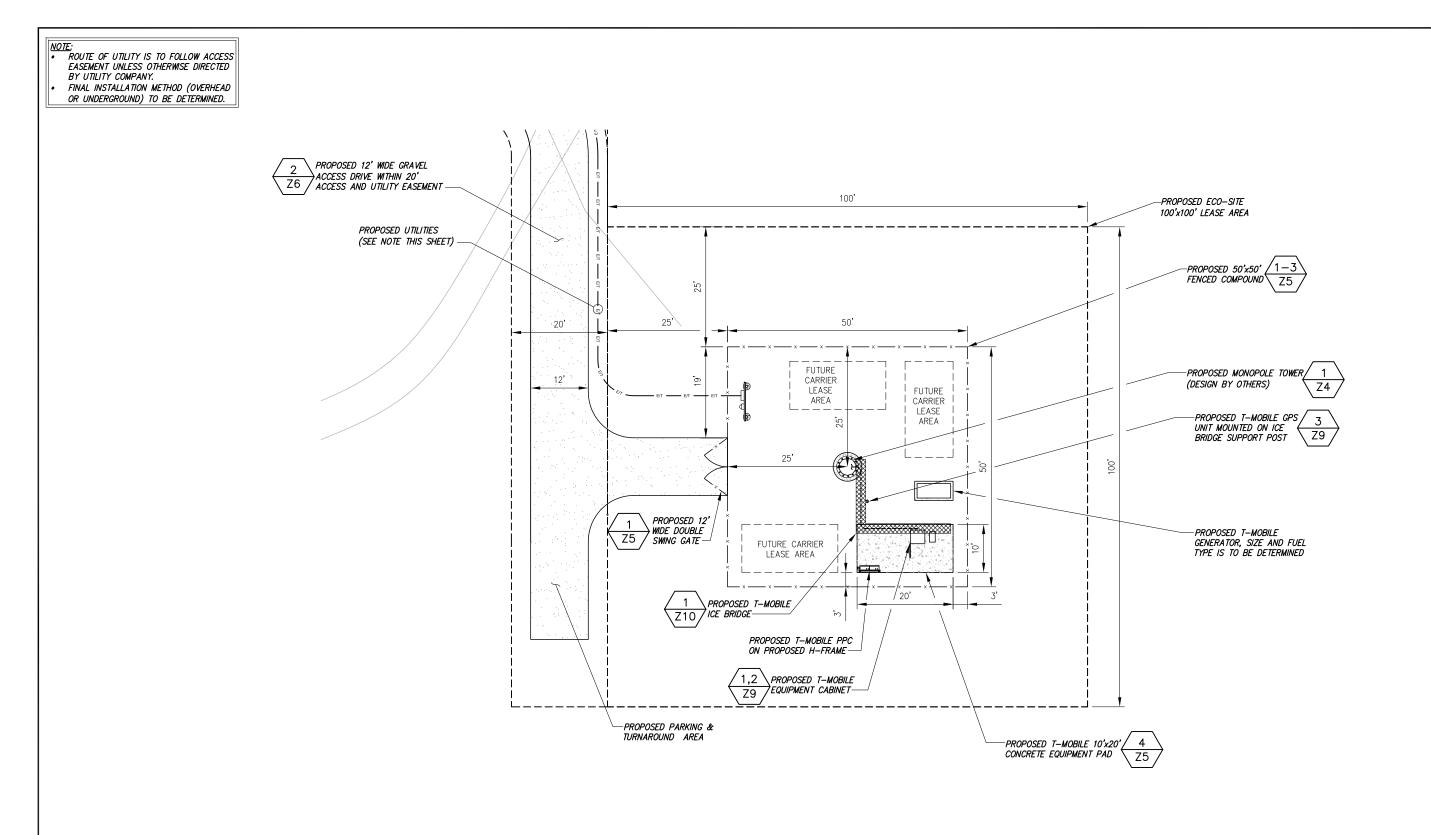CT-0007

63-80 WOODLAND STREET GLASTONBURY, CT 06073

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Drawing Title:


ENLARGED SITE LAYOUT

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Designed: AJD Date: 9/7/16 Checked: AJD Date: 9/7/16

Project Title:

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CT-0007

63-80 WOODLAND STREET GLASTONBURY, CT 06073

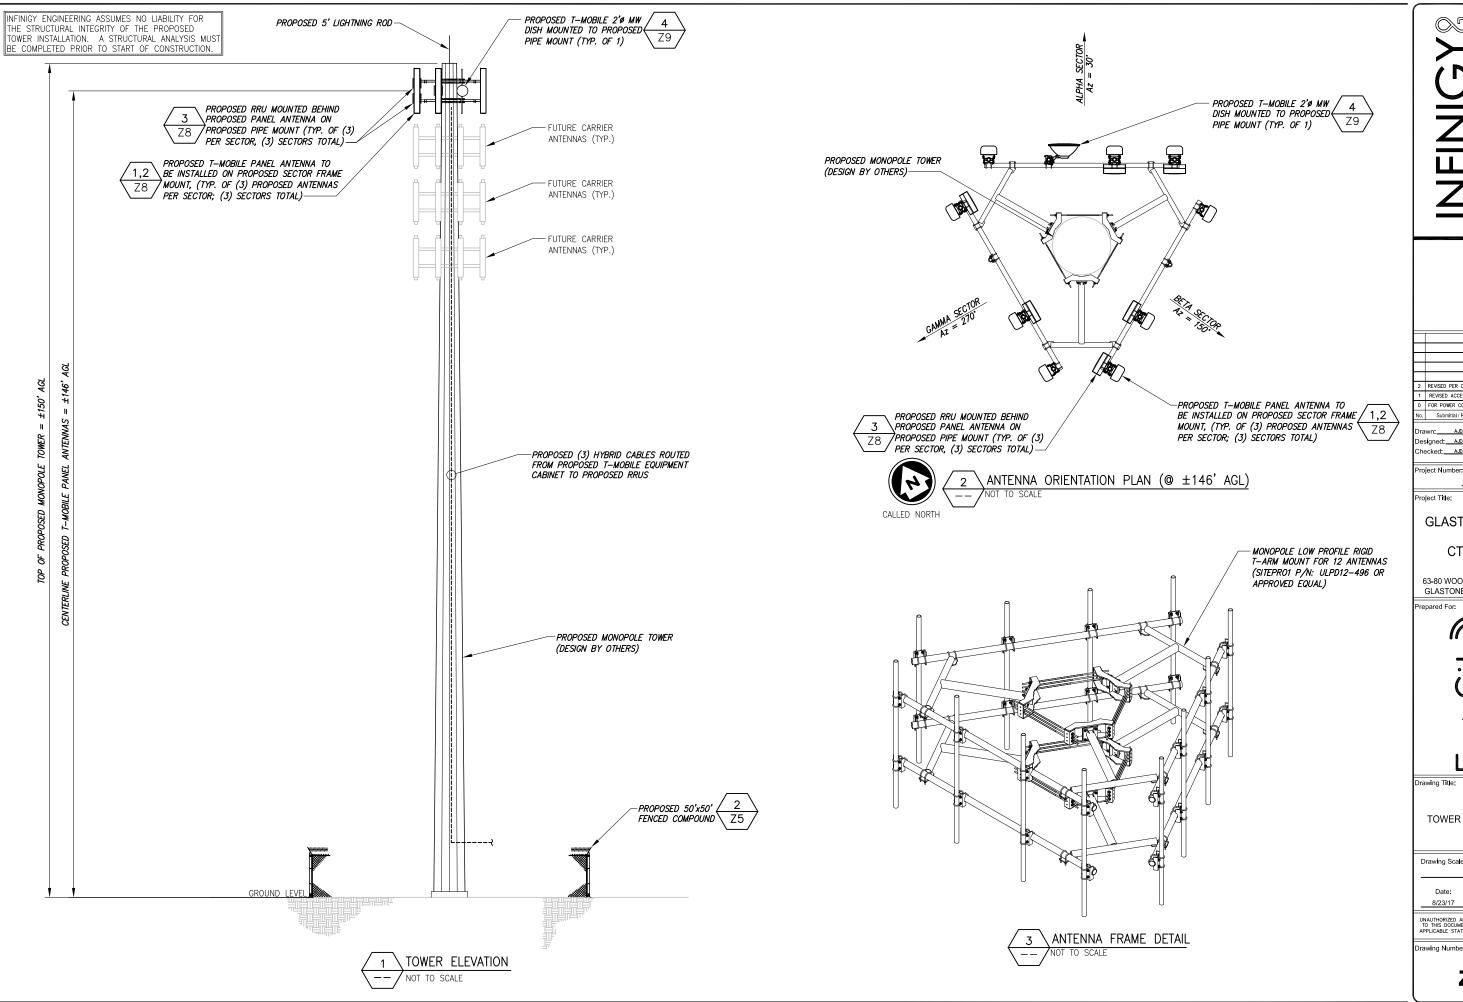

Drawing Title:


TOWER ELEVATION


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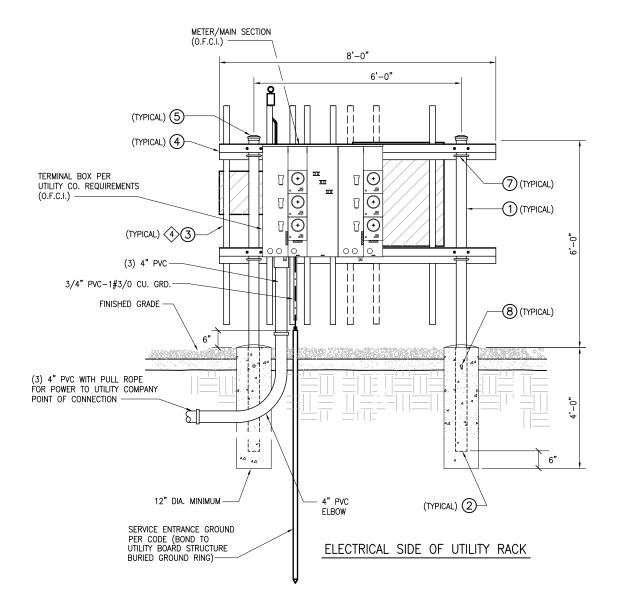
Date: 8/23/17

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	PARTS LIST - O.F.C.I.		
	ITEM	DESCRIPTION	
1 84" x 3.5" O.D. PIPE		2	
+ ② 36" INSERT ③ VERTICAL MEMBER ④ HORIZONTAL MEMBER		36" INSERT	2
		VERTICAL MEMBER	9
		4	
	(5)	3-1/2" O.D. PIPE CAP	2
*	6	3/8" ANGLE ADAPTER	38
	7	1/2 x 3-5/8 x 5" GALV. U-BOLT ASSY.	8
	8	1/2 x 1-1/2" GALV. BOLT ASSY.	2
*	9	3/8 x 3/4" GALV. BOLT ASSY.	38
*	9	3/8" GALV. FLAT WASHER	38

- \* NOT SHOWN
- + TO PREVENT CORROSION, ENSURE THAT THE PIPE SLEEVE IS COMPLETELY BELOW GROUND LEVEL AND ENCASED IN CONCRETE.



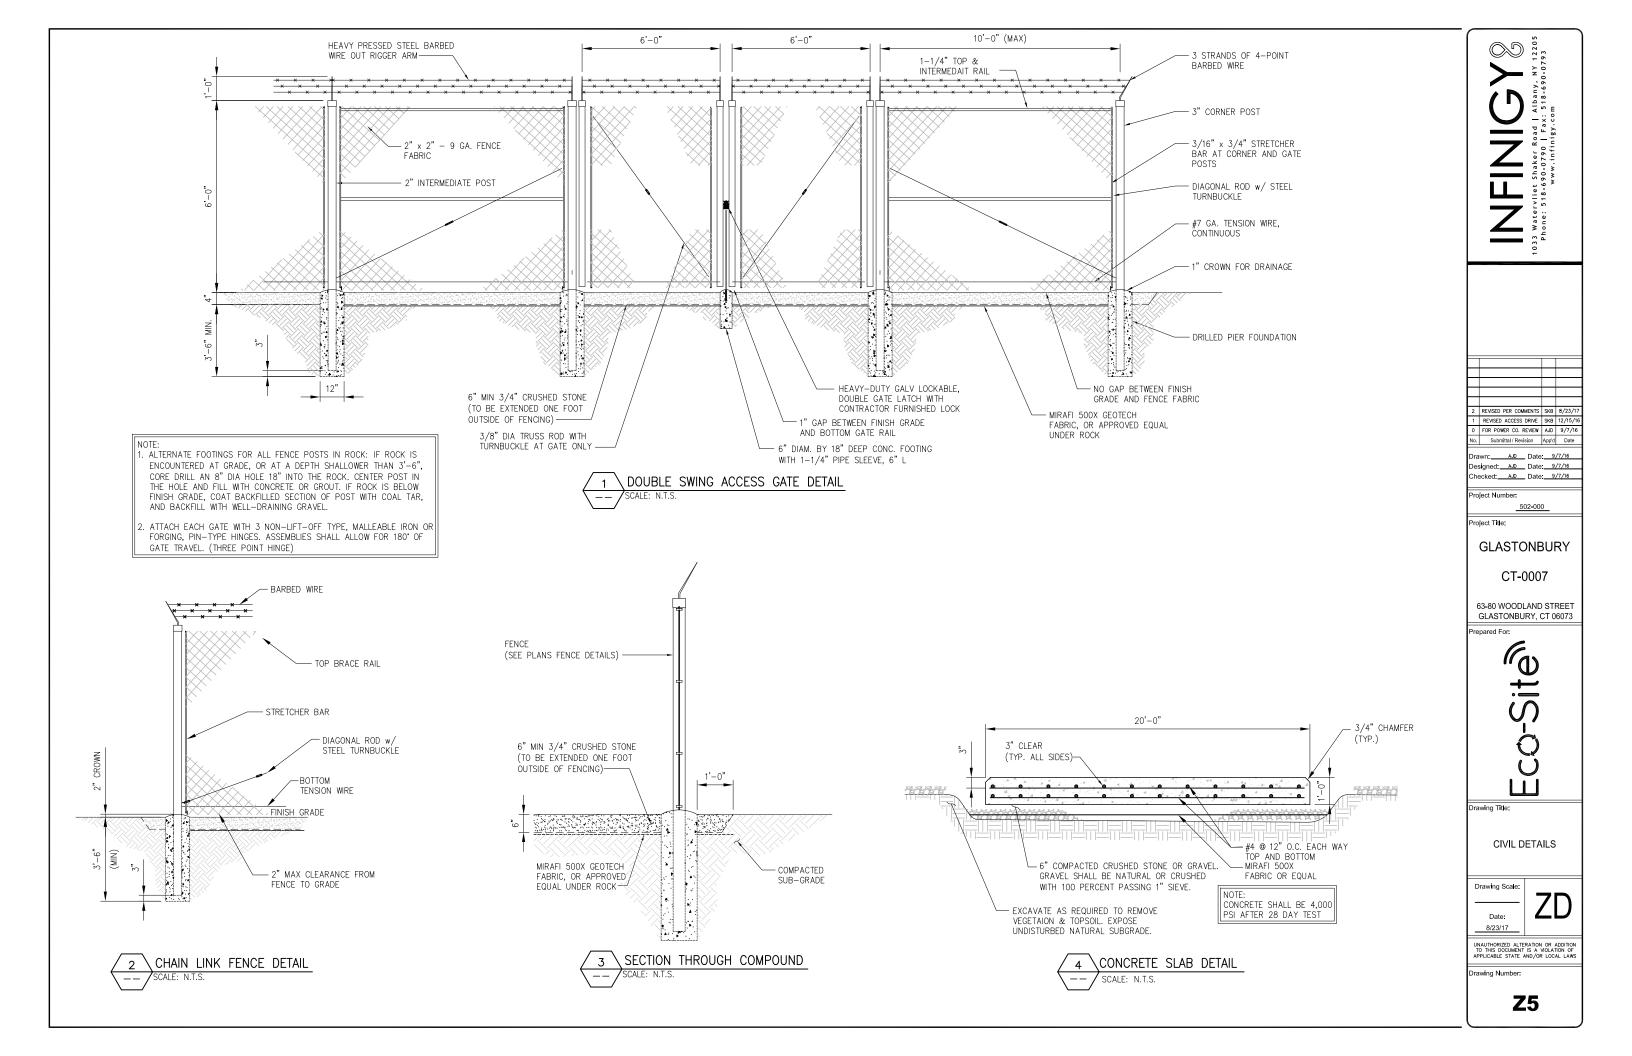
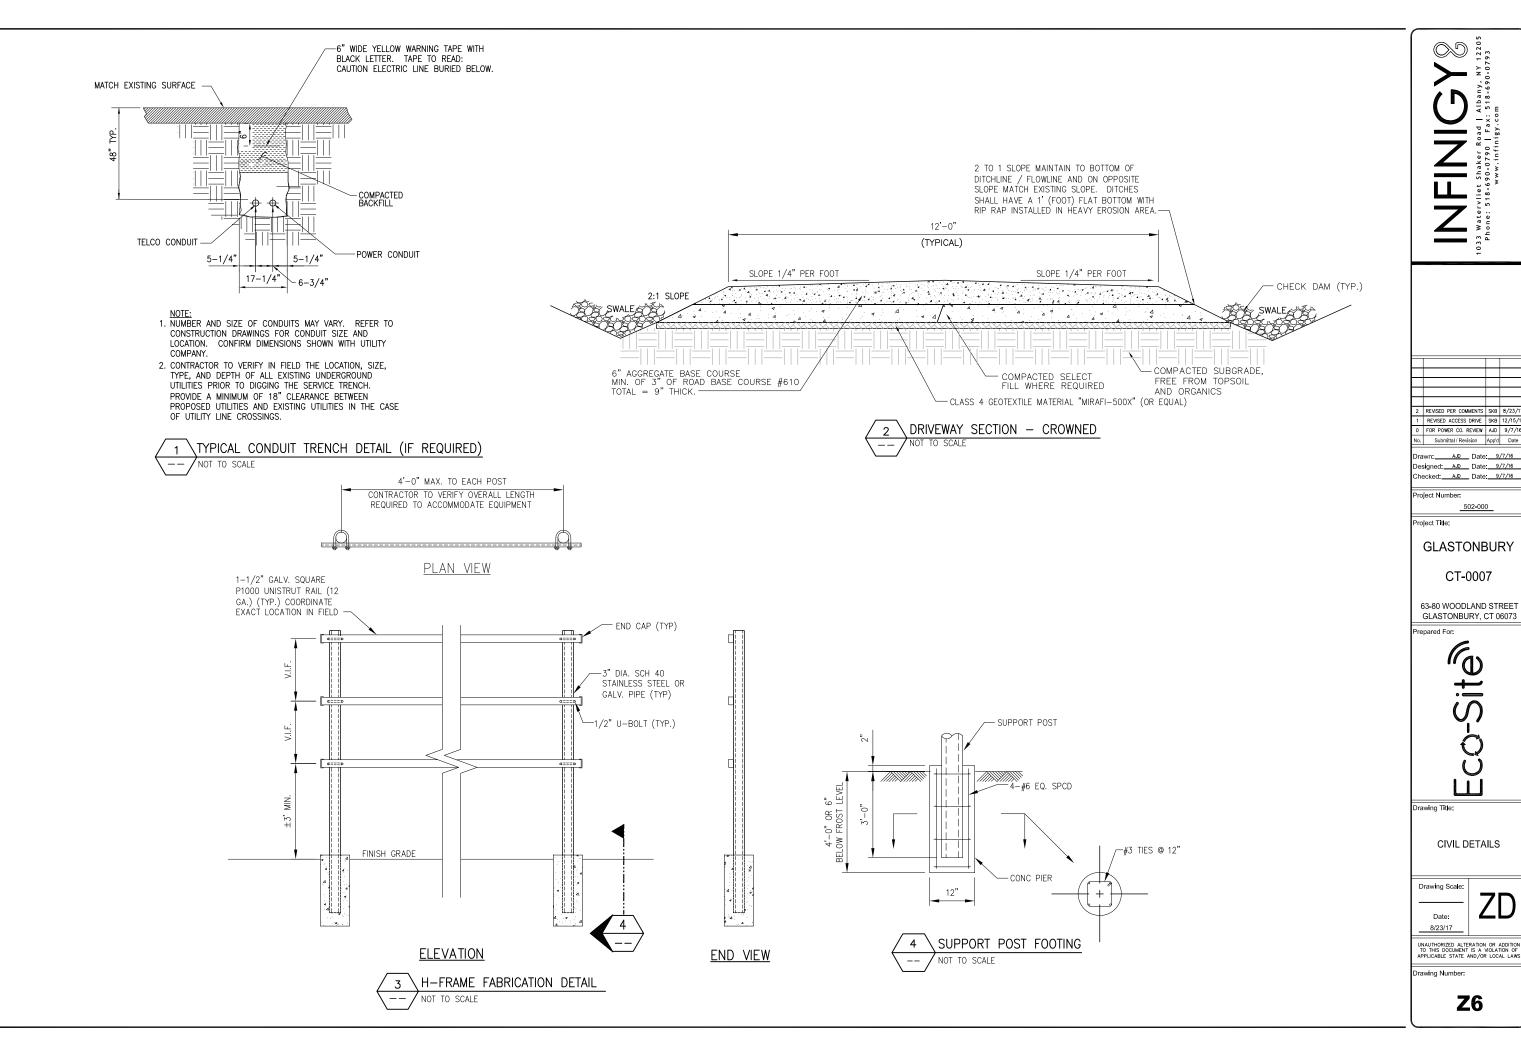
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GLASTONBURY

CT-0007

63-80 WOODLAND STREET GLASTONBURY, CT 06073

Prepared Fo



Drawing Title:


UTILITY RACK DETAIL


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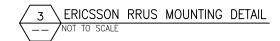
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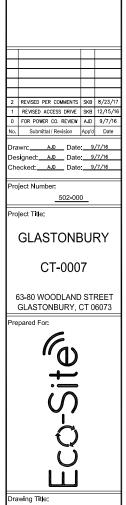
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T-MOBILE EQUIPMENT DETAILS

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**Z8** 

Drawing Scale:

Date: 8/23/17

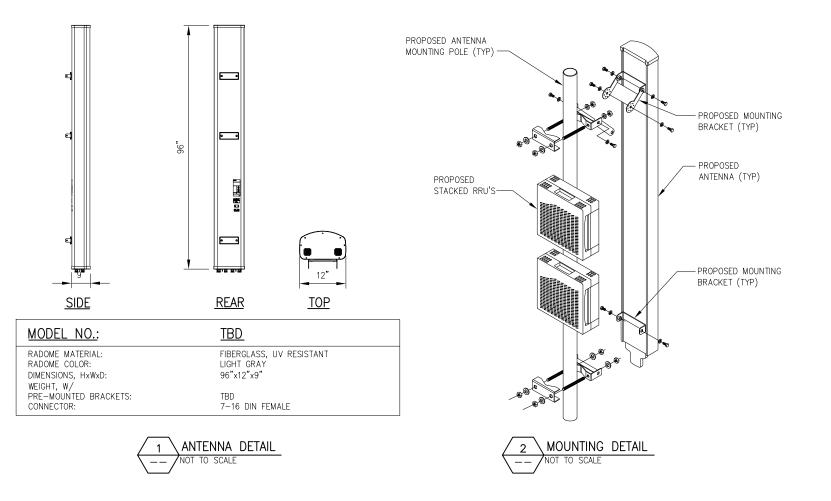Drawing Number:

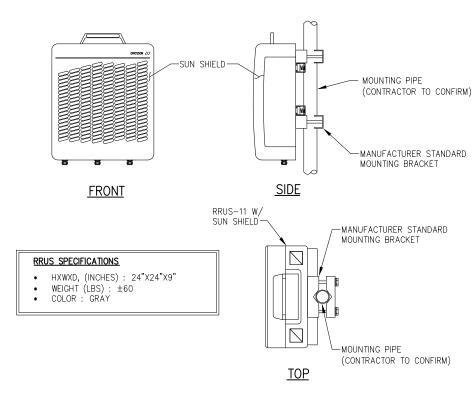

CABINET COLOR: LIGHT GRAY
DIMENSIONS (HxWxD IN): 72x36x36 IN

V1 WEIGHT (FULLY EQUIPPED): 715 LBS 340 LBS (ENCLOSURE + SUPPORT) 374 LBS (RBS 6201)

V2 WEIGHT (FULLY EQUIPPED): 1100 I

470 LBS (ENCLOSURE + CLIMATE SYSTEM + LOAD CENTER)
630 LBS (RBS + TRANSMISSION + SUPPORT EQUIPMENT)

SUPPORT CONTROL UNIT

POWER CONNECTION UNIT

POWER CONNECTION
FILTER

(6) NEW RUSO1
B12 RADIOS

RADIO UNITS

POWER SUBRACK

1 EQUIPMENT CABINET DETAIL

NOT TO SCALE

# 26.305" 14.040" 14.040" SIDE FRONT

BATTERY CABINET DETAIL

ALMOND POWDER COAT


32.245x14.040x26.305 IN


PTS - PTS8003

DIMENSIONS (HxWxD IN):

CABINET COLOR:

UNIT WEIGHT:

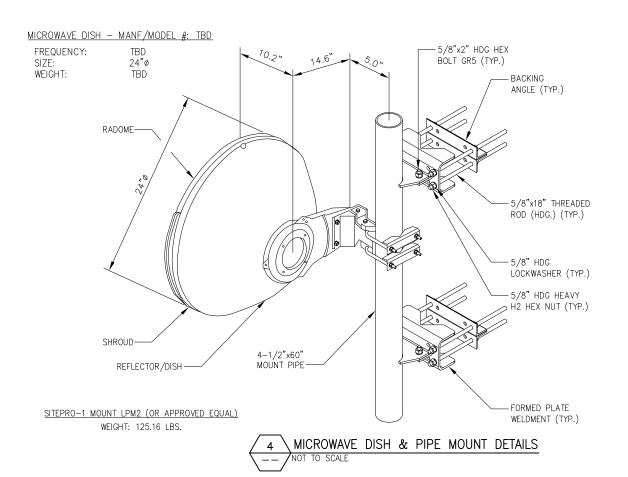

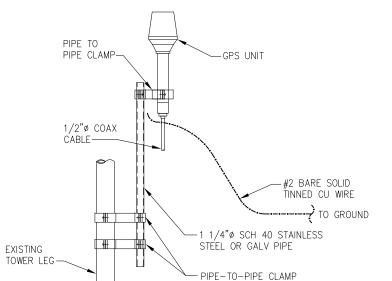

NOTES:

- 1. THE ELEVATION AND LOCATION OF THE GPS ANTENNA SHALL BE IN ACCORDANCE WITH THE FINAL RF REPORT.
- 2. THE GPS ANTENNA MOUNT IS DESIGNED TO FASTEN TO A GROUND PLANE BOLTED TO A STANDARD 1-1/4" DIAMETER, SCHEDULE 40 GALVANIZED STEEL OR STAINLESS STEEL PIPE. THE PIPE MUST NOT BE THREADED AT THE ANTENNA MOUNT END. THE PIPE SHALL BE CUT TO THE REQUIRED LENGTH (MINIMUM OF 18 INCHES) USING A HAND OR ROTARY PIPE CUTTER TO ASSURE A SMOOTH AND PERPENDICULAR CUT. A HACK SAW SHALL NOT BE USED. THE CUT PIPE END SHALL BE DEBURRED AND SMOOTH IN ORDER TO SEAL AGAINST THE NEOPRENE GASKET ATTACHED TO THE ANTENNA MOUNT.
- IT IS CRITICAL THAT THE GPS ANTENNA IS MOUNTED SUCH THAT IT IS WITHIN 2 DEGREES OF VERTICAL AND THE BASE OF THE ANTENNA IS WITHIN 2 DEGREES OF LEVEL.
- 4. DO NOT SWEEP TEST GPS ANTENNA.



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No. Submittal / Revision App'd Date

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 AJD
 Date:
 9/7/16

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 AJD
 Date:
 9/7/16

 Checked:
 AJD
 Date:
 9/7/16

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Project Title:

GLASTONBURY

CT-0007

63-80 WOODLAND STREET GLASTONBURY, CT 06073

Prepared



Drawing Title:

T-MOBILE EQUIPMENT DETAILS


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Date: **2 1 8**/23/17

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Drawing Number:

24" WAVEGUIDE BRIDGE SUPPORT BRACKET SAFETY GRATING 24"x10'-<u>TOP</u> GRATING 24"x10" PIPE CAP-



FOR POWER CO. REVIEW AJD 9/7/10

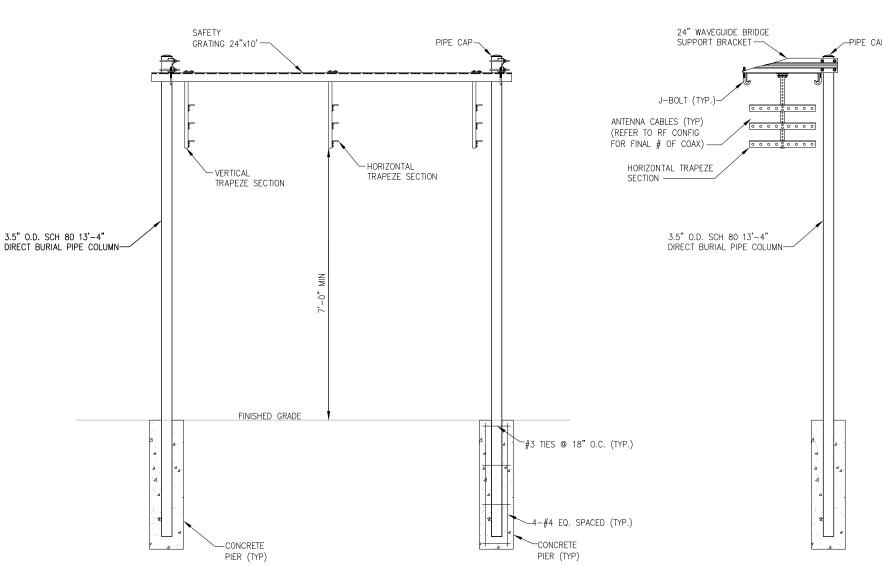necked: AJD Date: 9/7/16

Project Title:

GLASTONBURY

CT-0007

63-80 WOODLAND STREET GLASTONBURY, CT 06073

ICE BRIDGE DETAILS

Drawing Scale:

8/23/17

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**Z10** 

NOTES:
1. USE SITE PRO 1 PARTS OR APPROVED EQUAL.

2. SUPPORT POSTS SHALL BE LOCATED ON ALTERNATING SIDES OF ICE BRIDGE, SPACED NO MORE THAN 6'-0".

SIDE

3. ANY SPLICES OR CANTILEVERED SECTIONS OF THE ICE BRIDGE SHALL BE LOCATED WITHIN 2'-0" OF A SUPPORT POST.

WAVEGUIDE BRIDGE KIT (SITE PRO P/N: IB24D-T3)

<u>FRONT</u>

#### **GRADING & EXCAVATING NOTES:**

- ALL EXCAVATIONS ON WHICH CONCRETE IS TO BE PLACED SHALL BE SUBSTANTIALLY HORIZONTAL ON UNDISTURBED AND UNFROZEN SOIL AND BE FREE FROM LOOSE MATERIAL AND EXCESS GROUNDWATER. DEWATERING FOR EXCESS GROUNDWATER SHALL BE PROVIDED IF REQUIRED.
- CONCRETE FOUNDATIONS SHALL NOT BE PLACED ON ORGANIC MATERIAL. IF SOUND SOIL IS NOT REACHED AT THE DESIGNATED EXCAVATION DEPTH, THE UNSATISFACTORY SOIL SHALL BE EXCAVATED TO ITS FULL DEPTH AND EITHER BE REPLACED WITH MECHANICALLY COMPACTED GRANULAR MATERIAL OR THE EXCAVATION BE FILLED WITH CONCRETE OF THE SAME QUALITY SPECIFIED FOR THE FOUNDATION.
- ANY EXCAVATION OVER THE REQUIRED DEPTH SHALL BE FILLED WITH EITHER MECHANICALLY COMPACTED GRANULAR MATERIAL OR CONCRETE OF THE SAME QUALITY SPECIFIED FOR THE FOUNDATION. CRUSHED STONE MAY BE USED TO STABILIZE THE BOTTOM OF THE EXCAVATION. STONE, IF USED, SHALL NOT BE USED AS COMPILING CONCRETE THICKNESS.
- AFTER COMPLETION OF THE FOUNDATION AND OTHER CONSTRUCTION BELOW GRADE, AND BEFORE BACKFILLING, ALL EXCAVATIONS SHALL BE CLEAN OF UNSUITABLE MATERIAL SUCH AS VEGETATION, TRASH, DEBRIS, AND SO FORTH,
- 5. -USE APPROVED MATERIALS CONSISTING OF EARTH, LOAM, SANDY CLAY, SAND -BE FREE FROM CLODS OR STONES OVER 2-1/2" MAXIMUM DIMENSIONS -BE PLACED IN 6" LAYERS AND COMPACTED TO 95% STANDARD PROCTOR EXCEPT IN GRASSED/LANDSCAPED AREAS, WHERE 90% STANDARD PROCTOR
- 6. REMOVE ALL VEGETATION, TOPSOIL, DEBRIS, WET AND UNSATISFACTORY SOIL MATERIALS, OBSTRUCTIONS, AND DELETERIOUS MATERIALS FROM GROUND SURFACE PRIOR TO PLACING FILLS. PLOW, STRIP, OR BREAK UP SLOPED SURFACES STEEPER THAN THAN 1 VERTICAL TO 4 HORIZONTAL SO FILL MATERIAL WILL BOND WITH EXISTING SURFACE. WHEN SUBGRADE OR EXISTING GROUND SURFACE TO RECEIVE FILL HAS A DENSITY LESS THAN THAT REQUIRED FOR FILL, BREAK UP GROUND SURFACE TO DEPTH REQUIRED, PULVERIZE, MOISTURE-CONDITION OR AERATE SOIL AND RECOMPACT TO REQUIRED
- 7. PROTECT EXISTING GRAVEL SURFACING AND SUBGRADE IN AREAS WHERE EQUIPMENT LOADS WILL OPERATE, USE PLANKING OR OTHER SUITABLE MATERIALS DESIGNED TO SPREAD EQUIPMENT LOADS. REPAIR DAMAGE TO EXISTING GRAVEL SURFACING OR SUBGRADE WHERE SUCH DAMAGE IS DUE TO THE CONTRACTOR'S OPERATIONS. DAMAGED GRAVEL SURFACING SHALL BE RESTORED TO MATCH THE ADJACENT UNDAMAGED GRAVEL SURFACING AND SHALL BE OF THE SAME THICKNESS
- 8. REPLACE EXISTING GRAVEL SURFACING ON AREAS FROM WHICH GRAVEL SURFACING IS REMOVED DURING CONSTRUCTION OPERATIONS. GRAVEL SURFACING SHALL BE REPLACED TO MATCH EXISTING ADJACENT GRAVEL SURFACING AND SHALL BE OF THE SAME THICKNESS. SURFACES OF GRAVEL SURFACING SHALL BE FREE FROM CORRUGATIONS AND WAVES. EXISTING GRAVEL SURFACING MAY BE EXCAVATED SEPARATELY AND REUSED IF INJURIOUS AMOUNTS OF EARTH, ORGANIC MATTER, OR OTHER DELETERIOUS MATERIALS ARE REMOVED PRIOR TO REUSE. FURNISH ALL ADDITIONAL GRAVEL RESURFACING MATERIAL AS REQUIRED BEFORE GRAVEL SURFACING IS REPLACED, SUBGRADE SHALL BE GRADED TO CONFORM TO REQUIRED SUBGRADE ELEVATIONS. AND LOOSE OR DISTURBED MATERIALS SHALL BE THOROUGHLY COMPACTED. DEPRESSIONS IN THE SUBGRADE SHALL BE FILLED AND COMPACTED WITH APPROVED SELECTED MATERIAL. GRAVEL SURFACING MATERIAL MAY BE USED FOR FILLING DEPRESSIONS IN THE SUBGRADE, SUBJECT TO ENGINEER'S APPROVAL.
- DAMAGE TO EXISTING STRUCTURES AND UTILITIES RESULTING FROM CONTRACTOR'S NEGLIGENCE SHALL BE REPAIRED/REPLACED TO OWNER'S SATISFACTION AT CONTRACTOR'S EXPENSE.
- CONTRACTOR SHALL COORDINATE THE CONSTRUCTION SCHEDULE WITH PROPERTY OWNER SO AS TO AVOID INTERRUPTIONS TO PROPERTY OWNER'S OPERATIONS.
- 11. ENSURE POSITIVE DRAINAGE DURING AND AFTER COMPLETION OF CONSTRUCTION.
- ALL CUT AND FILL SLOPES SHALL BE MAXIMUM 2 HORIZONTAL TO 1 VERTICAL
- CONTRACTOR SHALL BE RESPONSIBLE FOR MONITORING SITE VEHICLE TRAFFIC AS TO NOT ALLOW VEHICLES LEAVING THE SITE TO TRACK MUD ONTO PUBLIC STREETS. THE CONTRACTOR IS RESPONSIBLE FOR CLEANING PUBLIC STREETS DUE TO MUDDY VEHICLES LEAVING

#### GENERAL EROSION & SEDIMENT CONTROL NOTES:

- THE SOIL EROSION AND SEDIMENT CONTROL MEASURES AND DETAILS AS SHOWN HEREIN AND STIPULATED WITHIN STATE STANDARDS SHALL BE FOLLOWED AND INSTALLED IN A MANNER SO AS TO MINIMIZE SEDIMENT LEAVING THE SITE.
- PRIOR TO COMMENCING LAND DISTURBANCE ACTIVITY, THE LIMITS OF LAND DISTURBANCE SHALL BE CLEARLY AND ACCURATELY DEMARCATED WITH STAKES, RIBBONS, OR OTHER APPROPRIATE MEANS.
- EROSION CONTROL DEVICES SHALL BE INSTALLED BEFORE GROUND DISTURBANCE OCCURS. THE LOCATION OF SOME OF THE EROSION CONTROL DEVICES MAY HAVE TO BE ALTERED FROM SHOWN ON THE APPROVED PLANS IF DRAINAGE PATTERNS DURING CONSTRUCTION ARE DIFFERENT FROM THE FINAL PROPOSED DRAINAGE PATTERNS. IT IS THE CONTRACTOR'S RESPONSIBILITY TO ACCOMPLISH EROSION CONTROL FOR ALL DRAINAGE PATTERNS CREATED AT VARIOUS STAGES DURING CONSTRUCTION. ANY DIFFICULTY IN CONTROLLING EROSION DURING ANY PHASE OF CONSTRUCTION SHALL BE REPORTED TO THE ENGINEER IMMEDIATELY.
- THE LOCATION OF SOME OF THE EROSION CONTROL DEVICES MAY HAVE TO BE ALTERED FROM THAT SHOWN ON THE PLANS IF DRAINAGE PATTERNS DURING CONSTRUCTION ARE DIFFERENT FROM THE FINAL PROPOSED DRAINAGE PATTERNS. ANY DIFFICULTY IN CONTROLLING EROSION DURING ANY PHASE OF CONSTRUCTION SHALL BE REPORTED TO THE ENGINEER
- CONTRACTOR SHALL MAINTAIN ALL EROSION CONTROL MEASURES UNTIL PERMANENT VEGETATION HAS BEEN ESTABLISHED. CONTRACTOR SHALL CLEAN OUT ALL SEDIMENT PONDS WHEN REQUIRED BY THE ENGINEER OR THE LOCAL JURISDICTION INSPECTOR. CONTRACTOR SHALL INSPECT EROSION CONTROL MEASURES AT THE END OF EACH WORKING DAY TO ENSURE MEASURES ARE FUNCTIONING PROPERLY.
- THE CONTRACTOR SHALL REMOVE ACCUMULATED SILT WHEN THE SILT IS WITHIN 12" OF THE TOP OF THE SILT FENCE.
- FAILURE TO INSTALL, OPERATE OR MAINTAIN ALL EROSION CONTROL MEASURES WILL RESULT IN ALL CONSTRUCTION BEING STOPPED ON THE JOB SITE UNTIL SUCH MEASURES ARE
- SILT BARRIERS TO BE PLACED AT DOWNSTREAM TOE OF ALL CUT AND FILL SLOPES.
- ALL CUT AND FILL SLOPES MUST BE SURFACED ROUGHENED AND VEGETATED WITHIN SEVEN (7) DAYS OF THEIR CONSTRUCTION.
- CONTRACTOR SHALL REMOVE ALL EROSION & SEDIMENT CONTROL MEASURES AFTER COMPLETION OF CONSTRUCTION AND ESTABLISHMENT OF PERMANENT GROUND COVER.
- THE ESCAPE OF SEDIMENT FROM THE SITE SHALL BE PREVENTED BY THE INSTALLATION OF EROSION CONTROL MEASURES AND PRACTICES PRIOR TO, OR CONCURRENT WITH, LAND-DISTURBING ACTIVITIES.

## -WIRE FENCE- WHERE REQUIRED COMMERCIAL TYPE C SILT FABRIC ON UPSTREAM SIDE OF FENCE DIRECTION OF FLOW MIN GROUNDLINE DIG TRENCH LAY IN FABRIC TO BOTTOM OF TRENCH 3. BACKFILL TRENCH, COVERING FABRIC 6'\_0"± SILT FENCE DETAIL

NOTE:

#### **SEEDING GUIDELINES:**

FINAL STABILIZATION OF ALL DISTURBED AREAS, UNLESS OTHERWISE NOTED, SHALL BE LOAMED AND SEEDED. LOAM SHALL BE PLACED AT A MINIMUM COMPACTED DEPTH OF 4". RECOMMENDED SEEDING DATES FOR PERMANENT VEGETATION SHALL BE BETWEEN JUNE 15 THROUGH AUGUST 1 AND SEPTEMBER 15 THROUGH OCTOBER 15. TEMPORARY VEGETATIVE MEASURES SHALL CONSIST OF AN ANNUAL OR PERENNIAL RYE GRASS WITH RECOMMENDED SEEDING DATES BEING FROM JUNE 1 THROUGH AUGUST 15 AND SEPTEMBER 30 THROUGH NOVEMBER 30.

#### EVALUATE PROPOSED COVER MATERIAL

BEFORE SPREADING COVER MATERIAL OVER THE DESIGNATED AREA, OBTAIN A REPRESENTATIVE SOIL SAMPLE AND SUBMIT TO A REPUTABLE SOIL TESTING LABORATORY FOR CHEMICAL AND PHYSICAL ANALYSIS. THE PRELIMINARY TEST IS NECESSARY TO DETERMINE THE REQUIRED INORGANIC AND/OR ORGANIC AMENDMENTS THAT ARE NEEDED TO ASSIST IN ESTABLISHING THE SEED MIXTURE IN AN ENVIRONMENTALLY AND ECONOMICALLY SOUND MANNER. THE RESULTS WILL GIVE THE COVER MATERIAL CHARACTERISTICS SUCH AS pH AND FERTILIZATION NEEDS. THESE RESULTS SHALL BE KEPT ON-SITE B THE CONTRACTOR AND AVAILABLE FOR REVIEW BY

#### SEED BED PREPARATION

PROPOSED COVER MATERIAL SHOULD BE SPREAD EVENLY OVER THE SITE AREA IN A MINIMUM 4" LIFT VIA BULLDOZER/BUCKET LOADER. USING THE INFORMATION FROM THE SOIL ANALYSIS, CAREFULLY CALCULATE THE QUANTITIES OF LIMESTONE AND PRE-PLANT FERTILIZER NEEDED PRIOR TO APPLYING. PRE-PLANT AMENDMENTS CAN BE APPLIED WITH A BROADCAST AND/OR DROP SEEDER AND INCORPORATED WITH AN OFFSET DISK, YORK RAKE, AND/OR HAND RAKE. AFTER INCORPORATION THE PRE-PLANT SOIL AMENDMENTS, THE SEED BED SHOULD BE SMOOTH AND FIRM PRIOR TO SEEDING. THE FOLLOWING SEED MIXTURES SHALL BE USED AS NOTED:

#### SFFD MIXTURE

SPECIES/VARIETY	LBS/ACRE
CREEPING RED FESCUE KENTUCKY BLUEGRASS	20 20
PERENNIAL RYEGRASS	5

#### SEED TIME AND METHOD

THE PREFERRED TIME FOR SEEDING THE COOL SEASON MIXTURE IS LATE SUMMER. SOIL AND AIR TEMPERATURES ARE IDEAL FOR SEED GERMINATION AND SEEDING GROWTH. WEED COMPETITION IS REDUCED BECAUSE SEEDS OF MANY WEED SPECIES GERMINATE EARLIER IN THE GROWING SEASON. ADDITIONALLY, HERBICIDE USE IS GREATLY REDUCED. HOWEVER, SEEDING MAY BE DONE AT ANY OF THE ABOVE NOTED TIMES.

#### MULCHING

TWELY SEEDED AREAS SHOULD BE MULCHED TO INSURE ADEQUATE MOISTURE FOR SUCCESSFUL TURF ESTABLISHMENT AND TO PROTECT AGAINST SURFACE MOVEMENT OF SEDIMENT—BOUND AGROCHEMICALS AND SOIL EROSION. IF MULCHING PROCEDURES ARE NOT SPECIFIED ON PLANS. APPLY GOOD QUALITY STRAW OR HAY AT A RATE OF 2 BALES/1000 SQ. FT. OTHER COMMERCIALLY AVAILABLE MULCHES CAN BE USED.

#### CONSTRUCTION NOTES FOR FABRICATED SILT FENCE

- 1. WOVEN WIRE FENCE TO BE FASTENED SECURELY POSTS: STEEL EITHER T OR U TO FENCE POSTS WITH WIRE TIES OR STAPLES.
- 2. FILTER CLOTH TO BE FASTENED SECURELY TO FENCE: WOVEN WIRE, 14 GA. WOVEN WIRE FENCE WITH TIES SPACED EVERY 24" AT TOP AND MID SECTION.
- 3. WHEN TWO SECTIONS OF FILTER CLOTH ADJOIN EACH OTHER THEY SHALL BE OVER-LAPPED BY SIX INCHES AND FOLDED.
- 4. MAINTENANCE SHALL BE PERFORMED AS NEEDED AND MATERIAL REMOVED WHEN 'BULGES" DEVELOP IN THE SILT FENCE.
- 5. ALL SILT FENCE MATERIALS MUST BE LISTED ON THE CURRENT STATES. D.O.T. QUALIFIED PRODUCTS LIST.

6" MAX. MESH OPENING

FILTER CLOTH: FILTER X. MIRAFI 100X' STABILINKA T140N OR APPROVED EQUAL.

PREFABRICATED UNIT: GEOFAB. ENVIROFENCE OR APPROVED FOLIAL

2 REVISED PER COMMENTS SKB 8/23/ 1 REVISED ACCESS DRIVE SKB 12/15, FOR POWER CO. REVIEW AJD 9/7/16

AJD Date: 9/7/16 Designed: AJD Date: 9/7/16 hecked: AJD Date: 9/7/16

oject Number

roject Title:

GLASTONBURY

CT-0007

63-80 WOODLAND STREET GLASTONBURY, CT 06073



rawing Title:

**GRADING & EROSION** CONTROL NOTES

Drawing Scale:

Date: 8/23/17

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awing Number:

EC1



COMPLETED BY CLIMAX DEVÉLOPMENT, SIGNED AND

STAMPED BY EARLE C. NEWMAN ON 11/18/16.

- IT IS ASSUMED THAT ONE TREE MEASURING 6" DBH OR GREATER EXISTS FOR EVERY 400 SQUARE FEET OF AREA TO BE IMPROVED.
- BASED ON A LEASE AREA OF 100'x100' AND A NEW ACCESS DRIVE CONSISTING OF 40,000 SQFT OF DISTURBANCE, THE TOTAL AREA TO

[(100)(100)] + [40,000] = 50,000 SQUARE FEET

- ADDING AN APPROXIMATE 10% CONTINGENCY, THE TOTAL AREA TO BE CLEARED IS 55,000 SQUARE FEET.
- THEREFORE THE ESTIMATED NUMBER OF TREES TO BE CLEARED IS: 55,000/400 = **138 TREES**

REVISED PER COMMENTS	SKB	8/23/17
REVISED ACCESS DRIVE	SKB	12/15/16
FOR POWER CO. REVIEW	AJD	9/7/16
Submittal / Revision	App'd	Date
	REVISED ACCESS DRIVE FOR POWER CO. REVIEW	REVISED ACCESS DRIVE SKB FOR POWER CO. REVIEW AJD

Drawn: \_\_\_\_\_AJD\_\_ Date: \_\_\_9/7/16 Designed: AJD Date: 9/7/16 Checked: AJD Date: 9/7/16

Project Number:

Project Title:

GLASTONBURY

CT-0007

63-80 WOODLAND STREET GLASTONBURY, CT 06073



Orawing Title:

GRADING PLAN

Drawing Scale:

Date: 8/23/17


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awing Number:

EC2

GRAPHIC SCALE

15' 30' SCALE (11x17): 1" = 30'-0"SCALE (22x34): 1" = 15'-0"

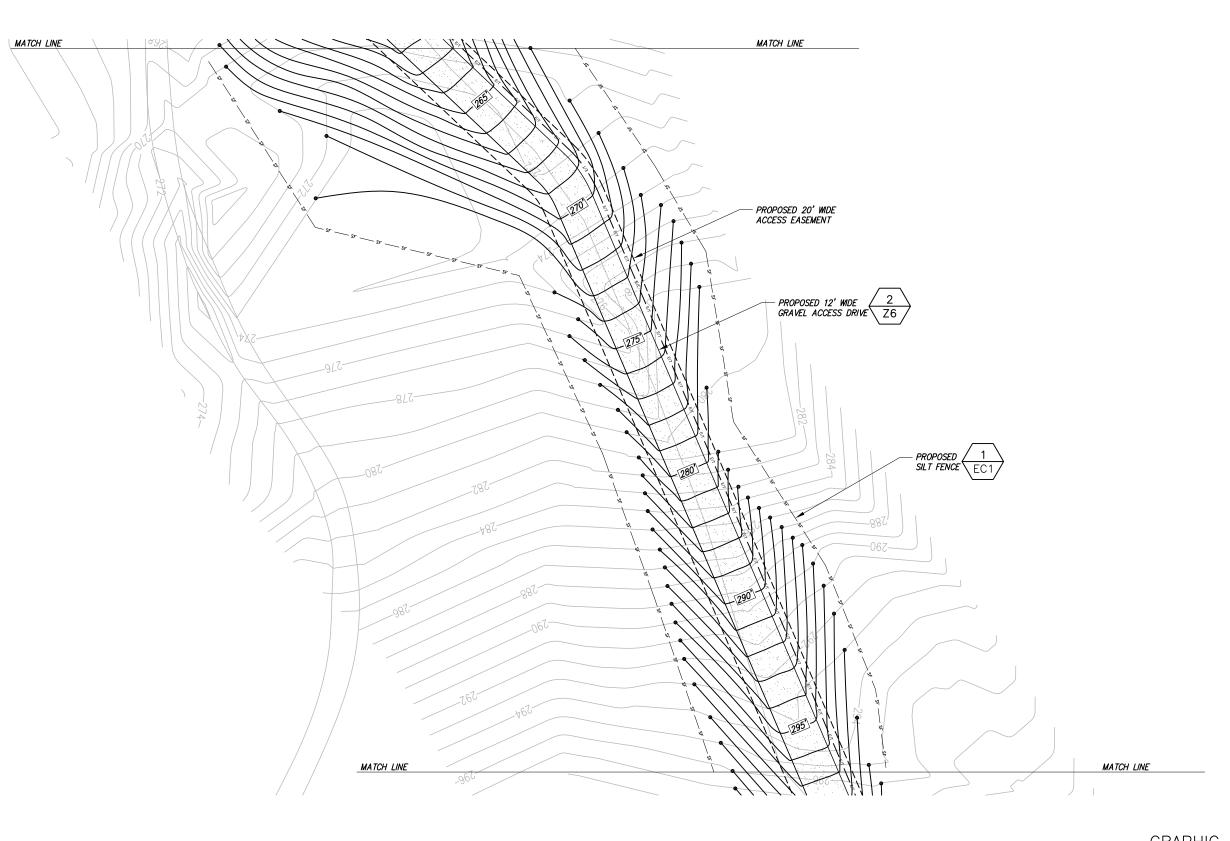

BASEMAPPING INFORMATION BASED ON INFORMATION OBTAINED FROM AERIAL PHOTOGRAPHY, INFORMATION PROVIDED BY ECO-SITE, A SITE WALK COMPLETED BY

INFINIGY ENGINEERING ON 5/17/16 AND SURVEY COMPLETED BY CLIMAX DEVELOPMENT, SIGNED AND STAMPED BY EARLE C. NEWMAN ON 11/18/16.

1 GRADING PLAN
SCALE: AS NOTED
APPROX. NORTH

GRAPHIC SCALE

0' 15' 0 15' 30'

SCALE (11x17): 1" = 30'-0"

SCALE (22x34): 1" = 15'-0"

1033 Waterviet Shaker Road | Albany, NY 12205 Phone: 518-690-0790 | Fax: 518-690-0793

REVISED PER COMMENTS	SKB	8/23/17
REVISED ACCESS DRIVE	SKB	12/15/16
FOR POWER CO. REVIEW	AJD	9/7/16
Submittal / Revision	App'd	Date

 Drawn:
 AJD
 Date:
 9/7/16

 Designed:
 AJD
 Date:
 9/7/16

 Checked:
 AJD
 Date:
 9/7/16

Project Number: 502-000

Project Title:

GLASTONBURY

CT-0007

63-80 WOODLAND STREET GLASTONBURY, CT 06073

Prepared For:



Drawing Title:

GRADING PLAN


Drawing Scale:

Date: 8/23/17

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Drawing Number:

EC3



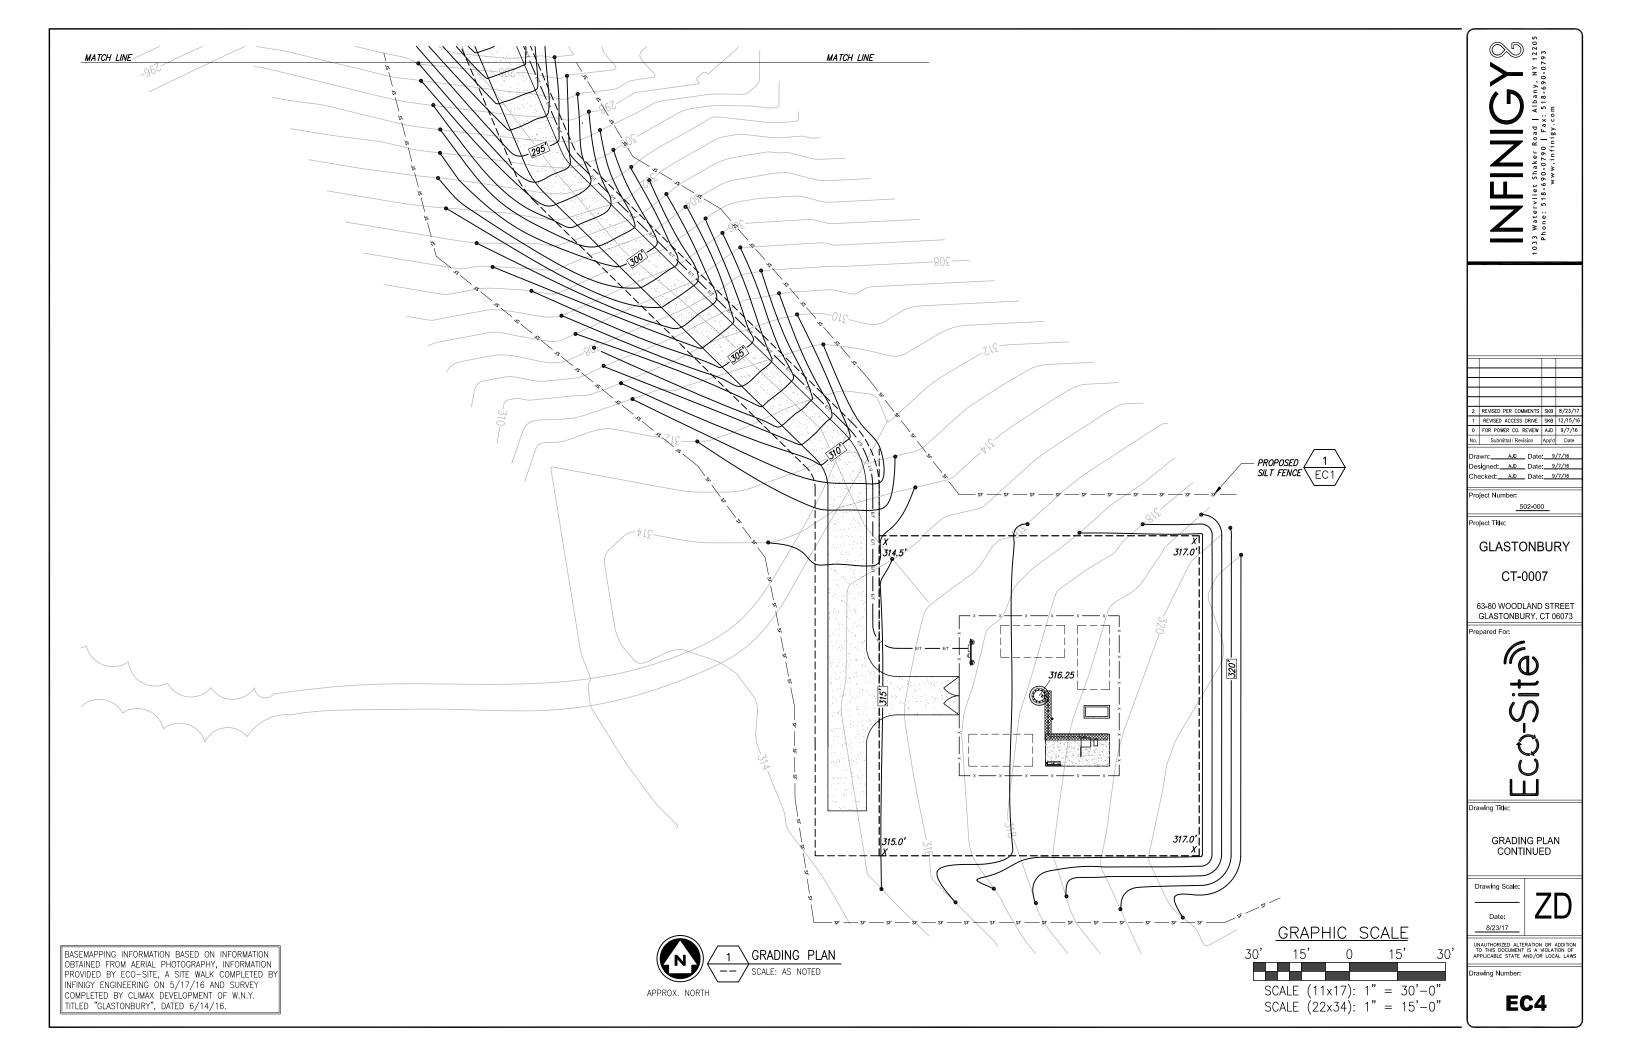




#### \*\*\* NOTICE \*\*\*

TOWAIR's findings are not definitive or binding, and we cannot guarantee that the data in TOWAIR are fully current and accurate. In some instances, TOWAIR may yield results that differ from application of the criteria set out in 47 C.F.R. Section 17.7 and 14 C.F.R. Section 77.13. A positive finding by TOWAIR recommending notification should be given considerable weight. On the other hand, a finding by TOWAIR recommending either for or against notification is not conclusive. It is the responsibility of each ASR participant to exercise due diligence to determine if it must coordinate its structure with the FAA. TOWAIR is only one tool designed to assist ASR participants in exercising this due diligence, and further investigation may be necessary to determine if FAA coordination is appropriate.

DETERMINATION Results  Structure does not require registration. There are no airports within 8 kilometers (5 miles) of the coordinates you provided.		
NAD83 Coordinates		
Latitude	41-39-50.9 north	
Longitude	072-34-18.6 west	
Measurements (Meters)		
Overall Structure Height (AGL)	45.7	
Support Structure Height (AGL)	0	
Site Elevation (AMSL)	111.3	
Structure Type		
MTOWER - Monopole		

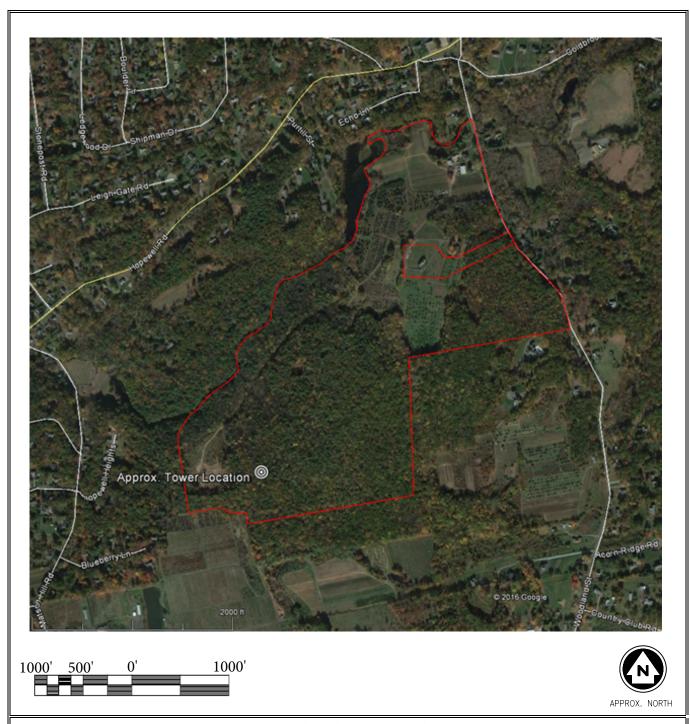

# Aerial Photography

Source: Google Earth Aerial Photo Dated 10/24/2014


Source: Glastonbury, CT GIS Map

Date: 6/22/2016 Rev: 0

Project: CT-0007

Site Address: 63 Woodland Street S. Glastonbury, CT 06073



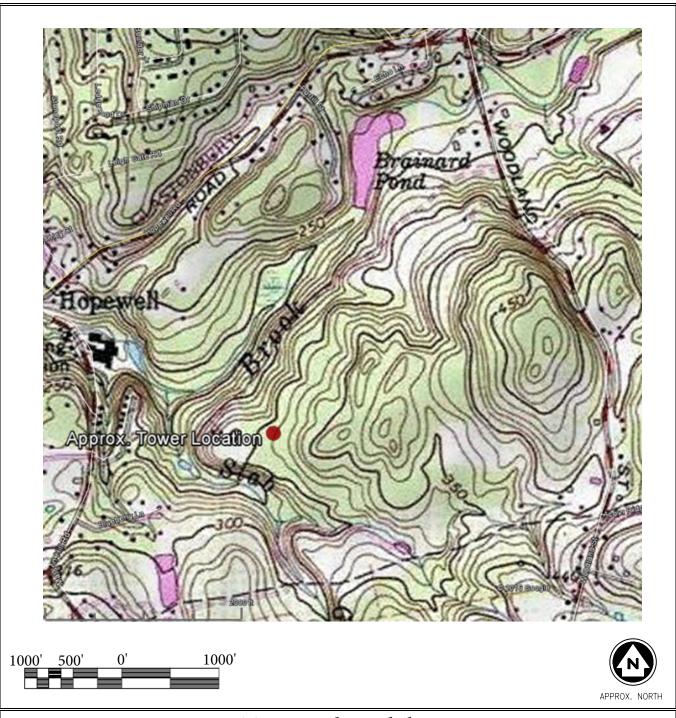

# Topography Exhibit

Source: Earth Point Topo Map Source: Glastonbury, CT GIS Map Project: CT-0007

Date: 6/22/2016 Rev: 0

Site Address: 63 Woodland Street S. Glastonbury, CT 06073

