

ATTACHMENT 4

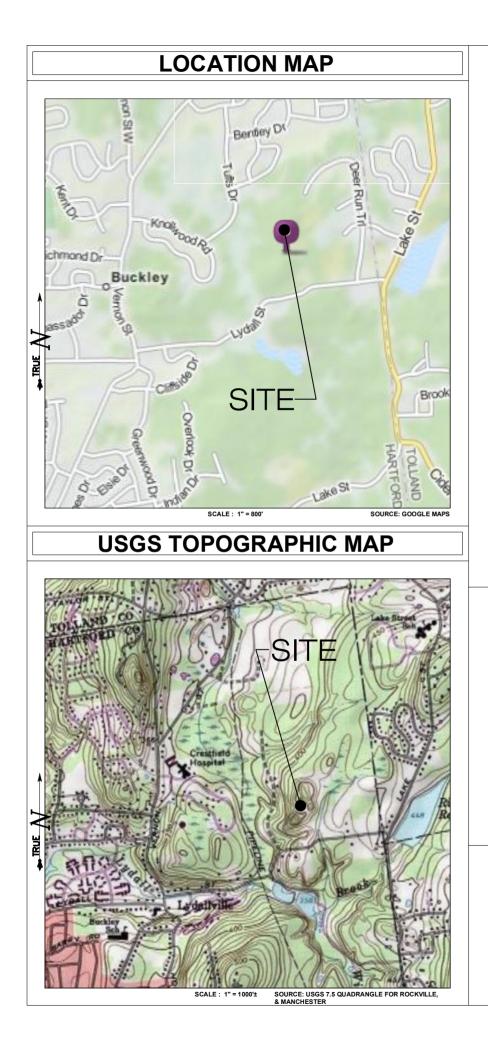

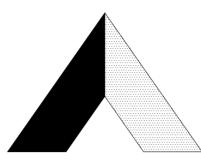

AMERICAN TOWER®

10 PRESIDENTIAL WAY WOBURN, MA. 01801

DRAWING INDEX

- T-1 TITLE SHEET & INDEX
- A-1 ABUTTERS MAP
- EX-1 COMPILATION MAP
- EX-2 EXISTING CONDITIONS SURVEY
- SP-1 SITE PLAN
- SP-2 COMPOUND PLAN AND TOWER ELEVATION
- SP-3 SEDIMENTATION & EROSION CONTROL DETAILS


*SITE INFORMATION:

-SITE NAME:	MANCHESTER RISLEY
-SITE ID NUMBER:	281539

MANCHESTER, CT

RR - RURAL RESIDENTIAL
41° 48' 08.54" N
72° 28' 47.27" W
431.3'± AMSL



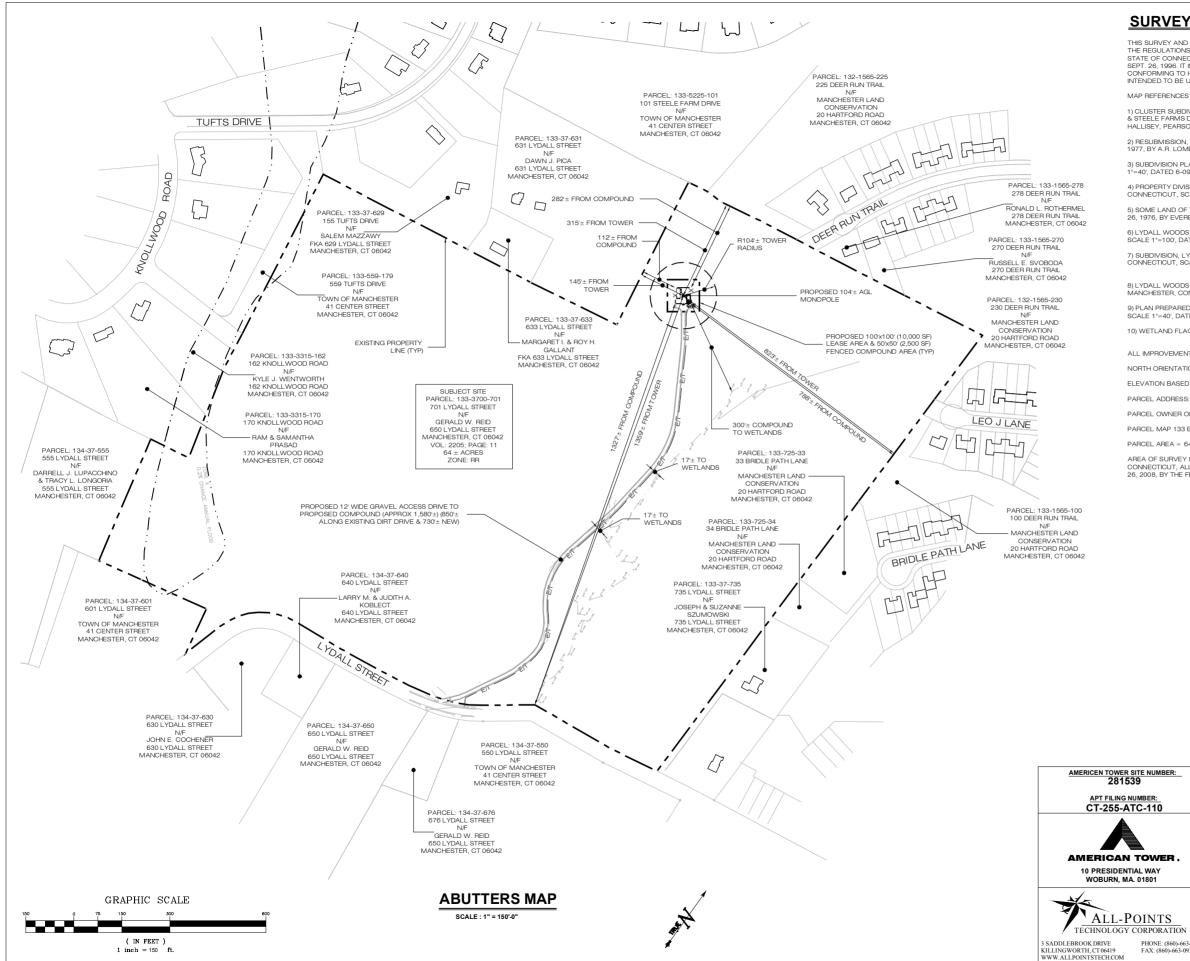

SURVEY NOTES

THIS SURVEY AND MAP HAS BEEN PREPARED IN ACCORDANCE WITH SECTIONS 20-300B-1 THRU 20-300B-20 OF THE REGULATIONS OF CONNECTICUT STATE AGENCIES - "MINIMUM STANDARDS FOR SURVEYS AND MAPS IN THE STATE OF CONNECTICUT" AS ENDORSED BY THE CONNECTICUT ASSOCIATION OF LAND SURVEYORS, INC, ON STATE OF CONNECTION TAS ENDORSED BY THE CONNECTION ASSOCIATION OF LAND SOMETONS, INC. ON SEPT. 26, 1996. IT IS A IMPROVEMENT LOCATION SURVEY AND IS BASED UPON A DEPENDENT RESURVEY CONFORMING TO HORIZONTAL ACCURACY CLASS A-2 AND A VERTICAL ACCURACY OF CLASS T-2 AND IS INTENDED TO BE USED FOR THE PURPOSE OF SHOWING EXISTING CONDITIONS AND PROPERTY LINE INFORMATION.

1) CLUSTER SUBDIVISION PLAN FOR STEELE FARMS, PROPERTY OF ARTHUR F. & LYNN B. STEELE, COLUMBIA DRIVE & STEELE FARMS DRIVE, MANCHESTER, CONNECTICUT, DATED JUNE 30, 2003, REVISED THROUGH 2-23-04, BY HALLISEY, PEARSON & CASSIDY

2) RESUBMISSION, SUBDIVISION PLAN, KNOLLWOOD, MANCHESTER, CONNECTICUT, SCALE 1*=40, DATED JULY 1977, BY A.R. LOMBARDI ASSOCIATES.

3) SUBDIVISION PLAN & LOT GEOMETRY, MILLARD WOOD SUBDIVISION, MANCHESTER, CONNECTICUT, SCALE 1*=40', DATED 6-09-00, REVISED THROUGH JULY 28, 2000, BY CES ENGINEERING.

4) PROPERTY DIVISION. PROPERTY OF JAMES D. & JEANNE K. ALDRICH, 737 LYDALL STREET, MANCHESTER, CONNECTICUT, SCALE 1*=40, DATED 10-92, REVISED THROUGH 4-93, BY MESSIER & ASSOCIATES.

5) SOME LAND OF THE MANCHESTER WATER COMPANY MANCHESTER CONNECTICUT SCALE 1*=200' DATED APR 26. 1976. BY EVERETT O. GARDNER & ASSOC

6) LYDALL WOODS, PROPERTY OF JOHN M. DAVIS, LYDALL STREET, MANCHESTER / VERNON, CONNECTICUT, SCALE 1*=100, DATED APRIL 24, 1982, BY A.R. LOMBARDI.

7) SUBDIVISION, LYDALL WOODS, PROPERTY OF JOHN M. DAVIS, LYDALL STREET, MANCHESTER / VERNON, CONNECTICUT, SCALE 1*=40, DATED MARCH 1983, BY A.R. LOMBARDI.

8) LYDALL WOODS COLONIAL VILLAGE, PROPERTY OF LYDALL WOODS CORPORATION, LYDALL STREET, MANCHESTER, CONNECTICUT, SCALE 1°=40', DATED MARCH 29 1984, BY A.R. LOMBARDI.

9) PLAN PREPARED FOR DARRELL J. LUPACCHINO & TRACY L. LONGORIA 555 LYDALL STREET. MANCHESTER, CT. SCALE 1"=40', DATED 3/20/13, BY HOLMES & HENRY ASSOCIATES LLC

10) WETLAND FLAG LOCATION PROVIDED BY ALL-POINTS TECHNOLOGY CORP., P.C. APRIL 1, 2014.

ALL IMPROVEMENTS ARE NOT SHOWN.

NORTH ORIENTATION AND COORDINATES REFER TO CONNECTICUT GRID SYSTEM NAD 83.

ELEVATION BASED ON NAVD 1988 DATUM.

PARCEL ADDRESS: 701 LYDALL STREET, MANCHESTER, CT 06042.


PARCEL OWNER OF RECORD: GERALD W REID


PARCEL MAP 133 BLOCK 3700 LOT 701 MANCHESTER ASSESSORS MAP


PARCEL AREA = 64± ACRES


AREA OF SURVEY IS NOT IN A FLOOD HAZARD ZONE ON THE FLOOD INSURANCE RATE MAP, HARTFORD COUNTY, CONNECTICUT, ALL JURISDICTIONS, PANEL 411 OF 675, MAP NUMBER 09003C411F, EFFECTIVE DATE SEPTEMBER 26, 2008, BY THE FEDERAL EMERGENCY MANAGEMENT AGENCY


ABER:	PERMITTING DOCUMENTS		
ō	MANCHESTER RISLEY 701 LYDALL STREET MANCHESTER, CT 06042	ABUTTE	RS MAP
	DESIGN TYPE:	APT FILING NUMBER: C	T-255-ATC-110
	RAW LAND	APT DRAWING NUMBER	281539 A-1.DWG
ER.		DRAWN BY: RCB	SCALE: AS NOTED
ſ		CHECKED BY: SMC	DATE: 04/21/14
	REVISIONS:		
	REV.0: 04/21/14: FOR REVIEW: SMC	SHEET NUMBER:	
T .0	REV.1: 05/13/14: REVISE TOWER HEIGHT: SMC		
TS	REV.2:		
RATION	REV.3:	A-1	Ν /
E: (860)-663-1697 860)-663-0935	REV.4:		\land
000,000.0755	DEV 5		

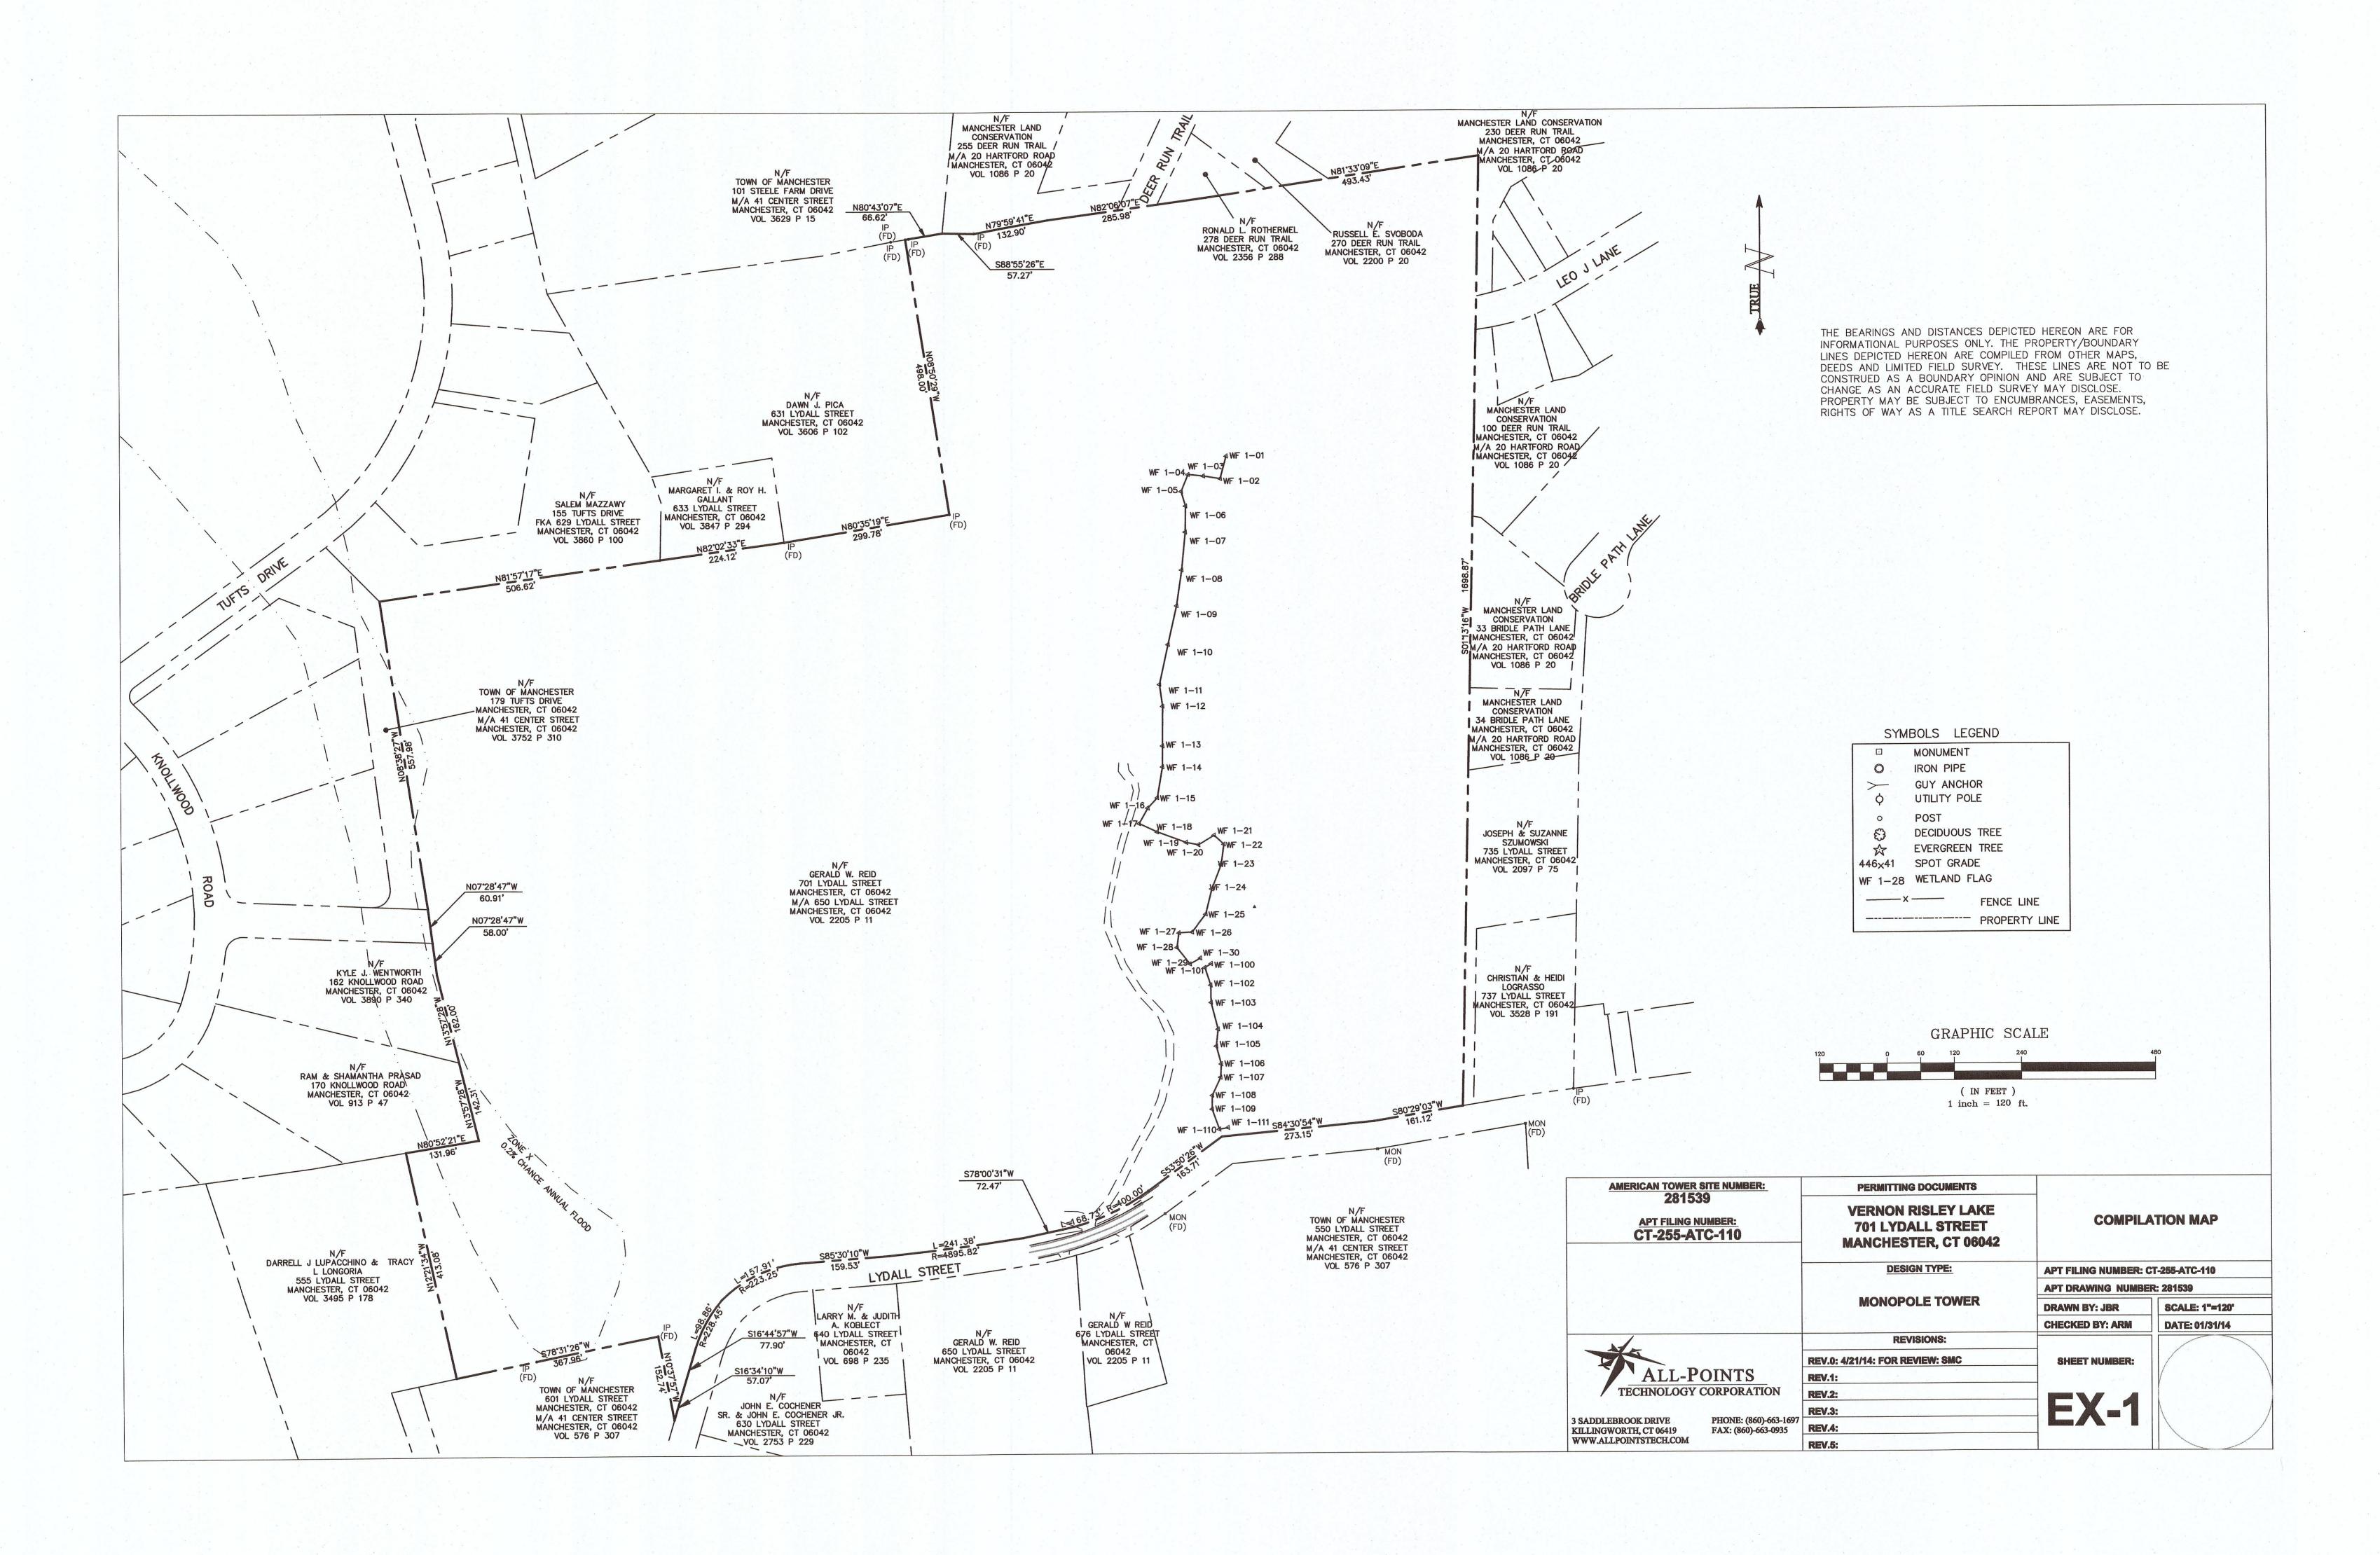

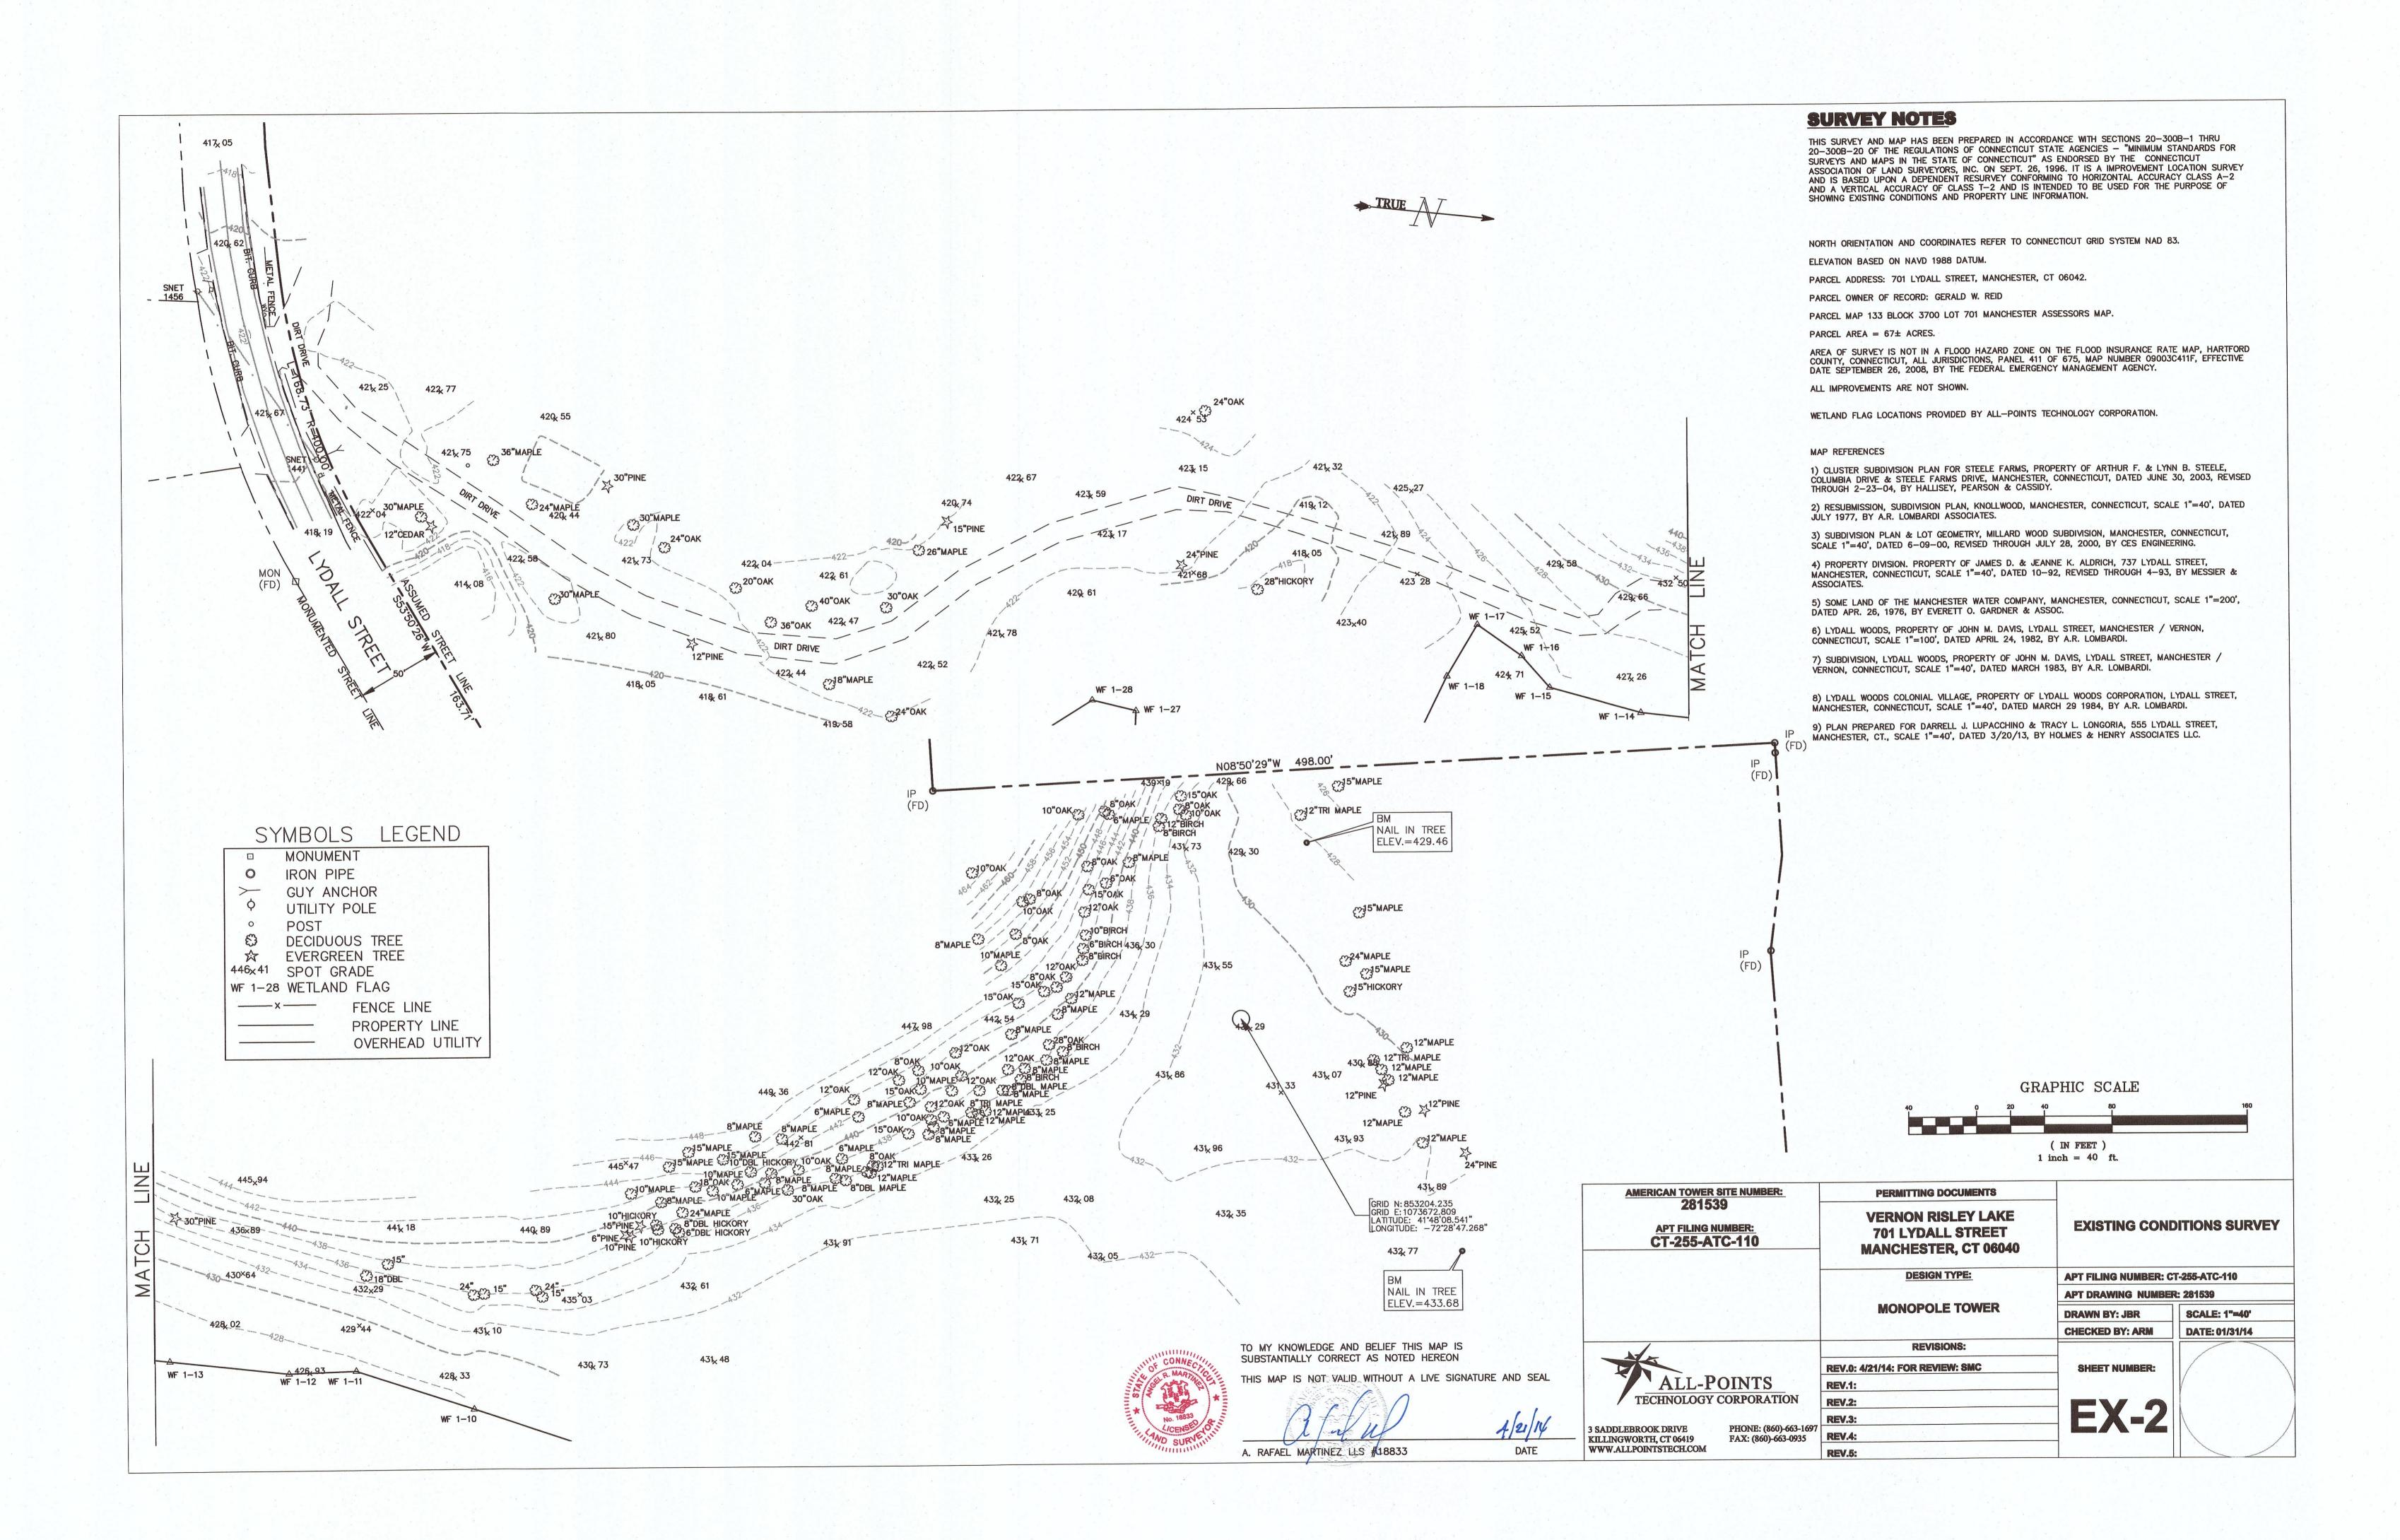


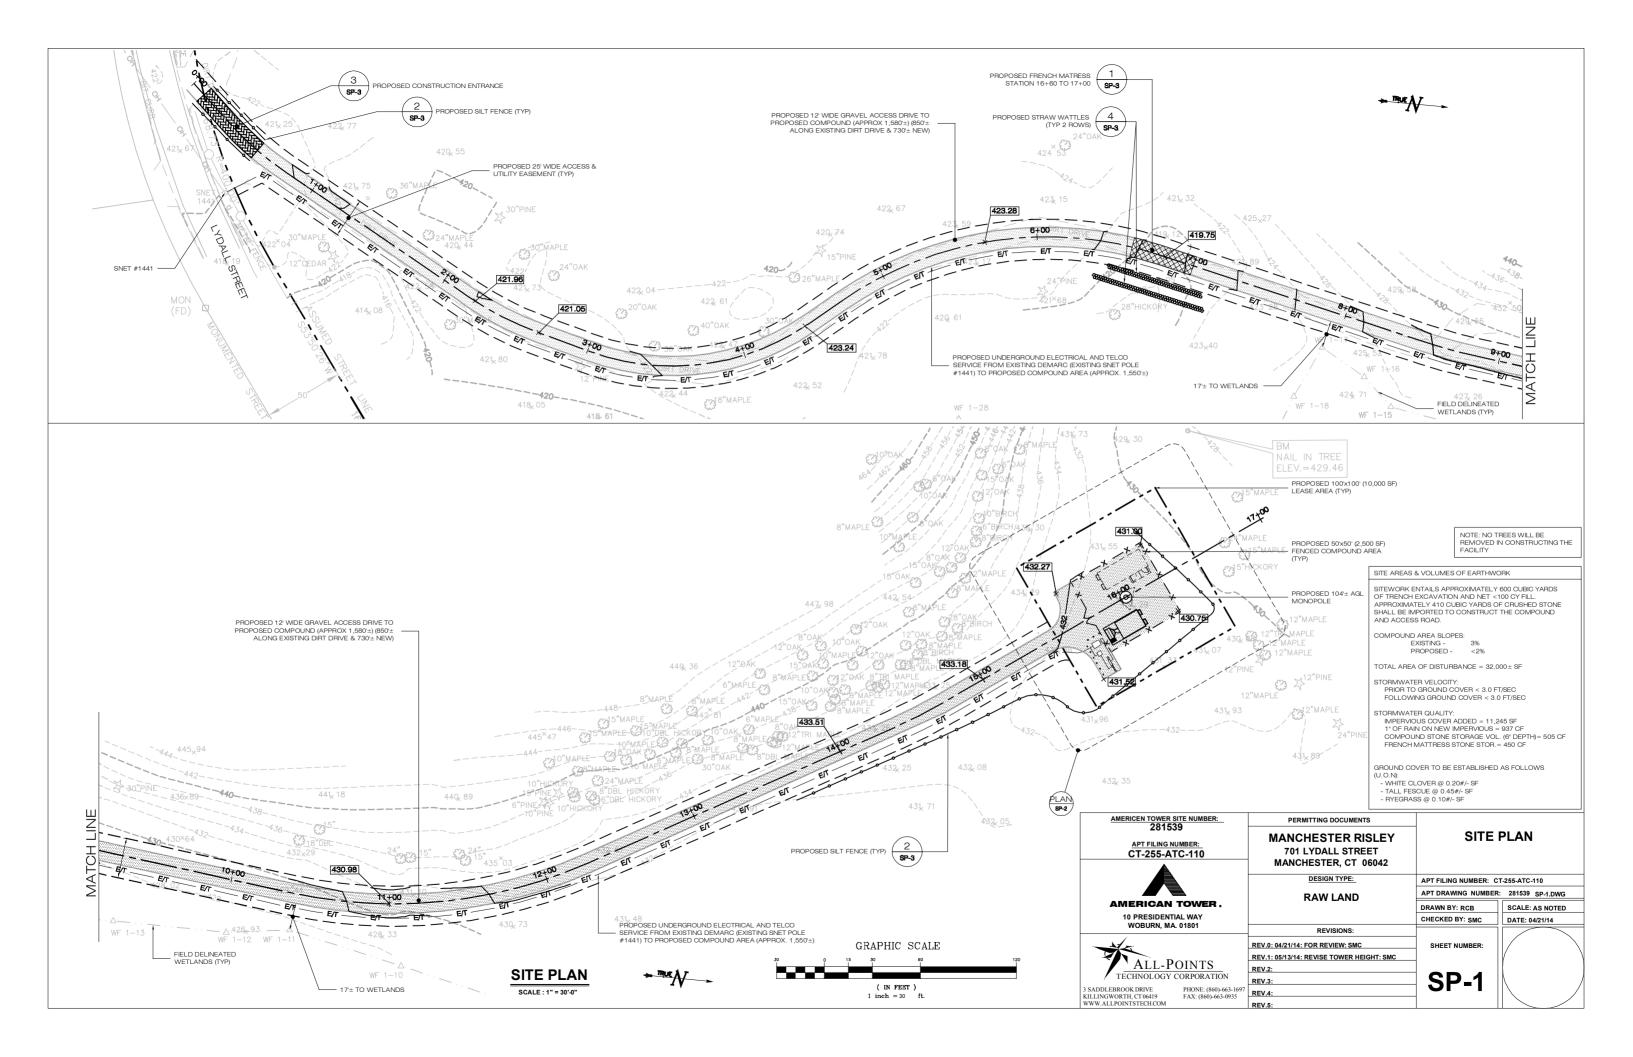

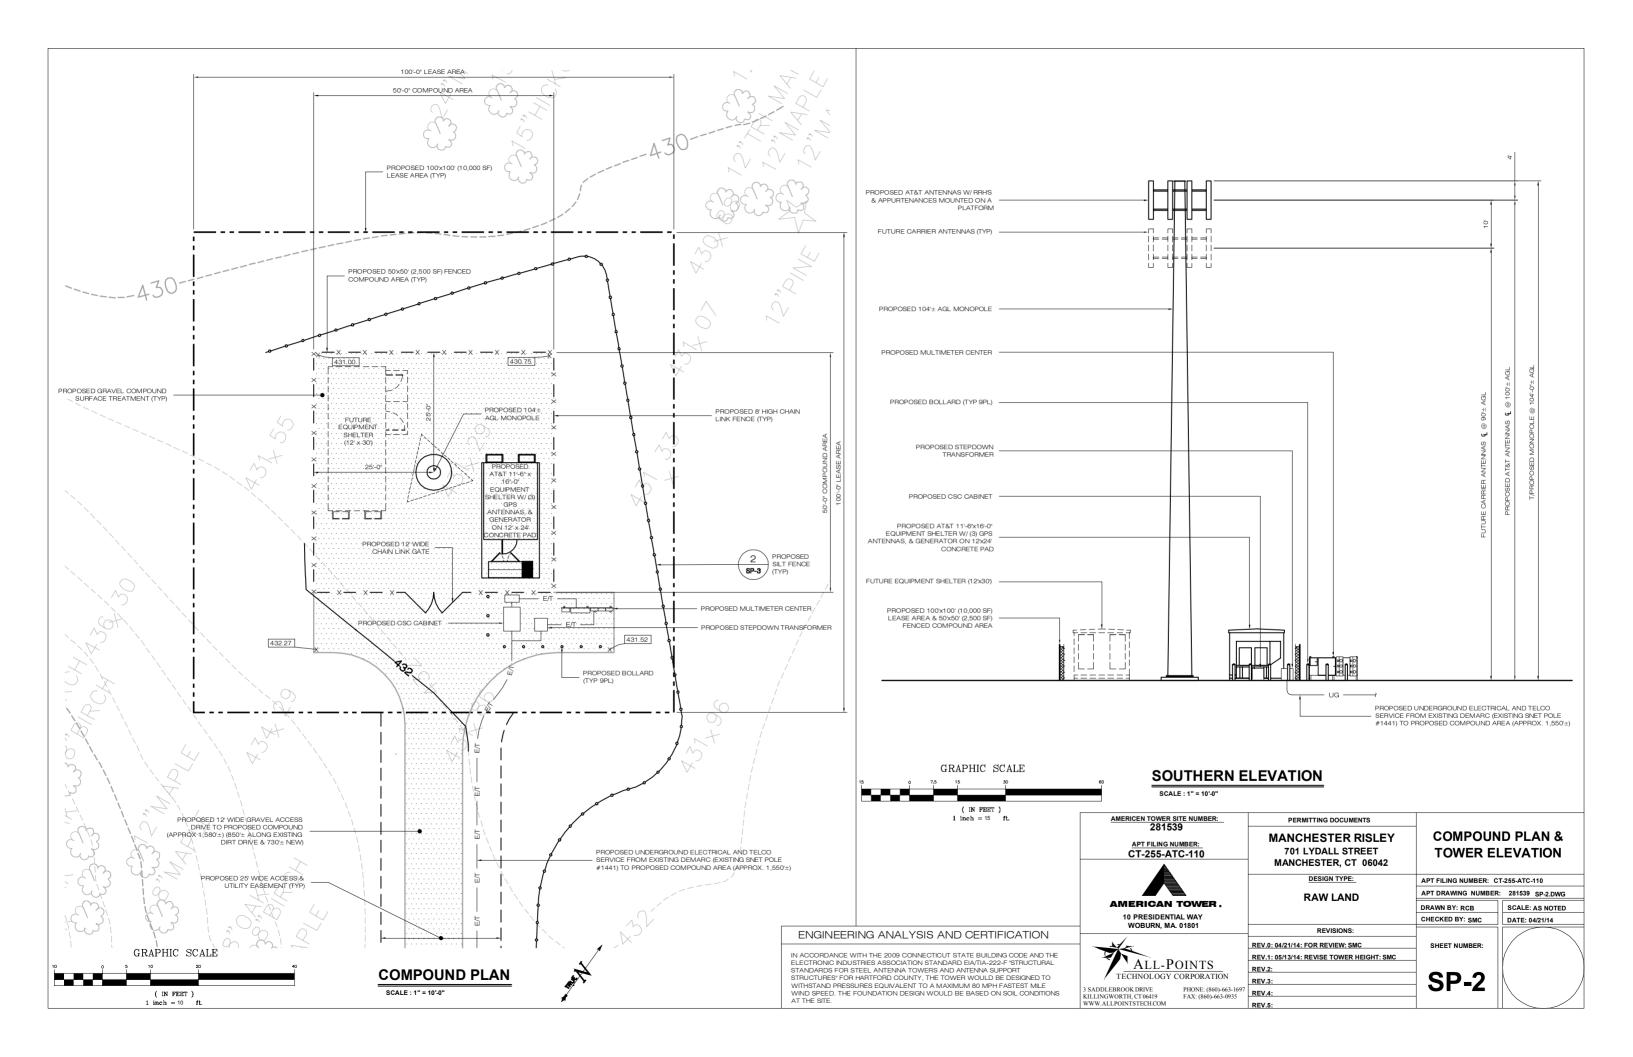


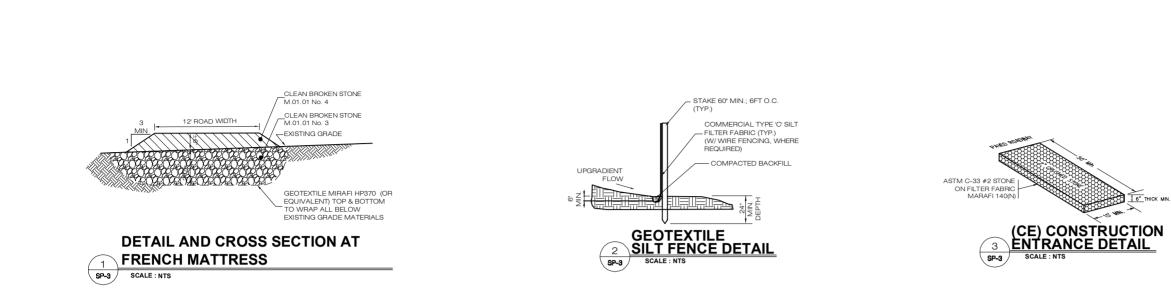

BEGIN AT THE LOCATION WHERE THE WATTLE IS TO BE INSTALLED BY EXCAVATING A 2-3" (5-7.5 CM) DEEP X 9" (22.9 CM) WIDE TRENCH ALONG THE CONTOUR OF THE SLOPE. EXCAVATED SOIL SHOULD BE PLACED UPSLOPE FROM THE ANCHOR TRENCH.
PLACE THE WATTLE IN THE TRENCH SO THAT IT CONTOURS TO THE SOIL SURFACE. COMPACT SOIL FROM THE EXCAVATED TRENCH AGAINST THE WATTLE ON THE UPHILL SIDE. ADJACENT WATTLES SHOULD TIGHTLY ABUT.
SECURE THE WATTLE WITH 18-24" (45.7-61 CM) STAKES EVERY 3-4" (0.9 -1.2 M) AND WITH A STAKE ON EACH END. STAKES SHOULD BE DRIVEN THROUGH THE MIDDLE OF THE WATTLE LEAVING AT LEAST 2-3" (6-7.5 CM) OF STAKE EXTENDING ABOVE THE WATTLE. STAKES SHOULD BE DRIVEN PERPENDICULAR TO THE SLOPE FACE.

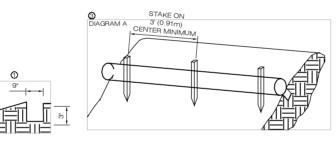



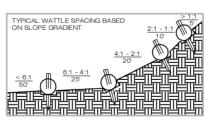

STRAW WATTLE SEDIMENTATION CONTROL BARRIER 4 SP-3 SCALE :




6" THICK MIN



5 W#

MBER:	PERMITTING DOCUMENTS	SEDIMEN	
Ō	MANCHESTER RISLEY 701 LYDALL STREET MANCHESTER, CT 06042	EROSION	CONTROL
	DESIGN TYPE:	APT FILING NUMBER: C	T-255-ATC-110
	RAW LAND	APT DRAWING NUMBER	: 281539 SP-3
ER.		DRAWN BY: RCB	SCALE: AS NOTED
ſ		CHECKED BY: SMC	DATE: 04/21/14
	REVISIONS:		
	REV.0: 04/21/14: FOR REVIEW: SMC	SHEET NUMBER:	
TC	REV.1: 05/13/14: REVISE TOWER HEIGHT: SMC	4	
TS RATION	REV.2:		
	REV.3:	SP-3	Λ /
E: (860)-663-1697 860)-663-0935	REV.4:		
	REV.5:		

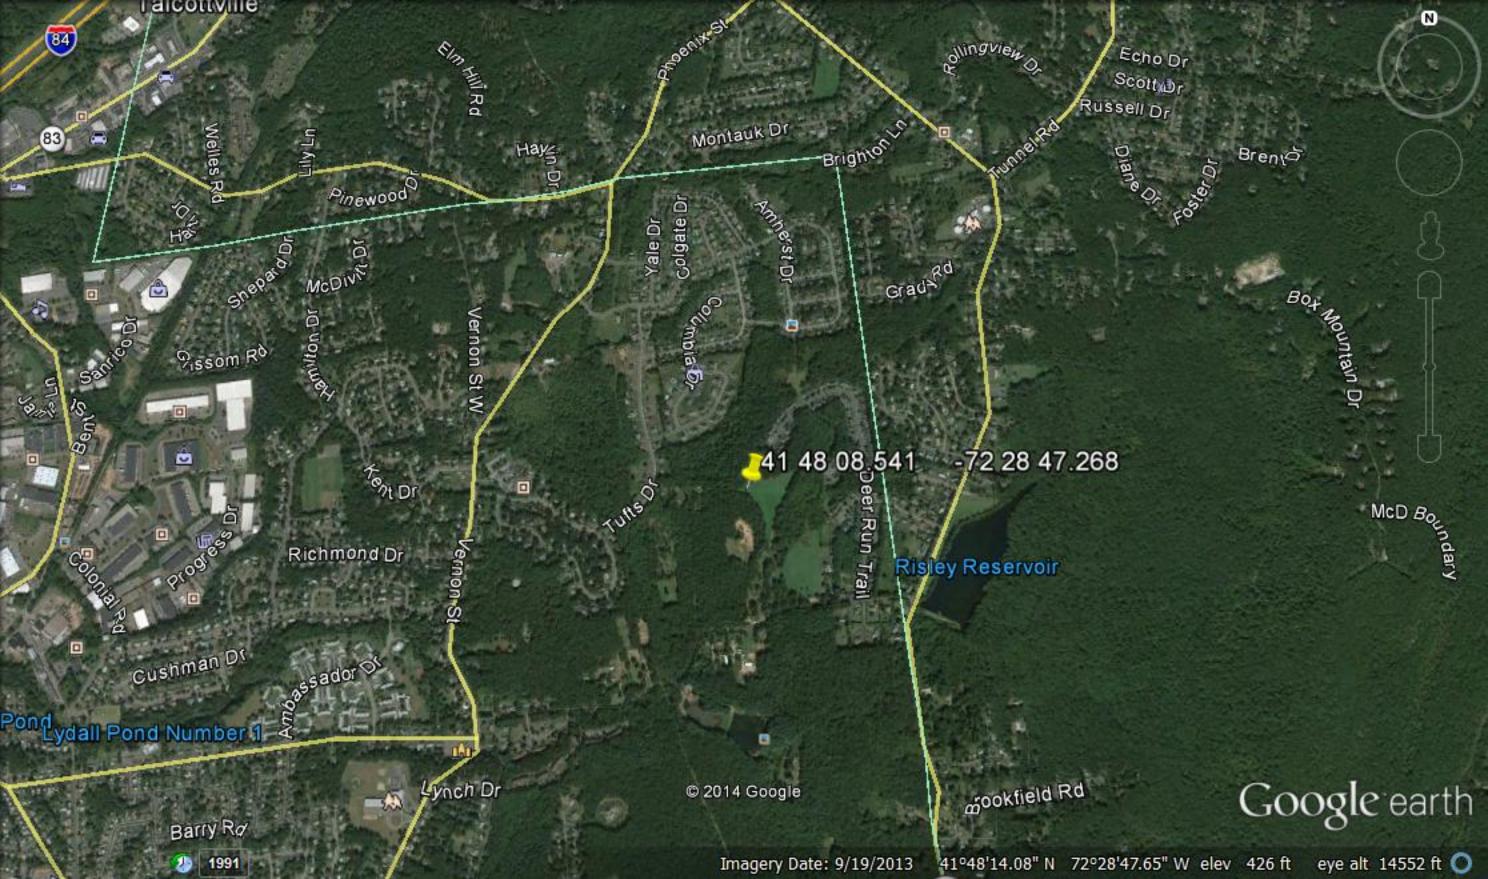



Site Impact Statement

Site: Manchester Risley Site Address: 701 Lydall Street Manchester, CT 06042

Access distances:

Distance of proposed gravel access driveway: 1,580'+/- (850'+/- along existing dirt drive and 730'+/- new).

Distance to Nearest Wetlands

300'+/- southeast of the proposed compound and 17'+/- east of the proposed access driveway.

Distance to Property Lines:

315'+/- to the northern property boundary from the tower 1359'+/- to the southern property boundary from the tower 145'+/- to the western property boundary from the tower 823'+/- to the eastern property boundary from the tower

282'+/- to the northern property boundary from the compound 1327'+/- to the southern property boundary from the compound 112'+/- to the western property boundary from the compound 788'+/- to the eastern property boundary from the compound

Residence Information:

There are 45 single family residences within 1,000' feet of the compound. The closest off site residence is approximately 452 feet to the northeast and is located at Parcel 133-1565-277 (277 Deer Run Trail).

Special Building Information:

None.

Tree Removal Count:

No trees need to be removed to construct the equipment areas.

Cut/Fill: The site improvements shall entail approximately 600 CY of cut for utility trenching and net <100 CY of fill. Approximately 410 CY of broken stone for the compound and driveway construction.

Clearing/Grading Necessary: Total area of disturbance = 32,000 SF

PARCEL ID	STREET ADDRESS	BUILDING TYPE	DISTANCE FROM COMPOUND* (ft)
133-37-633	633 LYDALL STREET	Single Family	537+/-
133-37-631	631 LYDALL STREET	Single Family	551+/-
133-37-629	155 TUFTS DRIVE	Single Family	714+/-
133-559-159	159 TUFTS DRIVE	Single Family	857+/-
133-559-139	139 TUFTS DRIVE	Single Family	914+/-
133-559-129	129 TUFTS DRIVE	Single Family	938+/-
133-5225-91	91 STEELE FARM DRIVE	Single Family	847+/-
132-5225-81	81 STEELE FARM DRIVE	Single Family	825+/-
132-5225-70	70 STEELE FARM DRIVE	Single Family	981+/-
132-5225-71	71 STEELE FARM DRIVE	Single Family	800+/-
132-5225-60	60 STEELE FARM DRIVE	Single Family	974+/-
132-5225-61	61 STEELE FARM DRIVE	Single Family	795+/-
132-5225-51	51 STEELE FARM DRIVE	Single Family	862+/-
132-5225-47	47 STEELE FARM DRIVE	Single Family	959+/-
33-1565-277	277 DEER RUN TRAIL	Single Family	452+/-
33-1565-269	269 DEER RUN TRAIL	Single Family	549+/-
32-1565-265	265 DEER RUN TRAIL	Single Family	637+/-
32-1565-263	263 DEER RUN TRAIL	Single Family	662+/-
32-1565-259	259 DEER RUN TRAIL	Single Family	694+/-
32-1565-257	257 DEER RUN TRAIL	Single Family	730+/-
32-1565-253	253 DEER RUN TRAIL	Single Family	796+/-
32-1565-249	249 DEER RUN TRAIL	Single Family	822+/-
32-1565-247	247 DEER RUN TRAIL	Single Family	851+/-
32-1565-243	243 DEER RUN TRAIL	Single Family	888+/-
32-1565-241	241 DEER RUN TRAIL	Single Family	940+/-
32-1565-237	237 DEER RUN TRAIL	Single Family	976+/-
32-1565-248	248 DEER RUN TRAIL	Single Family	831+/-
32-1565-252	252 DEER RUN TRAIL	Single Family	797+/-
32-1565-254	254 DEER RUN TRAIL	Single Family	767+/-
32-1565-258	258 DEER RUN TRAIL	Single Family	736+/-
33-1565-262	262 DEER RUN TRAIL	Single Family	662+/-
33-1565-264	264 DEER RUN TRAIL	Single Family	627+/-
33-1565-270	270 DEER RUN TRAIL	Single Family	556+/-
33-1565-278	278 DEER RUN TRAIL	Single Family	485+/-
133-3445-23	23 LEO J LANE	Single Family	986+/-
133-3445-27	27 LEO J LANE	Single Family	931+/-
133-3445-29	29 LEO J LANE	Single Family	907+/-
133-3445-30	30 LEO J LANE	Single Family	964+/-
133-3445-32	32 LEO J LANE	Single Family	924+/-
133-3445-36	36 LEO J LANE	Single Family	860+/-
133-725-19	19 BRIDLE PATH LANE	Single Family	996+/-
133-725-23	23 BRIDLE PATH LANE	Single Family	974+/-
133-725-25	25 BRIDLE PATH LANE	Single Family	964+/-
133-725-27	27 BRIDLE PATH LANE	Single Family	939+/-
133-725-29	29 BRIDLE PATH LANE	Single Family	923+/-

Tree Inventory



May 13, 2014

Cuddy & Feder, LLP Attn: Christopher Fisher, Esq. 445 Hamilton Avenue 14th Floor White Plains, NY 10601

RE: Tree Inventory Site: 281539 Manchester Risley 701 Lydall Street Manchester, CT 06042

Dear Mr. Fisher:

A Tree Inventory was completed at the subject site on January 31, 2014 to determine the size and quantity of existing trees that will need to be removed for the installation of the proposed facility. The proposed site has suitable access, but clearing and earthwork will be required to improve the access route and to construct the compound area. Installation of the proposed compound area improvements will not require the removal of any trees (≥ 6 " dbh).

The area to be disturbed for construction of the compound area will be approximately 2,500 square feet of existing pasture area. The area to be cleared is located on the interior of the site. An existing improved dirt drive and proposed gravel access driveway extension will provide access to the proposed compound. The total combined area of disturbance for compound, access way, and utility improvements is approximately 32,000 sf.

Sincerely,

ALL-POINTS TECHNOLOGY CORPORATION, P.C.

Scott M. Chasse, P.E. Principal

FAA 1-A SURVEY CERTIFICATION

<u>Applicant:</u>	American Tower 19 Presidential Way Woburn, MA 01801
Site Name:	VERNON RISLEY LAKE
Address	701 Lydall Street Manchester, Connecticut 06040
Horizontal Datum:	NAD 83
Vertical Datum:	N.A.V.D. 88
Structure Type:	Proposed Monopole
Latitude: Longitude:	41°- 48'-08.541"N NAD 83 72°- 28'-47.268''W NAD 83
Existing Ground Elevation:	431.3'± feet N.A.V.D. 88
Proposed Top of Monopole	$104.0' \pm$ feet A.G.L. (535.3 \pm N.A.V.D. 88)

Certification:

I certify that the Latitude and Longitude noted hereon are accurate to within \pm -3 feet horizontally and that the site elevation is accurate to within \pm 1 feet vertically. With a proposed top of tower of 104.0' \pm AGL, the overall height will be 535.3' \pm N.A.V.D. 88. The horizontal datum (coordinates) are in terms of the North American Datum of 1983 (NAD 83) and are expressed in degrees minutes and seconds to the nearest thousandth of a second. The vertical datum (heights) are in terms of the North American Vertical Datum of 1988 and expressed to the nearest foot.

Company:

Martinez Gouch and Associates L.L.C.

Angel R. Martinez L. S. 18833 February 13, 2014 May 28, 2014



Signature: Surveyor/seal: Date: Revised Date:



FCC > WTB > ASR > Online Systems > TOWAIR

TOWAIR Determination Results

? HELP

FCC Site Map

🔍 <u>New Search</u> 💾 <u>Printable Page</u>

*** NOTICE ***

TOWAIR's findings are not definitive or binding, and we cannot guarantee that the data in TOWAIR are fully current and accurate. In some instances, TOWAIR may yield results that differ from application of the criteria set out in 47 C.F.R. Section 17.7 and 14 C.F.R. Section 77.13. A positive finding by TOWAIR recommending notification should be given considerable weight. On the other hand, a finding by TOWAIR recommending either for or against notification is not conclusive. It is the responsibility of each ASR participant to exercise due diligence to determine if it must coordinate its structure with the FAA. TOWAIR is only one tool designed to assist ASR participants in exercising this due diligence, and further investigation may be necessary to determine if FAA coordination is appropriate.

DETERMINATION Results

Structure does not require registration. There are no airports within 8 kilometers (5 miles) of the coordinates you provided.

Your Specifications

NAD83 Coordinates	
Latitude	41-48-08.5 north
Longitude	072-28-47.3 west
Measurements (Meters)	
Overall Structure Height (AGL)	31.7
Support Structure Height (AGL)	30.5
Site Elevation (AMSL)	131.5
Structure Type	
MTOWER - Monopole	

Tower Construction Notifications

Notify Tribes and Historic Preservation Officers of your plans to build a tower.

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