

Thomas J. Regan
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Hartford
Connecticut
06103
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January 20, 2015

Via Hand Delivery

Ms. Melanie Bachman
Executive Director
Connecticut Siting Council
Ten Franklin Square
New Britain, Connecticut 06051

**RE: Docket No. 417 – Certificate of Environmental Compatibility and Public Need for a
Telecommunications Facility at Moose Hill Road in Guilford, Connecticut
Request for Extension of Time to Complete Construction**

Dear Ms. Bachman:

On behalf of Bay Communications II LLC (“Bay Communications”), please find enclosed for filing in this Docket two (2) full size and thirteen (13) 11” x 17” copies of the Development & Management plan prepared by All-Points Technology Corporation.

The Connecticut Siting Council (the “Council”) approved the above-captioned telecommunications facility on October 6, 2011. On October 17, 2013, the Council approved the transfer of the Certificate of Environmental Compatibility and Public Need (the “Certificate”) from T-Mobile Northeast, LLC to Bay Communications and on December 31, 2013, the Council approved request for an extension of time to construct the facility in this docket until April 8, 2014. Over the past year Bay Communications developed an environmental assessment for a stream crossing for the facility and is now prepared to proceed with construction.

As a result, Bay respectfully requests an additional extension of time pursuant to Conn. Agencies Regs. § 16-50j-6 to complete the construction of, and to begin providing wireless services from, the above-referenced telecommunication facility.

Very truly yours,

BROWN RUDNICK LLP


By: 

Thomas J. Regan


cc: via Fed Ex - Joseph S. Mazza, First Selectman of Guilford
(enclosing one 11”x17” copy of the D&M plan)

61846564 v1-WorkSiteUS-023509/0040

LOCATION MAP

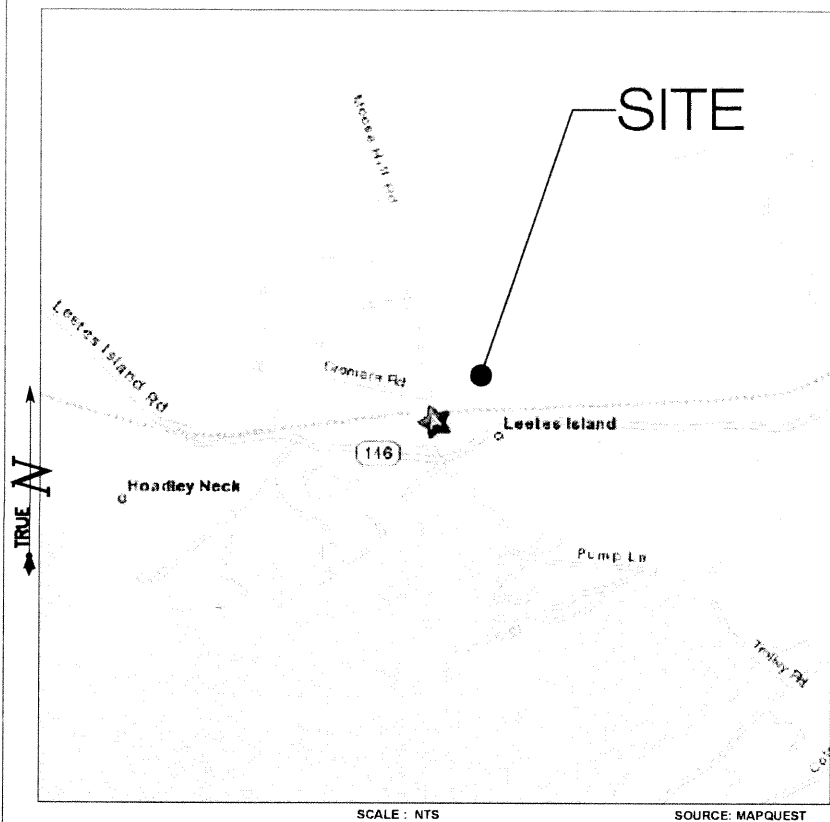

USGS TOPOGRAPHIC MAP

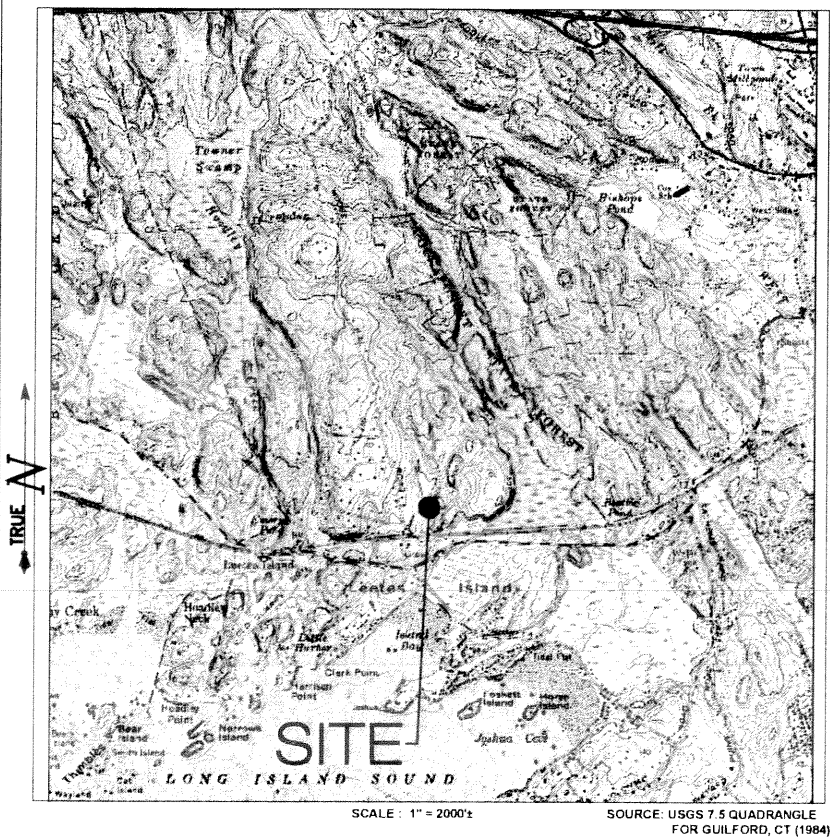

**391 OAKLAND STREET
SECOND FLOOR
MANSFIELD, MA 02048**

OFFICE: (774) 719-2146

**DEVELOPMENT & MANAGEMENT PLAN
DRAWING INDEX**

- | | |
|-------------------------------------|---------------------------------------|
| T-1 TITLE SHEET & INDEX | C-1 T-MOBILE EQUIPMENT PLAN & DETAILS |
| R-1 ABUTTERS MAP | S-1 COMPOUND DETAILS |
| SP-1 SITE PLAN | S-2 ACCESS DRIVEWAY PROFILE & DETAILS |
| SP-2 ENVIRONMENTAL NOTES & DETAILS | N-1 NOTES & SPECIFICATIONS |
| A-1 COMPOUND PLAN & TOWER ELEVATION | |

***SITE INFORMATION:**

-SITE NAME.....	GUILFORD	-ZONE.....	R-8
-SITE ID NUMBER.....	CT0007	-LATITUDE.....	41° 16' 02.88" N
-SITE ADDRESS.....	MOOSE HILL ROAD GUILFORD, CT 06437	-LONGITUDE.....	72° 42' 57.81" W
		-ELEVATION.....	52 ± AMSL
		-FEMA/FIRM.....	
		DESIGNATION.....	ZONE C
-MAP.....	66	-ACREAGE.....	163.0 Ac
-BLOCK.....	N/A		
-LOT.....	64		



3 SADDLEBROOK DRIVE
KILLINGWORTH, CT 06419
WWW.ALLPOINTSTECH.COM

PHONE: (860)-663-1697
FAX: (860)-663-0935

CONTACT PERSONNEL

APPLICANT:
BAY COMMUNICATIONS II, LLC
391 OAKLAND STREET
SECOND FLOOR
MANSFIELD, MA 02048

LANDLORD:
LEETE ASSOCIATES, INC
P.O. BOX 45
GUILFORD, CT 06437

BAY COMMUNICATIONS PROJECT MANAGER:
VINCENT GRANESE (781) 608-1002

BAY COMMUNICATIONS PROJECT ATTORNEY:
THOMAS J. REGAN, ESQ.
BROWN RUDNICK LLP
CITY PLACE
185 ASYLUM STREET
HARTFORD, CT 06103
(860) 509-6526

POWER PROVIDER:
CL&P (203) 245-5414
KEITH SURAVICH - CASE # 2293099

TELCO PROVIDER:
AT&T: (800)-727-8368

CALL BEFORE YOU DIG:
(800) 922-4455


GOVERNING CODES:
2005 CONNECTICUT BUILDING CODE (2003 IBC BASI S)
NATIONAL ELECTRIC CODE
EIA/TIA 222F

U.S. ARMY CORPS OF ENGINEERS
PERMIT NUMBER: NAE-2014-214

SITE INFORMATION


**CT0007
GUILFORD
MOOSE HILL ROAD
GUILFORD, CT 06437**

DEVELOPMENT & MANAGEMENT DOCUMENTS	TITLE SHEET & INDEX
GUILFORD MOOSE HILL ROAD GUILFORD, CT 06437	
DESIGN TYPE:	APT FILING NUMBER: CT-265-160
RAW LAND	APT DRAWING NUMBER: CT0007 T-1 DWG
	DRAWN BY: RCB SCALE: AS NOTED
	CHECKED BY: SMC DATE: 09/04/14
REVISIONS:	SHEET NUMBER:
REV. 0: 09/04/14: FOR REVIEW: SMC	T-1
REV. 1: 01/13/15: TOWER REVISIONS: SMC	
REV. 2:	
REV. 3:	
REV. 4:	
REV. 5:	

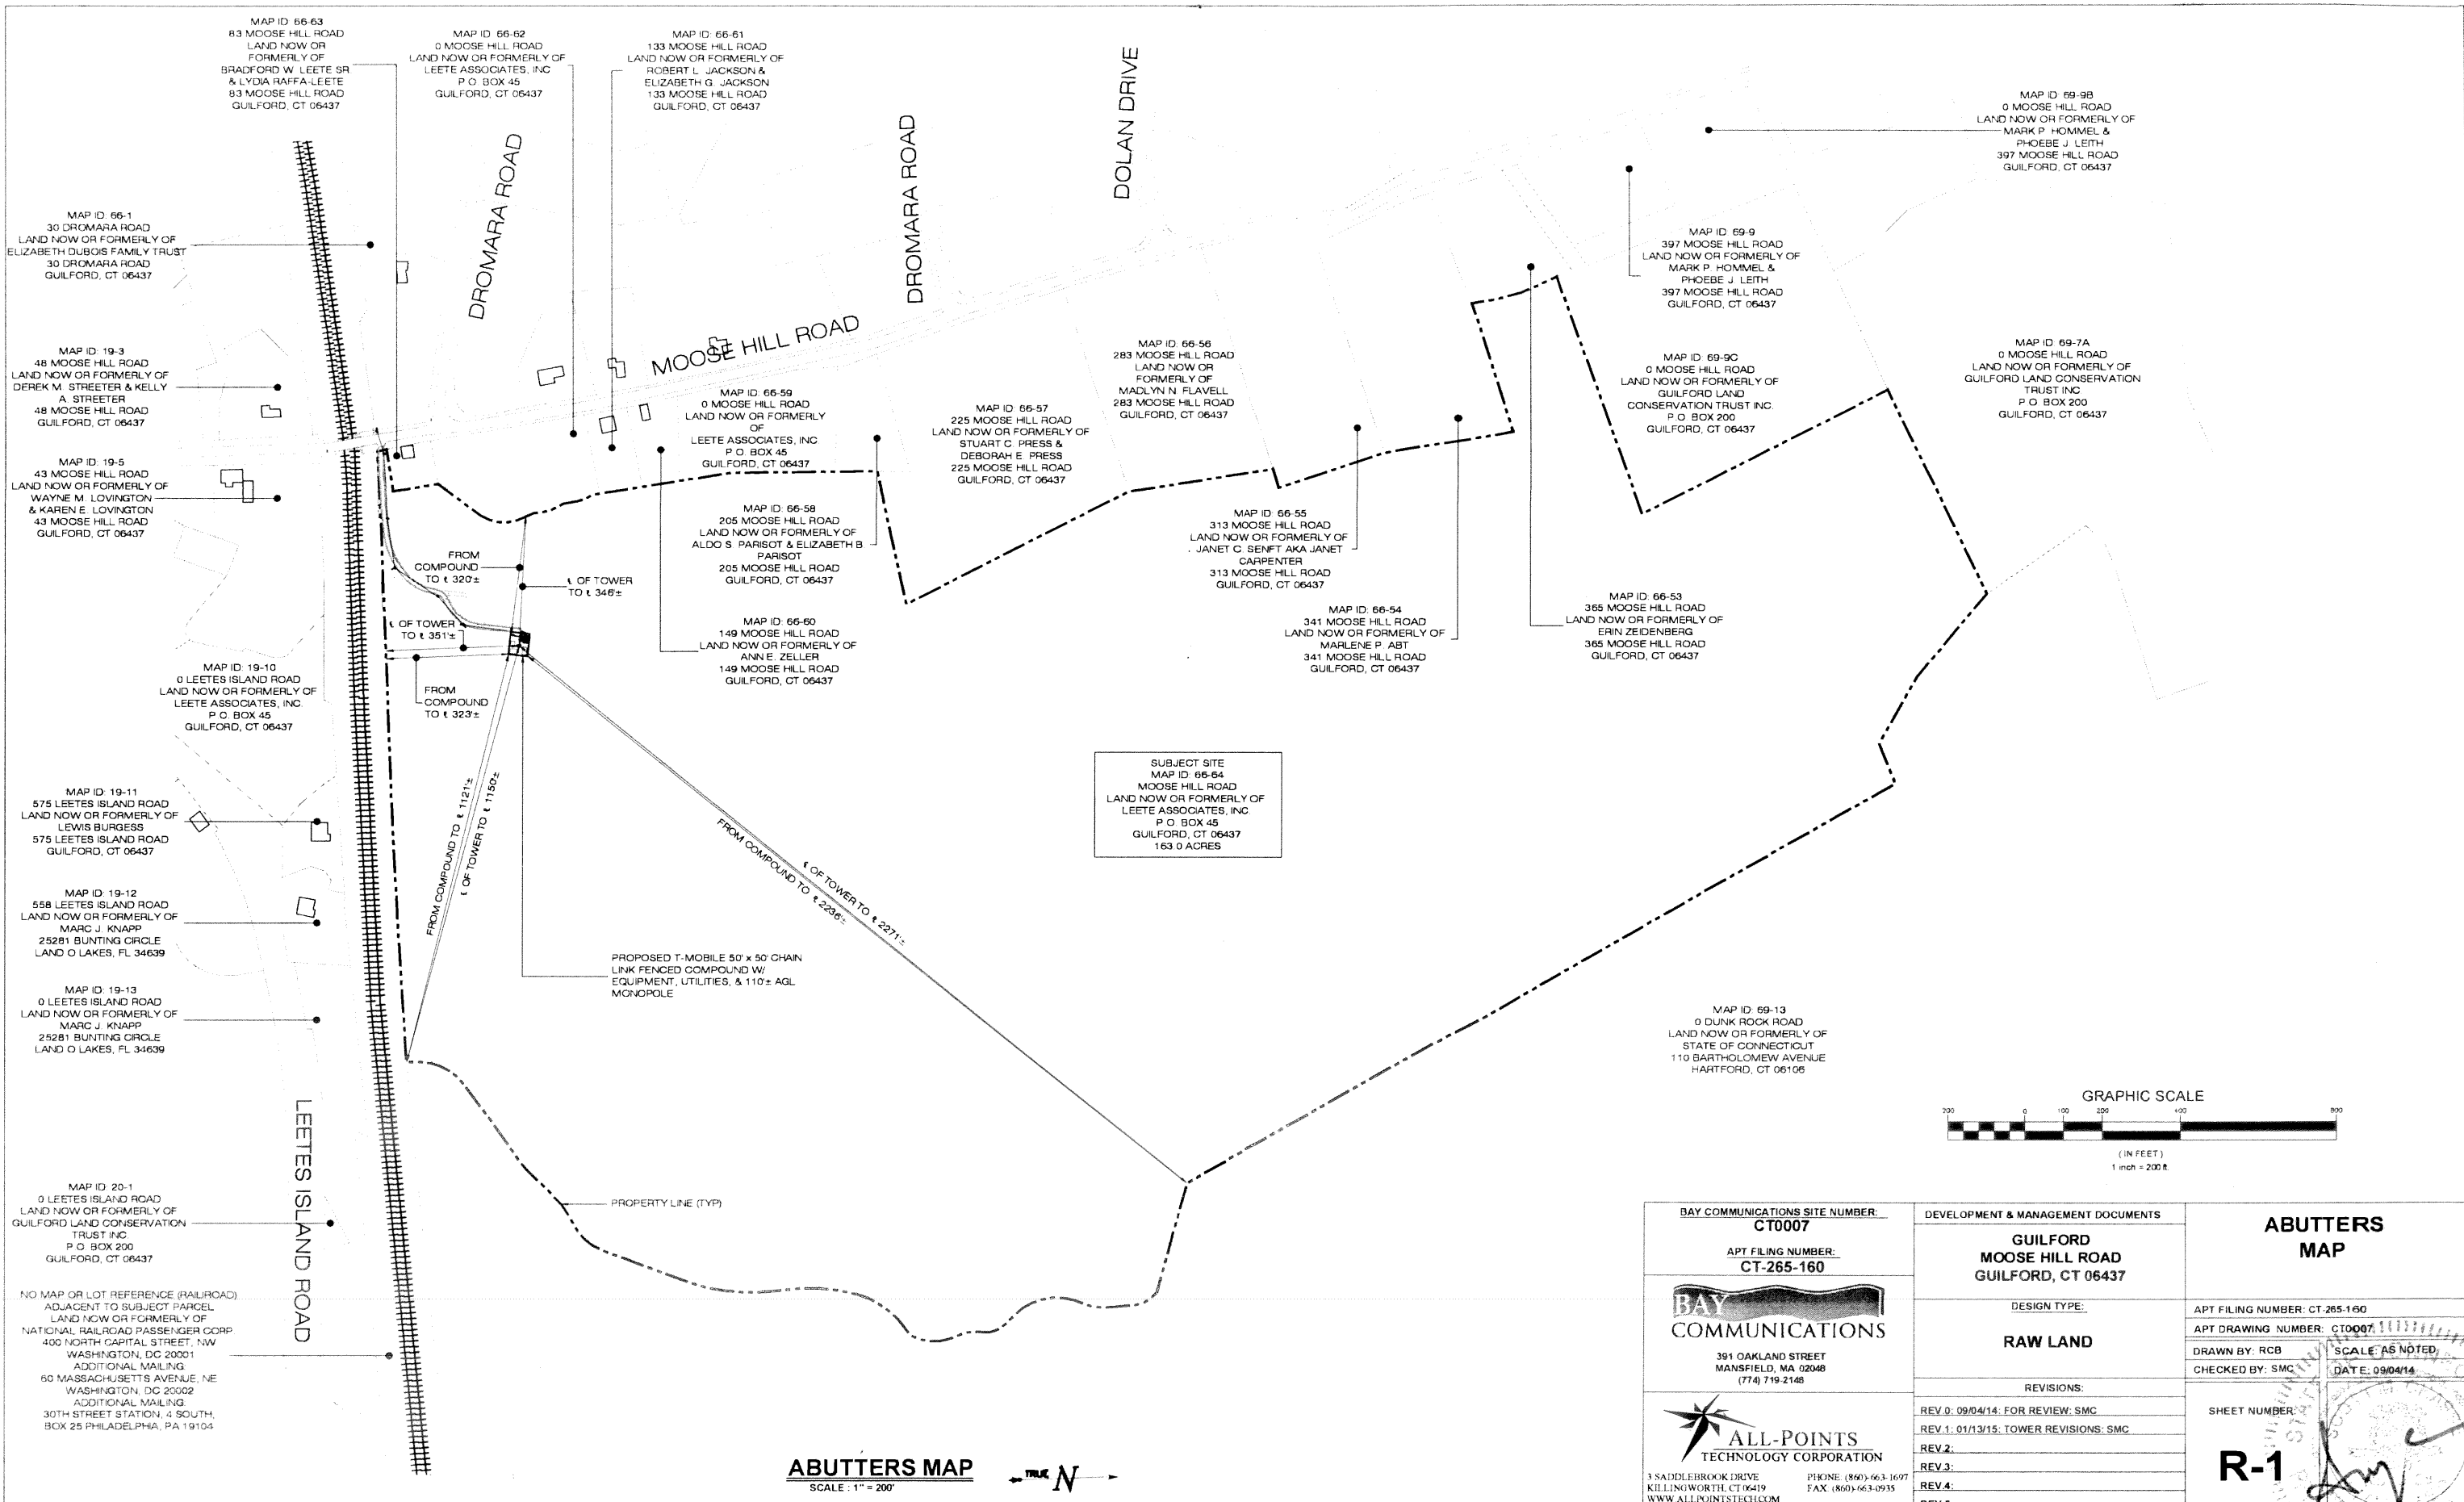

SUBJECT SITE
 MAP ID 66-64
 MOOSE HILL ROAD
 LAND NOW OR FORMERLY OF
 LEETE ASSOCIATES, INC
 P. O. BOX 45
 GUILFORD, CT 06437
 163.0 ACRES

PROPOSED T-MOBILE 50' x 50' CHAIN
 LINK FENCED COMPOUND W/
 EQUIPMENT, UTILITIES, & 110'± AGL
 MONOPOLE

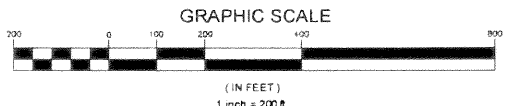

ABUTTERS MAP
 SCALE: 1" = 200'
 N

BAY COMMUNICATIONS SITE NUMBER: CT0007 APT FILING NUMBER: CT-265-160 391 OAKLAND STREET MANSFIELD, MA 02048 (774) 719-2148 ALL-POINTS TECHNOLOGY CORPORATION 3 SADDLEBROOK DRIVE KILLINGWORTH, CT 06419 WWW.ALLPOINTSTECH.COM	DEVELOPMENT & MANAGEMENT DOCUMENTS GUILFORD MOOSE HILL ROAD GUILFORD, CT 06437		ABUTTERS MAP	
	DESIGN TYPE: RAW LAND		APT FILING NUMBER: CT-265-160 APT DRAWING NUMBER: CT0007	
	REVISIONS: REV 0: 09/04/14: FOR REVIEW: SMC REV 1: 01/13/15: TOWER REVISIONS: SMC REV 2: REV 3: REV 4: REV 5:		SCALE AS NOTED DATE: 09/04/14	
	SHEET NUMBER: R-1			
	DRAWN BY: RCB CHECKED BY: SMC		DATE: 09/04/14	

NO MAP OR LOT REFERENCE (RAILROAD)
 ADJACENT TO SUBJECT PARCEL
 LAND NOW OR FORMERLY OF
 NATIONAL RAILROAD PASSENGER CORP
 400 NORTH CAPITAL STREET, NW
 WASHINGTON, DC 20001
 ADDITIONAL MAILING
 60 MASSACHUSETTS AVENUE, NE
 WASHINGTON, DC 20002
 ADDITIONAL MAILING
 30TH STREET STATION, 4 SOUTH,
 BOX 25 PHILADELPHIA, PA 19104

LEETES ISLAND ROAD

FROM COMPOUND TO ± 1121'±
 ± OF TOWER TO ± 1180'±

FROM COMPOUND TO ± 323'±

± OF TOWER TO ± 351'±

FROM COMPOUND TO ± 320'±

± OF TOWER TO ± 346'±

± OF TOWER TO ± 2236'±
 FROM COMPOUND TO ± 2271'±

PROPERTY LINE (TYP)

MAP ID 66-63
 83 MOOSE HILL ROAD
 LAND NOW OR FORMERLY OF
 BRADFORD W. LEETE SR
 & LYDIA RAFFA-LEETE
 83 MOOSE HILL ROAD
 GUILFORD, CT 06437

MAP ID 66-62
 0 MOOSE HILL ROAD
 LAND NOW OR FORMERLY OF
 LEETE ASSOCIATES, INC
 P. O. BOX 45
 GUILFORD, CT 06437

MAP ID 66-61
 133 MOOSE HILL ROAD
 LAND NOW OR FORMERLY OF
 ROBERT L. JACKSON &
 ELIZABETH G. JACKSON
 133 MOOSE HILL ROAD
 GUILFORD, CT 06437

MAP ID 66-1
 30 DROMARA ROAD
 LAND NOW OR FORMERLY OF
 ELIZABETH DUBOIS FAMILY TRUST
 30 DROMARA ROAD
 GUILFORD, CT 06437

MAP ID 19-3
 48 MOOSE HILL ROAD
 LAND NOW OR FORMERLY OF
 DEREK M. STREETER & KELLY
 A. STREETER
 48 MOOSE HILL ROAD
 GUILFORD, CT 06437

MAP ID 19-5
 43 MOOSE HILL ROAD
 LAND NOW OR FORMERLY OF
 WAYNE M. LOVINGTON
 & KAREN E. LOVINGTON
 43 MOOSE HILL ROAD
 GUILFORD, CT 06437

MAP ID 19-10
 0 LEETES ISLAND ROAD
 LAND NOW OR FORMERLY OF
 LEETE ASSOCIATES, INC
 P. O. BOX 45
 GUILFORD, CT 06437

MAP ID 19-11
 575 LEETES ISLAND ROAD
 LAND NOW OR FORMERLY OF
 LEWIS BURGESS
 575 LEETES ISLAND ROAD
 GUILFORD, CT 06437

MAP ID 19-12
 558 LEETES ISLAND ROAD
 LAND NOW OR FORMERLY OF
 MARC J. KNAPP
 25281 BUNTING CIRCLE
 LAND O LAKES, FL 34639

MAP ID 19-13
 0 LEETES ISLAND ROAD
 LAND NOW OR FORMERLY OF
 MARC J. KNAPP
 25281 BUNTING CIRCLE
 LAND O LAKES, FL 34639

MAP ID 20-1
 0 LEETES ISLAND ROAD
 LAND NOW OR FORMERLY OF
 GUILFORD LAND CONSERVATION
 TRUST INC
 P. O. BOX 200
 GUILFORD, CT 06437

MAP ID 66-59
 0 MOOSE HILL ROAD
 LAND NOW OR FORMERLY OF
 LEETE ASSOCIATES, INC
 P. O. BOX 45
 GUILFORD, CT 06437

MAP ID 66-58
 205 MOOSE HILL ROAD
 LAND NOW OR FORMERLY OF
 ALDO S. PARISOT & ELIZABETH B.
 PARISOT
 205 MOOSE HILL ROAD
 GUILFORD, CT 06437

MAP ID 66-60
 149 MOOSE HILL ROAD
 LAND NOW OR FORMERLY OF
 ANNE E. ZELLER
 149 MOOSE HILL ROAD
 GUILFORD, CT 06437

MAP ID 66-57
 225 MOOSE HILL ROAD
 LAND NOW OR FORMERLY OF
 STUART C. PRESS &
 DEBORAH E. PRESS
 225 MOOSE HILL ROAD
 GUILFORD, CT 06437

MAP ID 66-56
 283 MOOSE HILL ROAD
 LAND NOW OR FORMERLY OF
 MADLYN N. FLAVELL
 283 MOOSE HILL ROAD
 GUILFORD, CT 06437

MAP ID 66-55
 313 MOOSE HILL ROAD
 LAND NOW OR FORMERLY OF
 JANET C. SENFT AKA JANET
 CARPENTER
 313 MOOSE HILL ROAD
 GUILFORD, CT 06437

MAP ID 66-54
 341 MOOSE HILL ROAD
 LAND NOW OR FORMERLY OF
 MARLENE P. ABT
 341 MOOSE HILL ROAD
 GUILFORD, CT 06437

MAP ID 69-9
 397 MOOSE HILL ROAD
 LAND NOW OR FORMERLY OF
 MARK P. HOMMEL &
 PHOEBE J. LEITH
 397 MOOSE HILL ROAD
 GUILFORD, CT 06437

MAP ID 69-9C
 0 MOOSE HILL ROAD
 LAND NOW OR FORMERLY OF
 GUILFORD LAND
 CONSERVATION TRUST INC.
 P. O. BOX 200
 GUILFORD, CT 06437

MAP ID 69-9B
 0 MOOSE HILL ROAD
 LAND NOW OR FORMERLY OF
 MARK P. HOMMEL &
 PHOEBE J. LEITH
 397 MOOSE HILL ROAD
 GUILFORD, CT 06437

MAP ID 69-7A
 0 MOOSE HILL ROAD
 LAND NOW OR FORMERLY OF
 GUILFORD LAND CONSERVATION
 TRUST INC
 P. O. BOX 200
 GUILFORD, CT 06437

MAP ID 69-13
 0 DUNK ROCK ROAD
 LAND NOW OR FORMERLY OF
 STATE OF CONNECTICUT
 110 BARTHOLOMEW AVENUE
 HARTFORD, CT 06106

NOTES

1 THIS MAP AND SURVEY HAVE BEEN PREPARED PURSUANT TO THE REGULATIONS OF CONNECTICUT STATE AGENCIES SECTIONS 20-300b-1 THROUGH 20-300b-20 AND THE STANDARDS FOR SURVEYS AND MAPS IN THE STATE OF CONNECTICUT AS ADOPTED BY THE CONNECTICUT ASSOCIATION OF LAND SURVEYORS, INC ON SEPTEMBER 26, 1996

THE TYPE OF SURVEY PERFORMED AND THE MAPPED FEATURES DEPICTED HEREON ARE IN ACCORDANCE WITH THE REQUIREMENTS OF A TOPOGRAPHIC SURVEY. BOUNDARY LINES DEPICTED HEREON ARE COMPILED FROM OTHER MAPS, DEEDS, AND A LIMITED FIELD SURVEY. THESE LINES DO NOT REPRESENT A PROPERTY BOUNDARY OPINION AND ARE SUBJECT TO CHANGE BASED ON A COMPLETE FIELD SURVEY

2 VERTICAL ACCURACY CLASS T-2 ELEVATIONS REFER TO NORTH AMERICAN VERTICAL DATUM 1988. TOPOGRAPHIC INFORMATION IS DEPICTED ONLY FOR A PORTION OF THE PROPERTY. FIELD SURVEYED DECEMBER 1, 2009

3 NORTH REFERS TO TOWN OF GUILFORD ASSESSORS MAPS

4 REFERENCE MAPS

(A) "RIGHT OF WAY AND TRACK MAP, THE NEW YORK NEW HAVEN AND HARTFORD R.R. CO., FROM NEW HAVEN TO NEW LONDON, STATION 739+05 TO 791+85, TOWN OF GUILFORD, STATE OF CONN., SHEET 13 OF 55, SCALE 1"=100', DATED JUNE 30, 1915

(B) "MAP SHOWING PROPERTY OF PETER WOERNER," PREPARED BY ERIC ANDERSON, SCALE 1"=40', DATED APRIL 10, 1978

(C) "MAP OF PROPERTY OWNED BY NY THE NEW YORK, NEW HAVEN & HARTFORD RAILROAD COMPANY TO BE CONVEYED TO JONATHAN T. & LINDA FRAWLEY HOWEY," PREPARED BY ROBERT C. HART, SCALE 1"=30', DATED 4-12-2001 AND REVISED 6-25-01

5 ACCORDING TO FIRST AMERICAN TITLE INSURANCE COMPANY COMMITMENT FOR TITLE INSURANCE NUMBER HPC-CTN-805, THERE ARE NO COVENANTS, RESTRICTIONS, EASEMENTS OR RIGHTS-OF-WAY AFFECTING THE PORTIONS OF THE PROPERTY DEPICTED HEREON




6 PARCEL OWNER OF RECORD

LEETE ASSOCIATES, INC.
P.O. BOX 45
GUILFORD, CT 06437
DEED REFERENCES: VOLUME 734, PAGES 353, 355, 357

7 SUBSURFACE AND ENVIRONMENTAL CONDITIONS WERE NOT EXAMINED OR CONSIDERED AS PART OF THIS SURVEY.

8 WETLAND FLAGS SET BY SOIL SCIENCE AND ENVIRONMENTAL SERVICES, INC.

9 TREES HAVING A CALIPER OF 9" AND GREATER LOCATED ONLY ON A PORTION OF THE PROPERTY

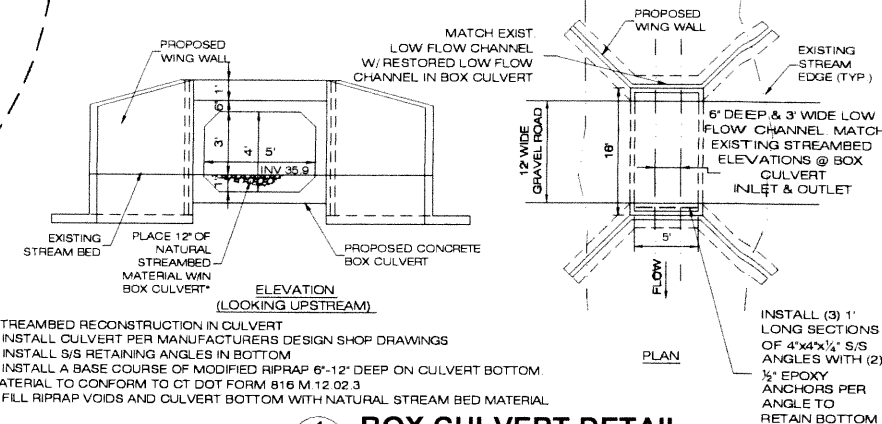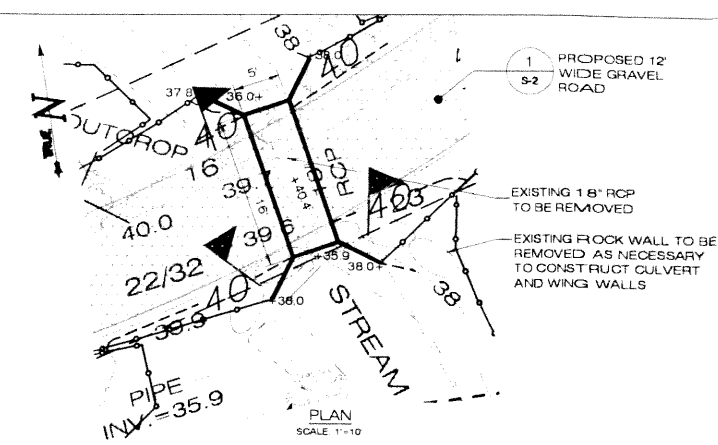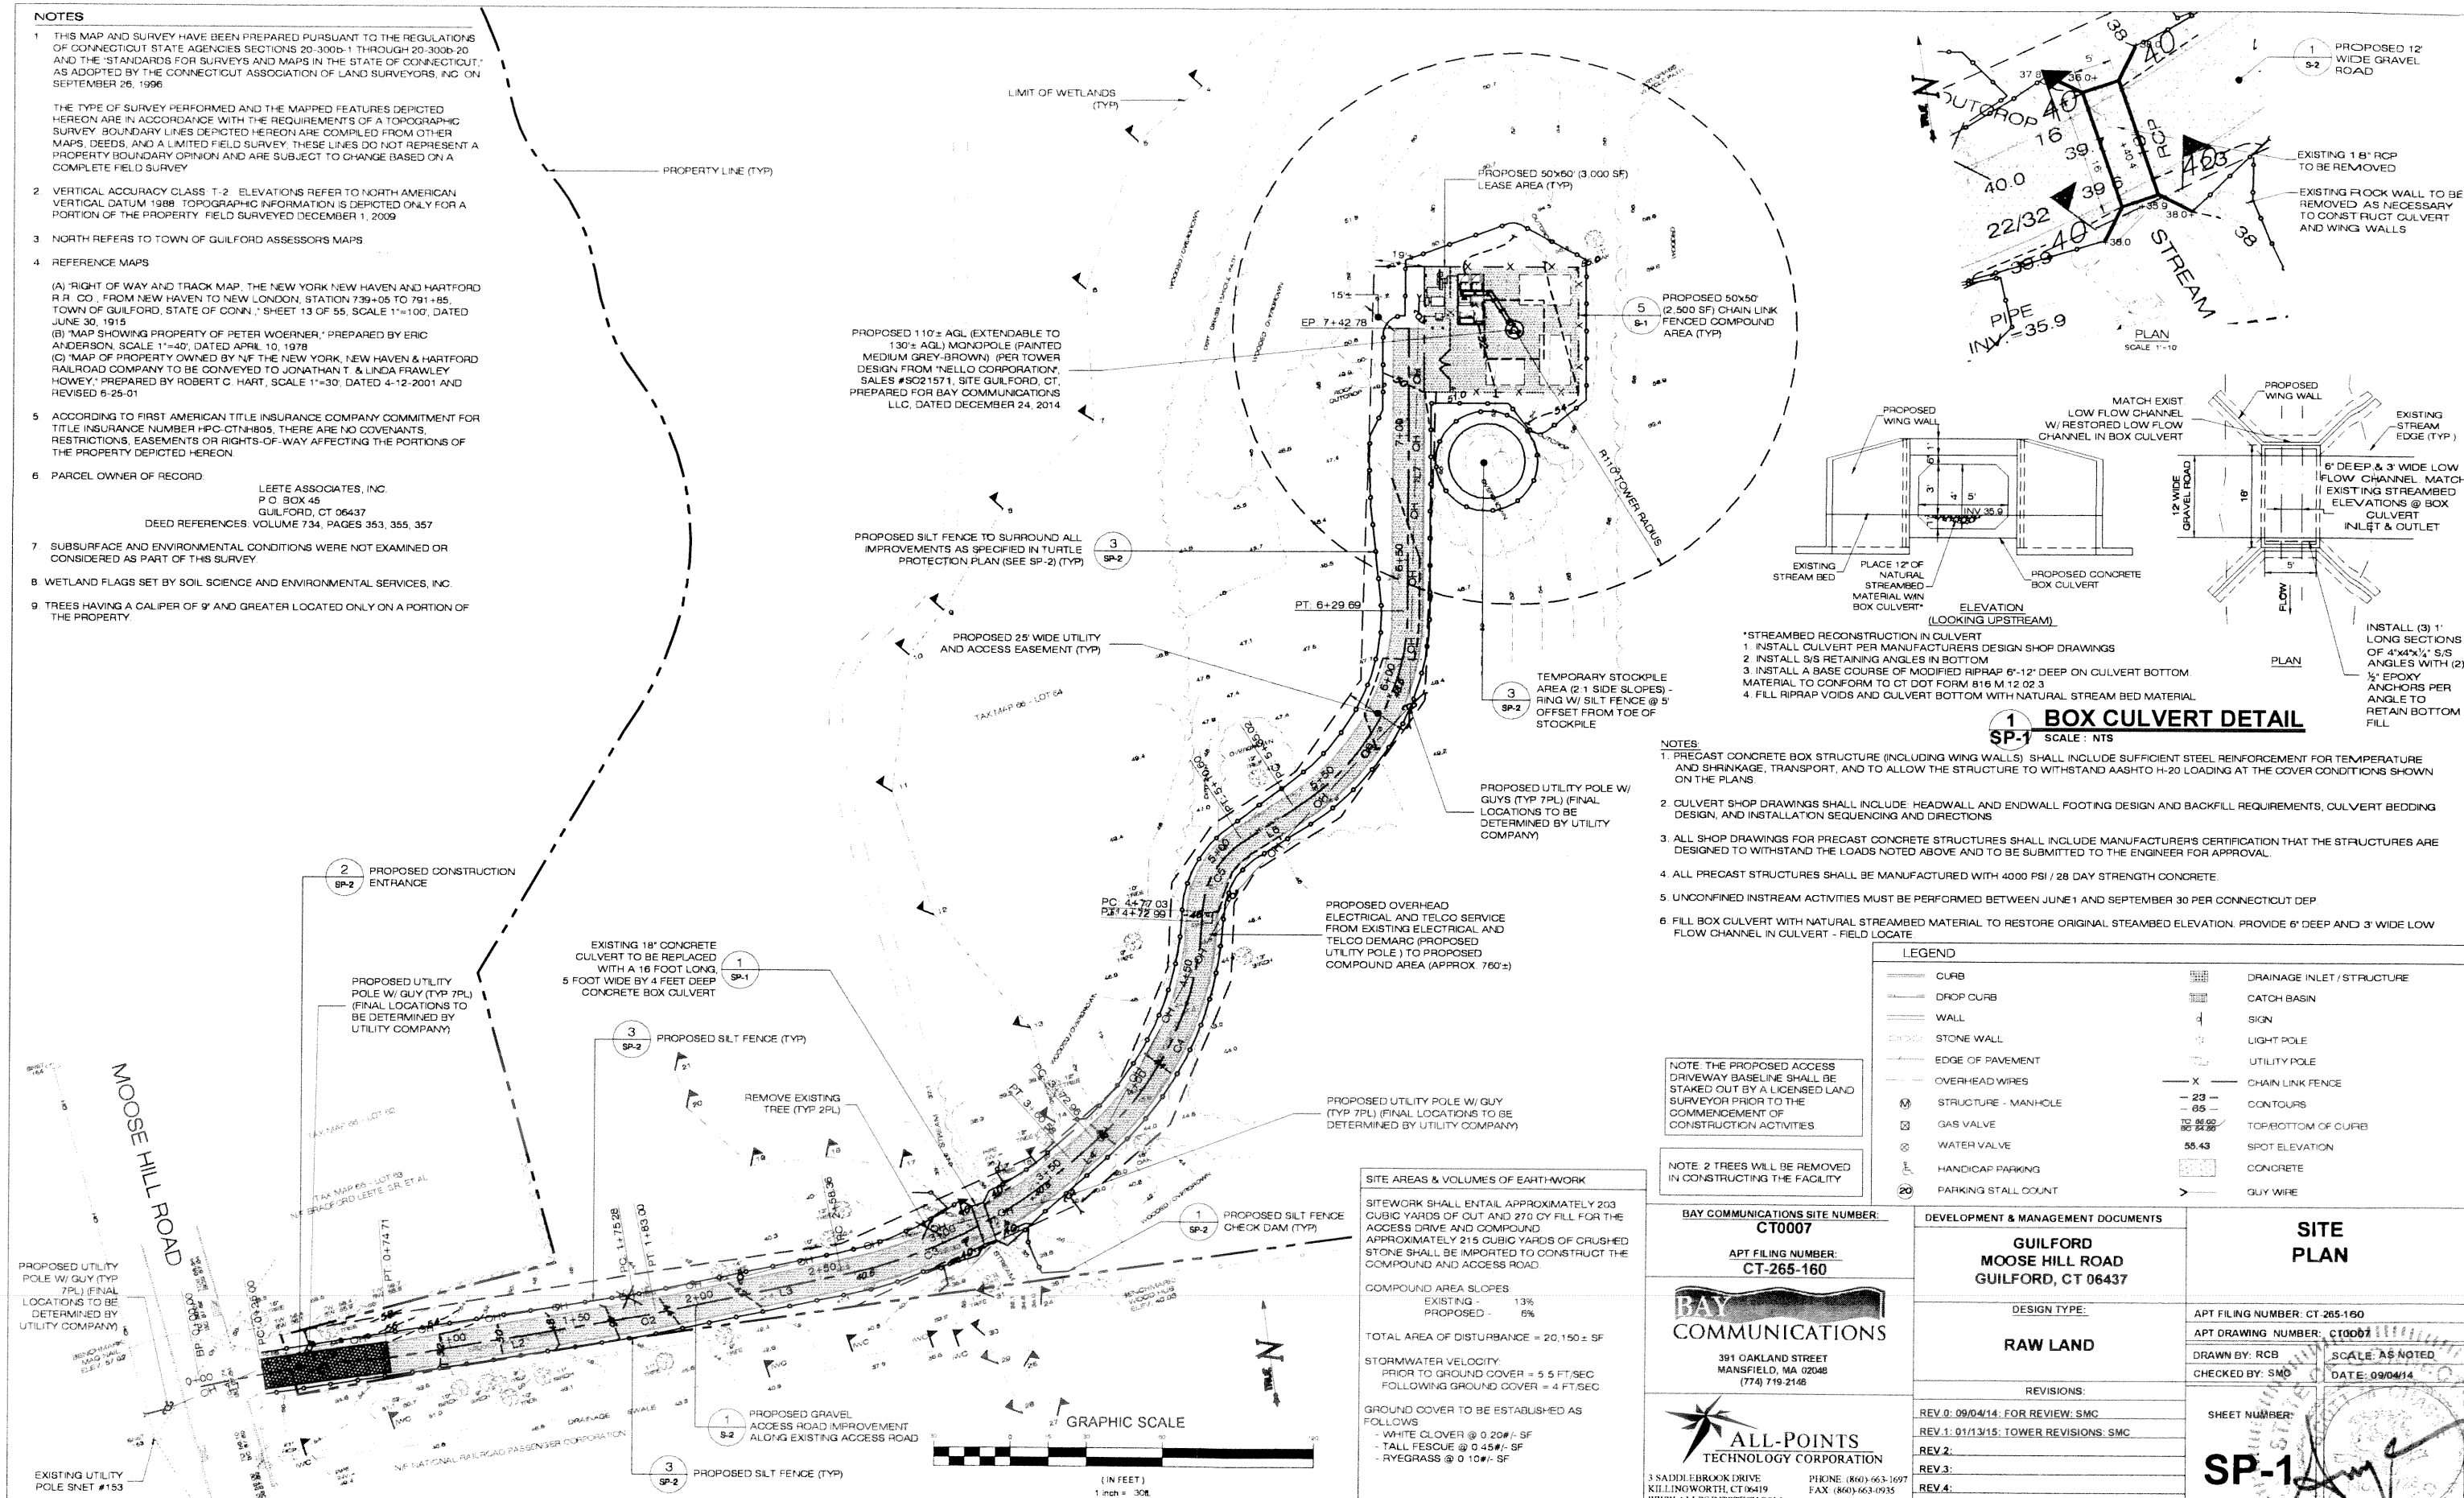

- *STREAMBED RECONSTRUCTION IN CULVERT
1. INSTALL CULVERT PER MANUFACTURER'S DESIGN SHOP DRAWINGS
 2. INSTALL S/S RETAINING ANGLES IN BOTTOM
 3. INSTALL A BASE COURSE OF MODIFIED RIPRAP 6"-12" DEEP ON CULVERT BOTTOM
 4. MATERIAL TO CONFORM TO CT DOT FORM 816 M 12.02.3
 5. FILL RIPRAP VOIDS AND CULVERT BOTTOM WITH NATURAL STREAM BED MATERIAL
- INSTALL (3) 1' LONG SECTIONS OF 4"x4"x1/4" S/S ANGLES WITH (2) 1/2" EPOXY ANCHORS PER ANGLE TO RETAIN BOTTOM FILL

- NOTES:**
1. PRECAST CONCRETE BOX STRUCTURE (INCLUDING WING WALLS) SHALL INCLUDE SUFFICIENT STEEL REINFORCEMENT FOR TEMPERATURE AND SHRINKAGE, TRANSPORT, AND TO ALLOW THE STRUCTURE TO WITHSTAND AASHTO H-20 LOADING AT THE COVER CONDITIONS SHOWN ON THE PLANS
 2. CULVERT SHOP DRAWINGS SHALL INCLUDE HEADWALL AND ENDWALL FOOTING DESIGN AND BACKFILL REQUIREMENTS, CULVERT BEDDING DESIGN, AND INSTALLATION SEQUENCING AND DIRECTIONS
 3. ALL SHOP DRAWINGS FOR PRECAST CONCRETE STRUCTURES SHALL INCLUDE MANUFACTURER'S CERTIFICATION THAT THE STRUCTURES ARE DESIGNED TO WITHSTAND THE LOADS NOTED ABOVE AND TO BE SUBMITTED TO THE ENGINEER FOR APPROVAL
 4. ALL PRECAST STRUCTURES SHALL BE MANUFACTURED WITH 4000 PSI / 28 DAY STRENGTH CONCRETE
 5. UNCONFINED INSTREAM ACTIVITIES MUST BE PERFORMED BETWEEN JUNE 1 AND SEPTEMBER 30 PER CONNECTICUT DEP
 6. FILL BOX CULVERT WITH NATURAL STREAMBED MATERIAL TO RESTORE ORIGINAL STREAMBED ELEVATION. PROVIDE 6" DEEP AND 3' WIDE LOW FLOW CHANNEL IN CULVERT - FIELD LOCATE

LEGEND	
	CURB
	DROP CURB
	WALL
	STONE WALL
	EDGE OF PAVEMENT
	OVERHEAD WIRES
	STRUCTURE - MANHOLE
	GAS VALVE
	WATER VALVE
	HANDICAP PARKING
	PARKING STALL COUNT
	DRAINAGE INLET / STRUCTURE
	CATCH BASIN
	SIGN
	LIGHT POLE
	UTILITY POLE
	CHAIN LINK FENCE
	CONTOURS
	TOP/BOTTOM OF CURB
	SPOT ELEVATION
	CONCRETE
	GUY WIRE

SITE AREAS & VOLUMES OF EARTHWORK

SITework SHALL ENTAIL APPROXIMATELY 203 CUBIC YARDS OF OUT AND 270 CY FILL FOR THE ACCESS DRIVE AND COMPOUND APPROXIMATELY 215 CUBIC YARDS OF CRUSHED STONE SHALL BE IMPORTED TO CONSTRUCT THE COMPOUND AND ACCESS ROAD

COMPOUND AREA SLOPES
EXISTING - 13%
PROPOSED - 6%

TOTAL AREA OF DISTURBANCE = 20,150 ± SF

STORMWATER VELOCITY:
PRIOR TO GROUND COVER = 5.5 FT/SEC
FOLLOWING GROUND COVER = 4 FT/SEC

GROUND COVER TO BE ESTABLISHED AS FOLLOWS
- WHITE CLOVER @ 0.20#/- SF
- TALL FESCUE @ 0.45#/- SF
- RYEGRASS @ 0.10#/- SF

BAY COMMUNICATIONS SITE NUMBER:
CT0007

APT FILING NUMBER:
CT-265-160



391 OAKLAND STREET
MANSFIELD, MA 02048
(774) 719-2148

ALL-POINTS TECHNOLOGY CORPORATION

3 SADDLEBROOK DRIVE
KILLINGWORTH, CT 06419
WWW.ALLPOINTS TECH.COM

PHONE: (860) 663-1697
FAX: (860) 663-0935

DEVELOPMENT & MANAGEMENT DOCUMENTS

GUILFORD MOOSE HILL ROAD GUILFORD, CT 06437


DESIGN TYPE:
RAW LAND

REVISIONS:
REV. 0: 09/04/14: FOR REVIEW: SMC
REV. 1: 01/13/15: TOWER REVISIONS: SMC
REV. 2:
REV. 3:
REV. 4:
REV. 5:

SITE PLAN

APT FILING NUMBER: CT 265-160
APT DRAWING NUMBER: **CT0007**
DRAWN BY: RCB
CHECKED BY: SMO
SCALE: AS NOTED
DATE: 09/04/14

SHEET NUMBER:
SP-1

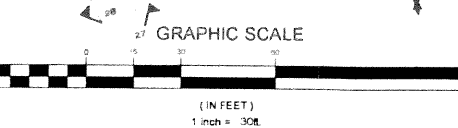

ENVIRONMENTAL NOTES

U.S. Army Corps of Engineers Category 1 Permit Authorization

The project has received authorization by the U.S. Army Corps of Engineers New England Division ("Corps") Category 1 Permit Authorization (Permit Number: NAE-2014-214, dated April 1, 2014). The Contractor is required to review the Category 1 Permit Authorization and the Connecticut General Permit ("GP"), in particular the GP Conditions. The Contractor is required to ensure that work is performed in accordance with the terms and conditions of the GP, specifically Conditions 18, 20 and 21. The Category 1 Permit Authorization Special Condition is in the following Rare Species Protection Program.

Rare Species Protection Program

Eastern Box Turtle, Wood Turtle and Saltmarsh Sharp-tailed Sparrow, all State Special Concern species, are afforded protection under the Connecticut Endangered Species Act and are known to occur on or within the vicinity of the site. The following protective measures satisfy requirements from the Connecticut Department of Energy & Environmental Protection ("CTDEEP") Wildlife Division and follow protocols developed from previous rare species consultations and state-approved protection plans. This protection plan also satisfies a Special Condition of the Corps Category 1 Permit Authorization. This protection plan is valid for one year from the date of CTDEEP's letter (March 3, 2014), at which point if construction has not been initiated, a new Natural Diversity Data Base review request from CTDEEP is required.

It is of the utmost importance that the Contractor comply with the requirement for the installation of protective measures and the education of its employees and subcontractors performing work on the project site if work will occur during the Eastern Box Turtles and Wood Turtles active period (April 1 to November 15) or the Saltmarsh Sharp-tailed Sparrow active nesting period (May 15 to August 15). All-Points Technology Corporation, P.C. ("APT") will serve as the Environmental Monitor for this project to ensure that Eastern Box Turtle, Wood Turtle and Saltmarsh Sharp-tailed Sparrow protection measures are implemented properly and will provide an education session on Eastern Box Turtle, Wood Turtle and Saltmarsh Sharp-tailed Sparrow prior to the start of construction activities. The Contractor shall contact Dean Gustafson, Senior Environmental Scientist at APT, at least 5 business days prior to the pre-construction meeting. Mr. Gustafson can be reached by phone at (860) 663-1697 ext. 201 or via email at dgustafson@allpointstech.com.

Eastern Box Turtle and Wood Turtle Protection Plan

The proposed Eastern Box Turtle and Wood Turtle species protection program consists of several components: isolation of the project perimeter, periodic inspection and maintenance of isolation structures, education of all contractors and sub-contractors prior to initiation of work on the site, protective measures, and reporting.

I. Isolation Measures & Erosion and Sedimentation Controls

- a. Plastic netting used in a variety of erosion control products (i.e., erosion control blankets, fiber rolls (wattles), reinforced silt fence) has been found to entangle wildlife, including reptiles, amphibians, birds and small mammals. No permanent erosion control products or reinforced silt fence will be used on the project. Temporary erosion control products will use either erosion control blankets and fiber rolls composed of processed fibers mechanically bound together to form a continuous matrix (net less) or netting composed of planar woven natural biodegradable fiber to avoid/minimize wildlife entanglement.

- b. Installation of erosion and sedimentation controls (i.e., silt fencing), required for erosion control compliance and creation of a barrier to possible migrating/dispersing turtles, shall be performed by the Contractor following clearing activities and prior to any earthwork. The Environmental Monitor will inspect the work zone area prior to and following erosion control barrier installation to ensure the area is free of eastern box turtles and wood turtles and satisfactorily installed. The intent of the barrier is to segregate the majority of the work zone from foraging/migrating/dispersing turtles. Oftentimes complete isolation of a work zone is not feasible due to accessibility needs and locations of staging/material storage areas, etc. In those circumstances, the barriers will be positioned to deflect migrating/dispersal routes away from the work zone to minimize potential encounters with turtles.
- c. The fencing will consist of non-reinforced conventional erosion control woven fabric, installed approximately six inches below surface grade and staked at seven to ten-foot intervals using four-foot oak stakes or approved equivalent. In addition to required daily inspection by the Contractor, the fencing will be inspected for tears or breaches in the fabric following installation periodically by APT throughout the course of the construction project.
- d. The extent of the barrier fencing will be as shown on the site plans. The Contractor shall have additional barrier fencing should field conditions warrant extending the fencing as directed by APT.
- e. No equipment, vehicles or construction materials shall be stored outside of barrier fencing.
- f. All silt fencing shall be removed within 30 days of completion of work and permanent stabilization of site soils so that reptile and amphibian movement between uplands and wetlands is not restricted. If fiber rolls/wattles, straw bales, or other natural material erosion control products are used, such devices will not be left in place to biodegrade and shall be promptly removed after soils are stable so as not to create a barrier to migrating wildlife. Seed from seeding of soils should not spread over fiber rolls/wattles as it makes them harder to remove once soils are stabilized by vegetation.

II. Contractor Education

- a. Prior to work on site, the Contractor shall attend an educational session at the pre-construction meeting with APT. This orientation and educational session will consist of an introductory meeting with APT providing photos of eastern box turtles and wood turtles and emphasizing the non-aggressive nature of these turtles, the absence of need to destroy animals that might be encountered and the need to follow Protective Measures as described in Section 4 below. Workers will also be provided information regarding the identification of other turtle species that could be encountered.
- b. The education session will also focus on means to discriminate between the species of concern and other native species to avoid unnecessary "false alarms". Encounters with any species of turtles will be documented.

- c. The Contractor will be provided with cell phone and email contacts for APT personnel to immediately report any encounters with eastern box turtle, wood turtle or other turtle species. Educational poster materials will be provided by APT and displayed on the job site to maintain worker awareness as the project progresses.
- d. APT will also post Caution Signs throughout the project site for the duration of the construction project providing notice of the environmentally sensitive nature of the work area, the potential for encountering various amphibians and reptiles and precautions to be taken to avoid injury to or mortality of these animals.

III. Petroleum Materials Storage and Spill Prevention

- a. Certain precautions are necessary to store petroleum materials, refuel and contain and properly clean up any inadvertent fuel or petroleum (i.e., oil, hydraulic fluid, etc.) spill due to the projects location in proximity to sensitive wetlands.
- b. A spill containment kit consisting of a sufficient supply of absorbent pads and absorbent material will be maintained by the Contractor at the construction site throughout the duration of the project. In addition, a waste drum will be kept on site to contain any used absorbent pads/material for proper and timely disposal off site in accordance with applicable local, state and federal laws.
- c. The following petroleum and hazardous materials storage and refueling restrictions and spill response procedures will be adhered to by the Contractor.

I. Petroleum and Hazardous Materials Storage and Refueling

- 1. Refueling of vehicles or machinery shall occur a minimum of 100 feet from wetlands or watercourses and shall take place on an impervious pad with secondary containment designed to contain fuels.
- 2. Any fuel or hazardous materials that must be kept on site shall be stored on an impervious surface utilizing secondary containment a minimum of 100 feet from wetlands or watercourses.

II. Initial Spill Response Procedures

- 1. Stop operations and shut off equipment.
- 2. Remove any sources of spark or flame.
- 3. Contain the source of the spill.
- 4. Determine the approximate volume of the spill.
- 5. Identify the location of natural flow paths to prevent the release of the spill to sensitive nearby waterways or wetlands.
- 6. Ensure that fellow workers are notified of the spill.

III. Spill Clean Up & Containment

- 1. Obtain spill response materials from the on-site spill response kit. Place absorbent materials directly on the release area.
- 2. Limit the spread of the spill by placing absorbent materials around the perimeter of the spill.
- 3. Isolate and eliminate the spill source.
- 4. Contact the appropriate local, state and/or federal agencies, as necessary.
- 5. Contact a disposal company to properly dispose of contaminated materials.

IV. Reporting

- 1. Complete an incident report.
- 2. Submit a completed incident report to the Connecticut Siting Council.

IV. Turtle Protective Measures

- a. Prior to the start of construction each day, the Contractor shall search the entire work area for turtles.
- b. If a turtle is found, it shall be immediately moved, unharmed, by carefully grasped in both hands, one on each side of the shell, between the turtles forelimbs and the hind limbs, and placed just outside of the isolation barrier in the approximate direction it was walking.
- c. Special care shall be taken by the Contractor during early morning and evening hours so that possible basking or foraging turtles are not harmed by construction activities.

V. Herbicide and Pesticide Restrictions

- a. The use of herbicides and pesticides at the proposed wireless telecommunications facility and along the proposed access drive are strictly prohibited.

VI. Reporting

- a. APT will submit monthly inspection reports (brief narrative and applicable photos) to the Connecticut Siting Council for compliance verification. Any observations of turtles will be included in the reports.
- b. Following completion of the construction project, APT will provide a summary report to the Corps and CTDEEP documenting the monitoring and maintenance of the barrier fence and erosion control measures.
- c. Any observations of eastern box turtle or wood turtle will be reported to CTDEEP by APT, with photo-documentation (if possible) and with specific information on the location and disposition of the animal.

Saltmarsh Sharp-tailed Sparrow Protection Plan

The proposed Saltmarsh Sharp-tailed Sparrow protection program will require a nest inspection if work is proposed to be conducted during the sparrows nesting season (May 15 to August 15).


- 1. APT will perform an avian survey to determine if Saltmarsh Sharp-tailed Sparrow Plastic nesting occurs within 600 feet of proposed development activities.
- 2. If a nest is found within 600 feet of proposed development activities, work will need to be suspended during the nesting season to minimize potential impacts to this species.

Restoration of Disturbed Wetland Areas


- 1. Upon completion of construction, all disturbed wetland areas shall be stabilized with a wetland seed mix containing only plant species native to New England and shall not contain any species listed in the "Invasive and Other Unacceptable Plant Species" Appendix in the "New England District Compensatory Mitigation Guidance".
- 2. The introduction or spread of invasive plant species in disturbed areas shall be controlled. If swamp or timber mats are to be used, they shall be thoroughly cleaned before re-use.
- 3. In areas of authorized temporary disturbance, if trees are cut they shall be cut at or above ground level and not uprooted in order to prevent disruption to the wetland soil structure and to allow stump sprouts to revegetate the work area, unless otherwise authorized.
- 4. Wetland areas where permanent disturbance shall be higher than the preconstruction elevation. Original condition means careful protection and/or removal of existing soil and vegetation, and replacement back to the original location such that the original soil layering and vegetation schemes are approximately the same, unless otherwise authorized.

Culvert Replacement


- 1. Unconfined in-stream construction work shall be conducted during the low flow period June 1 through September 30 in any year except in instances where a specific written exception has been issued by the Connecticut Department of Energy & Environmental Protection.
- 2. All temporary fill must be removed as soon as it is no longer needed and all disturbed areas must be returned to their pre-construction conditions.

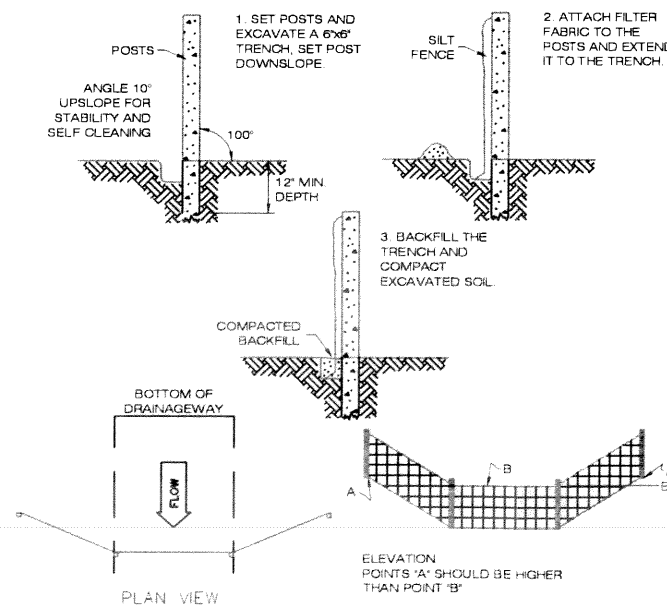

1 SP-2
SILT FENCE CHECK DAM
SEDIMENTATION CONTROL BARRIER
 SCALE: NTS




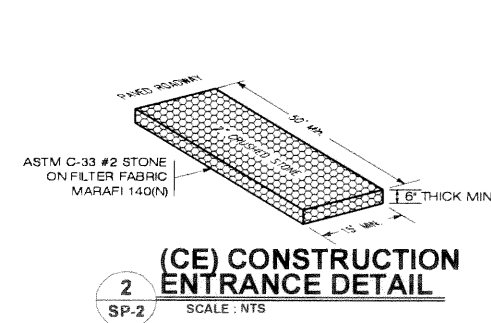


(CE) CONSTRUCTION
ENTRANCE DETAIL
 SCALE: NTS

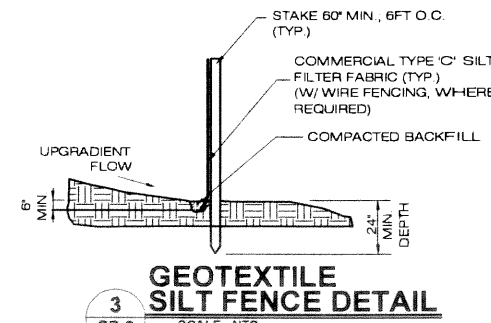

GEOTEXTILE
SILT FENCE DETAIL
 SCALE: NTS

BAY COMMUNICATIONS SITE NUMBER: CT0007 APT FILING NUMBER: CT-265-160 391 OAKLAND STREET MANSFIELD, MA 02048 (774) 719-2148	DEVELOPMENT & MANAGEMENT DOCUMENTS GUILFORD MOOSE HILL ROAD GUILFORD, CT 06437	ENVIRONMENTAL NOTES & DETAILS APT FILING NUMBER: CT-265-160 APT DRAWING NUMBER: CT0007 DRAWN BY: RCB CHECKED BY: SMC SCALE: AS NOTED DATE: 09/04/14
	DESIGN TYPE: RAW LAND	
 3 SADDLEBROOK DRIVE KILLINGWORTH CT 06419 WWW.ALLPOINTSTECH.COM PHONE: (860)-663-1697 FAX: (860)-663-0935	REVISIONS: REV. 0: 09/04/14: FOR REVIEW: SMC REV. 1: 01/13/15: TOWER REVISIONS: SMC REV. 2: REV. 3: REV. 4: REV. 5:	

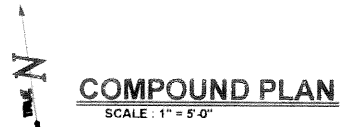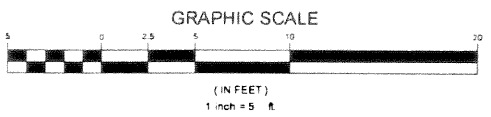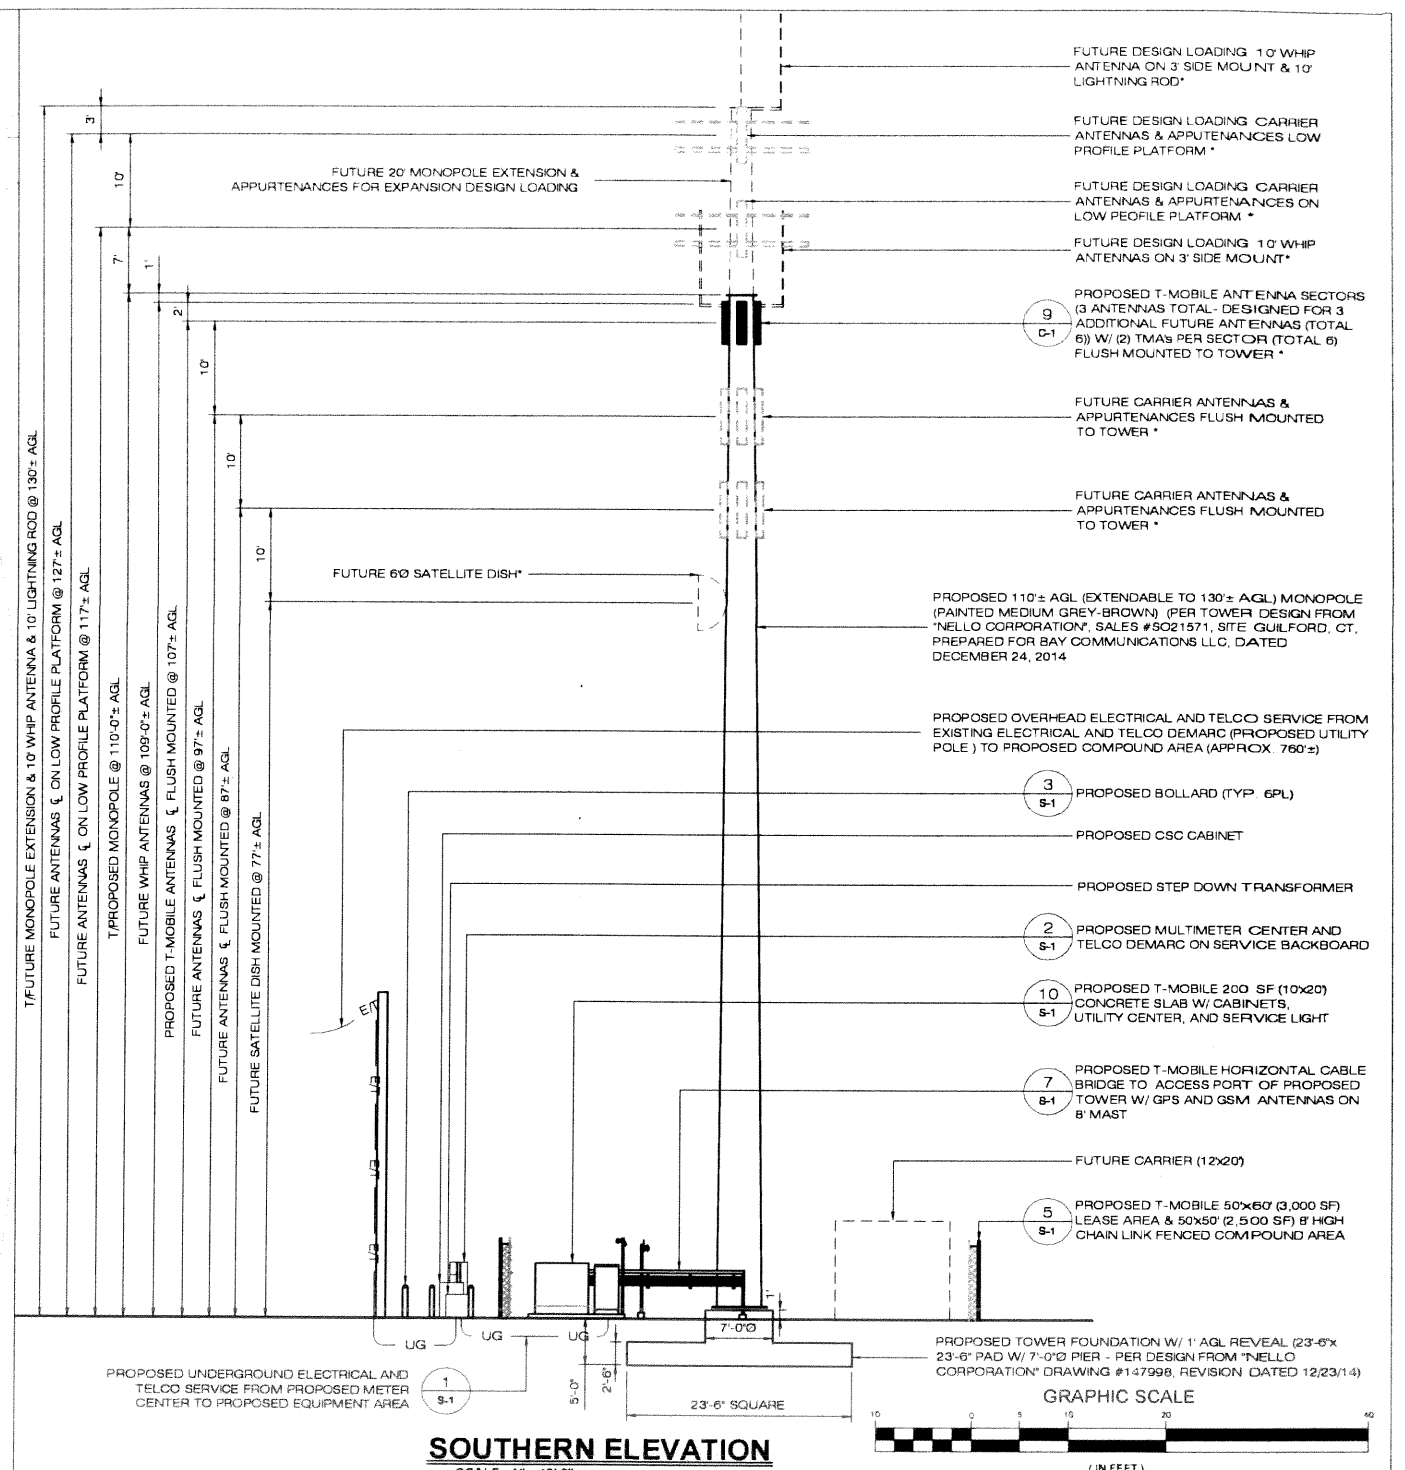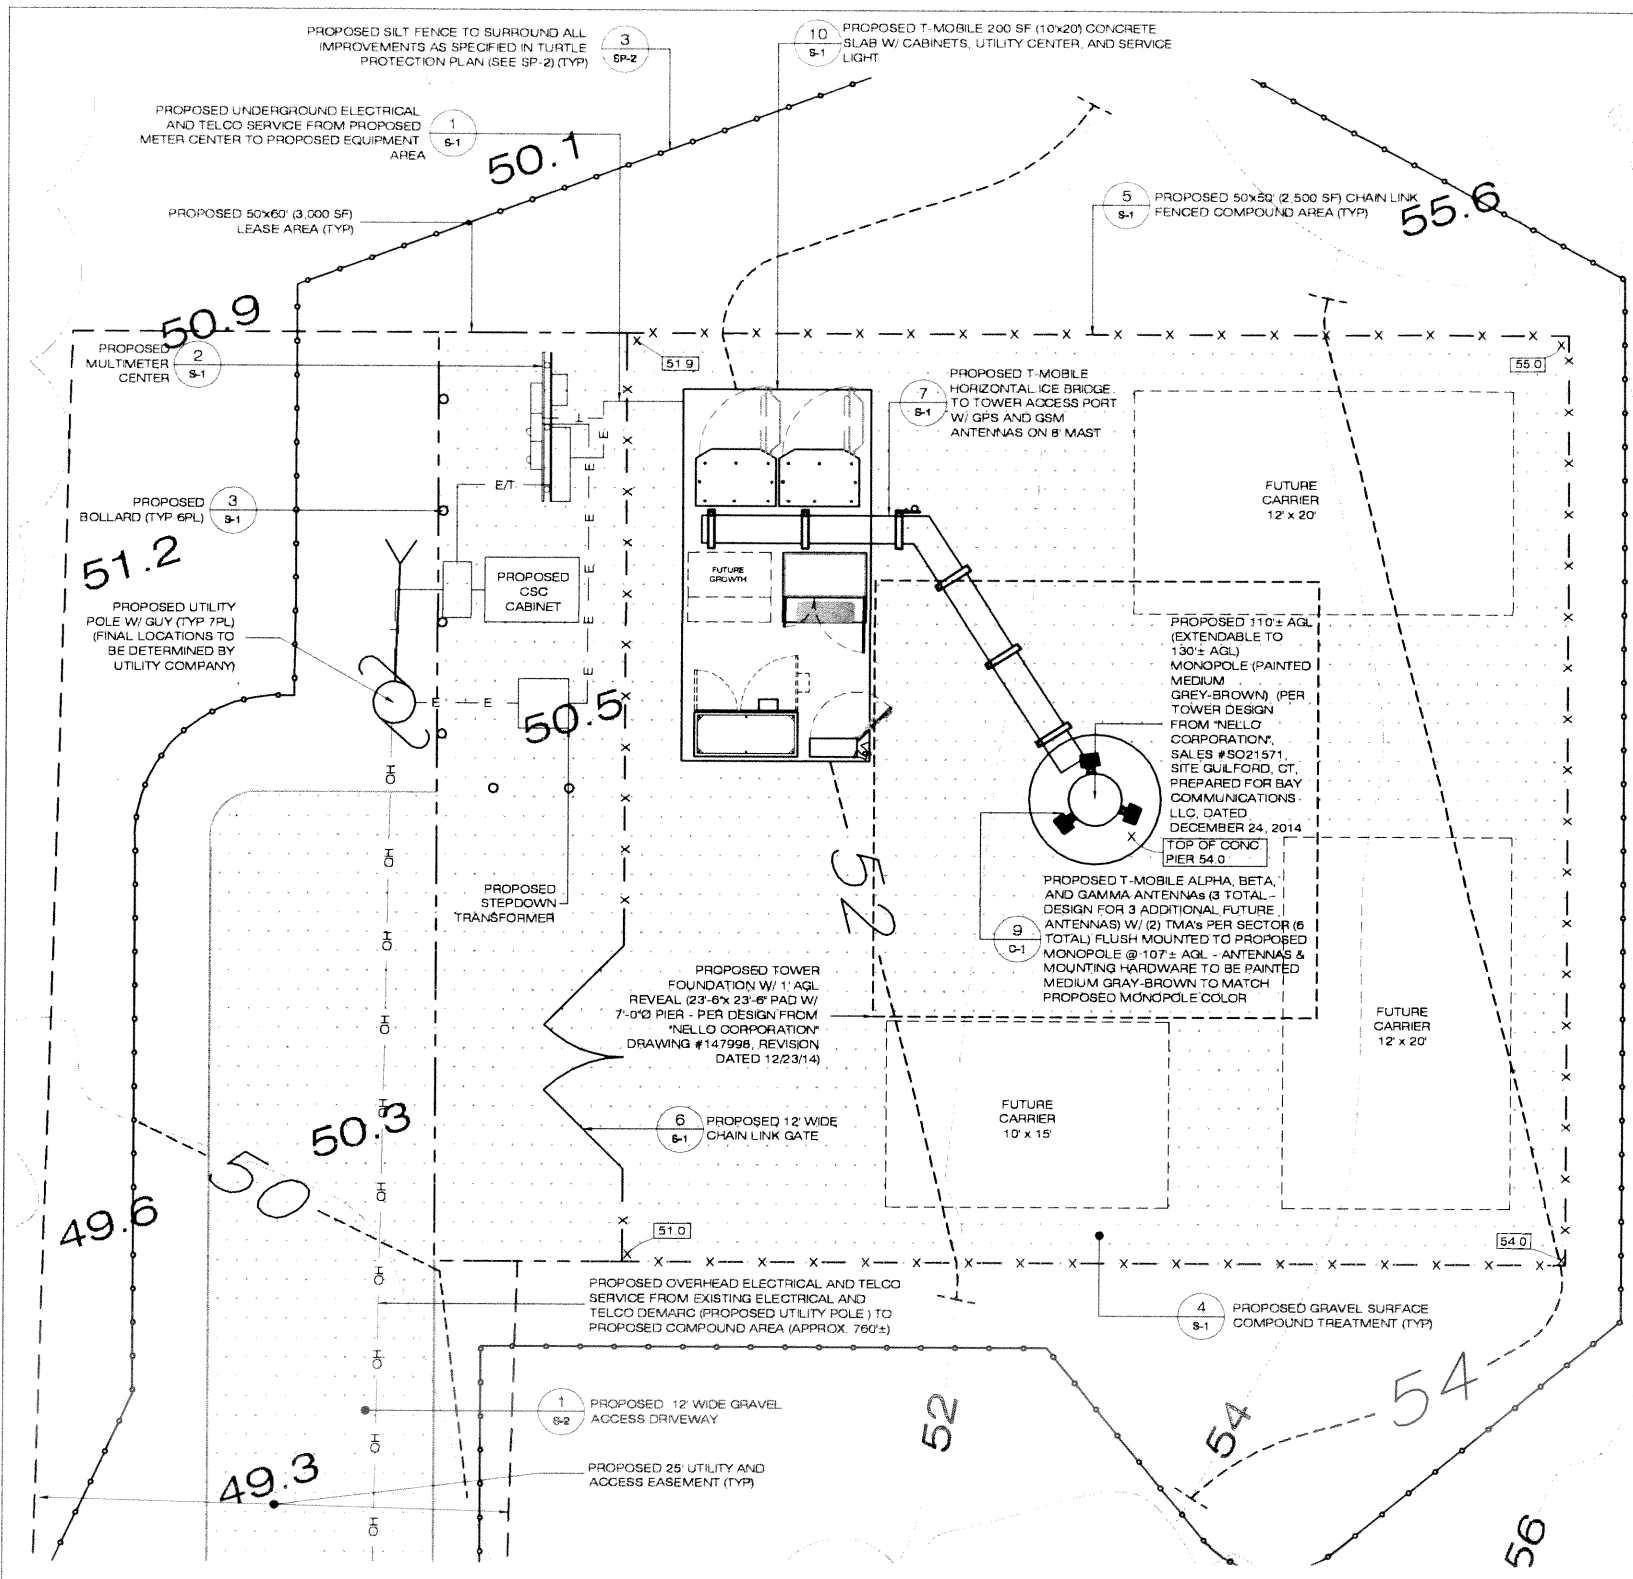


* NOTE: ALL ANTENNAS & MOUNTING HARDWARE TO BE PAINTED MEDIUM GRAY-BROWN TO MATCH PROPOSED MONOPOLE COLOR

ENGINEERING ANALYSIS AND CERTIFICATION

IN ACCORDANCE WITH THE 2005 CONNECTICUT STATE BUILDING CODE AND THE ELECTRONIC INDUSTRIES ASSOCIATION STANDARD EIA/TIA-222-F 'STRUCTURAL STANDARDS FOR STEEL ANTENNA TOWERS AND ANTENNA SUPPORT STRUCTURES' FOR NEW HAVEN COUNTY, THE TOWER WOULD BE DESIGNED TO WITHSTAND PRESSURES EQUIVALENT TO A MAXIMUM 85 MPH WIND. THE FOUNDATION DESIGN WOULD BE BASED ON SOIL CONDITIONS AT THE SITE.

BAY COMMUNICATIONS SITE NUMBER: C T0007	DEVELOPMENT & MANAGEMENT DOCUMENTS	COMPOUND PLAN & TOWER ELEVATION
APT FILING NUMBER: CT-265-160	GUILFORD MOOSE HILL ROAD GUILFORD, CT 06437	
	DESIGN TYPE: RAW LAND	APT FILING NUMBER: CT-265-160
391 OAKLAND STREET MANSFIELD, MA 02048 (774) 719-2146	REVISIONS:	APT DRAWING NUMBER: C T0007
	REV. 0: 09/04/14: FOR REVIEW: SMC	DRAWN BY: RCB SCALE: AS NOTED
3 SADDLEBROOK DRIVE KILLINGWORTH, CT 06419 WWW.ALLPOINTSTECH.COM	REV. 1: 01/13/15: TOWER REVISIONS: SMC	CHECKED BY: SMC DATE: 09/04/14
PHONE: (860) 663-1697 FAX: (860) 663-0935	REV. 2:	SHEET NUMBER: A-1
	REV. 3:	
	REV. 4:	
	REV. 5:	

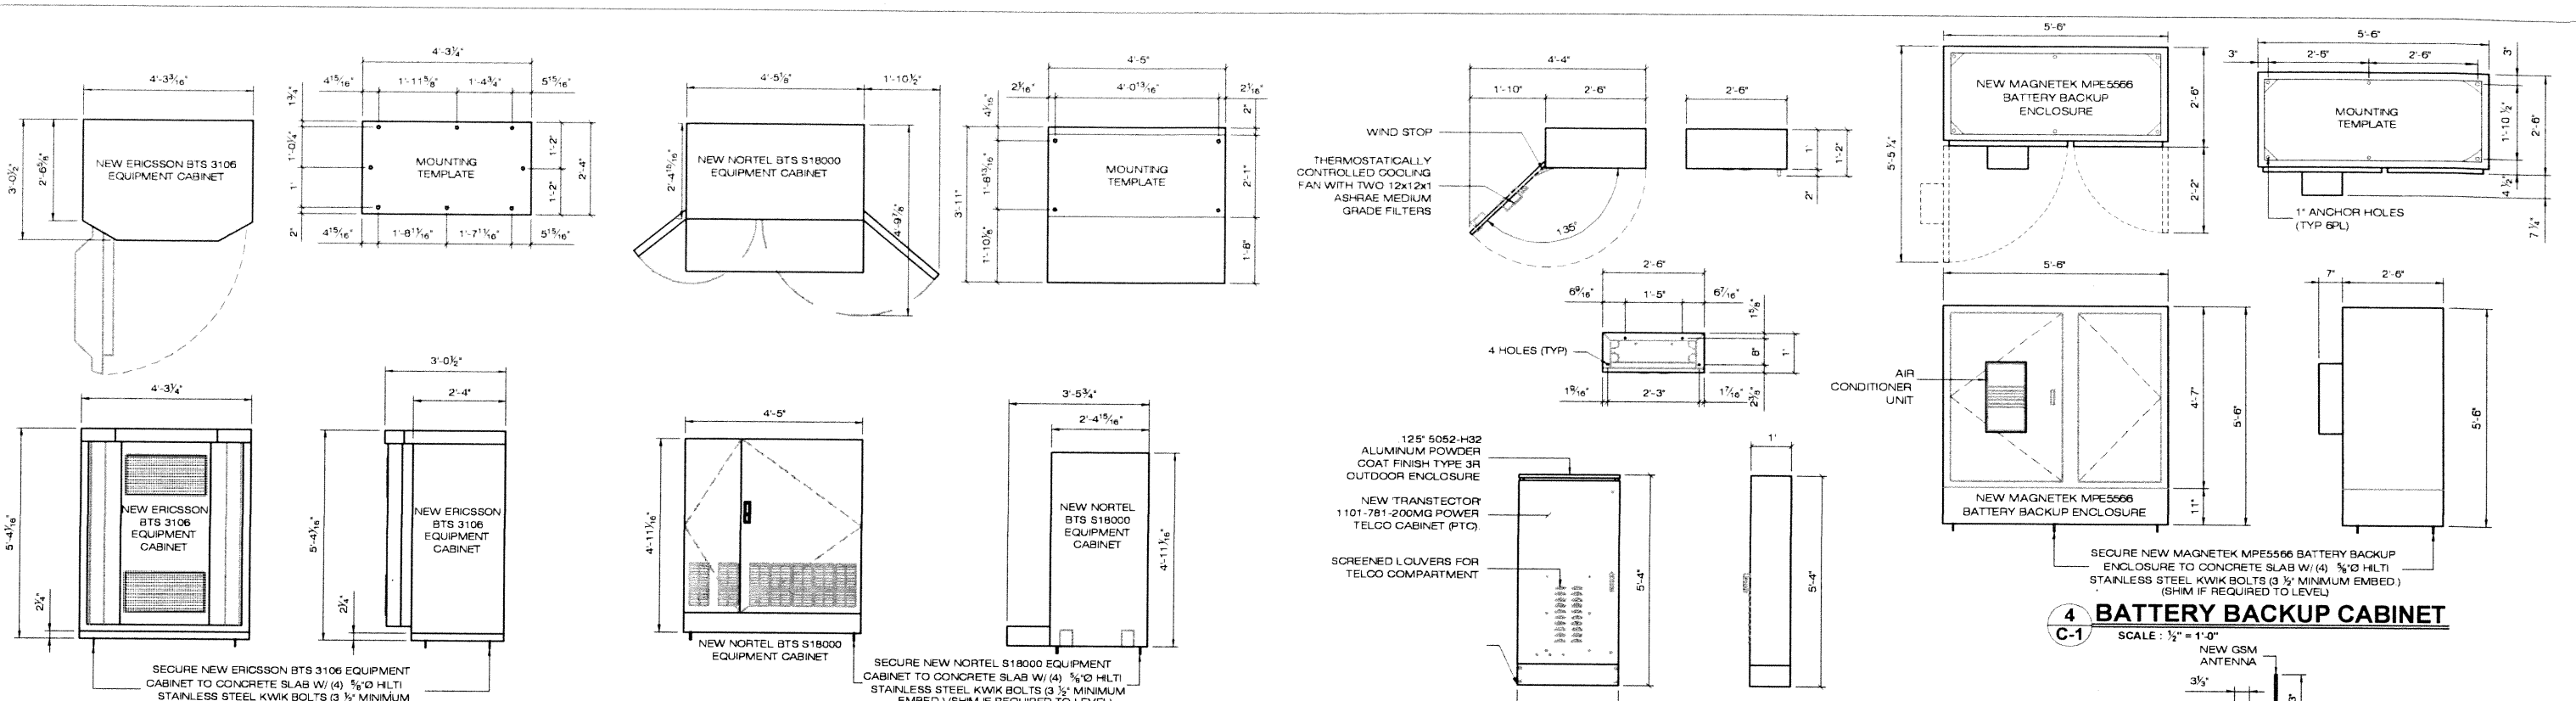


1 ERICSSON RBS 3106 EQUIPMENT CABINET
SCALE: 1/2" = 1'-0"


2 NORTEL BTS S18000 EQUIPMENT CABINET
SCALE: 1/2" = 1'-0"

3 TRANSTECTOR PTC CABINET
SCALE: 1/2" = 1'-0"


4 BATTERY BACKUP CABINET
SCALE: 1/2" = 1'-0"

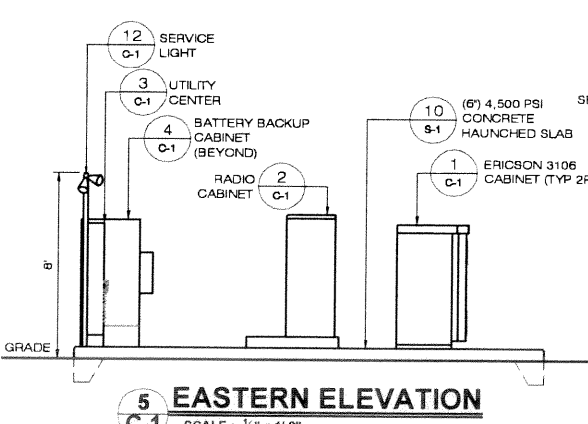


5 EASTERN ELEVATION
SCALE: 1/4" = 1'-0"

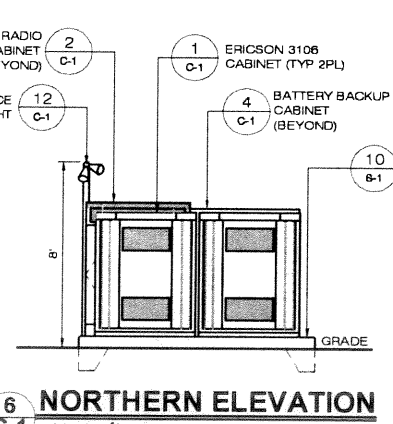


6 NORTHERN ELEVATION
SCALE: 1/4" = 1'-0"

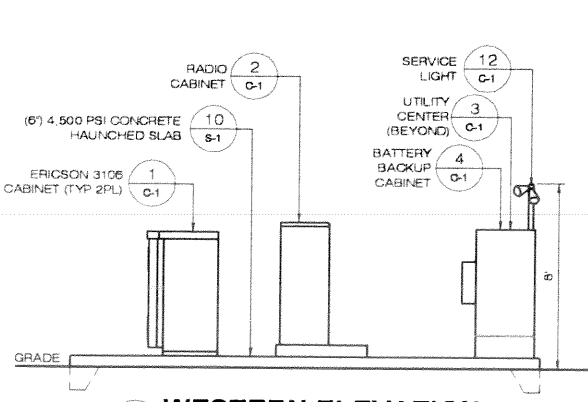

7 WESTERN ELEVATION
SCALE: 1/4" = 1'-0"

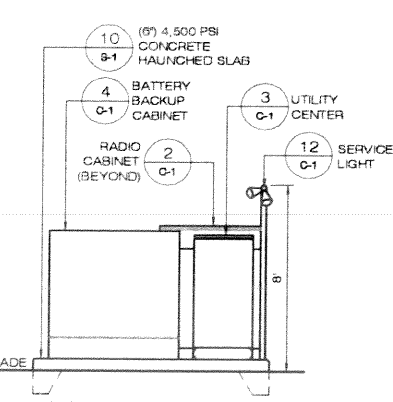


8 SOUTHERN ELEVATION
SCALE: 1/4" = 1'-0"

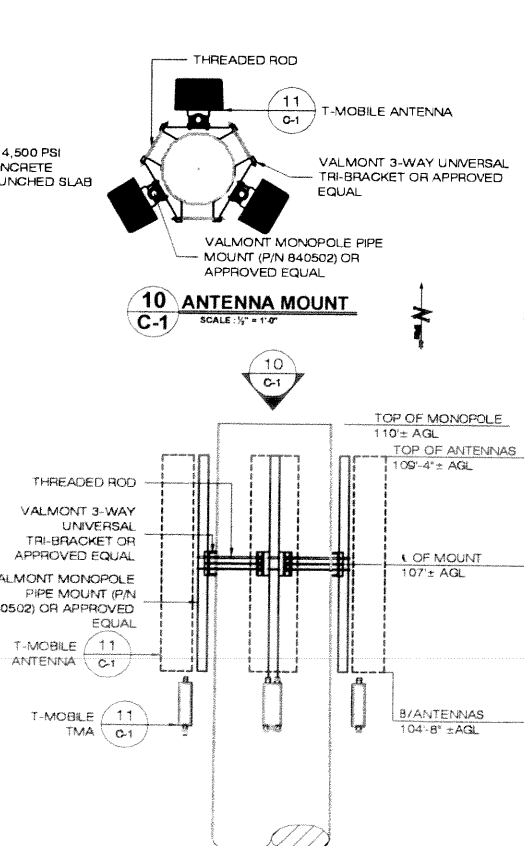


10 ANTENNA MOUNT
SCALE: 1/2" = 1'-0"

9 ANTENNA MOUNT
SCALE: 1/2" = 1'-0"

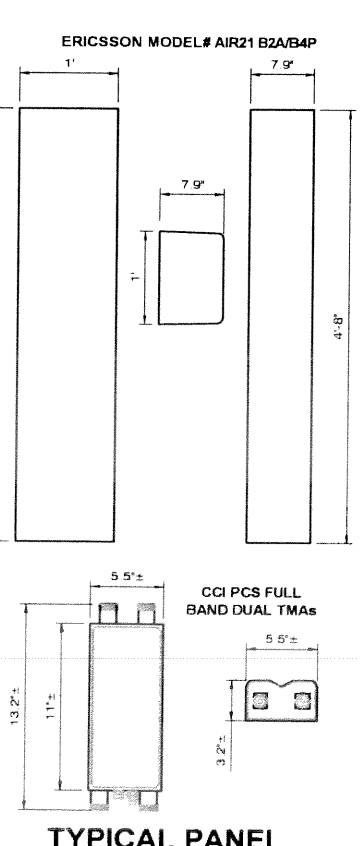

11 TYPICAL PANEL ANTENNA & TMA
SCALE: NTS

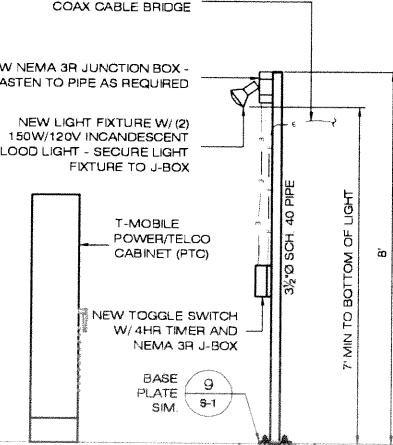

12 SERVICE LIGHT
SCALE: 1/2" = 1'-0"

13 TYPICAL GSM & GPS ANTENNA DETAILS
SCALE: NTS

DESIGN LOAD CRITERIA

EQUIPMENT SHELTER SHALL BE DESIGNED AND MANUFACTURED TO MEET ALL STATE AND LOCAL CODES. ITS LAYOUT SHALL BE COORDINATED WITH CARRIERS.

DESIGN BASIS	CONNECTICUT STATE BUILDING CODE
GOVERNING CODE	40 PSF (ASCE 7-02)
DESIGN LIVE LOADS	II
IMPORTANCE CATEGORY	
SNOW LOAD	30 PSF
GROUND SNOW LOAD (Pg)	1.0
IMPORTANCE FACTOR	0.9
EXPOSURE FACTOR (Ce)	1.0
THERMAL FACTOR (Ct)	1.0
WIND LOAD	110 MPH (3 SECOND GUST) / 65 MPH (FASTEST MILE)
BASIC WIND LOAD	C
EXPOSURE GROUP	1.00
IMPORTANCE FACTOR	
EQUIPMENT LOAD	9,000 LBS
EQUIPMENT DL	
SEISMIC DESIGN PARAMETERS	
SEISMIC USE GROUP	I
MCE SPECTRAL ACCELERATION SHORT (Sa)	0.229
MCE SPECTRAL ACCELERATION SHORT (Sv)	0.050
SITE CLASS	D FOR UNKNOWN SOIL PROPERTIES
IMPORTANCE FACTOR	1.0

BAY COMMUNICATIONS SITE NUMBER: **CT0007**

APT FILING NUMBER: **CT-265-160**

BAY COMMUNICATIONS

391 OAKLAND STREET
MANSFIELD, MA 02048
(774) 719-2148

ALL-POINTS TECHNOLOGY CORPORATION

3 SADDLEBROOK DRIVE
KILLINGWORTH, CT 06419
WWW.ALLPOINTSSTECH.COM

PHONE: (860) 663-1697
FAX: (860) 663-0935

DEVELOPMENT & MANAGEMENT DOCUMENTS

GUILFORD MOOSE HILL ROAD GUILFORD, CT 06437

DESIGN TYPE: **RAW LAND**

REVISIONS:

REV. 0:	09/04/14: FOR REVIEW: SMC
REV. 1:	01/13/15: TOWER REVISIONS: SMC
REV. 2:	
REV. 3:	
REV. 4:	
REV. 5:	

T-MOBILE EQUIPMENT PLAN & DETAILS


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APT DRAWING NUMBER: **CT0007**


DRAWN BY: **RCB** SCALE: **AS NOTED**

CHECKED BY: **SMC** DATE: **09/04/14**


SHEET NUMBER: **C-1**

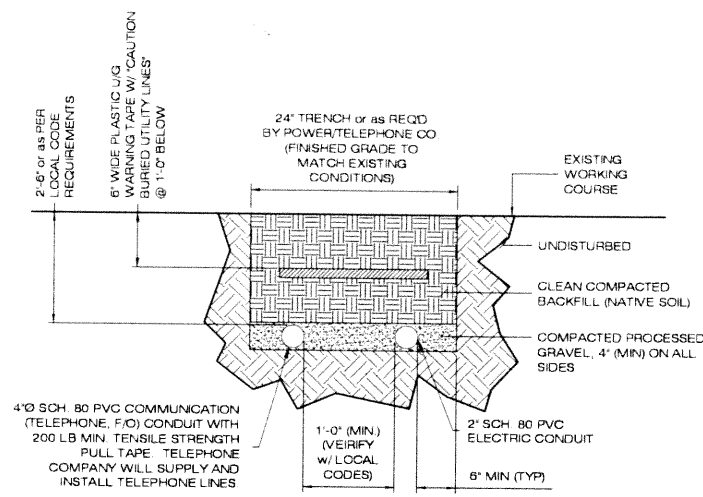


1 SECONDARY TRENCH DETAIL
S-1 SCALE: N.T.S.

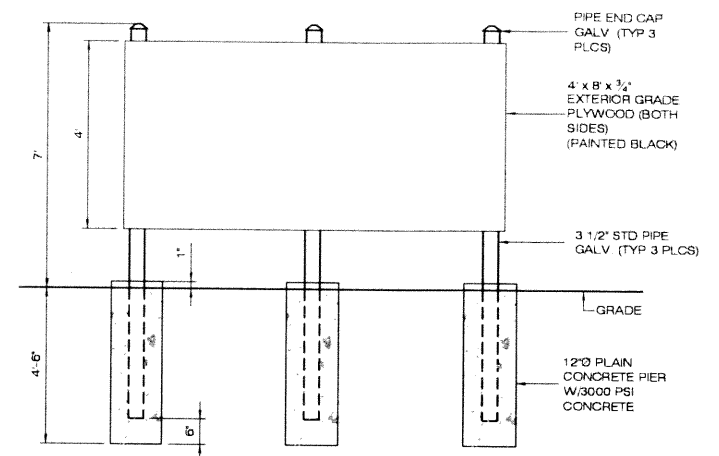


2 UTILITY BACKBOARD DETAIL
S-1 SCALE: N.T.S.

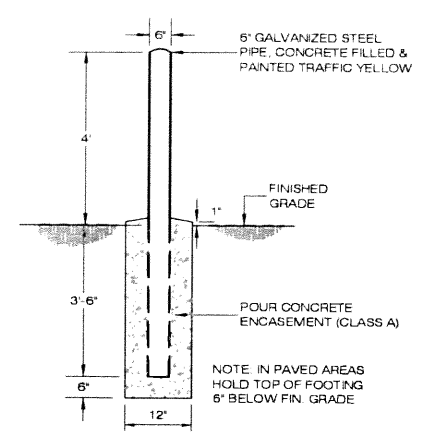


3 BOLLARD DETAIL
S-1 SCALE: N.T.S.

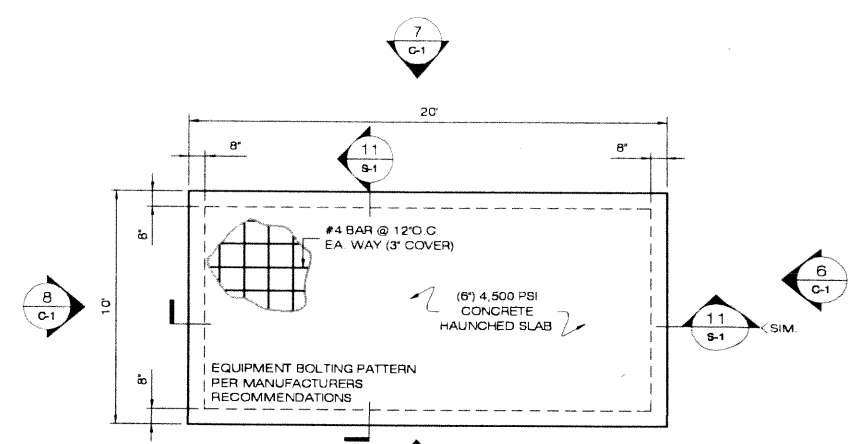


10 HAUNCHED SLAB PLAN
S-1 SCALE: 1/4" = 1'-0"

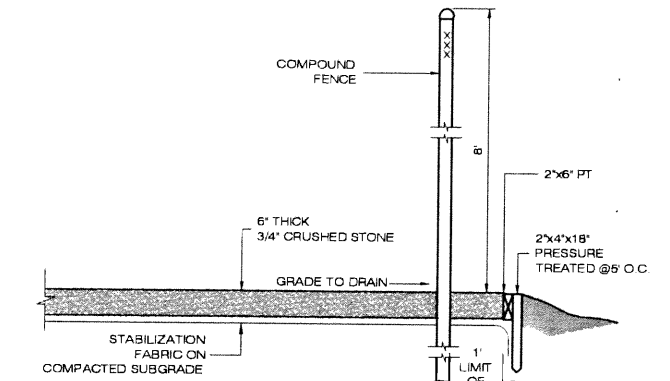


4 COMPOUND DETAIL
S-1 SCALE: N.T.S.

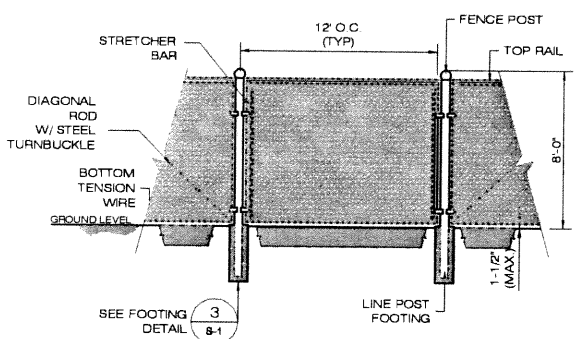

5 CHAIN-LINK FENCING DETAIL
S-1 SCALE: N.T.S.

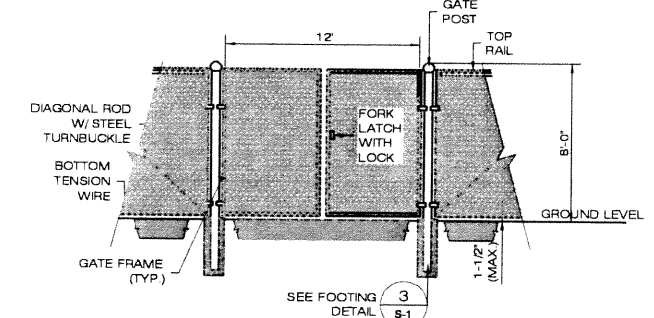


6 FENCE & GATE DETAIL
S-1 SCALE: N.T.S.

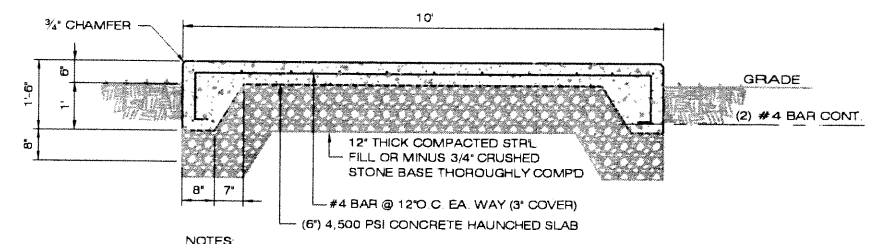


- NOTES
1 CONCRETE SHALL BE Fc = 4,500 PSI (MIN) @ 28 DAYS WITH MAXIMUM WATER/CEMENT (W/C) RATIO = 0.45 AND AIR ENTRAINED IN ACCORDANCE WITH ISO SECTION 1904 "DURABILITY REQUIREMENTS".
2 DEFORMED REINFORCING BARS SHALL BE FABRICATED WITHOUT SPLICES. SUPPORT BAR MAT ON CONCRETE BRICK.
3 ALL INTERSECTING BARS SHALL BE TIED. TURN ENDS OF TIE WIRE AWAY FROM EXPOSED SURFACES.


11 HAUNCHED SLAB DETAIL
S-1 SCALE: 1/2" = 1'-0"

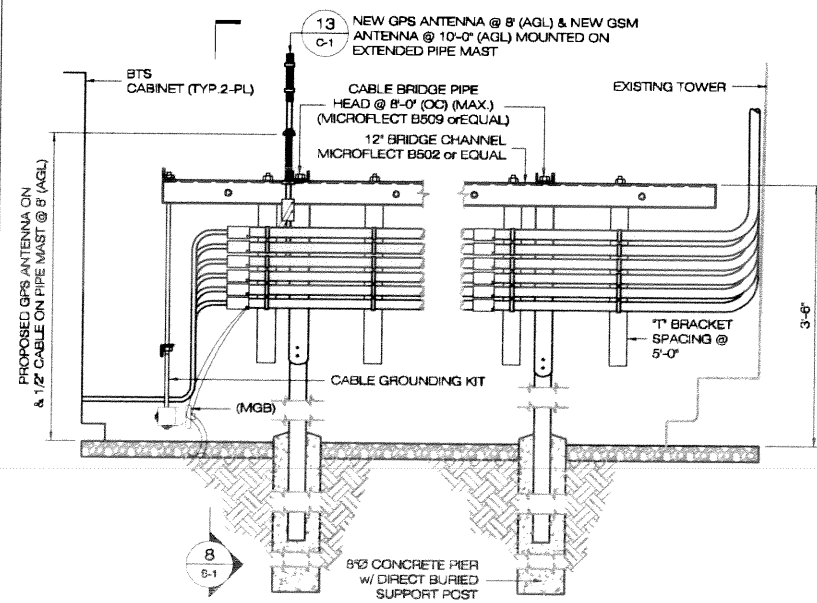


7 CABLE BRIDGE DETAIL
S-1 SCALE: N.T.S.

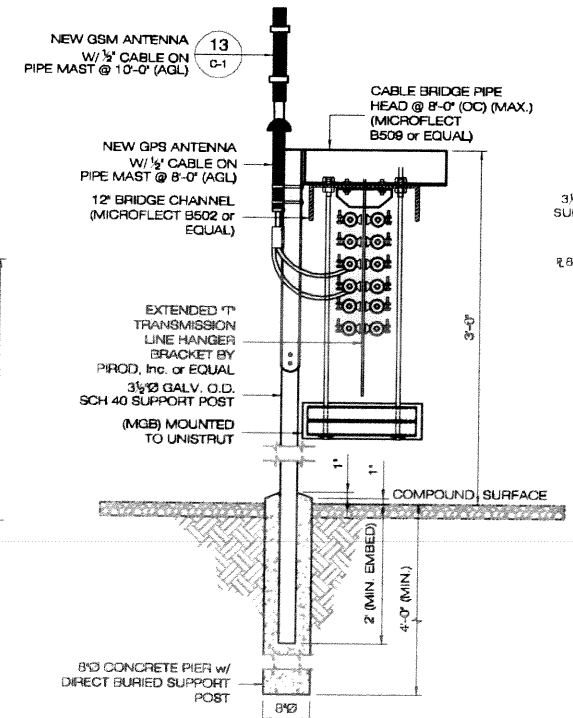


8 SECTION VIEW
S-1 SCALE: N.T.S.

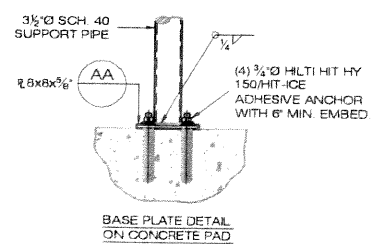


9 HAUNCHED SLAB PLAN
S-1 SCALE: N.T.S.

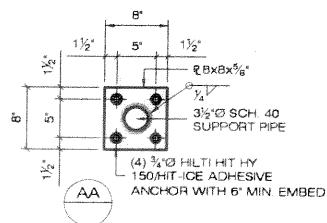

BAY COMMUNICATIONS SITE NUMBER: CT007	DEVELOPMENT & MANAGEMENT DOCUMENTS	COMPOUND DETAILS
APT FILING NUMBER: CT-265-160	GUILFORD MOOSE HILL ROAD GUILFORD, CT 06437	
BAY COMMUNICATIONS	DESIGN TYPE: RAW LAND	APT FILING NUMBER: CT-265-160
391 OAKLAND STREET MANSFIELD, MA 02048 (774) 719-2148	REVISIONS:	APT DRAWING NUMBER: CT0007
ALL-POINTS TECHNOLOGY CORPORATION	REV. 0: 09/04/14: FOR REVIEW: SMC	DRAWN BY: RCB CHECKED BY: SMC
3 SADDLEBROOK DRIVE KILLINGWORTH, CT 06419 WWW.ALLPOINTS.TECH.COM	REV. 1: 01/13/15: TOWER REVISIONS: SMC	SCALE: AS NOTED
PHONE (860) 663-1697 FAX (860) 663-0935	REV. 2:	DATE: 09/04/14
	REV. 3:	SHEET NUMBER: S-1
	REV. 4:	
	REV. 5:	

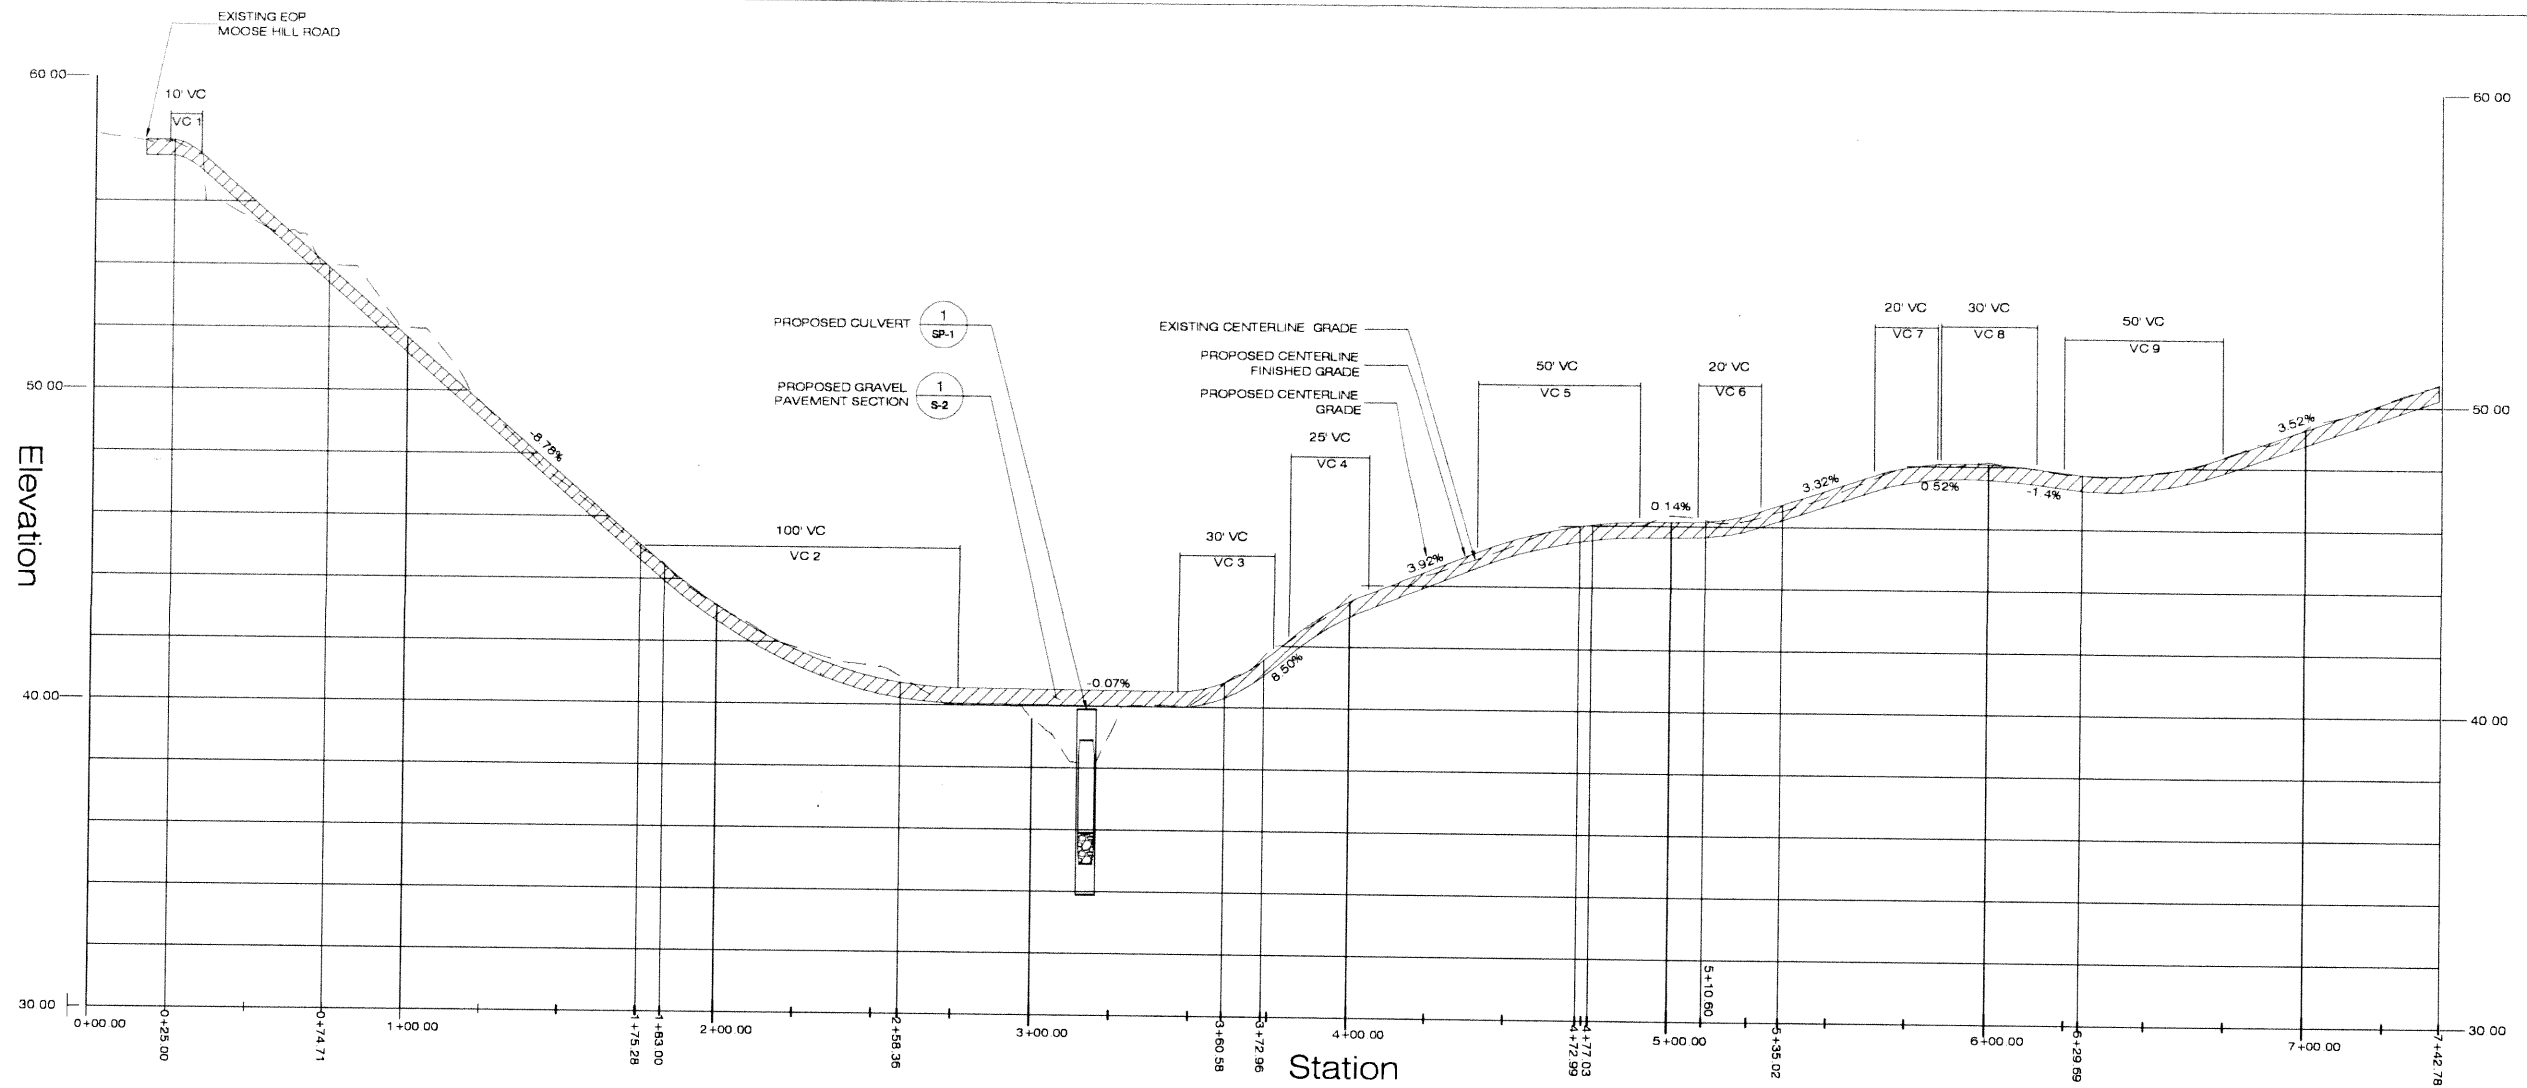



PROPOSED ACCESS ROAD CENTERLINE PROFILE
 SCALE: 1"=30' HORIZONTAL
 1"= 3' VERTICAL

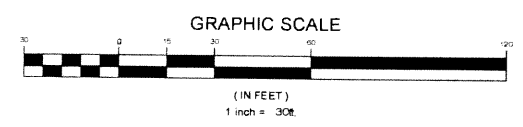

VERTICAL CURVE TABLE					
LINE #	PVI STA	GRADE IN	GRADE OUT	LENGTH	K VALUE
VC1	0+28.54	0.14%	-8.78%	10.00	1.12
VC2	2+26.53	-8.78%	-0.07%	100.00	11.48
VC3	3+60.95	-0.07%	8.50%	30.00	3.50
VC4	3+93.23	8.50%	3.92%	25.00	5.46
VC5	4+65.71	3.92%	0.14%	50.00	13.22
VC6	5+18.16	0.14%	3.32%	20.00	6.30
VC7	5+74.81	3.32%	0.52%	20.00	7.15
VC8	6+00.10	0.52%	-1.4%	30.00	15.58
VC9	6+48.95	-1.4%	3.52%	50.00	10.15

LINE TABLE FOR ALIGNMENT		
LINE #	LENGTH	DIRECTION
L1	25.0	S83° 22' 51.62"E
L2	100.57	S81° 31' 03.10"E
L3	75.35	S83° 43' 43.91"E
L4	12.38	N69° 14' 07.17"E
L5	4.03	N20° 22' 56.93"E
L6	24.42	N75° 20' 50.30"E
L7	113.09	N18° 14' 59.39"E

CURVE TABLE FOR ALIGNMENT			
CURVE #	RADIUS	LENGTH	CHORD DIRECTION
C1	356.00	49.71	S79° 22' 50.13"E
C2	200.00	7.72	S82° 37' 23.51"E
C3	195.00	102.22	N81° 15' 11.63"E
C4	125.00	100.03	N43° 18' 32.05"E
C5	35.00	33.58	N47° 51' 53.61"E
C6	95.00	94.67	N46° 47' 54.84"E

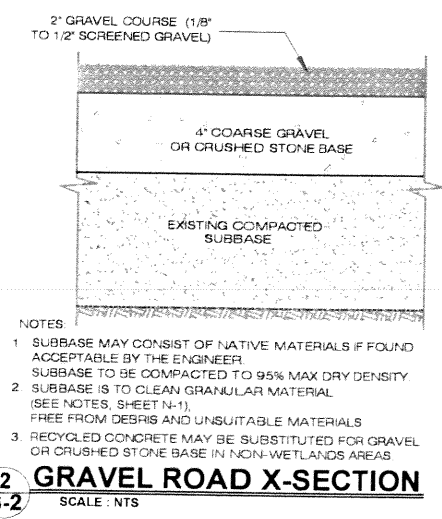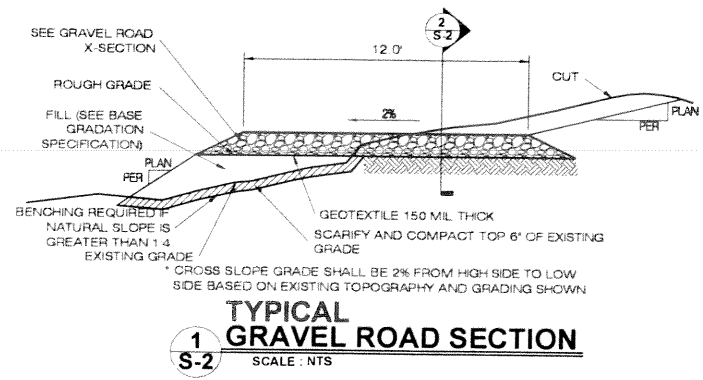

- NOTES
- SUBBASE MAY CONSIST OF NATIVE MATERIALS IF FOUND ACCEPTABLE BY THE ENGINEER. SUBBASE TO BE COMPACTED TO 95% MAX DRY DENSITY.
 - SUBBASE IS TO CLEAN GRANULAR MATERIAL (SEE NOTES, SHEET N-1), FREE FROM DEBRIS AND UNSUITABLE MATERIALS.
 - RECYCLED CONCRETE MAY BE SUBSTITUTED FOR GRAVEL OR CRUSHED STONE BASE IN NON-WETLANDS AREAS.

BAY COMMUNICATIONS SITE NUMBER: **CT0007**
 APT FILING NUMBER: **CT-265-160**

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 391 OAKLAND STREET
 MANSFIELD, MA 02048
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 KILLINGWORTH, CT 06419
 WWW.ALLPOINTSTECH.COM

PHONE: (860) 663-1697
 FAX: (860) 663-0935

DEVELOPMENT & MANAGEMENT DOCUMENTS	
GUILFORD MOOSE HILL ROAD GUILFORD, CT 06437	
DESIGN TYPE:	RAW LAND
REVISIONS:	
REV. 0:	09/04/14: FOR REVIEW: SMC
REV. 1:	01/13/15: TOWER REVISIONS: SMC
REV. 2:	
REV. 3:	
REV. 4:	
REV. 5:	

ACCESS DRIVEWAY PROFILE & DETAILS

APT FILING NUMBER: CT-265-160
 APT DRAWING NUMBER: CT0007
 DRAWN BY: RCB
 CHECKED BY: SMC
 SCALE: AS NOTED
 DATE: 09/04/14

SHEET NUMBER: **S-2**

