ATTACHMENT 4



Legend



Site

Municipal Boundary

Subject Property

Approximate Parcel Boundary

Map Notes:
Base Map Source: CT ECO 2019 Imagery
Map Scale:1 inch = 400 feet
Map Date: November 2021



Site Location Map


Proposed Wireless Telecommunications Facility **Brookfield South** 60 Vale Road Brookfield, Connecticut








Legend

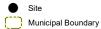

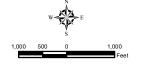

Site Location Map

Proposed Wireless Telecommunications Facility Brookfield South 60 Vale Road Brookfield, Connecticut




ALL-POINTS TECHNOLOGY CORPORATION




HOMELAND TOWERS, LLC

WIRELESS TELECOMMUNICATIONS FACILITY

BROOKFIELD SOUTH 60 VALE ROAD BROOKFIELD, CT 06804

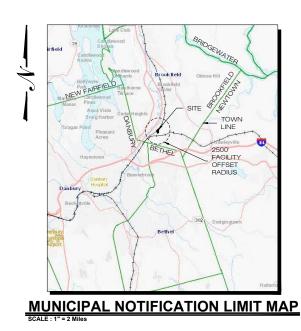

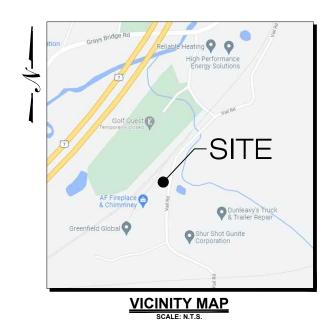

DRAWING INDEX

T-1 TITLE SHEET

EX-1 BOUNDARY SURVEY

SP-1 SITE PLAN & ABUTTERS MAP

SP-2 PARTIAL SITE PLAN

CP-1 COMPOUND PLAN & ELEVATION

C-1 SITE DETAILS

C-2 EROSION CONTROL DETAILS

C-3 AT&T EQUIPMENT PLAN & DETAILS

SITE INFORMATION

PROJECT LOCATION: 60 VALE ROAD

BROOKFIELD, CT 06804

PROJECT DESCRIPTION: RAWLAND SITE W/ GROUND EQUIPMENT

WITHIN 3.150± SETEL ECOMMUNICATIONS COMPOUND W/ NEW 165'± AGL

GALVANIZED MONOPOLE

PROPERTY DEVELOPER: HOMELAND TOWERS, LLC 9 HARMONY STREET

2ND FLOOR

DANBURY, CT 06810

DEVELOPER CONTACT: RAY VERGATI (203) 297-6345

ENGINEER CONTACT: ROBERT C. BURNS, P.E.

(860) 552-2036

LATITUDE: 41° 26' 08.94" N (41.435817) LONGITUDE: 73° 23' 57.56" W (-73.399322)

ELEVATION: 298.0'± AMSL

MAP: E16 ZONE: I-1 HO HOMELAND TOWERS, LLC DANBURY, CT 06810





'ALL-POINTS

7 VAUXHALL STREET EXTENSION - SUITE 31 ATERFORD, CT 06385 PHONE: (860)-663-WW.ALLPOINTSTECH.COM FAX:(860)-663-0

PETITION DOCUMENTS

NO	DATE	REVISION		
0	03/07/22	FOR REVIEW: RCB		
1	03/23/22	CLIENT REVS: RCB		
2	03/29/22	CLIENT REVS: RCB		
3	07/28/22	MUNI ANTENNA REVS: RCB		
4				
5				
6				

DESIGN PROFESSIONALS OF RECORD

PROF: ROBERT C. BURNS P.E. COMP: ALL-POINTS TECHNOLOGY CORPORATION, P.C. ADD: 567 VAUXHALL STREET EXT. SUITE 311 WATERFORD, CT 06385 DEVELOPER: HOMELAND TOWERS, LLC

ADDRESS: 9 HARMONY STREET 2ND FLOOR DANBURY, CT 06810

BROOKFIELD SOUTH

SITE 60 VALE ROAD ADDRESS: BROOKFIELD, CT 06804

DATE: 03/07/22 DRAWN BY: CSI

CHECKED BY: RCE

TITLE SHEET

SHEET TITLE:

SHEET NUMBER: T-1

OWNER:

2ND FLOOR

70 VALE ROAD LLC HOMELAND TOWERS, LLC 9 HARMONY STREET 70 VALE ROAD BROOKFIELD, CT 06804 DANBURY, CT 06810 RAY VERGATI (203) 297-6345

340 MOUNT KEMBLE AVE. MORRISTOWN, NJ 07960

HOMELAND PROJECT ATTORNEY:

CUDDY & FEDER, LLP 14TH FLOOR WHITE PLAINS, NY 10601 (914) 761-1300

POWER PROVIDER: EVERSOURCE: (800) 286-2000


TELCO PROVIDER: FRONTIER (800) 921-8102


(800) 922-4455


CALL BEFORE YOU DIG:

CONNECTICUT STATE BUILDING CODE, LATEST EDITION NATIONAL ELECTRIC CODE, LATEST EDITION

GOVERNING CODES

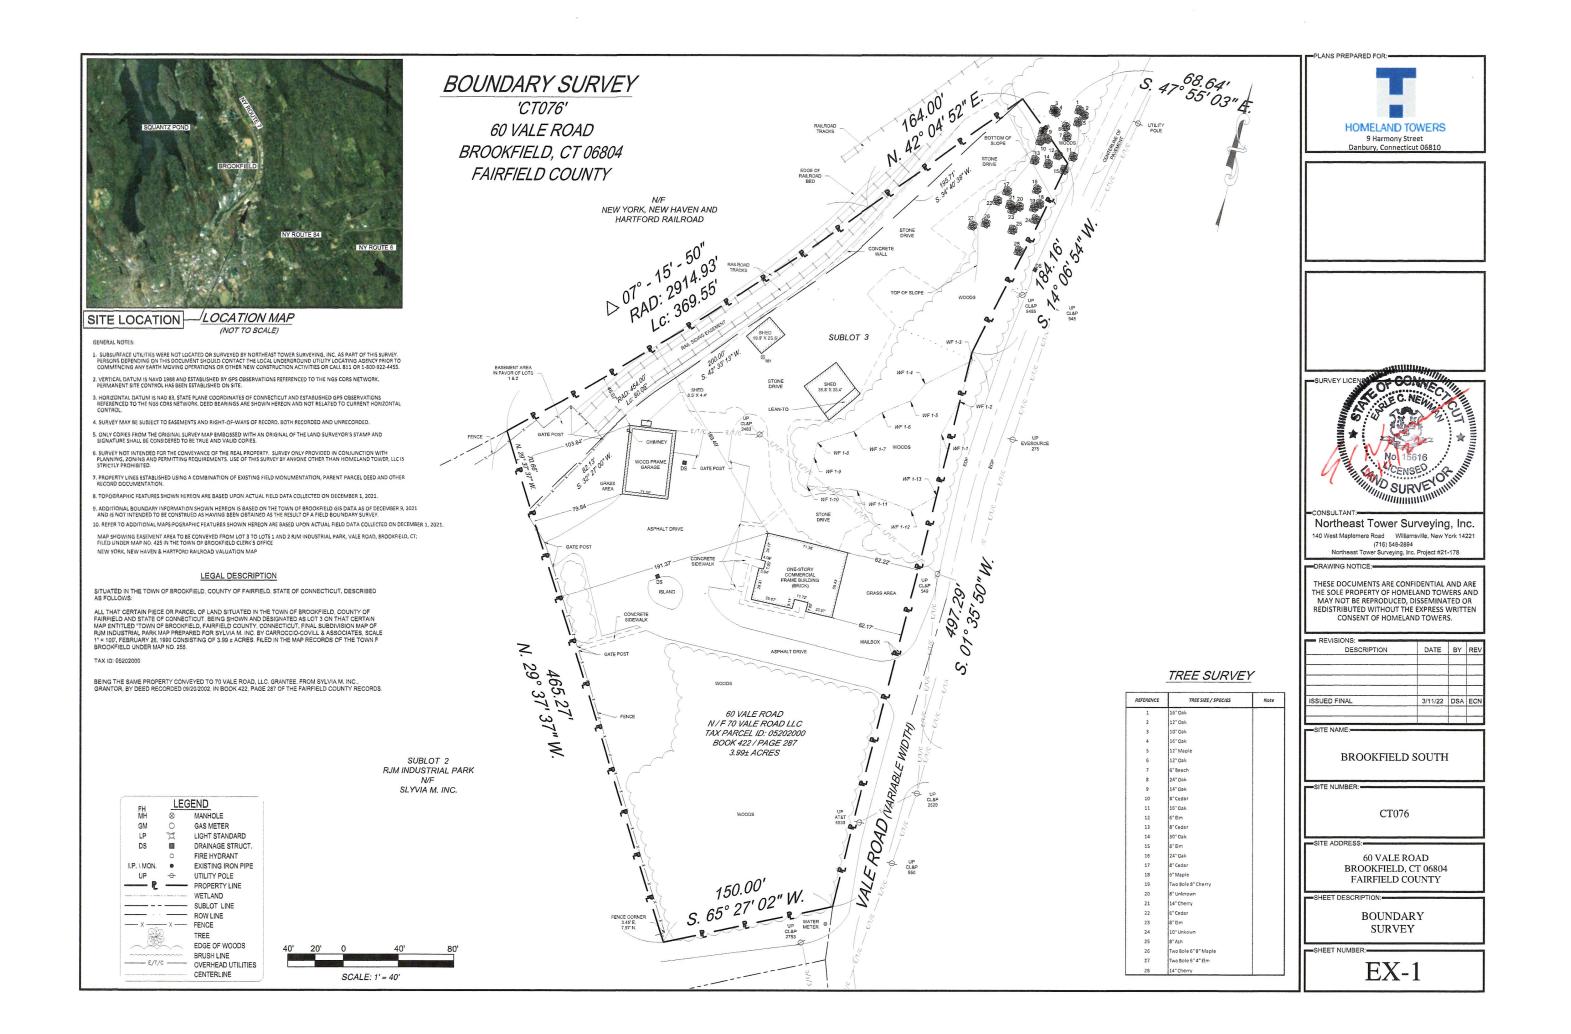

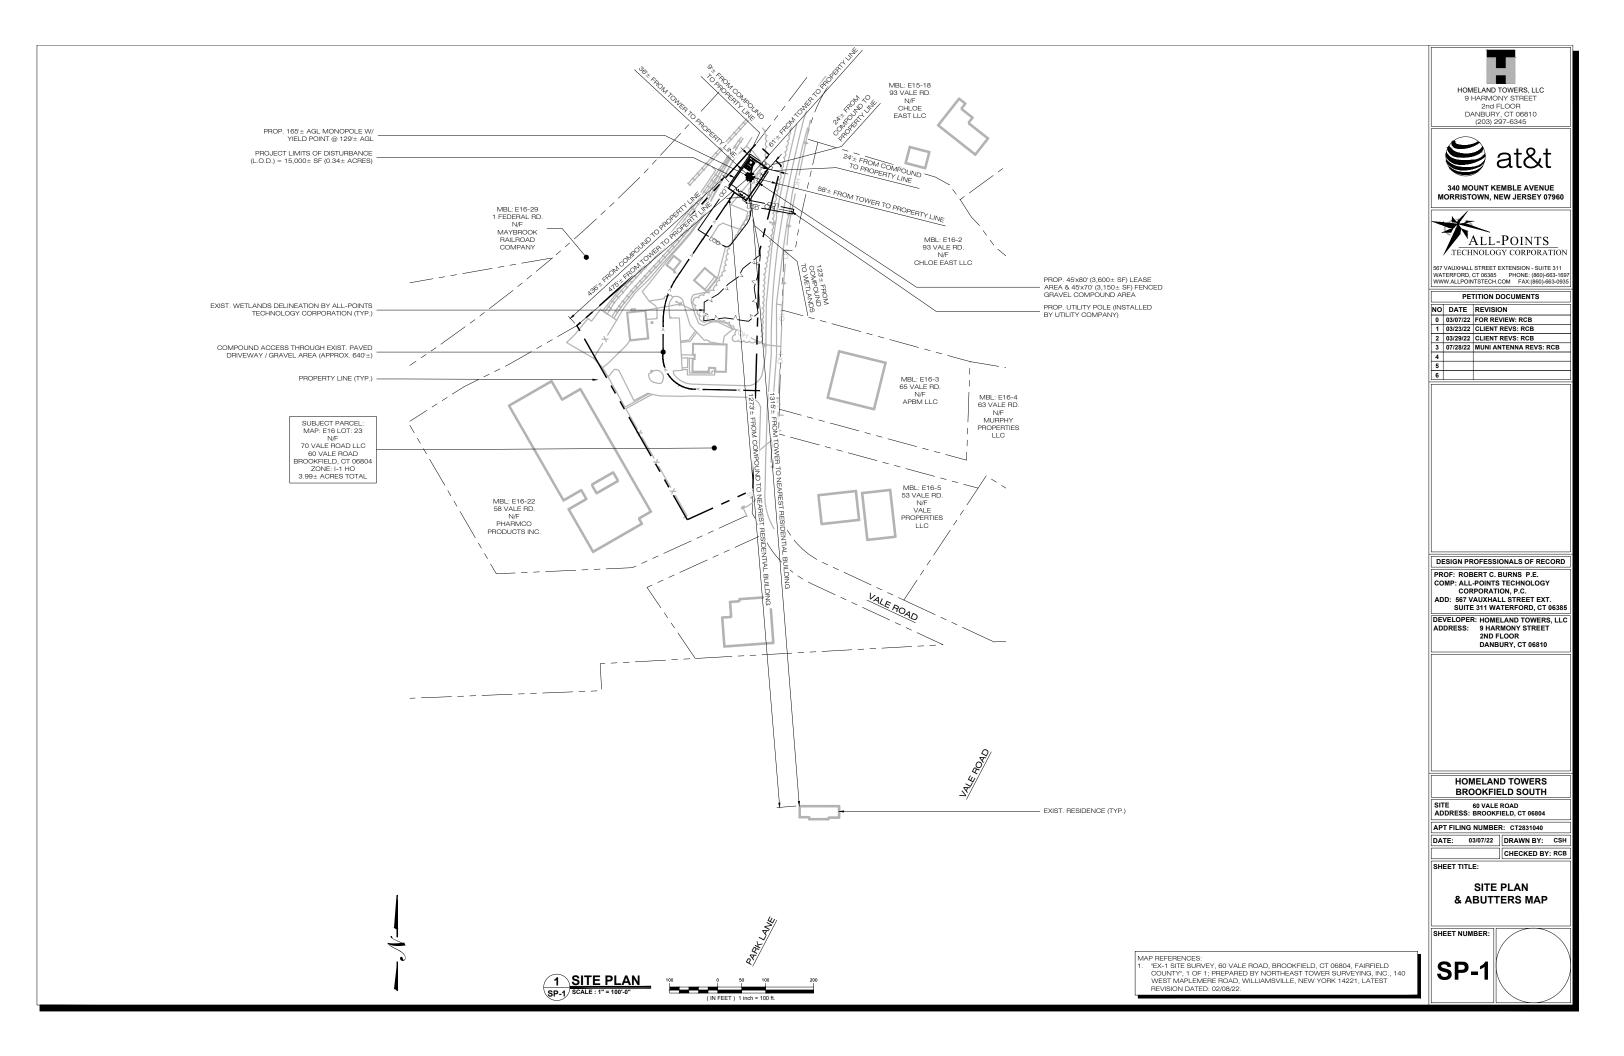

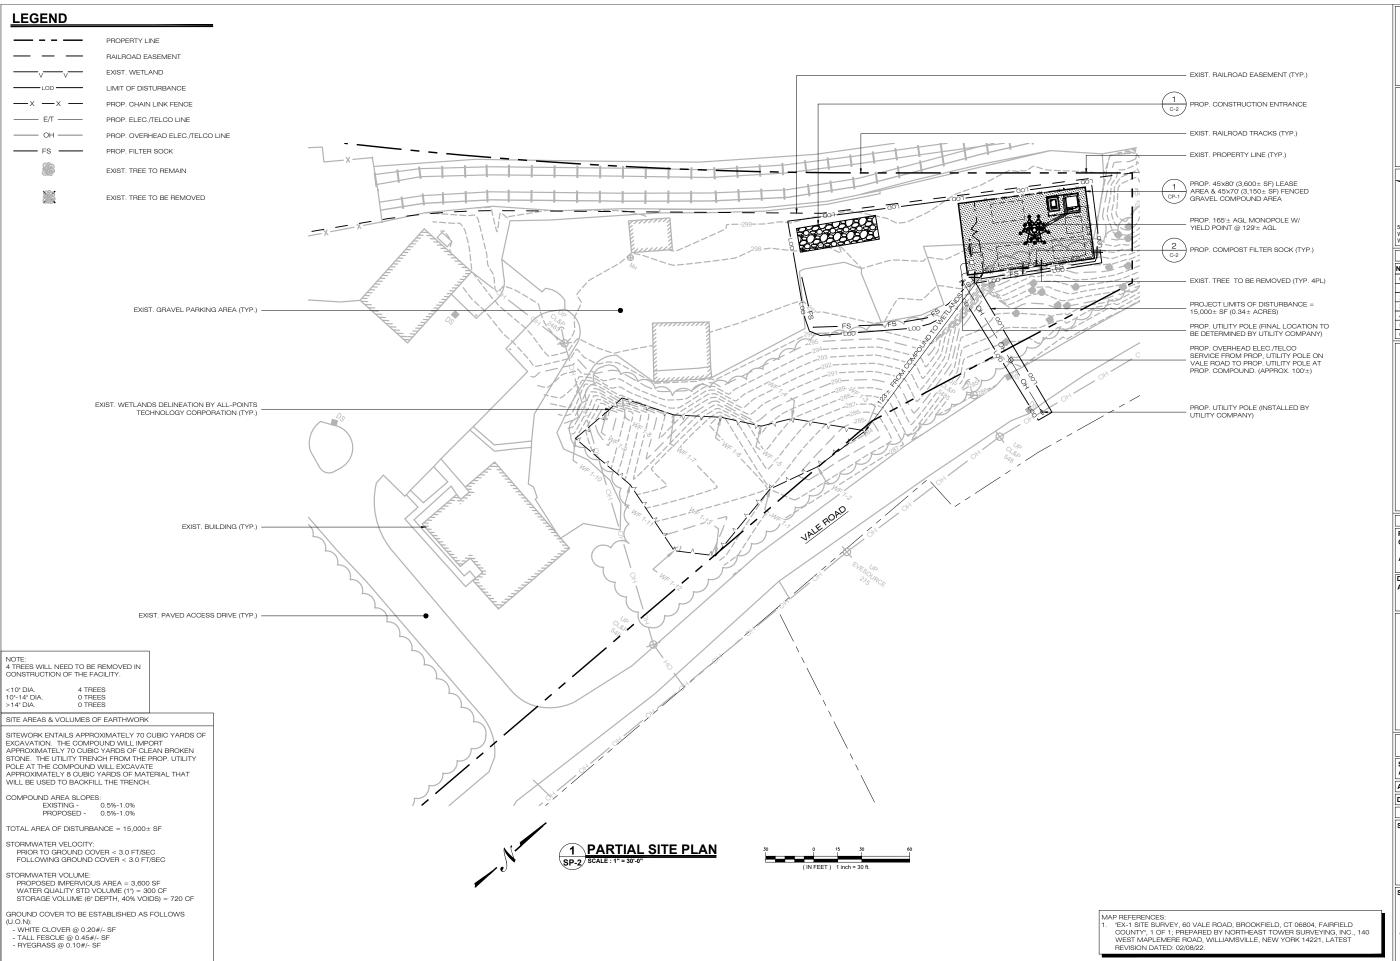

HOMELAND TOWERS, LLC 9 HARMONY STREET 2nd FLOOR DANBURY, CT 06810 (203) 297-6345





MORRISTOWN, NEW JERSEY 07960

567 VAUXHALL STREET EXTENSION - SUITE 311 WATERFORD, CT 06385 PHONE: (860)-663-1697 WWW.ALLPOINTSTECH.COM FAX:(860)-663-0935

PETITION DOCUMENTS

NO	DATE	REVISION
0	03/07/22	FOR REVIEW: RCB
1	03/23/22	CLIENT REVS: RCB
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6		

DESIGN PROFESSIONALS OF RECORD

PROF: ROBERT C. BURNS P.E.
COMP: ALL-POINTS TECHNOLOGY
CORPORATION, P.C.
ADD: 567 VAUXHALL STREET EXT.
SUITE 311 WATERFORD, CT 06388
DEVELOPER: HOMELAND TOWERS, LLC
ADDRESS: 9 HARMONY STREET
2ND FLOOR
DANBURY, CT 06810

·

HOMELAND TOWERS BROOKFIELD SOUTH

SITE 60 VALE ROAD ADDRESS: BROOKFIELD, CT 06804

APT FILING NUMBER: CT2831040


DATE: 03/07/22 DRAWN BY: CSH
CHECKED BY: RCB


SHEET TITLE:

PARTIAL SITE PLAN

SHEET NUMBER:

SP-2

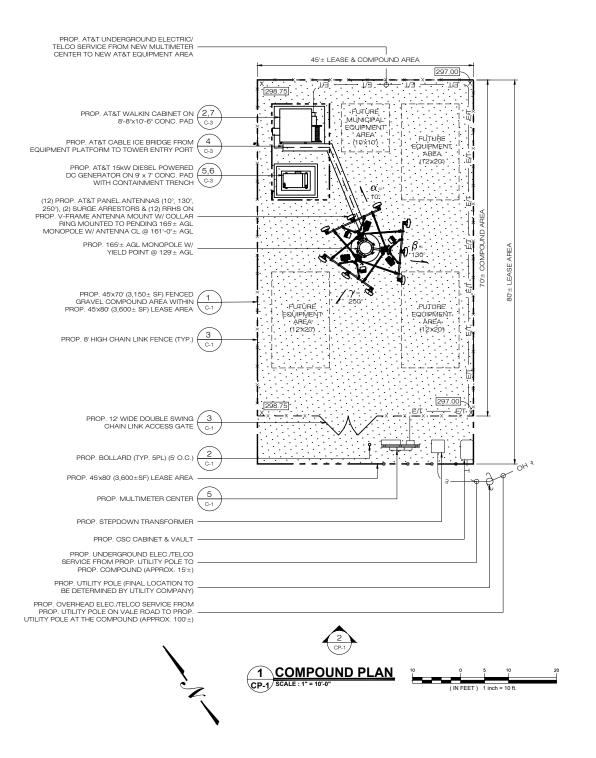

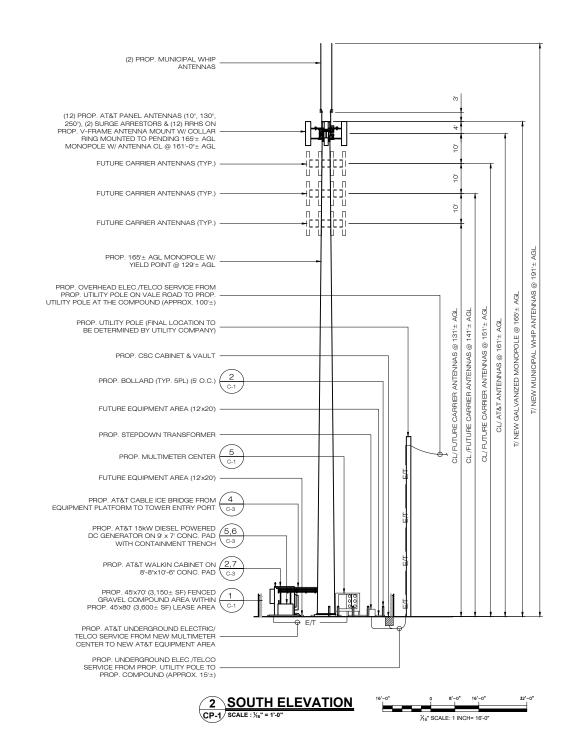





340 MOUNT KEMBLE AVENUE MORRISTOWN, NEW JERSEY 07960



567 VAUXHALL STREET EXTENSION - SUITE 311 WATERFORD, CT 06385 PHONE: (860)-663-169 WWW.ALLPOINTSTECH.COM FAX:(860)-663-0938

PETITION DOCUMENTS

NO	DATE	REVISION
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COMP: ALL-POINTS TECHNOLOGY
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ADD: 567 VAUXHALL STREET EXT.
SUITE 311 WATERFORD, CT 06388

DEVELOPER: HOMELAND TOWERS, LLC
ADDRESS: 9 HARMONY STREET
2ND FLOOR
DANBURY, CT 06810

HOMELAND TOWERS BROOKFIELD SOUTH

SITE 60 VALE ROAD ADDRESS: BROOKFIELD, CT 06804

CHECKED BY: RCB

SHEET TITLE:


COMPOUND PLAN AND ELEVATION


ENGINEERING ANALYSIS AND CERTIFICATION

THE SUBJECT TOWER SHALL BE DESIGNED IN ACCORDANCE WITH THE 2015 INTERNATIONAL BUILDING CODE, AS AMENDED BY THE 2018 CONNECTICUT STATE BUILDING CODE, THE TELECOMMUNICATIONS INDUSTRY ASSOCIATION STANDARD TIA-222-H "STRUCTURAL STANDARD FOR ANTENNA SUPPORTING STRUCTURES AND ANTENNAS AND SMALL WIND TURBINE SUPPORT STRUCTURES", UTILIZING AN ULTIMATE DESIGN BASIC WIND SPEED OF 120 MPH (3-SEC GUST), EQUIVALENT TO A NOMINAL BASIC DESIGN WIND SPEED OF 98 MPH (3-SEC GUST).


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CP-1




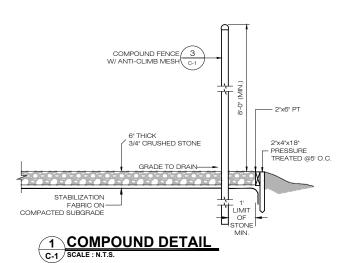


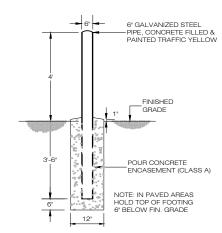

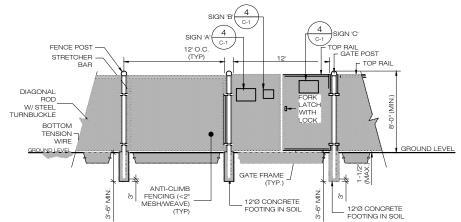

3 CHAIN-LINK FENCING & FENCE GATE DETAIL
C-1 SCALE: N.T.S.

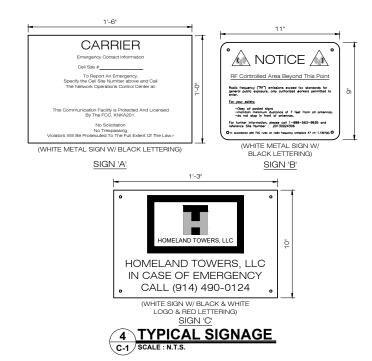

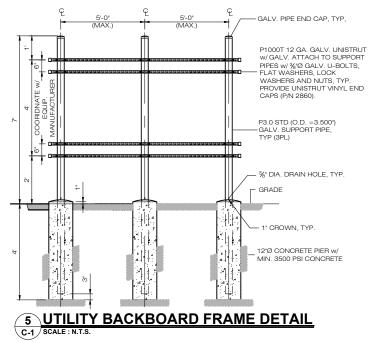





340 MOUNT KEMBLE AVENUE MORRISTOWN, NEW JERSEY 07960



567 VAUXHALL STREET EXTENSION - SUITE 311 WATERFORD, CT 06385 PHONE: (860)-663-11 WWW.ALLPOINTSTECH.COM FAX:(860)-663-08

	FE	ITTION DOCUMENTS
NO	DATE	REVISION
0	03/07/22	FOR REVIEW: RCB
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5		
6		

DESIGN PROFESSIONALS OF RECORD

PROF: ROBERT C. BURNS P.E. COMP: ALL-POINTS TECHNOLOGY CORPORATION, P.C. ADD: 567 VAUXHALL STREET EXT. SUITE 311 WATERFORD, CT 06385 DEVELOPER: HOMELAND TOWERS, LLC ADDRESS: 9 HARMONY STREET
2ND FLOOR
DANBURY, CT 06810

HOMELAND TOWERS **BROOKFIELD SOUTH**


SITE 60 VALE ROAD ADDRESS: BROOKFIELD, CT 06804

APT FILING NUMBER: CT2831040 DATE: 03/07/22 DRAWN BY: CSH

CHECKED BY: RCB SHEET TITLE:

SITE DETAILS


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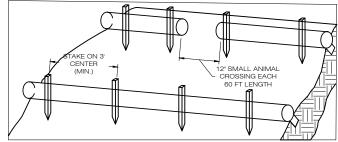


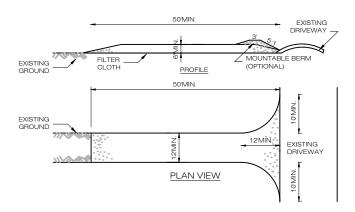CONSTRUCTION ENTRANCE SPECIFICATIONS:

1. STONE SIZE - USE 1-4 INCH STONE, OR RECLAIMED OR RECYCLED CONCRETE EQUIVALENT.

- 2. LENGTH NOT LESS THAN 50 FEET (EXCEPT ON A SINGLE RESIDENCE LOT WHERE A 30 FOOT MINIMUM LENGTH WOULD APPLY).
- 3. THICKNESS NOT LESS THAN SIX (6) INCHES.
- WIDTH TWELVE (12) FOOT MINIMUM, BUT NOT LESS THAN THE FULL WIDTH AT POINTS WHERE INGRESS OR EGRESS OCCURS. TWENTY-FOUR (24) FOOT IF SINGLE ENTRANCE TO SITE.
- 5. GEOTEXTILE WILL BE PLACED OVER THE ENTIRE AREA PRIOR TO PLACING OF STONE.
- 6. SURFACE WATER ALL SURFACE WATER FLOWING OR DIVERTED TOWARD CONSTRUCTION ACCESS SHALL BE PIPED BENEATH THE ENTRANCE. IF PIPING IS IMPRACTICAL, A MOUNTABLE BERM WITH 5:1 SLOPES WILL BE PERMITTED.
- 7 MAINTENANCE THE ENTRANCE SHALL BE MAINTAINED IN A CONDITION WHICH WILL PREVENT TRACKING OR FLOWING OF SEDIMENT ONTO PUBLIC RIGHTS-OF-WAY, ALL SEDIMENT SPILLED, DROPPED, WASHED OR TRACKED ONTO PUBLIC RIGHTS-OF-WAY MUST BE REMOVED IMMEDIATELY.
- WHEN WASHING IS REQUIRED, IT SHALL BE DONE ON A AREA STABILIZED WITH STONE AND WHICH DRAINS INTO AN APPROVED SEDIMENT TRAPPING DEVICE.
- 9. PERIODIC INSPECTION AND NEEDED MAINTENANCE SHALL BE PROVIDED AFTER EACH RAIN.



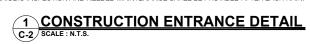

1. BEGIN AT THE LOCATION WHERE THE SOCK IS TO BE INSTALLED BY EXCAVATING A 2-3' (5-7.5 CM) DEEP X 9' (22.9 CM) WIDE TRENCH ALONG THE CONTOUR OF THE SLOPE, EXCAVATED SOIL SHOULD BE PLACED UP SLOPE FROM THE ANCHOR TRENCH.

2. PLACE THE SOCK IN THE TRENCH SO THAT IT CONTOURS TO THE SOIL SURFACE, COMPACT SOIL FROM THE

2. PLACE THE SOCK IN THE THENCH SO THAT IT CONTIOURS TO THE SOIL SURFACE. COMPACT SOIL FHOM THE EXCAVATED TRENCH AGAINST THE SOCK ON THE UPHILL SIDE. SOCKS SHALL BE INSTALLED IN 80 FT CONTINUOUS LENGTHS WITH ADJACENT SOCKS TIGHTLY ABUT. EVERY 60 FT THE SOCK ROW SHALL BE SPACED 12 INCHES CLEAR, END TO END, FOR AMPHIBIAN AND REPTILE TRAVEL. THE OPEN SPACES SHALL BE STAGGERED MID LENGTH OF THE NEXT DOWN GRADIENT SOCK.

3. SECURE THE SOCK WITH 18-24" (45.7-61 CM) STAKES EVERY 3-4" (0.9 -1.2 M) AND WITH A STAKE ON EACH END. STAKES SHOULD BE DRIVEN THROUGH THE MIDDLE OF THE SOCK LEAVING AT LEAST 2-3" (6-7.5 CM) OF STAKE EXTENDING ABOVE THE SOCK. STAKES SHOULD BE DRIVEN THE MIDDLE OF THE SOCK LEAVING AT LEAST 2-3" (6-7.5 CM) OF

COMPOST FILTER SOCK SEDIMENTATION CONTROL BARRIER







MORRISTOWN, NEW JERSEY 07960

567 VAUXHALL STREET EXTENSION - SUITE 311 WATERFORD, CT 06385 PHONE: (860)-663-11 WWW.ALLPOINTSTECH.COM FAX:(860)-663-08

PETITION DOCUMENTS NO DATE REVISION

0	03/07/22	FOR REVIEW: RCB
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4		
5		
6		

DESIGN PROFESSIONALS OF RECORD

PROF: ROBERT C. BURNS P.E. COMP: ALL-POINTS TECHNOLOGY CORPORATION, P.C. ADD: 567 VAUXHALL STREET EXT. SUITE 311 WATERFORD, CT 06385 DEVELOPER: HOMELAND TOWERS, LLC ADDRESS: 9 HARMONY STREET
2ND FLOOR
DANBURY, CT 06810

> HOMELAND TOWERS **BROOKFIELD SOUTH**

SITE 60 VALE ROAD ADDRESS: BROOKFIELD, CT 06804


APT FILING NUMBER: CT2831040


DATE: 03/07/22 DRAWN BY: CSH CHECKED BY: RCB


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EROSION CONTROL DETAILS


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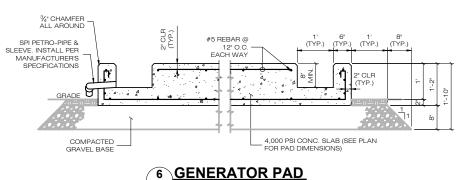


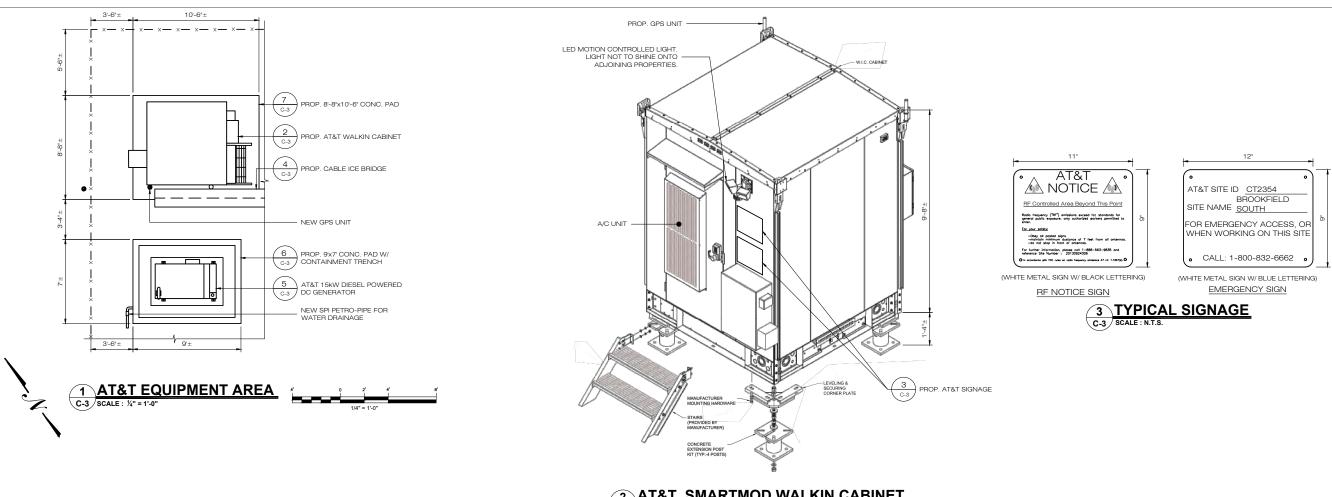


4 CABLE BRIDGE DETAIL
C.3 SCALE: N.T.S.

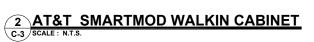

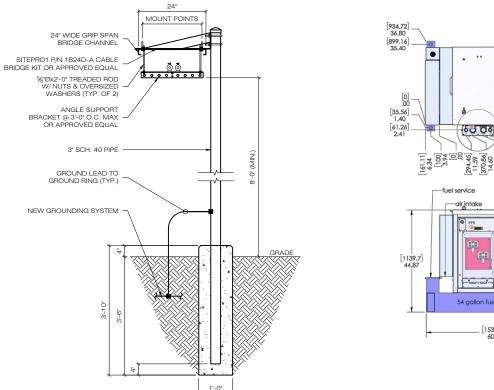5 GENERATOR
C-3 SCALE: N.T.S.

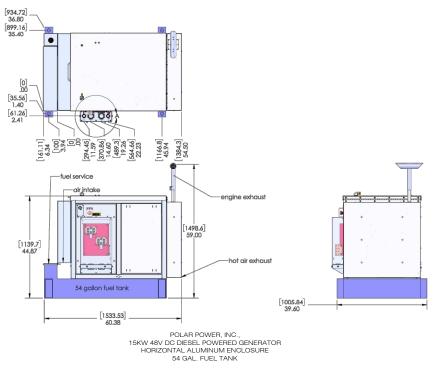



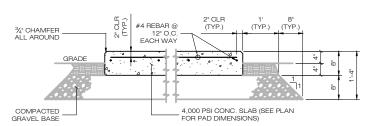

7 EQUIPMENT PAD SCALE: N.T.S.

HOMELAND TOWERS, LLC DANBURY, CT 06810 (203) 297-6345





MORRISTOWN, NEW JERSEY 07960

567 VAUXHALL STREET EXTENSION - SUITE 311 WATERFORD, CT 06385 PHONE: (860)-663-1 WWW.ALLPOINTSTECH.COM FAX:(860)-663-0

ı		PETITION DOCUMENTS			
	NO DATE		REVISION		
ı	0	03/07/22	FOR REVIEW: RCB		
ı	1	03/23/22	CLIENT REVS: RCB		
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ı	4				
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DESIGN PROFESSIONALS OF RECORD

PROF: ROBERT C. BURNS P.E. COMP: ALL-POINTS TECHNOLOGY CORPORATION, P.C. ADD: 567 VAUXHALL STREET EXT. SUITE 311 WATERFORD, CT 06385

DEVELOPER: HOMELAND TOWERS, LLC
ADDRESS: 9 HARMONY STREET
2ND FLOOR
DANBURY, CT 06810

HOMELAND TOWERS **BROOKFIELD SOUTH**

SITE 60 VALE ROAD ADDRESS: BROOKFIELD, CT 06804

APT FILING NUMBER: CT2831040 DATE: 03/07/22 DRAWN BY: CSH CHECKED BY: RCB

SHEET TITLE:

AT&T EQUIPMENT **PLAN & DETAILS**

SHEET NUMBER: **C-3**

Northeast Tower Surveying

140 West Maplemere Road Williamsville, New York 14221 Northeasttowersurveyingt@aol.com (716) 548-2894

FAA-1A SURVEY CERTIFICATION

Applicant: Homeland Towers					
	9 Harmony Stre	eet			
	Danbury, Conn				
Site Name:	Brookfield Sou	th			
Site ID:	CT076				
FA Number:					
Site Address: 60 Vale Road					
	Brookfield, Cor	nnecticut 06804			
Horizontal Dat	tum Source (sel	ect all that apply):			
☐ Ground Surv	vey 🛛 GPS	Survey NAD 83			
Vertical Datun	n Source (select	all that apply):			
☐ Ground Surv	vey 🛛 GPS	Survey NAVD 88			
Structure Type	e (select one):				
New Tower (Monopole)		☐ Existing Tower (☐ Building	
☐ Water Tank		☐ Smokestack		Other (describe): ()	
Latitude:		N 41°-26'-08.94" NAD83 / 41.435817 NAD83			
Longitude:		W 73°-23'-57.56" NAD83 / -73.399322 NAD83			
Ground Elevation:		298.00 feet AMSL NAVD88			
Structure Height:		463.00 feet AMSL	SL 165.00 feet AGL (<u>Proposed Top of Structur</u>		
Overall Max. Height (with Appurtenances):					
		463.00 feet AMSL	165.00	feet AGL (Proposed Top of Structure)	
CERTIFICAT	ION: I certify t	hat the latitude and longi	itude are	e accurate to within +/- 20 feet	

CERTIFICATION: I certify that the latitude and longitude are accurate to within +/- 20 feet horizontally and that the ground elevation is accurate to within +/- 3 feet vertically. The horizontal datum (coordinates) are expressed in terms of degrees, minutes, seconds and hundredths of seconds. The vertical datum (heights) are expressed in terms of feet.

Printed Name:

Earle C. Newman, L.S.

Surveyor License No:

15616

Company:

Northeast Tower Surveying, Inc.

Phone:

(716) 548.2894

Date:

February 25, 2022

Northeast Tower Surveying Project No.: 21-178





OPINION LETTER

April 5, 2022

FAA & FCC Not Required

Christine Vergati Homeland Towers, LLC 9 Harmony Street, 2nd Floor Danbury, CT 06810

RE: CT076 - Brookfield South, CT Airspace Analysis

Latitude (NAD-83): 41° 26′ 08.94″ N
Longitude (NAD-83): 73° 23′ 57.56″ W
Ground Elevation: 298.0 ft. AMSL
Tower tip height: 191.0 ft. AGL
Overall height: 489.0 ft. AMSL



Dear Ms. Vergati,

Our airspace analysis results for the CT076 - Brookfield South, CT site are as follows:

- 1. PER AIRSPACE, filing an FAA Form 7460-1 is not required for the proposed tower height of 191.0 ft. AGL (489.0 ft. AMSL). The maximum allowable height for not filing an FAA Form 7460-1 is 200 ft.
- FCC's TOWAIR Determination indicates that this structure does not require registration. There are no airports within 8 kilometers (5 miles) of the coordinates you provided. The maximum allowable height for not filing an ASR is 200 ft AGL
- 3. The proposed site is 5.11 nm NE from the nearest public landing facility DXR: Danbury Muni. At an overall height of 489.0 ft. AMSL, it does not exceed FAR 77.9 (a) or FAR 77.9 (b) Notice Criteria for DXR airport. This airport has both Circling and Straight-In Instrument approach procedures. It does not exceed any glide slopes of DXR airport. DXR: Danbury Muni is an airport type landing facility associated with the city of Danbury, CT.
- 4. The proposed site is not within any of the instrument approach procedures of DXR airport.
- 5. The nearest private landing facility is 0CT8: Danbury Hospital, which is a heliport type landing facility not eligible for study under FAR Part 77 sub-Part C. It is 2.77 nm SW from the proposed site.
- 6. The proposed 191.0 ft. AGL tower would not adversely affect low altitude en route airways and/ or VFR routes in the area.
- 7. The nearest AM tower is WINE, which is 4.23 mi (6812 meters) away bearing 338.96°. WINE AM is operating a non-directional type antenna system. As noted per the FCC AM Tower Locator and per FCC regulation 13-115, Section 1.30002, the structure will not require a 'Proof of Performance' measurement study before and after construction. The electrical height of the studied antenna is: 66°. Your structure is not within 1 wavelength of this station. The wavelength for this AM station is 319 meters. The critical tower height is 53 meters.
- 8. Marking and lighting are not required as FAA notification is not required.
- 9. All Wireless Applications Corp. analyses are based on the latest AIRSPACE, FAA Notice Criteria Tool and FCC TOWAIR programs.

If you have any questions, please do not hesitate to call.

Thank you.

Ronald W. Lageson, Jr. 425-643-5000 (office) 425-649-5675 (fax)















Develop Manage

Design

Engineering Regulatory

Dashboard