# **ATTACHMENT 4**



### Legend



Municipal Boundary

Approximate Parcel Boundary


<u>Map Notes:</u> Base Map Source: CT ECO 2019 Imagery Map Scale: 1 inch = 500 feet Map Date: December 2021 500 250

### Site Location Map

500 Feet Proposed Wireless Telecommunications Facility CT050 - New Canaan Northwest 1837 Ponus Ridge Road New Canaan, Connecticut






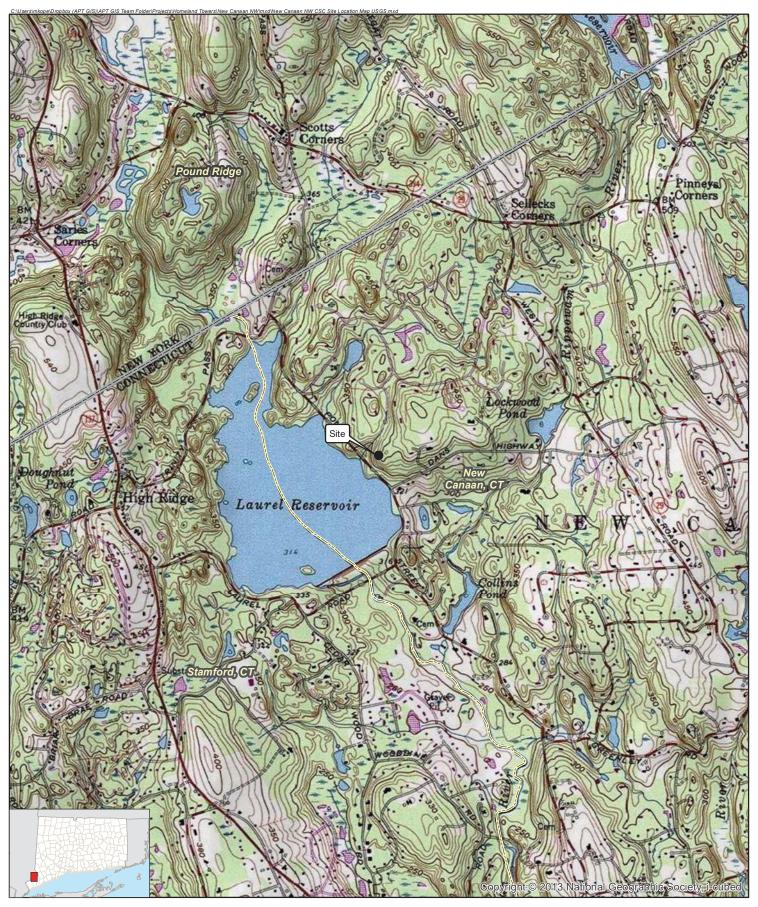

### Legend



<u>Map Notes:</u> Base Map Source: USGS 7.5 Minute Topographic Quadrangle Map, Pound Ridge, NY-CT (1971) Map Scale: 1:24,000 Map Date: December 2021

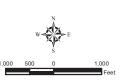


### **Site Location Map**

Proposed Wireless Telecommunications Facility CT050 - New Canaan Northwest 1837 Ponus Ridge Road New Canaan, Connecticut





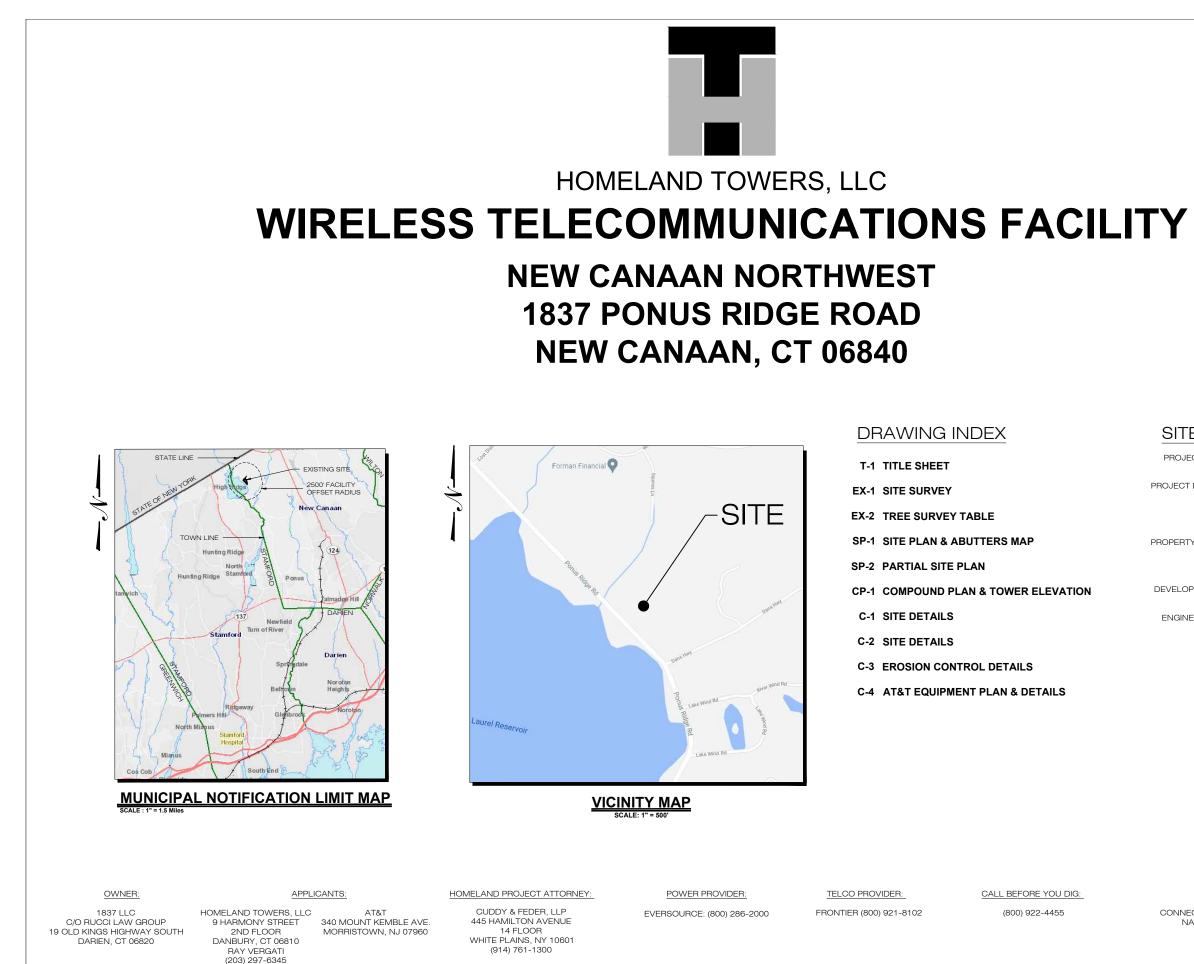

## SITE INFORMATION

JECT LOCATION:	1837 PONUS RIDGE ROAD NEW CANAAN, CT 06840	
CT DESCRIPTION:	RAWLAND SITE W/ GROUND EQUIPMENT WITHIN 3,000± SF TELECOMMUNICATIONS EQUIPMENT COMPOUND W/ PROP. 110'± AGL MONOPINE.	
RTY DEVELOPER:	HOMELAND TOWERS, LLC 9 HARMONY STREET 2ND FLOOR DANBURY, CT 06810	
OPER CONTACT:	RAY VERGATI (203) 297-6345	
INEER CONTACT:	ROBERT C. BURNS, P.E. (860) 552-2036	
LONGITUDE:	41° 10' 18.89"N (41.171914) 73° 32' 36.90"W (-73.543583) 394'± AMSL	
MAP: BLOCK: LOT: ZONE:	27	

HOMELAND TOWERS, LLC 9 HARMONY STREET 2nd FLOOR DANBURY, CT 06810 (203) 297-6345 at&t 340 MOUNT KEMBLE AVENUE MORRISTOWN, NEW JERSEY 0796 'All-Points ECHNOLOGY CORPORAT VAUXHALL STREET EXTENSION - SUITE 31 VATERFORD, CT 06385 PH: (860)-663-16 VWW.ALLPOINTSTECH.COM FAX: (860)-663-0 PERMITTING DOCUMENTS NO DATE REVISION 0 12/07/21 FOR REVIEW: RCE 1 12/10/21 FOR REVIEW: RCB 2 03/29/22 FOR REVIEW: RCB 3 04/04/22 CLIENT REVISIONS: RCE DESIGN PROFESSIONALS OF RECORD PROF' ROBERT C BURNS P.E. COMP: ALL-POINTS TECHNOLOGY CORPORATION, P.C. ADD: 567 VAUXHAUL STREET EXTENSION - SUITE311 WATERFORD, CT 06385 DEVELOPER: HOMELAND TOWERS 11 ADDRESS: 9 HARMONY STREET 2ND FLOOR DANBURY, CT 06810 HOMELAND TOWERS NEW CANAAN NORTHWEST SITE 1837 PONUS RIDGE ROAD ADDRESS: NEW CANAAN, CT 06840 APT FILING NUMBER: CT283860 DATE: 12/07/21 DRAWN BY: CSH CHECKED BY: RCE SHEET TITLE: TITLE SHEET SHEET NUMBER T-1

GOVERNING CODES:

CONNECTICUT STATE BUILDING CODE, LATEST EDITION NATIONAL ELECTRIC CODE, LATEST EDITION TIA-222-H

REFERENCE	TREE SIZE / SPECIES	Note	REFERENCE	
1	36" Oak		61	14'
2	14" Unknown		62	4"
3	6" Unknown		63	8"
4	10" Oak		64	14'
5	30" Oak		65	10'
6	6" Unknown		66	6"
7	6" Unknown		67	8"
8	42" Oak		68	4"
9	12" Birch		69	4"
10	36" / 30" Two Bole Oak		70	Th
11	34" Oak		71	24'
12	6" Birch		72	6"
13	4" Maple		73	Th
14	4" Oak		74	10'
15	28" Oak		75	20'
16	6" Beech		76	4"
17	30" Stump		77	20'
18	12" Oak		78	14'
19	4" Maple		79	4"
20	4" OAk		80	6"
21	4" Unkown		81	20'
22	4" Unkown		82	Tw
23	12" Unknown		83	14'
24	4" Unkown		84	18'
25	4" Unkown		85	16'
26	4" Unkown		86	20'
27	6" Unkown		87	20'
28	12" Maple		88	8"
29	6" Unkown		89	24'
30	12" Maple		90	20'
31	26" Oak		91	6"
32	8" Maple		92	4"
33	12" Beech		93	12'
34	4" Beech		94	10'
35	4" Beech		95	Tw
36	18" Oak		96	4"
37	4" Unkown		97	4"
38	8" Unknown	Dead	98	Tw
39	10" Unknown	Dead	99	22'
40	4" Unkown		100	10'
41	Two Bole 6" 6" Beech		101	4"
42	10" Oak		102	18'
43	8" Unknown		103	14'
44	8" Unknown		104	6"
45	20" Oak		105	Tw
46	4" Oak		106	28'
47	16" Oak		107	Tw
48	4" Beech		108	8"
49	6" Beech		109	Tw
50	12" Beech		110	22'
51	6" Maple		111	4"
52	Two Bole 12" & 4" Beech		112	Tw
53	8" Oak		113	4"
54	12" Oak		114	4"
55	14" Oak		115	8"
56	16" Oak		116	8"
57	8" Unknown		117	6"
58	10" Oak		118	22'
59	10" Oak		119	4"
60	6" Unknown		120	24'
L	1		L	

REFERENCE	TREE SIZE / SPECIES	Note
61	14" Beech	
62	4" Unknown	
63	8" Unknown	
64	14" Unknown	
65	10" Unknown	
66	6" Unknown	
67	8" Unknown	
68	4" Unknown	
69	4" Beech	
70	Three Bole 4", 4" & 2" Beech	
71	24" Oak	
72	6" Unknown	
73	Three Bole 6", 6" & 4" Beech	
74	10" Beech	
75	20" Oak	
76	4" Unknown	
77	20" Oak	
78	14" Oak	
79	4" Unknown	
80	6" Unknown	Dead
81	20" Oak	Dead
82	Two Bole 8" & 6" Beech	
83		
	14" Oak	
84	18" Oak	
85	16" Oak	
86	20" Birch	
87	20" Birch	
88	8" Birch	
89	24" Oak	
90	20" Oak	
91	6" Beech	
92	4" Beech	
93	12" Unknown	
94	10" Beech	
95	Two Bole 20" & 18" Oak	
96	4" Unknown	
97	4" Maple	
98	Two Bole 14" & 10" Oak	
99	22" Oak	
100	10" Maple	
101	4" Maple	
102	18" Maple	
103	14" Maple	
104	6" Beech	
105	Two Bole 6" & 4" Maple	
106	28" Oak	
107	Two Bole 8" & 12" Maple	
108	8" Maplw	
109	Two Bole 16" & 14" Maple	
110	22" Birch	
111	4" Beech	
112	Two Bole 12" & 10" Maple	
113	4" Maple	
114	4" Maple	
115	8" Oak	
116	8" OAk	
117	6" Maple	
118	22" Oak	
119	4" Maple	
120	24" Oak	
		•

TREE SIZE / SPECIES Note	REFERENCE	TREE SIZE / SPECIES	Note	REFERENCE	TREE SIZE / SPECIES	Note	REFERENC
1" Beech	121	8" Oak		181	4" Beech		241
' Unknown	122	6" Oak		182	24" Hickory Stump		242
' Unknown	123	4" Maple		183	20" Maple		243
4" Unknown	124	10" Birch		184	Two Bole 14" & 4" Maple		244
D" Unknown	125	14" Oak		185	8" Birch		245
' Unknown	126	8" Unknown	Dead	186	8" Oak		246
' Unknown	127	10" Birch		187	18" Maple		247
" Unknown	128	16" Oak		188	14" Oak		248
" Beech	129	6" Oak		189	22" Oak		249
hree Bole 4", 4" & 2" Beech	130	16" Oak		190	Three Bole 10", 6" & 4" Oak		250
4" Oak	131	8" Beech		191	14" Oak		251
' Unknown	131	12" Maple		191	Two Bole 6" & 6" Maple		251
hree Bole 6", 6" & 4" Beech	133	6" Beech		193	12" Birch		253
0" Beech	134	8" Beech		194	16" Oak		254
D" Oak	135	24" Oak		195	8" Birch		255
" Unknown	136	26" Oak		196	10" Oak		256
D" Oak	137	6" Oak		197	10" Maple		257
4" Oak	138	8" Oak		198	20" Oak		258
" Unknown	139	10" Beech		199	28" Oak		259
" Unknown Dead	140	14" Oak		200	8" Oak		260
0" Oak	141	Two Bole 12" & 6" Maple		201	24" Maple		261
wo Bole 8" & 6" Beech	142	6" Unknown		202	Two Bole 6" & 8" Maple		262
4" Oak	143	18" Oak		203	8" Birch		263
8" Oak	144	24" Oak		204	8" Birch		264
5" Oak	145	6" Birch		205	14" Oak		265
D" Birch	146	Two Bole 6" & 6" Maple		206	6" Birch		266
0" Birch	147	18" Oak		207	6" Birch		267
" Birch	148	8" Birch		208	10" Hemlock		268
4" Oak	149	Two Bole 4" & 8" Maple		209	22" Oak		269
0" Oak	145	6" Maple		203	10" Birch		203
		4" Maple					
" Beech	151			211	10" Oak		271
" Beech	152	26" Oak		212	6" Oak		272
2" Unknown	153	10" Oak		213	10" Oak		273
0" Beech	154	14" Oak		214	10" Birch		274
wo Bole 20" & 18" Oak	155	16" Oak		215	6" Oak		275
" Unknown	156	26" Oak		216	14" Oak		276
" Maple	157	30" Oak		217	10" Oak		277
wo Bole 14" & 10" Oak	158	10" Unknown		218	40" Unknown	Dead	278
2" Oak	159	20" Oak		219	8" Beech		279
D" Maple	160	20" Oak		220	4" Beech		280
" Maple	161	10" Maple		221	26" Beech		281
8" Maple	162	8" Maple		222	32 Beech		282
4" Maple	163	6" Maple		223	16" Beech		283
" Beech	164	6" Maple		224	14" Oak		284
wo Bole 6" & 4" Maple	165	6" Maple		225	12" Oak		285
8" Oak	166	6" Oak	1	226	8" Hemlock		286
wo Bole 8" & 12" Maple	167	12" Maple		227	30" Oak	Dead	287
" Maplw	168	8" Birch	<u> </u>	228	8" Beech		288
wo Bole 16" & 14" Maple	169	10" Maple		229	24" Henlock		289
2" Birch	170	10" Maple		230	8" Oak		290
" Beech	170	16" Maple		230	4" Birch		
						Dead	291
wo Bole 12" & 10" Maple	172	8" Oak		232	30" Unknown	Dead	292
" Maple	173	8" Oak	<b> </b>	233	24" Oak		293
" Maple	174	6" Birch	<b> </b>	234	8" Maple		294
" Oak	175	14" Oak	<b> </b>	235	4" Beech		295
" OAk	176	12" Birch		236	4" Beech		296
" Maple	177	Two Bole 18" & 14" Oak		237	Two Bole 14" & 6" Oak		297
2" Oak	178	8" Birch		238	8" Maple		298
" Maple	179	20" Maple		239	4" Maple		299
				240	24" Oak		300
4" Oak	180	Two Bole 8" & 4" Oak		240	24 Udk		500


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REFERENCE	TREE SIZE / SPECIES	Note
181	4" Beech	
182	24" Hickory Stump	
183	20" Maple	
184	Two Bole 14" & 4" Maple	
185	8" Birch	
186	8" Oak	
187	18" Maple	
188	14" Oak	
189	22" Oak	
190	Three Bole 10", 6" & 4" Oak	
191	14" Oak	
192	Two Bole 6" & 6" Maple	
193	12" Birch	
194	16" Oak	
195	8" Birch	
196	10" Oak	
197	10" Maple	
198	20" Oak	
199	28" Oak	
200	8" Oak	
201	24" Maple	
202	Two Bole 6" & 8" Maple	
203	8" Birch	
204	8" Birch	
205	14" Oak	
206	6" Birch	
207	6" Birch	
208	10" Hemlock	
209	22" Oak	
210	10" Birch	
211	10" Oak	
212	6" Oak	
213	10" Oak	
214	10" Birch	
215	6" Oak	
216	14" Oak	
217	10" Oak	
218	40" Unknown	Dead
219	8" Beech	
220	4" Beech	
221	26" Beech	
222	32 Beech	
223	16" Beech	
224	14" Oak	
225	12" Oak	
226	8" Hemlock	
227	30" Oak	Dead
228	8" Beech	
229	24" Henlock	
230	8" Oak	
231	4" Birch	
232	30" Unknown	Dead
233	24" Oak	
234	8" Maple	
235	4" Beech	
235	4" Beech	
230	4 Beech Two Bole 14" & 6" Oak	
237	8" Maple	
238	4" Maple	
240	24" Oak	


REFERENCE	TREE SIZE / SPECIES	Note
241		
241	10" Oak	
242	6" Maple	
243	24" OAk	Dood
	14" Unknown	Dead
245	6" Beech	
246	12" Oak	
247	4" Maple	
248	14" Birch	
249	22" Oak	
250	22" Oak	
251	18" Oak	
252	18" Oak	
253	18" Oak	
254	14" Beech	
255		
256	10" Birch	
250	18" Oak	
	8" Oak	
258	10 Oak	
259	6" Oak	
260	10" Birch	
261	26" Oak	
262	8" Oak	
263	28" Oak	
264	6" Maple	
265	14" Birch	
266	16" Maple	
267	14" Oak	
268		
269	6" Birch	
203	6" Maple	
	16" Oak	
271	32" Oak	
272	14" Oak	
273	14" Oak	
274	16" Oak	
275	10" Beech	
276	10" Oak	
277	18" Oak	
278	16" Birch	
279	10" Oak	
280		
280	Two Bole 12" & 8" Beech	Dead
281	14" Unknown	Jeau
	10" Oak	
283	36" Oak	
284	6" Oak	I
285	14" Oak	
285	14" Oak	
285 286	14" Oak 10" Beech	
285 286 287	14" Oak 10" Beech 26" Oak	
285 286 287 288	14" Oak 10" Beech 26" Oak 6" Birch 20" Oak	
285 286 287 288 289	14" Oak 10" Beech 26" Oak 6" Birch 20" Oak 8" Oak	
285 286 287 288 289 290	14" Oak 10" Beech 26" Oak 6" Birch 20" Oak 8" Oak 10" Oak	
285 286 287 288 289 290 291 292	14" Oak 10" Beech 26" Oak 6" Birch 20" Oak 8" Oak 10" Oak 14" Beech	
285 286 287 288 289 290 291 291 292 293	14" Oak 10" Beech 26" Oak 6" Birch 20" Oak 8" Oak 10" Oak 14" Beech 4" Beech	
285 286 287 288 289 290 291 292 293 293 294	14" Oak 10" Beech 26" Oak 6" Birch 20" Oak 8" Oak 10" Oak 14" Beech 4" Beech 6" Birch	
285 286 287 288 289 290 291 292 293 293 294 295	14" Oak 10" Beech 26" Oak 6" Birch 20" Oak 8" Oak 10" Oak 14" Beech 4" Beech	
285 286 287 288 289 290 291 292 293 293 294 295 296	14" Oak 10" Beech 26" Oak 6" Birch 20" Oak 8" Oak 10" Oak 14" Beech 4" Beech 6" Birch	
285 286 287 288 289 290 291 292 293 293 294 295	14" Oak 10" Beech 26" Oak 6" Birch 20" Oak 8" Oak 10" Oak 14" Beech 4" Beech 6" Birch 8" Maple	
285 286 287 288 289 290 291 292 293 293 294 295 296	14" Oak 10" Beech 26" Oak 6" Birch 20" Oak 8" Oak 10" Oak 14" Beech 4" Beech 6" Birch 8" Maple 10" Birch	
285 286 287 288 289 290 291 292 293 293 294 295 296 297	14" Oak 10" Beech 26" Oak 6" Birch 20" Oak 8" Oak 10" Oak 14" Beech 4" Beech 6" Birch 8" Maple 10" Birch 14" Birch	


REFERENCE	TREE SIZE / SPECIES	Note
301	6" Beech	
302	4" Birch	
303	8" Beech	
304	6" Maple	
305	8" Birch	
306	4" Beech	
307	26" Oak	
	20" Maple	
308		
309	24" Oak	
310	20" Oak	
311	20" Oak	
312	8" Birch	
313	4" Beech	
314	16" Oak	
315	8" Beech	
316	20" Oak	
317	20" Oak	
318	4" Beech	
319	6" Beech	
320	Two Bole 4" & 4" Beech	
321	20" Beech	
322	18" Unknown	Dead
323	6" Beech	
324	20" Oak	
325	6" Beech	
326	30" Beech	
327	16" Beech	
328	14" Oak	
329	28 Beech	
330	22" Beech	
331	6" Beech	
332	6" Beech	
333	6" Beech	
334	38" Oak	
335	8" Beech	
336	24" Oak	
337	8" Oak	
338	8" Beech	
339	12" Birch	
340	6" Unknown	
341	26" Oak	
342	8" Beech	
343	8" Unknown	
344	4" Beech	
344	10" Birch	
345	10" Beech	
347	8" Oak	
348	8" Beech	
349	8" Beech	
350	8" Beech	
351	8" Beech	
352	18" Beech	
353	18" Oak	
354	20" Oak	
355	Two Bole 10" & 6" Oak	
356	8" Oak	
357	14" Birch	
358	6" Maple	
359	4" Beech	
360	22" Oak	

REFERENCE	TREE SIZE / SPECIES	Note
361	22" Oak	
362	16" Beech	
363	14" Oak	
364	12" Birch 8" Beech	
366	10" Beech	
367	14" Unknown	
368	4" Maple	
369	Two Bole 12" & 6" Oak	
370	16" Oak	
371	10" Maple	
372	20" Oak	
373	8" Birch	
374	4" Beech	
375	16" Oak	
376	10" Beech 12" Beech	
378	12" Deech	
379	16" Birch	
380	6" Maple	
381	16" Beech	
382	20" Oak	
383	4" Beech	
384	12" Beech	
385	6" Beech	
386	6" Beech	
387	14" Beech	
388	6" Beech	
389	18" Beech 8" Beech	
391	4" Beech	
392	24" Beech	
393	4" Beech	
394	14" Beech	
395	6" Beech	
396	22" Beech	
397	10" Beech	
398	4" Beech	
399	4" Beech	
400	4" Beech 6" Beech	
402	28" Beech	
403	30" Beech	
404	14" Beech	
405	14" Beech	
406	12" Beech	
407	10" Beech	
408	6" Beech	
409	16" Beech	
410	8" Beech 8" Beech	
411	8" Beech 6" Beech	
413	16" Beech	
414	4" Beech	
415	6" Beech	
416	20" Beech	
417	10" Beech	
418	10" Beech	
419	24" Beech	
420	6" Beech	
421	6" Beech	
422	16" Beech 4" Beech	
423	4" Beech Two Bole 14" & 8" Maple	
425	16" Beech	
426	6" Beech	+
427	14" Beech	
428	18" Beech	
429	8" Beech	

HOMELAND TO 9 Harmony Stree Danbury, Connecticut	et		
SURVEY LICENSE:			
EARLE C. NEWMAN P.L.S. CONSULTANT: Northeast Tower Sur 140 West Maplemere Road Williams (716) 548-2894 Norteast Tower Surveying, Inc. F DRAWING NOTICE: THESE DOCUMENTS ARE CON	<b>Veying</b> wille, New Y Project #21-	<b>g, In</b> ′ork 14 025	221
ARE THE SOLE PROPERTY O TOWERS AND MAY NOT BE DISSEMINATED OR REDIS WITHOUT THE EXPRESS WRITON	F HOMEL REPRODU STRIBUTE FTEN CON	AND ICED, D	
REVISIONS: DESCRIPTION	DATE	BY	REV
ISSUED FINAL ISSUED DRAFT	11/30/21 05/07/21		ECN ECN
NEW CANAAN NOI	RTHW	EST	7
SITE NUMBER:			
SITE ADDRESS: 1837 PONUS RIDG NEW CANAAN, C FAIRFIELD COU	CT 06840		
SHEET DESCRIPTION:			
EX-2	)		

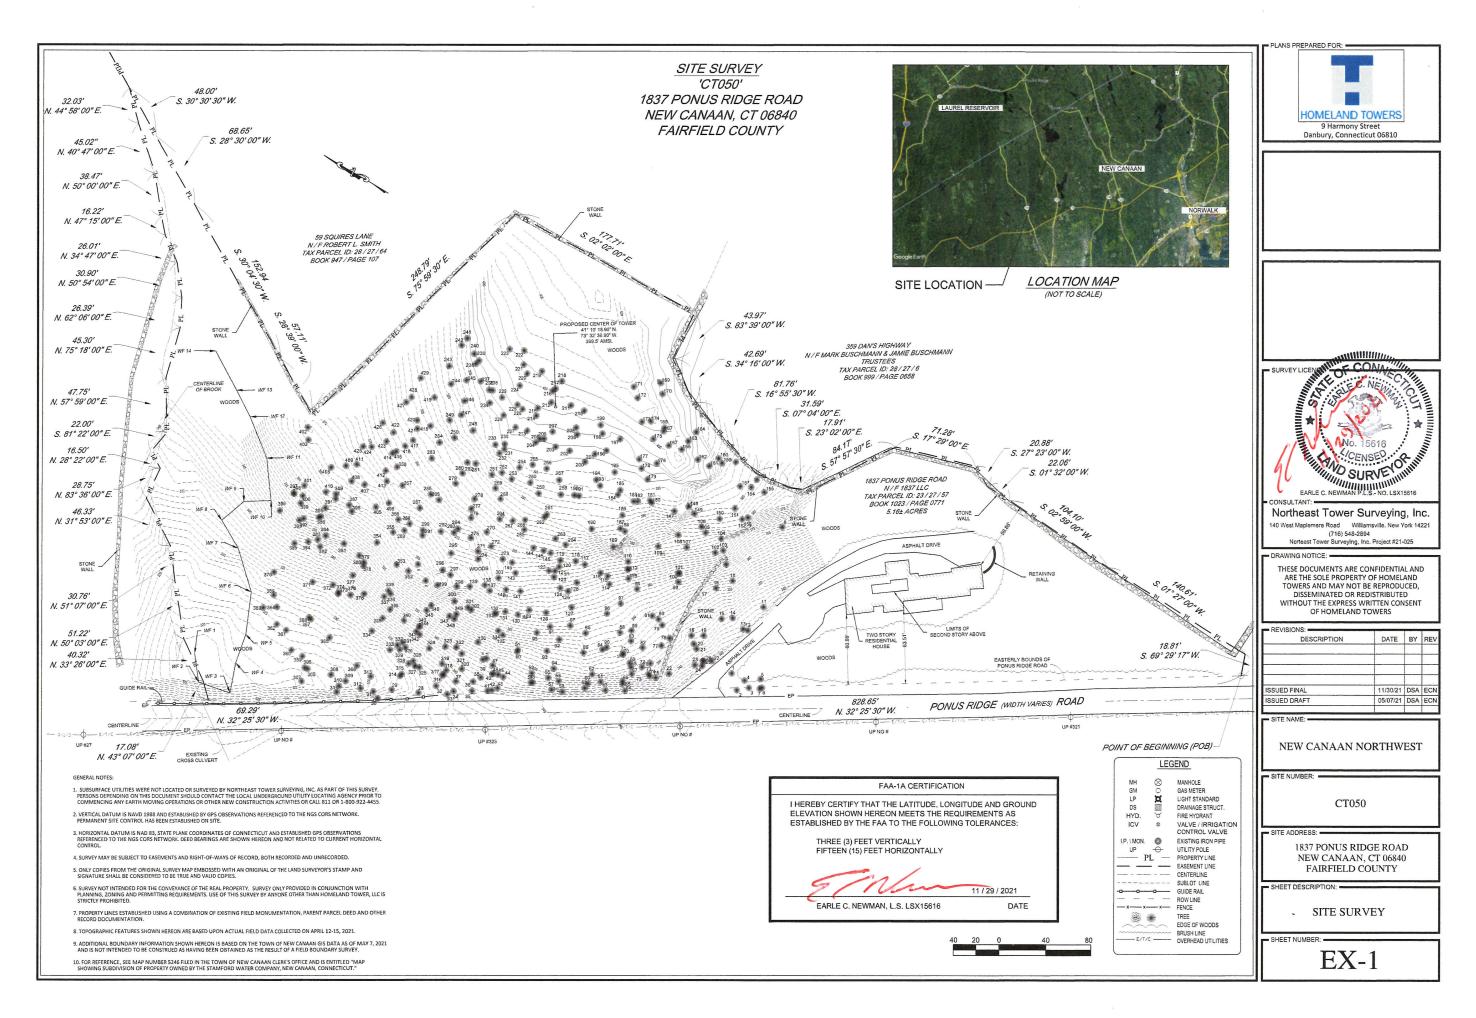

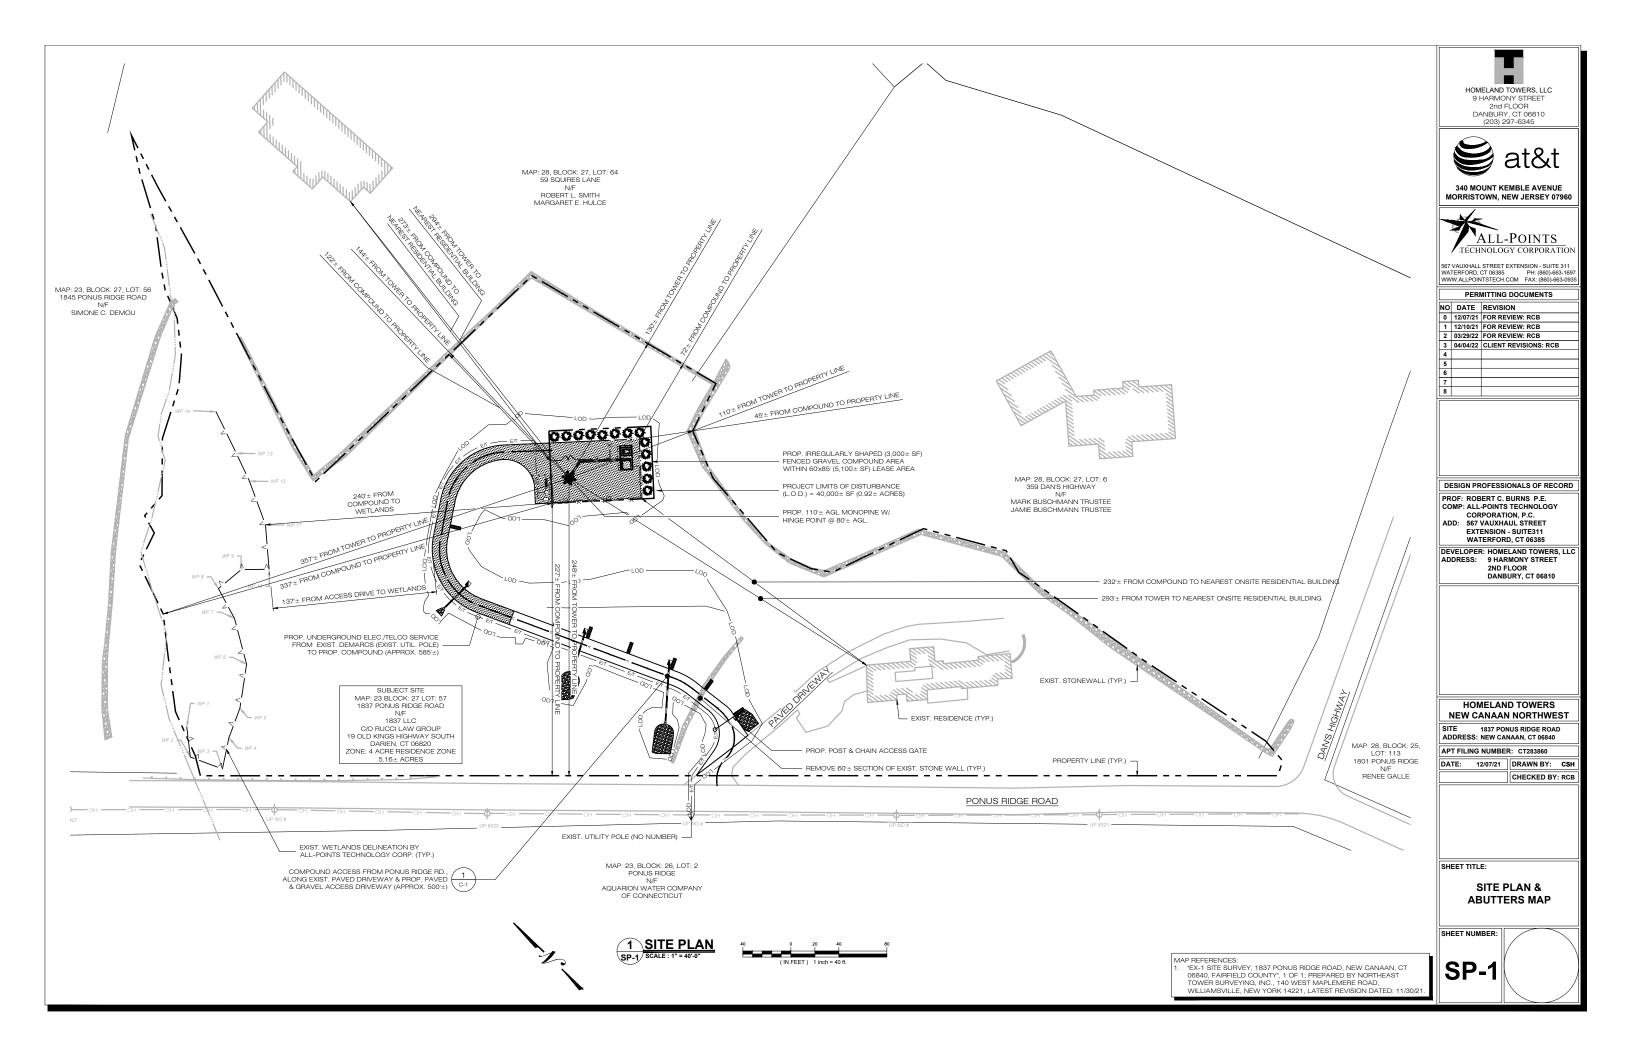

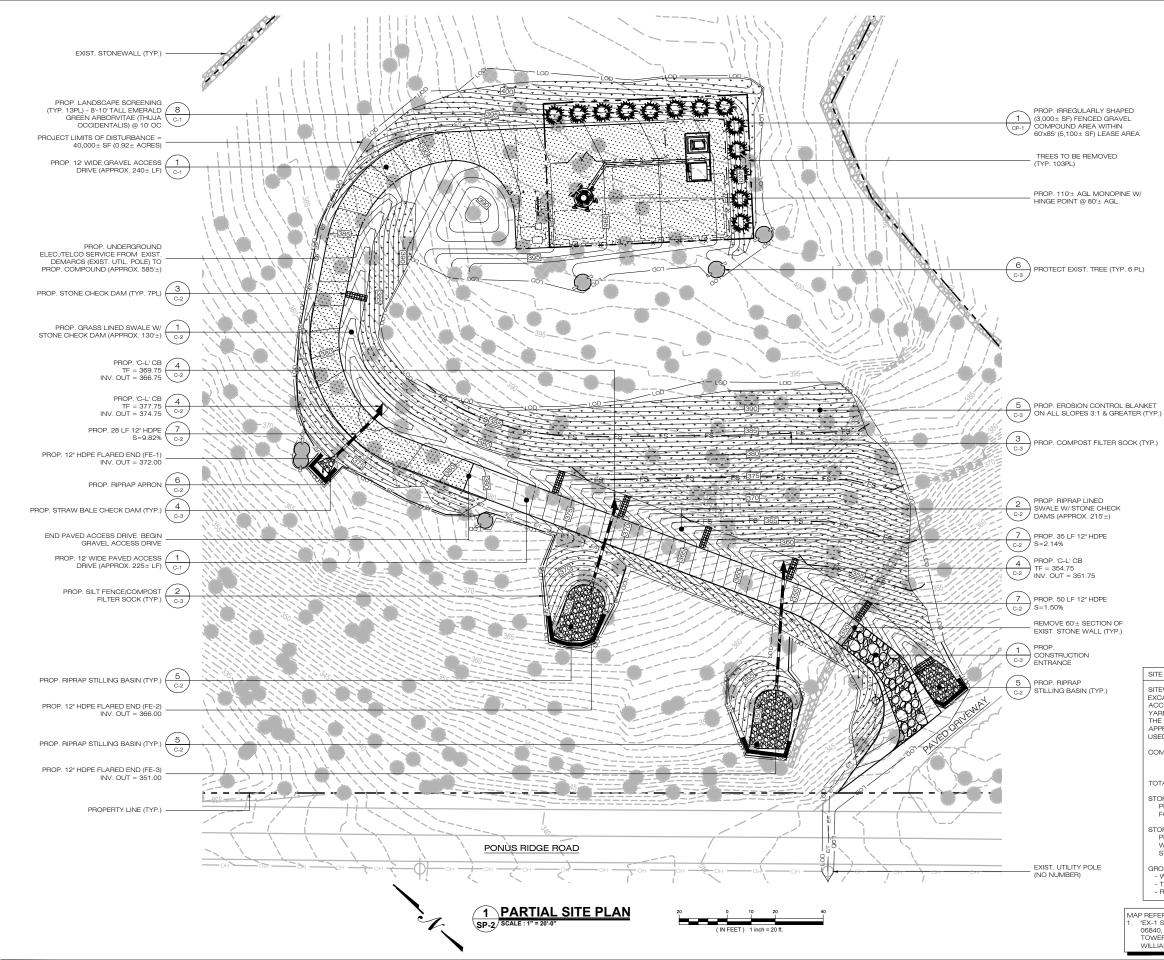


### LEGEND PROPERTY LINE HOMELAND TOWERS, LLC EXIST. WETLAND 9 HARMONY STREET 2nd FLOOR 100' WETLAND SETBACK DANBURY, CT 06810 (203) 297-6345 LIMIT OF DISTUBBANCE PROP. CHAIN LINK FENCE at&t PROP. ELEC./TELCO LINE PROP. FILTER SOCK PROP. FILTER SOCK 340 MOUNT KEMBLE AVENUE MORRISTOWN, NEW JERSEY 0796 PROP. HAYBALE CHECK DAM EXIST. TREE TO REMAIN $\boldsymbol{X}$ ALL-POINTS EXIST. TREE TO BE REMOVED TECHNOLOGY CORPORATION 7 VAUXHALL STREET EXTENSION - SUITE 31 WATERFORD, CT 06385 PH: (860)-663-16 WWW.ALLPOINTSTECH.COM FAX: (860)-663-09 Ð EXIST TREE TO BE PROTECTED PERMITTING DOCUMENTS EROSION CONTROL BLANKET \* \* \* \* NO DATE REVISION 0 12/07/21 FOR REVIEW: RCE 12/10/21 FOR REVIEW: RCB PROP. EMERALD GREEN 2 03/29/22 FOR REVIEW: RCB ARBORVITAE 3 04/04/22 CLIENT REVISIONS: RCE STONE CHECK DAM 5 DESIGN PROFESSIONALS OF RECORD PROF' ROBERT C BURNS P.E. COMP: ALL-POINTS TECHNOLOGY CORPORATION, P.C. ADD: 567 VAUXHAUL STREET EXTENSION - SUITE311 WATERFORD, CT 06385 DEVELOPER: HOMELAND TOWERS, LLC ADDRESS: 9 HARMONY STREET 2ND FLOOR DANBURY, CT 06810 NOTE: 103 TREES WILL NEED TO BE REMOVED IN CONSTRUCTION OF THE FACILITY 6"-10" DIA. 10"-14" DIA. >14" DIA. 28 TREES 36 TREES 39 TREES HOMELAND TOWERS NEW CANAAN NORTHWEST SITE AREAS & VOLUMES OF EARTHWORK SITE 1837 PONUS RIDGE ROAD ADDRESS: NEW CANAAN, CT 06840 SITEWORK ENTAILS APPROXIMATELY 5.170 CUBIC YARDS OF SITEWORK ENTAILS APPROXIMATELY 5,170 CUBIC YARDS OF EXCAVATION AND 65 CUBIC YARDS OF FILL. ACCESS DRIVEWAY WILL IMPORT APPROXIMATELY 250 CUBIC YARDS OF CLEAN BROKEN STONE. THE UTILITY TRENCH FROM THE DEMARC TO THE COMPOUND WILL EXCAVATE APPROXIMATELY 340 CUBIC YARDS OF MATERIAL THAT WILL BE UPED TO ROUGHLY IN TATENDA APT FILING NUMBER: CT283860 DATE: 12/07/21 DRAWN BY: CSH CHECKED BY: RCB USED TO BACKFILL THE TRENCH. COMPOUND AREA SLOPES EXISTING -6%-15% PROPOSED - 3%-5% TOTAL AREA OF DISTURBANCE = 40,000± SF STORMWATER VELOCITY: PRIOR TO GROUND COVER < 3.0 FT/SEC FOLLOWING GROUND COVER < 3.0 FT/SEC SHEET TITLE: STORMWATER VOLUME: TOHIWWATEH VOLUME: PROPOSED IMPERVIOUS AREA = 4,880 SF WATER QUALITY STD VOLUME (1\*) = 407 CF STORAGE VOLUME (6\* DEPTH, 40% VOIDS) = 600 CF PARTIAL SITE PLAN GROUND COVER TO BE ESTABLISHED AS FOLLOWS (U.O.N):

SHEET NUMBER:


SP-2

- WHITE CLOVER @ 0.20#/- SF TALL FESCUE @ 0.45#/- SF RYEGRASS @ 0.10#/- SF

MAP REFERENCES: 1. "EX-1 SITE SURVEY, 1837 PONUS RIDGE ROAD, NEW CANAAN, CT 06840, FAIRFIELD COUNTY', 1 OF 1; PREPARED BY NORTHEAST TOWER SURVEYING, INC., 140 WEST MAPLEMERE ROAD, WILLIAMSVILLE. NEW YORK 14221, LATEST REVISION DATED: 11/30/2

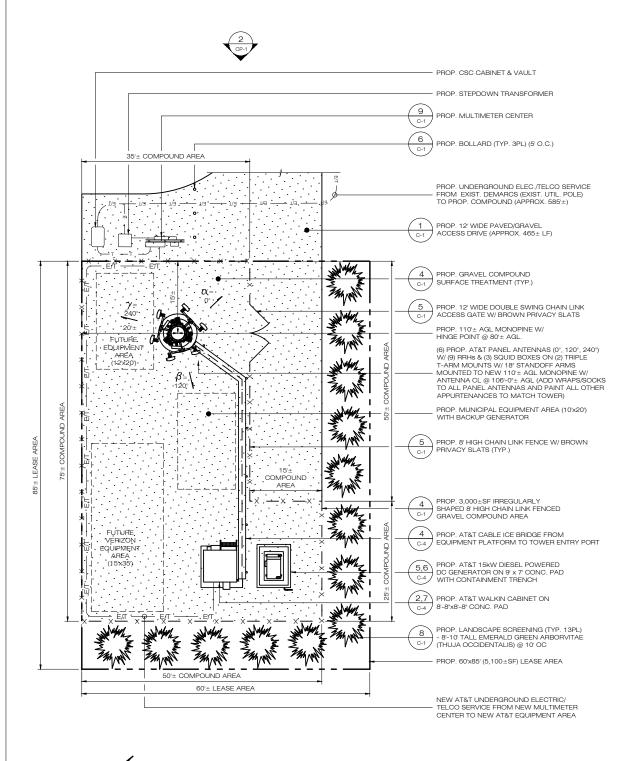



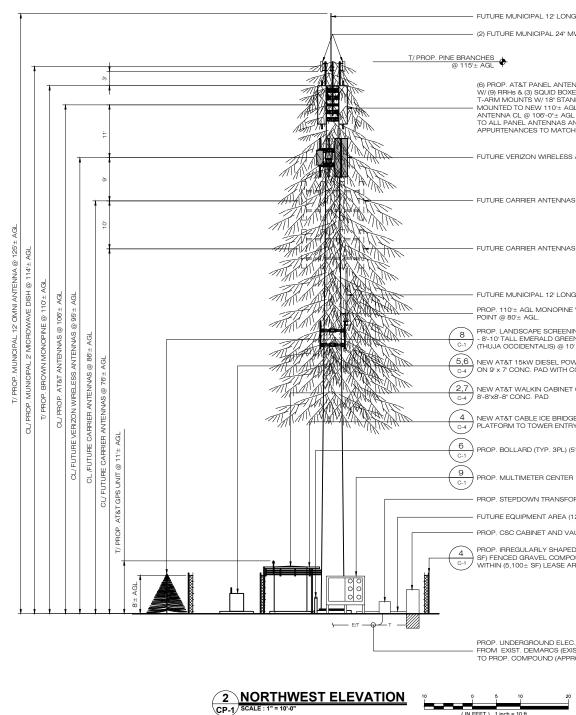

FUTURE MUNICIPAL 12' LONG OMNI ANTENNA

- (2) FUTURE MUNICIPAL 24" MW DISH

(6) PROP. AT&T PANEL ANTENNAS (0°, 120°, 240°) W/ (9) RRHs & (3) SQUID BOXES ON (2) TRIPLE T-ARM MOUNTS W/ 18" STANDOFF ARMS I -ARM MUONTS W 16 STANDOFF ARMS MOUNTED TO NEW 110°± AGL MONOPINE W/ ANTENNA CL @ 106-0°± AGL (ADD WRAPS/SOCKS TO ALL PANEL ANTENNAS AND PAINT ALL OTHER APPURTENANCES TO MATCH TOWER)

- FUTURE VERIZON WIRELESS ANTENNAS (TYP.)

- FUTURE CARRIER ANTENNAS (TYP.)

- FUTURE CARRIER ANTENNAS (TYP.)

FUTURE MUNICIPAL 12' LONG OMNI ANTENNA

PROP. 110'± AGL MONOPINE W/ HINGE POINT @ 80'± AGL.

8 PROP. LANDSCAPE SCREENING (TYP. 13PL) - 8'-10' TALL EMERALD GREEN ARBORVITAE (THUJA OCCIDENTALIS) @ 10' OC

5,6C-4 NEW AT&T 15kW DIESEL POWERED DC GENERATOR ON 9' x 7' CONC. PAD WITH CONTAINMENT TRENCH

2,7 C-4 NEW AT&T WALKIN CABINET ON 8-8"x8"-8" CONC. PAD

4 NEW AT&T CABLE ICE BRIDGE FROM EQUIPMENT C-4 PLATFORM TO TOWER ENTRY PORT

PROP. BOLLARD (TYP. 3PL) (5' O.C.)

PROP. STEPDOWN TRANSFORMER


FUTURE EQUIPMENT AREA (12'x20')


- PROP. CSC CABINET AND VAULT

4 C-1 BROP. IRREGULARLY SHAPED (3,000± SF) FENCED GRAVEL COMPOUND AREA WITHIN (5,100± SF) LEASE AREA

PROP. UNDERGROUND ELEC./TELCO SERVICE FROM EXIST. DEMARCS (EXIST. UTIL. POLE) TO PROP. COMPOUND (APPROX. 585'±)

HOMELAND TOWERS, LLC			
9 HARMONY STREET 2nd FLOOR			
DANBURY, CT 06810 (203) 297-6345			
😂 at&t			
340 MOUNT KEMBLE AVENUE MORRISTOWN, NEW JERSEY 07960			
ALL-POINTS			
TECHNOLOGY CORPORATION			
567 VAUXHALL STREET EXTENSION - SUITE 311 WATERFORD, CT 06385 PH: (860)-663-1697 WWW.ALLPOINTSTECH.COM FAX: (860)-663-0935			
PERMITTING DOCUMENTS			
NO DATE REVISION			
0         12/07/21         FOR REVIEW: RCB           1         12/10/21         FOR REVIEW: RCB			
2 03/29/22 FOR REVIEW: RCB 3 04/04/22 CLIENT REVISIONS: RCB			
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7 8			
DESIGN PROFESSIONALS OF RECORD			
PROF: ROBERT C. BURNS P.E. COMP: ALL-POINTS TECHNOLOGY			
CORPORATION, P.C.			
ADD: 567 VAUXHAUL STREET EXTENSION - SUITE311			
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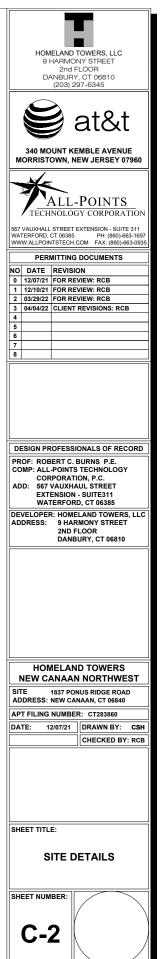


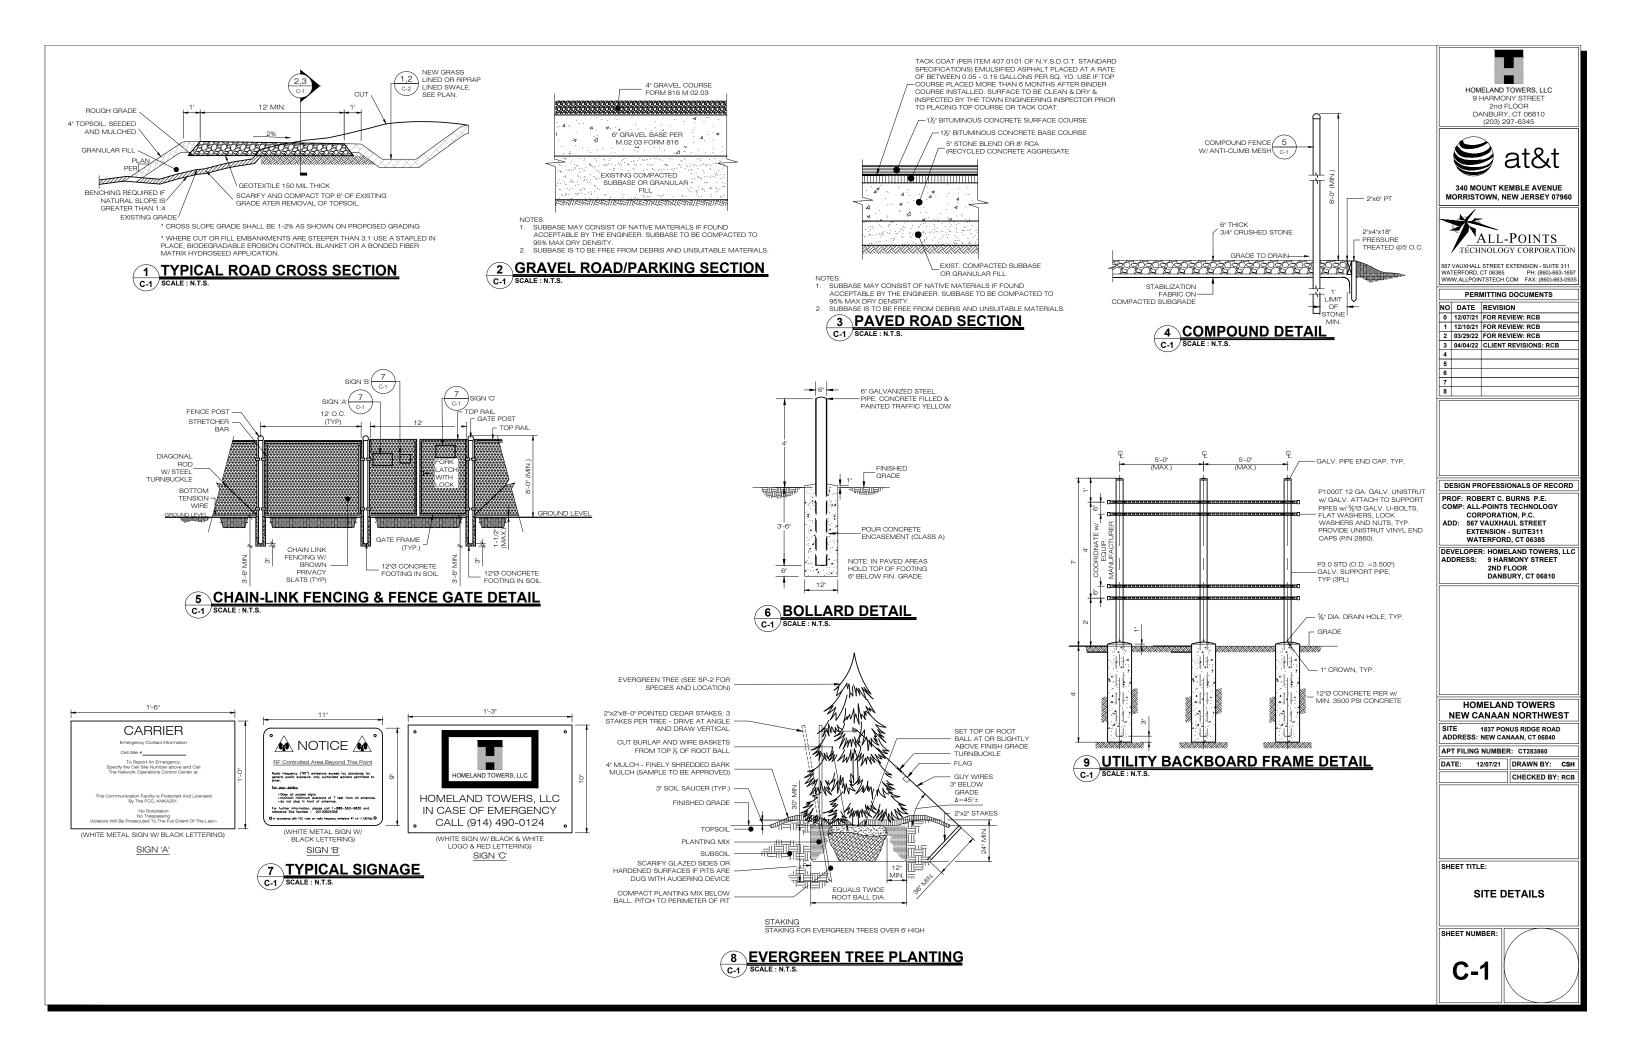


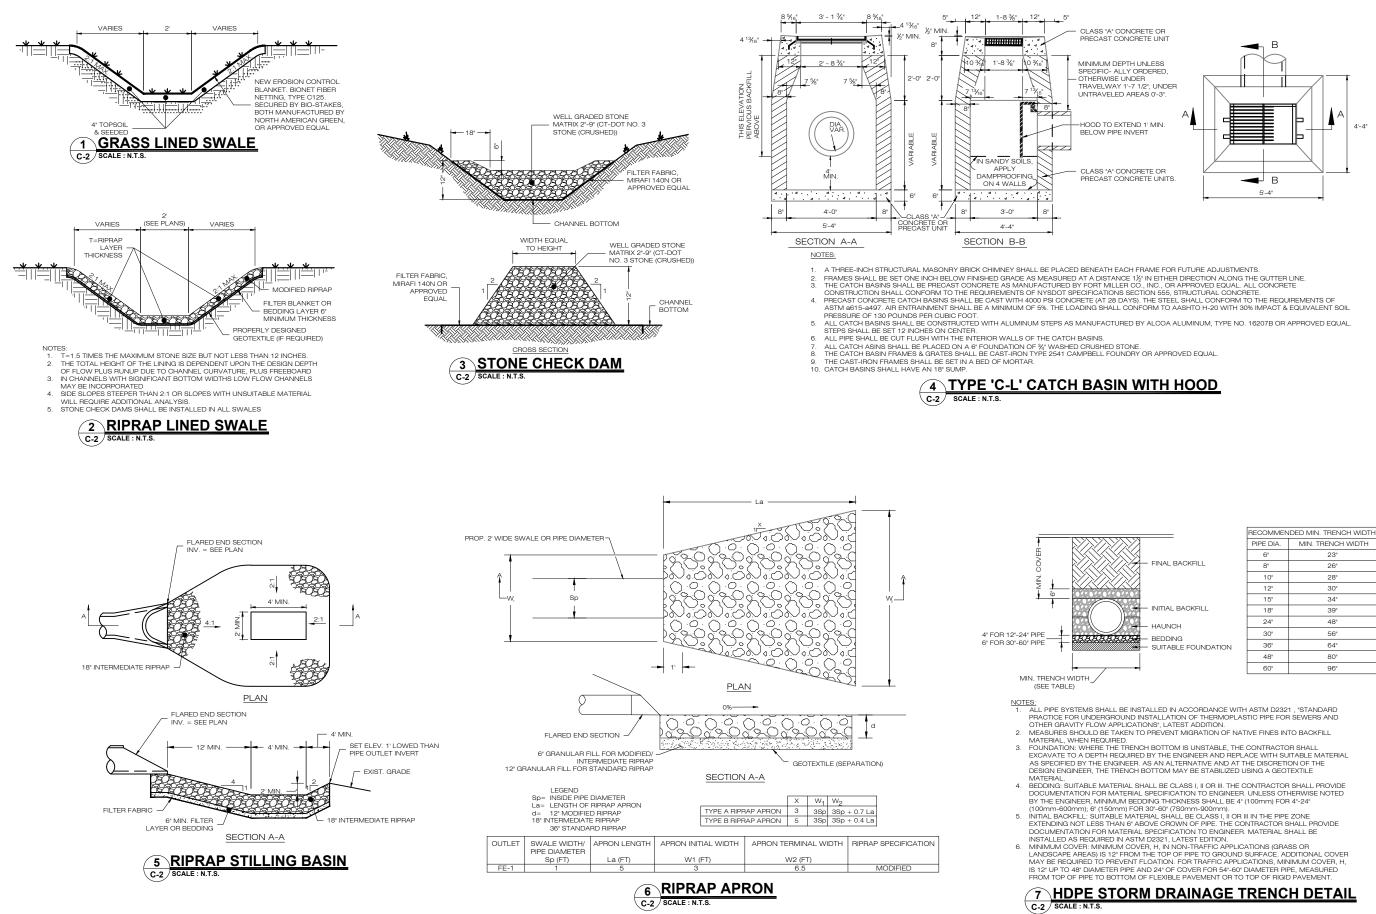	PIPE DIA.	MIN. TRENCH WIDTH
	6"	23"
	8"	26"
	10"	28"
	12"	30"
	15"	34"
	18"	39"
	24"	48"
	30"	56"
V	36"	64"
	48"	80"
	60"	96"

RECOMMEN	IDED MIN. TRENCH WIDTH
PIPE DIA.	MIN. TRENCH WIDTH
6"	23"
8"	26"
10"	28"
12"	30"
15"	34"
18"	39"
24"	48"
30"	56"
0.01	0.47

ТΗ	HOOD




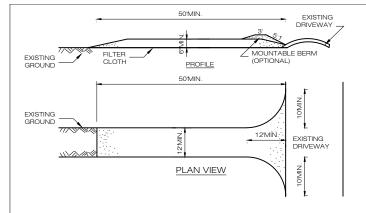


CONSTRUCTION SPECIFICATIONS: 1. STONE SIZE - USE 1-4 INCH STONE, OR RECLAIMED OR RECYCLED CONCRETE EQUIVALENT.

- 2. LENGTH NOT LESS THAN 50 FEET (EXCEPT ON A SINGLE RESIDENCE LOT WHERE A 30 FOOT MINIMUM LENGTH WOULD APPLY).
- 3. THICKNESS NOT LESS THAN SIX (6) INCHES.
- 4. WIDTH TWELVE (12) FOOT MINIMUM. BUT NOT LESS THAN THE FULL WIDTH AT POINTS WHERE INGRESS OR EGRESS OCCURS. TWENTY-FOUR (24) FOOT IF SINGLE ENTRANCE TO SITE.
- 5. GEOTEXTILE WILL BE PLACED OVER THE ENTIRE AREA PRIOR TO PLACING OF STONE
- 6. SURFACE WATER ALL SURFACE WATER FLOWING OR DIVERTED TOWARD CONSTRUCTION ACCESS SHALL BE PIPED BENEATH THE ENTRANCE. IF PIPING IS IMPRACTICAL, A MOUNTABLE BERM WITH 5.1 SLOPES WILL BE PERMITTED.
- 7. MAINTENANCE THE ENTRANCE SHALL BE MAINTAINED IN A CONDITION WHICH WILL PREVENT TRACKING OR FLOWING OF SEDIMENT ONTO PUBLIC RIGHTS-OF-WAY, ALL SEDIMENT SPILLED, DROPPED, WASHED OR TRACKED ONTO PUBLIC RIGHTS-OF-WAY MUST BE REMOVED IMMEDIATELY.
- WHEN WASHING IS REQUIRED, IT SHALL BE DONE ON A AREA STABILIZED WITH STONE AND WHICH DRAINS INTO AN APPROVED SEDIMENT TRAPPING DEVICE.
- 9. PERIODIC INSPECTION AND NEEDED MAINTENANCE SHALL BE PROVIDED AFTER EACH RAIN.



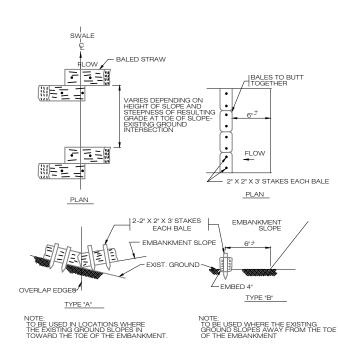

## STRAW BALE CHECK DAM <u>A SEDIMENTATION CONTROL BARRIER</u> C-3 SCALE : N.T.S.

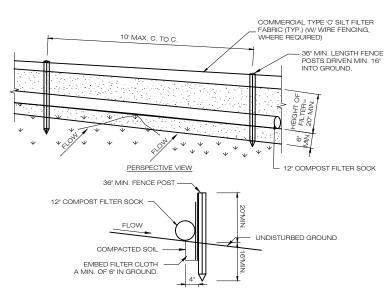

SECTION VIEW

CONSTRUCTION SPECIFICATIONS 1. POSTS SHALL BE STEEL EITHER "T" OR "U" TYPE OR HARDWOOD.


- 2. WHEN TWO SECTIONS OF FILTER CLOTH ADJOIN EACH OTHER THEY SHALL BE OVERLAPPED BY SIX INCHES AND FOLDED. FILTER CLOTH SHALL BE EITHER FILTER X, MIRAFI 100X, STABILINKA T140N, OR APPROVED EQUIVALENT
- 3. PREFABRICATED UNITS SHALL BE GEOFAB, ENVIROFENCE, OR APPROVED EQUIVALENT.
- 4. MAINTENANCE SHALL BE PERFORMED AS NEEDED AND MATERIAL REMOVED WHEN "BULGES" DEVELOP IN THE SILT FENCE.
- GEOTEXTILE SILT FENCE/FILTER SOCK DETAIL **~2**~ C-3 SCALE : N.T.S.

SEQUENCE OF CONSTRUCTION 1. PREPARE SOIL BEFORE INSTALLING ROLLED EROSION CONTROL PRODUCTS (RECPS), INCLUDING ANY NECESSARY


- APPLICATION OF LIME. FERTILIZER. AND SEED.
- APPLICATION OF LIME, FERTILIZER, AND SEED. 2. BEGIN AT THE TOP OF THE SLOPE BY ANCHORING THE REOPS IN A 6" DEEP X 6" WIDE TRENCH WITH APPROXIMATELY 12" OF REOPS EXTENDED BEYOND THE UP-SLOPE PORTION OF THE TRENCH. ANCHOR THE REOPS WITH A ROW OF STAPLES/STAKES APPROXIMATELY 12" APART IN THE BOTTOM OF THE TRENCH. BACKFILL AND COMPACT THE TRENCH AFTER STAPLING. APPLY SEED TO THE COMPACTED SOIL AND FOLD THE RENCH. BACKFILL 12" PORTION OF REOPS BACK OVER THE SEED AND COMPACTED SOIL. SECURE REOPS OVER COMPACTED SOIL WITH A ROW OF STAPLES/STAKES SPACED APPROXIMATELY 12 "APART ACROSS THE WIDTH OF THE REPS. 3. ROLL THE REOPS DOWN HORIZONTALLY ACROSS THE SLOPE. REOPS WILL UNROLL WITH APPROPRIATE SIDE AGAINST THE SOIL SURFACE. ALL REOPS MUST BE SECURELY FASTENED TO SOIL SURFACE BY PLACING STAPLES/STAKES IN APPROPRIATE LOCATIONS AS SHOWN IN THE STAPLE PATTENG GUIDE. 4. THE EDGES OF PARALLEL REOPS MUST BE STAPLED WITH APPROXIMATELY 2" 5" OVERLAP DEPENDING ON THE RECOPS TYPE.
- RECPS TYPE.
- CONSECUTIVE RECPS SPLICED DOWN THE SLOPE MUST BE END OVER END (SHINGLE STYLE) WITH AN APPROXIMATE 3" OVERLAP. STAPLE THROUGH OVERLAPPED AREA, APPROXIMATELY 12" APART ACROSS ENTIRE RECPS WIDTH

NOTES: 1. PROVIDE ANCHOR TRENCH AT TOE OF SLOPE IN SIMILAR FASHION AS AT TOP OF SLOPE. 2. SLOPE SURFACE SHALL BE FREE OF ROCKS, CLODS, STICKS, AND GRASS.

- 3 BLANKET SHALL HAVE GOOD CONTINUOUS CONTACT WITH UNDERLYING SOIL THROUGHOUT ENTIRE LENGTH LAY BLANKET LOOSELY AND STAKE OR STAPLE TO MAINTAIN DIRECT CONTACT WITH SOIL. DO NOT STRETCH
- BLANKET LOOSELY AND STARL OF STARLE TO MAKE THE MANUFACTURERS RECOMMENDATIONS BLANKET. 4. THE BLANKET SHALL BE STAPLED IN ACCORDANCE WITH THE WANUFACTURERS RECOMMENDATIONS 5. BLANKETED AREAS SHALL BE INSPECTED WEEKLY AND AFTER EACH RUNOFF EVENT UNTIL PERENNIAL VEGETATION IS ESTABLISHED TO A MINIMUM UNIFORM 70% COVERAGE THROUGHOUT THE BLANKETED AREA. DAMAGED OR DISPLACED BLANKETS SHALL BE RESTORED OR REPLACED WITHIN 4 CALENDAR DAYS.

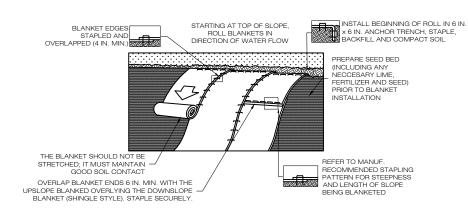


5 EROSION CONTROL BLANKET STEEP SLOPES C-3 SCALE : N.T.S.

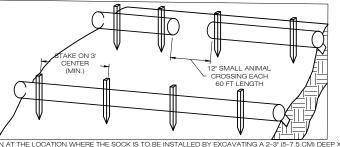


1. BEGIN AT THE LOCATION WHERE THE SOCK IS TO BE INSTALLED BY EXCAVATING A 2-3" (5-7.5 CM) DEEP X 9" (22.9 CM) WIDE THENCH ALONG THE CONTOUR OF THE SLOPE. EXCAVATED SOIL SHOULD BE PLACED UP SLOP FROM THE ANCHOR TRENCH.

EXCAVATED TRENCH AGAINST THE SOCK ON THE UPHILL SIDE. SOCKS SHALL BE INSTALLED IN 60 FT EXCAVATED THENCH AGAINST THE SOCK ON THE UPHILL SIDE. SOCKS SHALL BE INSTALLED IN 60 FT CONTINUOUS LENGTHS WITH ADJACENT SOCKS TIGHTLY ABUT. EVERY 60 FT THE SOCK ROW SHALL BE SPACED 12 INCHES CLEAR, END TO END, FOR AMPHIBIAN AND REPTILE TRAVEL. THE OPEN SPACES SHALL BE STAGGERED MID LENGTH OF THE NEXT DOWN GRADIENT SOCK. 3. SECURE THE SOCK WITH 18-24" (45.7-61 CM) STAKES EVERY 3-4" (0.9 -1.2 M) AND WITH A STAKE ON EACH END, STAKES SHOULD BE DRIVEN THROUGH THE MIDDLE OF THE SOCK LEAVING AT LEAST 2-3" (5-7.5 CM) OF TAXES DRIVEN THE SOCK OF CONCOUNT OF THE OPEN DRIVEN THROUGH THE MIDDLE OF THE SOCK LEAVING AT LEAST 2-3" (5-7.5 CM) OF STAKE EXTENDING ABOVE THE SOCK. STAKES SHOULD BE DRIVEN PERPENDICULAR TO THE SLOPE FACE.



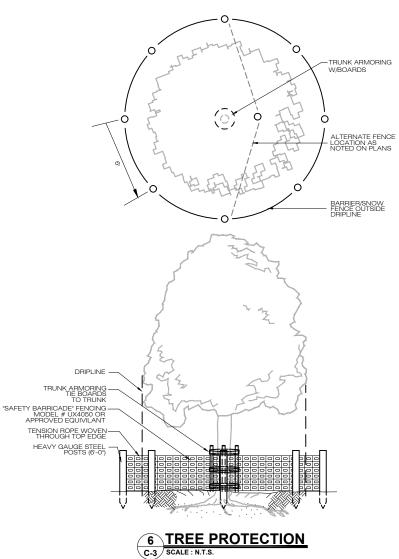

HOMELAND TOWERS, LLC 9 HARMONY STREET 2nd FLOOR			
D4	NBUR) (203) 2	/, CT 06810 97-6345	
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	,-		
567 VAUXHALL WATERFORD,	NOLOO STREET CT 06385	PH: (86	RATION UITE 311 0)-663-1697
WWW.ALLPOIN		COM FAX: (86	0)-663-0935
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PROF: ROBERT C. BURNS P.E. COMP: ALL-POINTS TECHNOLOGY CORPORATION, P.C. ADD: 567 VAUXHAUL STREET EXTENSION - SUITE311 WATERFORD, CT 06335			
DEVELOPER: HOMELAND TOWERS, LLC ADDRESS: 9 HARMONY STREET 2ND FLOOR DANBURY, CT 06810			
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EROSION CONTROL DETAILS			
SHEET NUM	BER:		$\overline{}$
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## Northeast Tower Surveying

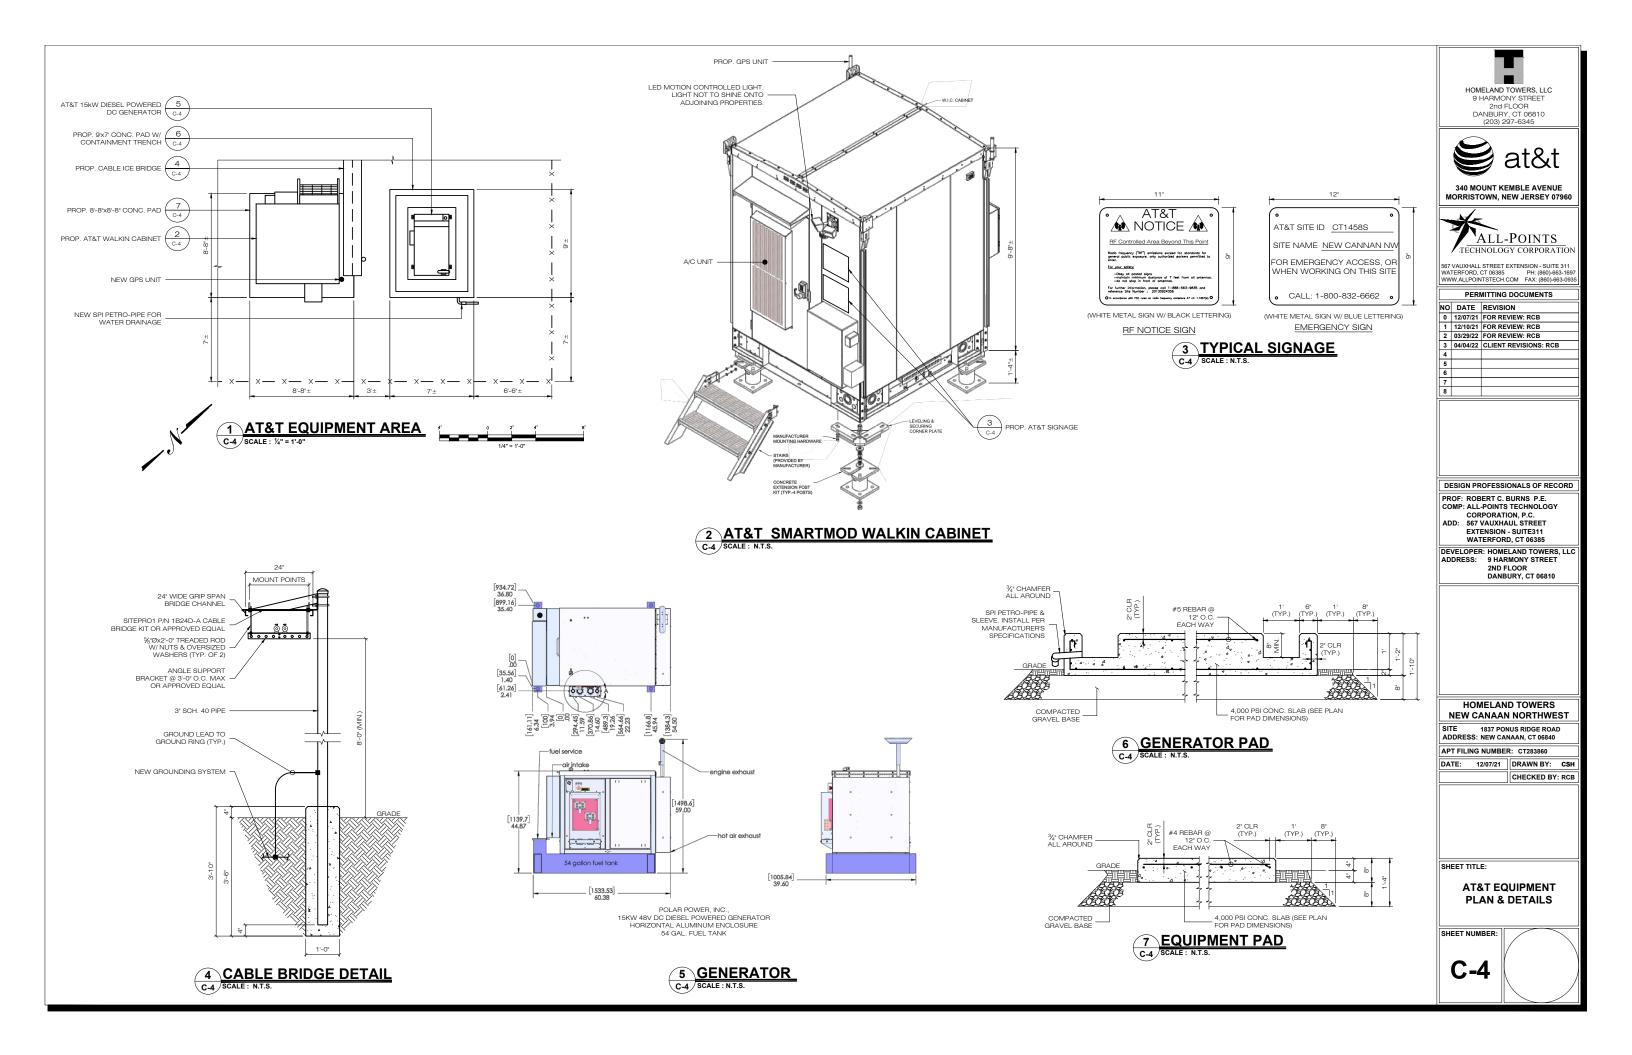140 West Maplemere Road Williamsville, New York 14221 Northeasttowersurveyingt@aol.com (716) 548-2894

## **FAA-1A SURVEY CERTIFICATION**

Applicant:	Homeland Tow	vers	
	9 Harmony Stre	eet	
	Danbury, Conn	ecticut 06810	
Site Name:	New Canaan N	orthwest	
Site ID:	CT050		
FA Number:			
Site Address:	1837 Ponus Rio	lge Road	
	New Canaan, C	Connecticut 06840	
Horizontal Da	tum Source <i>(sel</i>	lect all that apply):	
Ground Sur	vey 🛛 🖾 GPS	S Survey 🖂 NAD 83	
Vertical Datur	n Source <i>(select</i>	t all that apply):	
Ground Sur	vey 🛛 🖾 GPS	S Survey 🖾 NAVD 88	
Structure Typ	e (select one):		
New Tower	(Monopine)	Existing Tower (	) 🗌 Building
U Water Tank		Smokestack	Other (describe): ()
Latitude:			083 / 41.171914 NAD83
Longitude:		W 73°-32'-36.90" NA	D83 / -73.543583 NAD83
Ground Eleva	tion:	394.00 feet AMSL NA	VD88
Structure Heig	ght:	504.00 feet AMSL	110.00 feet AGL (Proposed Top of Structure)
<b>Overall Max.</b>	Height (with Ap	purtenances):	
	<u> </u>	519.00 feet AMSL	125.00 feet AGL (Proposed Omni Antenna)

**CERTIFICATION:** I certify that the latitude and longitude are accurate to within +/- 20 feet horizontally and that the ground elevation is accurate to within +/- 3 feet vertically. The horizontal datum (coordinates) are expressed in terms of degrees, minutes, seconds and hundredths of seconds. The vertical datum (heights) are expressed in terms of feet.

Printed Name: Surveyor License No: Company: Phone: Date:

Earle C. Newman, L.S. 15616 Northeast Tower Surveying, Inc. (716) 548.2894 September 21, 2021



Northeast Tower Surveying Project No.: 21-025



Mail Processing Center Federal Aviation Administration Southwest Regional Office Obstruction Evaluation Group 10101 Hillwood Parkway Fort Worth, TX 76177

Issued Date: 12/03/2021

Christine Vergati Homeland Towers, LLC 9 Harmony Street 2nd Floor Danbury, CT 06810

## **\*\* DETERMINATION OF NO HAZARD TO AIR NAVIGATION \*\***

The Federal Aviation Administration has conducted an aeronautical study under the provisions of 49 U.S.C., Section 44718 and if applicable Title 14 of the Code of Federal Regulations, part 77, concerning:

Structure:	Pole CT050 New Canaan NW
Location:	New Canaan, CT
Latitude:	41-10-18.89N NAD 83
Longitude:	73-32-36.90W
Heights:	394 feet site elevation (SE)
	126 feet above ground level (AGL)
	520 feet above mean sea level (AMSL)

This aeronautical study revealed that the structure does not exceed obstruction standards and would not be a hazard to air navigation provided the following condition(s), if any, is(are) met:

Based on this evaluation, marking and lighting are not necessary for aviation safety. However, if marking/ lighting are accomplished on a voluntary basis, we recommend it be installed in accordance with FAA Advisory circular 70/7460-1 M.

This determination expires on 06/03/2023 unless:

- (a) the construction is started (not necessarily completed) and FAA Form 7460-2, Notice of Actual Construction or Alteration, is received by this office.
- (b) extended, revised, or terminated by the issuing office.
- (c) the construction is subject to the licensing authority of the Federal Communications Commission (FCC) and an application for a construction permit has been filed, as required by the FCC, within 6 months of the date of this determination. In such case, the determination expires on the date prescribed by the FCC for completion of construction, or the date the FCC denies the application.

NOTE: REQUEST FOR EXTENSION OF THE EFFECTIVE PERIOD OF THIS DETERMINATION MUST BE E-FILED AT LEAST 15 DAYS PRIOR TO THE EXPIRATION DATE. AFTER RE-EVALUATION OF CURRENT OPERATIONS IN THE AREA OF THE STRUCTURE TO DETERMINE THAT NO

# SIGNIFICANT AERONAUTICAL CHANGES HAVE OCCURRED, YOUR DETERMINATION MAY BE ELIGIBLE FOR ONE EXTENSION OF THE EFFECTIVE PERIOD.

This determination is based, in part, on the foregoing description which includes specific coordinates, heights, frequency(ies) and power. Any changes in coordinates, heights, and frequencies or use of greater power, except those frequencies specified in the Colo Void Clause Coalition; Antenna System Co-Location; Voluntary Best Practices, effective 21 Nov 2007, will void this determination. Any future construction or alteration, including increase to heights, power, or the addition of other transmitters, requires separate notice to the FAA. This determination includes all previously filed frequencies and power for this structure.

If construction or alteration is dismantled or destroyed, you must submit notice to the FAA within 5 days after the construction or alteration is dismantled or destroyed.

This determination does include temporary construction equipment such as cranes, derricks, etc., which may be used during actual construction of the structure. However, this equipment shall not exceed the overall heights as indicated above. Equipment which has a height greater than the studied structure requires separate notice to the FAA.

This determination concerns the effect of this structure on the safe and efficient use of navigable airspace by aircraft and does not relieve the sponsor of compliance responsibilities relating to any law, ordinance, or regulation of any Federal, State, or local government body.

A copy of this determination will be forwarded to the Federal Communications Commission (FCC) because the structure is subject to their licensing authority.

If we can be of further assistance, please contact our office at (404) 305-6582, or Stephanie.Kimmel@faa.gov. On any future correspondence concerning this matter, please refer to Aeronautical Study Number 2021-ANE-7370-OE.

Signature Control No: 500598040-503407143 Stephanie Kimmel Specialist

Attachment(s) Frequency Data Map(s)

cc: FCC

(DNE)

## Frequency Data for ASN 2021-ANE-7370-OE

LOW	HIGH	FREQUENCY		ERP
FREQUENCY	FREQUENCY	UNIT	ERP	UNIT
6	7	CUL	55	IDW
6	7 7	GHz	55	dBW
6		GHz	42	dBW
10	11.7	GHz	55	dBW
10	11.7	GHz	42	dBW
17.7	19.7	GHz	55	dBW
17.7	19.7	GHz	42	dBW
21.2	23.6	GHz	55	dBW
21.2	23.6	GHz	42	dBW
614	698	MHz	1000	W
614	698	MHz	2000	W
698	806	MHz	1000	W
806	901	MHz	500	W
806	824	MHz	500	W
824	849	MHz	500	W
851	866	MHz	500	W
869	894	MHz	500	W
896	901	MHz	500	W
901	902	MHz	7	W
929	932	MHz	3500	W
930	931	MHz	3500	W
931	932	MHz	3500	W
932	932.5	MHz	17	dBW
935	940	MHz	1000	W
940	941	MHz	3500	W
1670	1675	MHz	500	W
1710	1755	MHz	500	W
1850	1910	MHz	1640	W
1850	1990	MHz	1640	W
1930	1990	MHz	1640	W
1990	2025	MHz	500	W
2110	2200	MHz	500	W
2305	2360	MHz	2000	W
2305	2310	MHz	2000	W
2345	2360	MHz	2000	W
2496	2690	MHz	500	W

