



**SITE EVALUATION REPORT**  
**North Branford CT021**

**I. LOCATION**

- A. COORDINATES: 41°-23'-44.9168" N  
72°-47'-35.0815" W
- B. GROUND ELEVATION: 277.7'± AMSL
- C. USGS MAP: USGS 7.5 quadrangle for Wallingford
- D. SITE ADDRESS: 222 Clintonville Road  
Northford, CT 06472
- E. ZONING WITHIN ¼ MILE OF SITE: Abutting areas to the north are zoned Zone R-40 – Residential 40 Zone. Areas to the south are zoned Zone R-80 – Residential 80 Zone. Areas to the west are zoned Zone R-80 – Residential 80 Zone and Zone R-40 – Residential 40 Zone. Areas to the east are zoned Zone B-3 – Local Business Zone, Zone R-40 – Residential 40 Zone and Zone B-2 – Central Business Zone.

**II. DESCRIPTION**

- A. SITE SIZE: 7.86 Ac (Vol 481 - Page 282)  
LEASE AREA/COMPOUND AREA: 4,631 SF/4,061 SF
  - B. TOWER TYPE/HEIGHT: A 110' Monopine.
  - C. SITE TOPOGRAPHY AND SURFACE: Wooded portion of residential property. Site slopes decreasingly from east to west.
  - D. SURROUNDING TERRAIN, VEGETATION, WETLANDS, OR WATER: The proposed compound is located toward the northeastern corner of a 7.86± acre residential parcel in a wooded area. There are wetlands located approximately 168' west of the proposed compound and approximately 17' east of the proposed gravel access driveway at its closest point.
-

- E. LAND USE WITHIN ¼ MILE OF SITE: Residential properties to the north, south, and west. Public School to the east.

**III. FACILITIES**

- A. POWER COMPANY: Wallingford Electric
- B. POWER PROXIMITY TO SITE: 900'±
- C. TELEPHONE COMPANY: Frontier
- D. PHONE SERVICE PROXIMITY: 900'±
- E. VEHICLE ACCESS TO SITE: Access to the proposed telecommunication facility will be along existing paved driveway (approx. 40'±) to a proposed gravel access driveway (approx. 795'±)
- F. OBSTRUCTION: N/A
- G. CLEARING AND FILL REQUIRED: Total area of disturbance is 42,000± sf.; 105 trees will need to be removed. The site improvements shall entail approximately 480 CY of cut for utility trenching and 2,450 CY of excavation and 400 CY of fill for the construction of the compound and access driveway. Approximately 380 CY of broken stone is needed for the compound and driveway construction.

**IV. LEGAL**

- A. PURCHASE [ ] LEASE [X]
- B. OWNER: GAIL & MICHAEL MONACO
- C. ADDRESS: 222 Clintonville Road, Northford, CT 06472
- D. DEED ON FILE AT: Volume 481 - Page 282



## Site Impact Statement

**Site:** North Branford CT021  
**Site Address:** 222 Clintonville Road  
Northford, CT 06472

**Access distances:**

Existing paved driveway (approx. 40'±) to a Proposed gravel access driveway (approx. 795'±)

**Distance to Nearest Wetlands**

168'+/- west of the proposed compound. At its closest point (near point where proposed driveway intersects with the existing paved driveway) 17'+/- east of the proposed gravel access driveway.

**Distance to Property Lines:**

155'+/- to the northern property boundary from the tower  
129'+/- to the eastern property boundary from the tower  
543'+/- to the southwestern property boundary from the tower  
96'+/- to the southern property boundary from the tower

114'+/- to the northern property boundary from the compound  
81'+/- to the eastern property boundary from the compound  
503'+/- to the southwestern property boundary from the compound  
51'+/- to the southern property boundary from the compound

**Residence Information:**

There are 36 single family residences within 1,000' feet of the compound. The closest off site single family residence to the compound is approximately 253 feet to the north and is located at Parcel 67D-6A (61 Pistapaug Rd.)

**Special Building Information:**

N/A

**Tree Removal Count:**

105 trees need to be removed to construct the access driveway and the compound area.

6" - 10" dbh	27 trees
10" - 14" dbh	50 trees
14" or greater dbh	28 trees

**Cut/Fill:** The site improvements shall entail approximately 480 CY of cut for utility trenching and 2,450 CY of excavation and 400 CY of fill for the construction of the compound and access driveway. Approximately 380 CY of broken stone is needed for the compound and driveway construction.

**Clearing/Grading Necessary:** Total area of disturbance = 42,000+/- SF (0.96+/- Ac)



## Tree Inventory

January 11, 2022

Robinson & Cole, LLP  
Attn: Kenneth Baldwin  
280 Trumbull Street  
Hartford, CT 06103

RE: Tree Inventory  
Site: North Branford CT021  
222 Clintonville Road  
Northford, CT 06472

Dear Mr. Baldwin:

A Tree Inventory was completed at the subject site during the month of March 2021 to determine the size and quantity of existing trees that will need to be removed for the installation of the proposed facility. The proposed site will require clearing and earthwork to construct the access driveway and to construct the compound area. Installation of the proposed compound area and access driveway will require the removal of 105 trees.

6" - 10" dbh	27 trees
10" - 14" dbh	50 trees
14" or greater dbh	28 trees

The area to be disturbed for construction of the compound area will be approximately 4,631 square feet (sf) of interior area currently wooded. A new access driveway will be installed to connect to the proposed compound. The total combined area of disturbance for compound, access drive, and utility improvements is approximately 42,000 sf.

Sincerely,

ALL-POINTS TECHNOLOGY CORPORATION, P.C.

Robert C. Burns, P.E.  
Program Manager


**ALL-POINTS TECHNOLOGY CORPORATION, P.C.**

567 VAUXHALL STREET EXTENSION - SUITE 311 · WATERFORD, CT 06385 · PHONE 860-663-1697 · FAX 860-663-0935


**Homeland Towers  
222 Clintonville Road, Northford  
1000' RESIDENTIAL BUILDING LIST**

<b>PARCEL ID</b>	<b>STREET ADDRESS</b>	<b>BUILDING TYPE</b>	<b>DISTANCE FROM COMPOUND* (ft+/-)</b>
67D-6B	41 Pistapaug Road	Single Family	450'
67D-6A	61 Pistapaug Road	Single Family	253'
67D-7-1	246 Clintonville Road	Apartments	208'
67D-7	250 Clintonville Road	Single Family	470'
67D-14-2	11 Woodhouse Avenue	Single Family	905'
67D-14-1	34 Pistapaug Road	Single Family	745'
67D-15B	38 Pistapaug Road	Single Family	680'
67D-15A	42 Pistapaug Road	Single Family	610'
67D-15A-1	46 Pistapaug Road	Single Family	800'
67D-15A-2	50 Pistapaug Road	Single Family	875'
67D-15A-3	54 Pistapaug Road	Single Family	605'
67D-15F	58 Pistapaug Road	Single Family	925'
67D-15F-1	62 Pistapaug Road	Single Family	660'
67D-15E	66 Pistapaug Road	Single Family	745'
67D-15C	68 Pistapaug Road	Single Family	970'
67D-15D	72 Pistapaug Road	Single Family	840'
67D-12	67 Pistapaug Road	Single Family	450'
67D-11	75 Pistapaug Road	Single Family	585'
67D-11A	77 Pistapaug Road	Single Family	665'
67D-10	58 Old Post Road	Single Family	730'
67D-59	61 Old Post Road	Single Family	900'
67D-60	49 Old Post Road	Single Family	750'
67D-67-5	35 Old Post Road	Single Family	640'
67D-67-4	31 Old Post Road	Single Family	635'
67D-67-1	1448 Middletown Avenue	Single Family	915'
67D-66	1444 Middletown Avenue	Single Family	870'
67D-65	1438 Middletown Avenue	Single Family	840'
67D-61	23 Old Post Road	Single Family	610'
67D-62	19 Old Post Road Rear	Single Family	595'
62A-23	2 Old Post Road	Single Family	855'
62A-24-1	295 Clintonville Road	Single Family	905'
62A-24A	291 Clintonville Road	Single Family	815'
62A-24	287 Clintonville Road	Single Family	685'
62A-25	277 Clintonville Road	Single Family	665'
67D-1	267 Clintonville Road	Single Family	645'
67-8-1	4 Old Post Road	Single Family	450'


\*Information gathered from North Branford Assessor's Maps 62A & 67D & CTECO Ortho Aerial Images

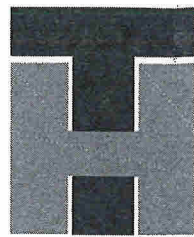

HOMELAND TOWERS, LLC  
**WIRELESS TELECOMMUNICATIONS FACILITY**  
 NORTH BRANFORD  
 222 CLINTONVILLE ROAD  
 NORTHFORD, CT 06472

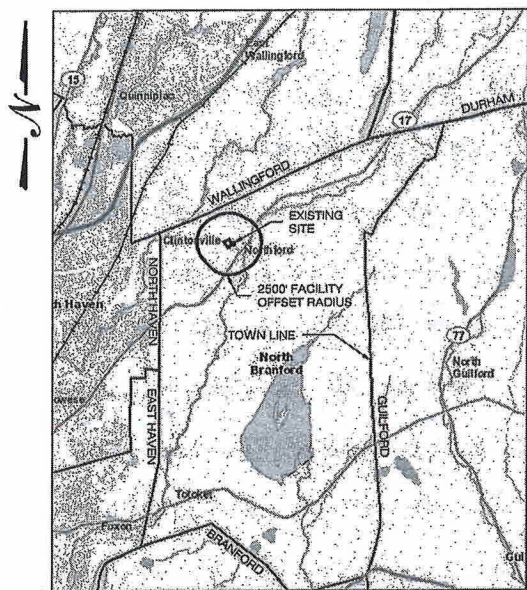

**MUNICIPAL NOTIFICATION LIMIT MAP**  
 SCALE: 1" = 1.5 Miles

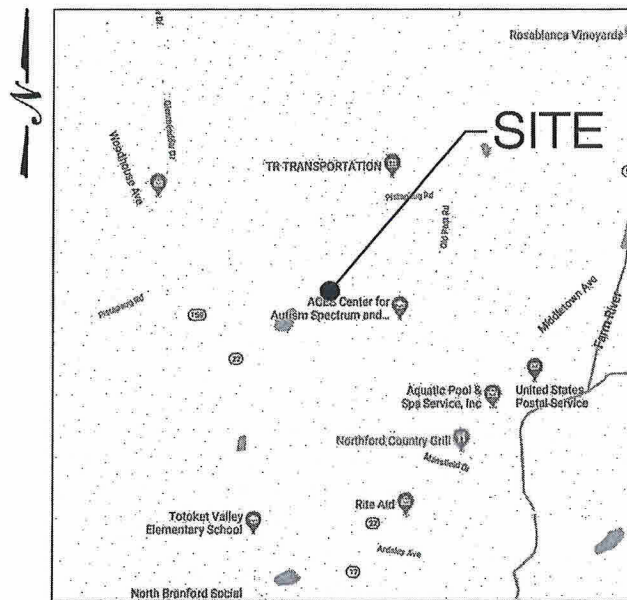

**VICINITY MAP**  
 SCALE: 1" = 500'

DRAWING INDEX

- T-1 TITLE SHEET & INDEX
- 1 OF 1 PROPERTY & TOPOGRAPHIC SURVEY
- SP-1 SITE PLAN & ABUTTERS MAP
- SP-2 PARTIAL SITE PLAN
- CP-1 COMPOUND PLAN & TOWER ELEVATION
- A-1 ALTERNATE MONOPOLE ELEVATION
- C-1 SITE DETAILS
- C-2 EROSION CONTROL & LANDSCAPING DETAILS
- C-3 VERIZON EQUIPMENT PLAN & DETAILS
- C-4 MUNICIPAL ANTENNA PLAN & DETAILS

SITE INFORMATION

PROJECT LOCATION: 222 CLINTONVILLE ROAD  
 NORTHFORD, CT 06472

PROJECT DESCRIPTION: RAWLAND SITE W/ GROUND EQUIPMENT WITHIN 4,061 ± SF TELECOMMUNICATIONS EQUIPMENT COMPOUND W/ PROP. 110 ± AGL MONOPIRE.

PROPERTY DEVELOPER: HOMELAND TOWERS, LLC  
 9 HARMONY STREET  
 2ND FLOOR  
 DANBURY, CT 06810

DEVELOPER CONTACT: RAY VERGATI  
 (203) 297-6345

ENGINEER CONTACT: ROBERT C. BURNS, P.E.  
 (860) 552-2036

LATITUDE: 41° 23' 44.9168"N  
 LONGITUDE: 72° 47' 35.0815"W  
 ELEVATION: 277.7 ± AMSL

MAP: 67D  
 LOT: 6  
 ZONE: R40

**HOMELAND TOWERS, LLC**  
 9 HARMONY STREET  
 2nd FLOOR  
 DANBURY, CT 06810  
 (203) 297-6345

Cellco Partnership d/b/a  
**verizon**  
 WIRELESS

20 ALEXANDER DRIVE  
 WALLINGFORD, CT 06492

**ALL-POINTS**  
 TECHNOLOGY CORPORATION

587 VAUXHALL STREET EXTENSION - SUITE 311  
 WATERFORD, CT 06385 PHONE: (860)-553-1897  
 WWW.ALLPOINTSTECH.COM FAX: (860)-553-0835

**PERMITTING DOCUMENTS**

NO	DATE	REVISION
0	07/23/21	FOR REVIEW: RCB
1	07/28/21	CLIENT COMMENTS: RCB
2	07/29/21	CLIENT COMMENTS: RCB
3	08/30/21	CLIENT COMMENTS: RCB
4	01/11/22	CLIENT COMMENTS: RCB
5	01/14/22	CLIENT COMMENTS: RCB
6	01/18/22	CLIENT COMMENTS: RCB

**DESIGN PROFESSIONALS OF RECORD**

PROF: ROBERT C. BURNS P.E.  
 COMP: ALL-POINTS TECHNOLOGY CORPORATION, P.C.  
 ADD: 587 VAUXHALL STREET EXT. SUITE 311 WATERFORD, CT 06385

DEVELOPER: HOMELAND TOWERS, LLC  
 ADDRESS: 9 HARMONY STREET 2ND FLOOR DANBURY, CT 06810

**HOMELAND TOWERS NORTH BRANFORD**

SITE: 222 CLINTONVILLE ROAD  
 ADDRESS: NORTHFORD, CT 06472

APT FILING NUMBER: CT283990

DATE: 07/23/21 DRAWN BY: CSH  
 CHECKED BY: RCB

SHEET TITLE:  
**TITLE SHEET & INDEX**

SHEET NUMBER:  
**T-1**

**OWNER:** GAIL & MICHAEL MONACO  
 222 CLINTONVILLE ROAD  
 NORTHFORD, CT 06472

**APPLICANTS:** HOMELAND TOWERS, LLC  
 9 HARMONY STREET  
 2ND FLOOR  
 DANBURY, CT 06810  
 RAY VERGATI  
 (203) 297-6345

CELLCO PARTNERSHIP  
 d/b/a VERIZON WIRELESS  
 20 ALEXANDER DRIVE  
 WALLINGFORD, CT 06492



**HOMELAND PROJECT ATTORNEY:** ROBINSON & COLE  
 280 TRUMBULL STREET  
 HARTFORD, CT 06103  
 (800) 826-3579

**POWER PROVIDER:** WALLINGFORD ELECTRIC: (203) 294-2020

**TELCO PROVIDER:** FRONTIER (800) 921-8102

**CALL BEFORE YOU DIG:** (800) 922-4455

**GOVERNING CODES:** CONNECTICUT STATE BUILDING CODE, LATEST EDITION  
 NATIONAL ELECTRIC CODE, LATEST EDITION  
 TIA-222-H

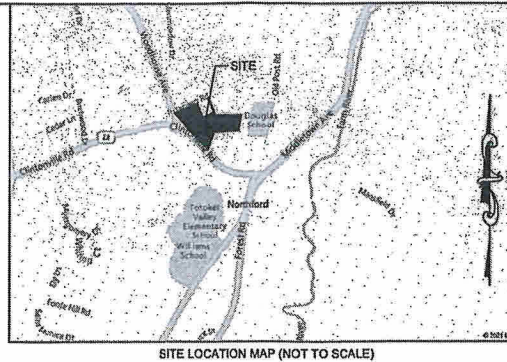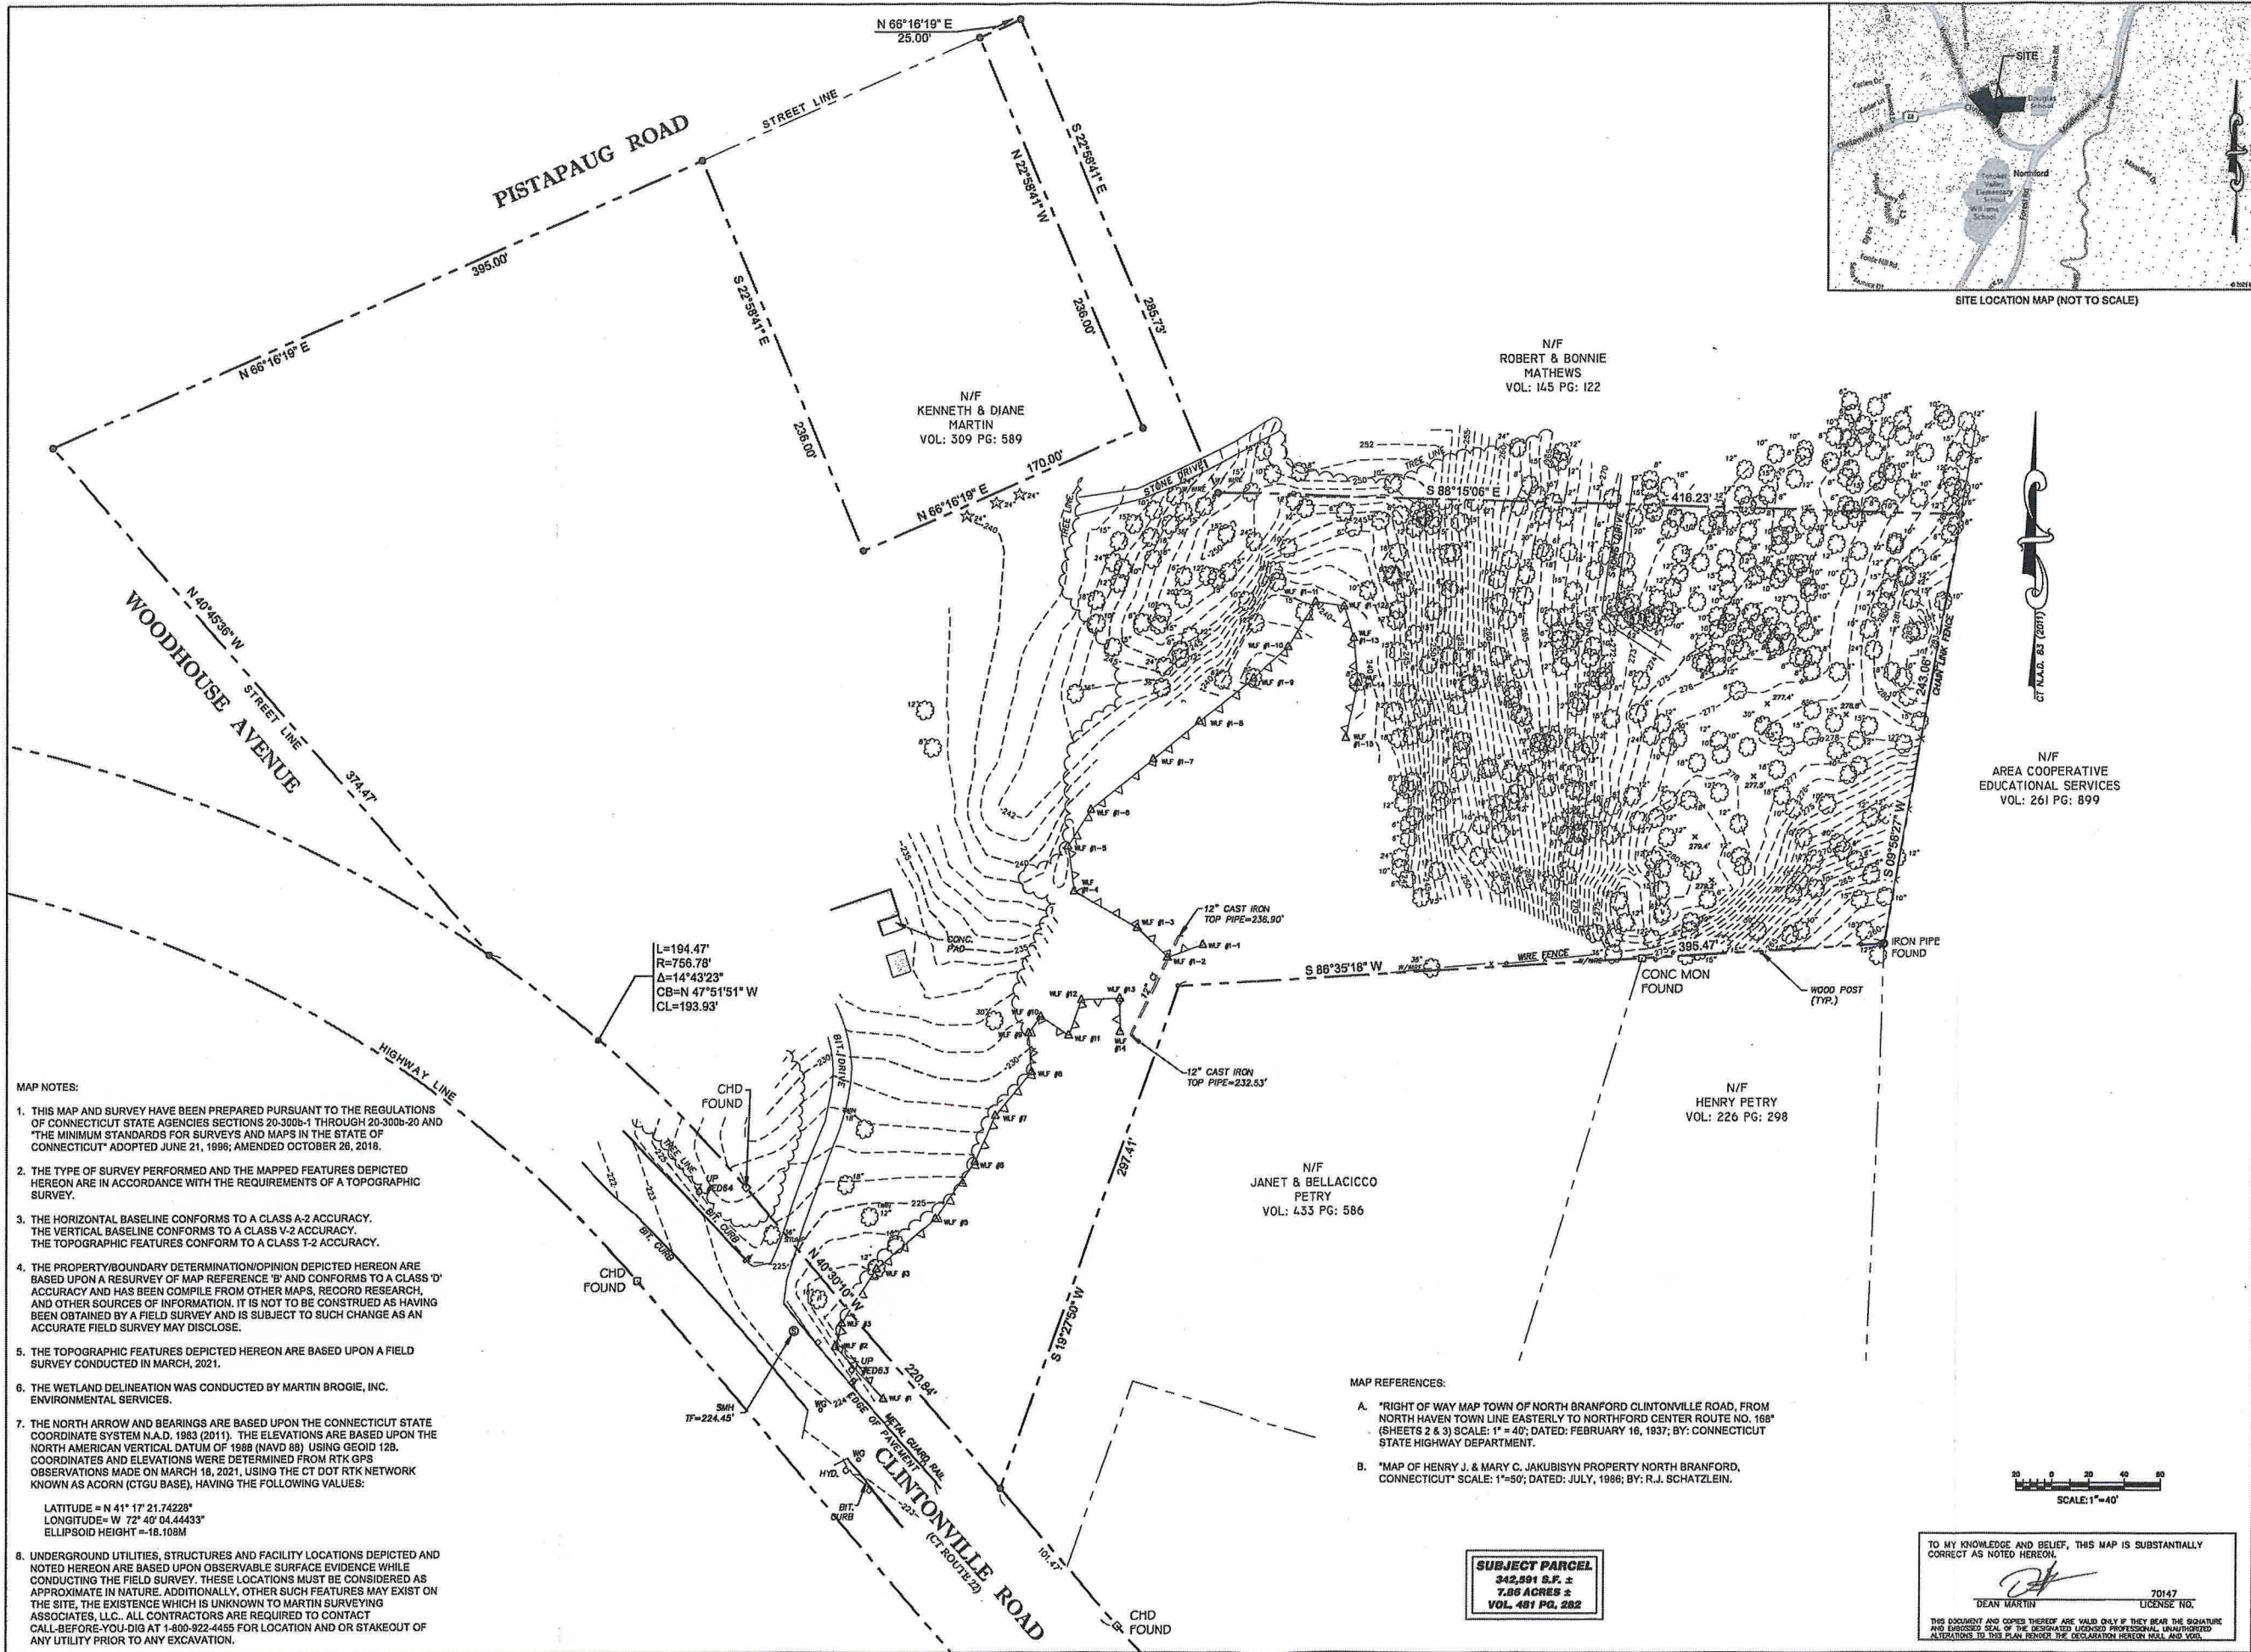

LEGEND:

● IRON PIN (FOUND)	△ SIGN
○ Rebar/Drill Hole (To Be Set)	○ POST
□ MONUMENT (FOUND)	☆ LIGHT POLE
○ MANHOLE	○ UTILITY POLE
○ DRAINAGE MANHOLE	○ WATER GATE
○ SANITARY MANHOLE	○ WATER METER
○ ELEC. MANHOLE	○ GAS VALVE
○ TELE. MANHOLE	○ GAS METER
■ "C" CATCH BASIN	□ TRANSFORMER
□ "C-L" CATCH BASIN	○ ELEC. METER
○ DECIDUOUS TREES	○ MAIL BOX
★ EVERGREEN TREES	□ HAND HOLE
○ SHRUB/BUSH	□ BUTTON BOX
○ FLAG POLE	○ A.C. UNIT
□ TRAFFIC CONTROL BOX	△ TRAFFIC LIGHT POLE

---	BOUNDARY LINE
---	GUARD RAIL
---	UNDERGROUND PIPING (San., Stm.)
G---	U/G GAS LINE
E---	U/G ELEC. LINE
W---	WATER LINE
---	OVERHEAD UTILITIES
T---	U/G TELE. LINE
---	CHAIN LINK FENCE
---	TREE LINE

**M martin**  
**Surveying Associates, LLC**  
 201 CHRISTIAN LANE BERLIN, CT 06037  
 860-832-9328 860-357-4804 (FAX)

REVISIONS:

**PROPERTY & TOPOGRAPHIC SURVEY OF LAND OF GAIL & MICHAEL MONACO**  
 222 CLINTONVILLE ROAD  
 NORTHFORD, CONNECTICUT

- MAP NOTES:
- THIS MAP AND SURVEY HAVE BEEN PREPARED PURSUANT TO THE REGULATIONS OF CONNECTICUT STATE AGENCIES SECTIONS 20-300b-1 THROUGH 20-300b-20 AND "THE MINIMUM STANDARDS FOR SURVEYS AND MAPS IN THE STATE OF CONNECTICUT" ADOPTED JUNE 21, 1996; AMENDED OCTOBER 26, 2018.
  - THE TYPE OF SURVEY PERFORMED AND THE MAPPED FEATURES DEPICTED HEREON ARE IN ACCORDANCE WITH THE REQUIREMENTS OF A TOPOGRAPHIC SURVEY.
  - THE HORIZONTAL BASELINE CONFORMS TO A CLASS A-2 ACCURACY. THE VERTICAL BASELINE CONFORMS TO A CLASS V-2 ACCURACY. THE TOPOGRAPHIC FEATURES CONFORM TO A CLASS T-2 ACCURACY.
  - THE PROPERTY/BOUNDARY DETERMINATION/OPINION DEPICTED HEREON ARE BASED UPON A RESURVEY OF MAP REFERENCE 'B' AND CONFORMS TO A CLASS 'D' ACCURACY AND HAS BEEN COMPILED FROM OTHER MAPS, RECORD RESEARCH, AND OTHER SOURCES OF INFORMATION. IT IS NOT TO BE CONSTRUED AS HAVING BEEN OBTAINED BY A FIELD SURVEY AND IS SUBJECT TO SUCH CHANGE AS AN ACCURATE FIELD SURVEY MAY DISCLOSE.
  - THE TOPOGRAPHIC FEATURES DEPICTED HEREON ARE BASED UPON A FIELD SURVEY CONDUCTED IN MARCH, 2021.
  - THE WETLAND DELINEATION WAS CONDUCTED BY MARTIN BROGIE, INC. ENVIRONMENTAL SERVICES.
  - THE NORTH ARROW AND BEARINGS ARE BASED UPON THE CONNECTICUT STATE COORDINATE SYSTEM N.A.D. 1983 (2011). THE ELEVATIONS ARE BASED UPON THE NORTH AMERICAN VERTICAL DATUM OF 1988 (NAVD 88) USING GEOID 12B. COORDINATES AND ELEVATIONS WERE DETERMINED FROM RTK GPS OBSERVATIONS MADE ON MARCH 18, 2021, USING THE CT DOT RTK NETWORK KNOWN AS ACORN (CTGU BASE), HAVING THE FOLLOWING VALUES:  
 LATITUDE = N 41° 17' 21.74228"  
 LONGITUDE = W 72° 40' 04.44433"  
 ELLIPSOID HEIGHT = -18.108M
  - UNDERGROUND UTILITIES, STRUCTURES AND FACILITY LOCATIONS DEPICTED AND NOTED HEREON ARE BASED UPON OBSERVABLE SURFACE EVIDENCE WHILE CONDUCTING THE FIELD SURVEY. THESE LOCATIONS MUST BE CONSIDERED AS APPROXIMATE IN NATURE. ADDITIONALLY, OTHER SUCH FEATURES MAY EXIST ON THE SITE, THE EXISTENCE WHICH IS UNKNOWN TO MARTIN SURVEYING ASSOCIATES, LLC. ALL CONTRACTORS ARE REQUIRED TO CONTACT CALL-BEFORE-YOU-DIG AT 1-800-922-4455 FOR LOCATION AND OR STAKEOUT OF ANY UTILITY PRIOR TO ANY EXCAVATION.

- MAP REFERENCES:
- "RIGHT OF WAY MAP TOWN OF NORTH BRANFORD CLINTONVILLE ROAD, FROM NORTH HAVEN TOWN LINE EASTERLY TO NORTHFORD CENTER ROUTE NO. 168" (SHEETS 2 & 3) SCALE: 1"=40'; DATED: FEBRUARY 16, 1937; BY: CONNECTICUT STATE HIGHWAY DEPARTMENT.
  - "MAP OF HENRY J. & MARY C. JAKUBISYN PROPERTY NORTH BRANFORD, CONNECTICUT" SCALE: 1"=50'; DATED: JULY, 1996; BY: R.J. SCHATZLEIN.

**SUBJECT PARCEL**  
 342,591 S.F. ±  
 7.86 ACRES ±  
 VOL. 461 PG. 282

TO MY KNOWLEDGE AND BELIEF, THIS MAP IS SUBSTANTIALLY CORRECT AS NOTED HEREON.

*Dean Martin*  
 DEAN MARTIN  
 No. 70147  
 LICENSE NO.

MSA PROJECT NO: 21-023


SCALE: 1"=40'

DATE: 09/23/2021

DRAWN BY: G.S.D.

CHECKED BY:

SHEET: 1 OF 1

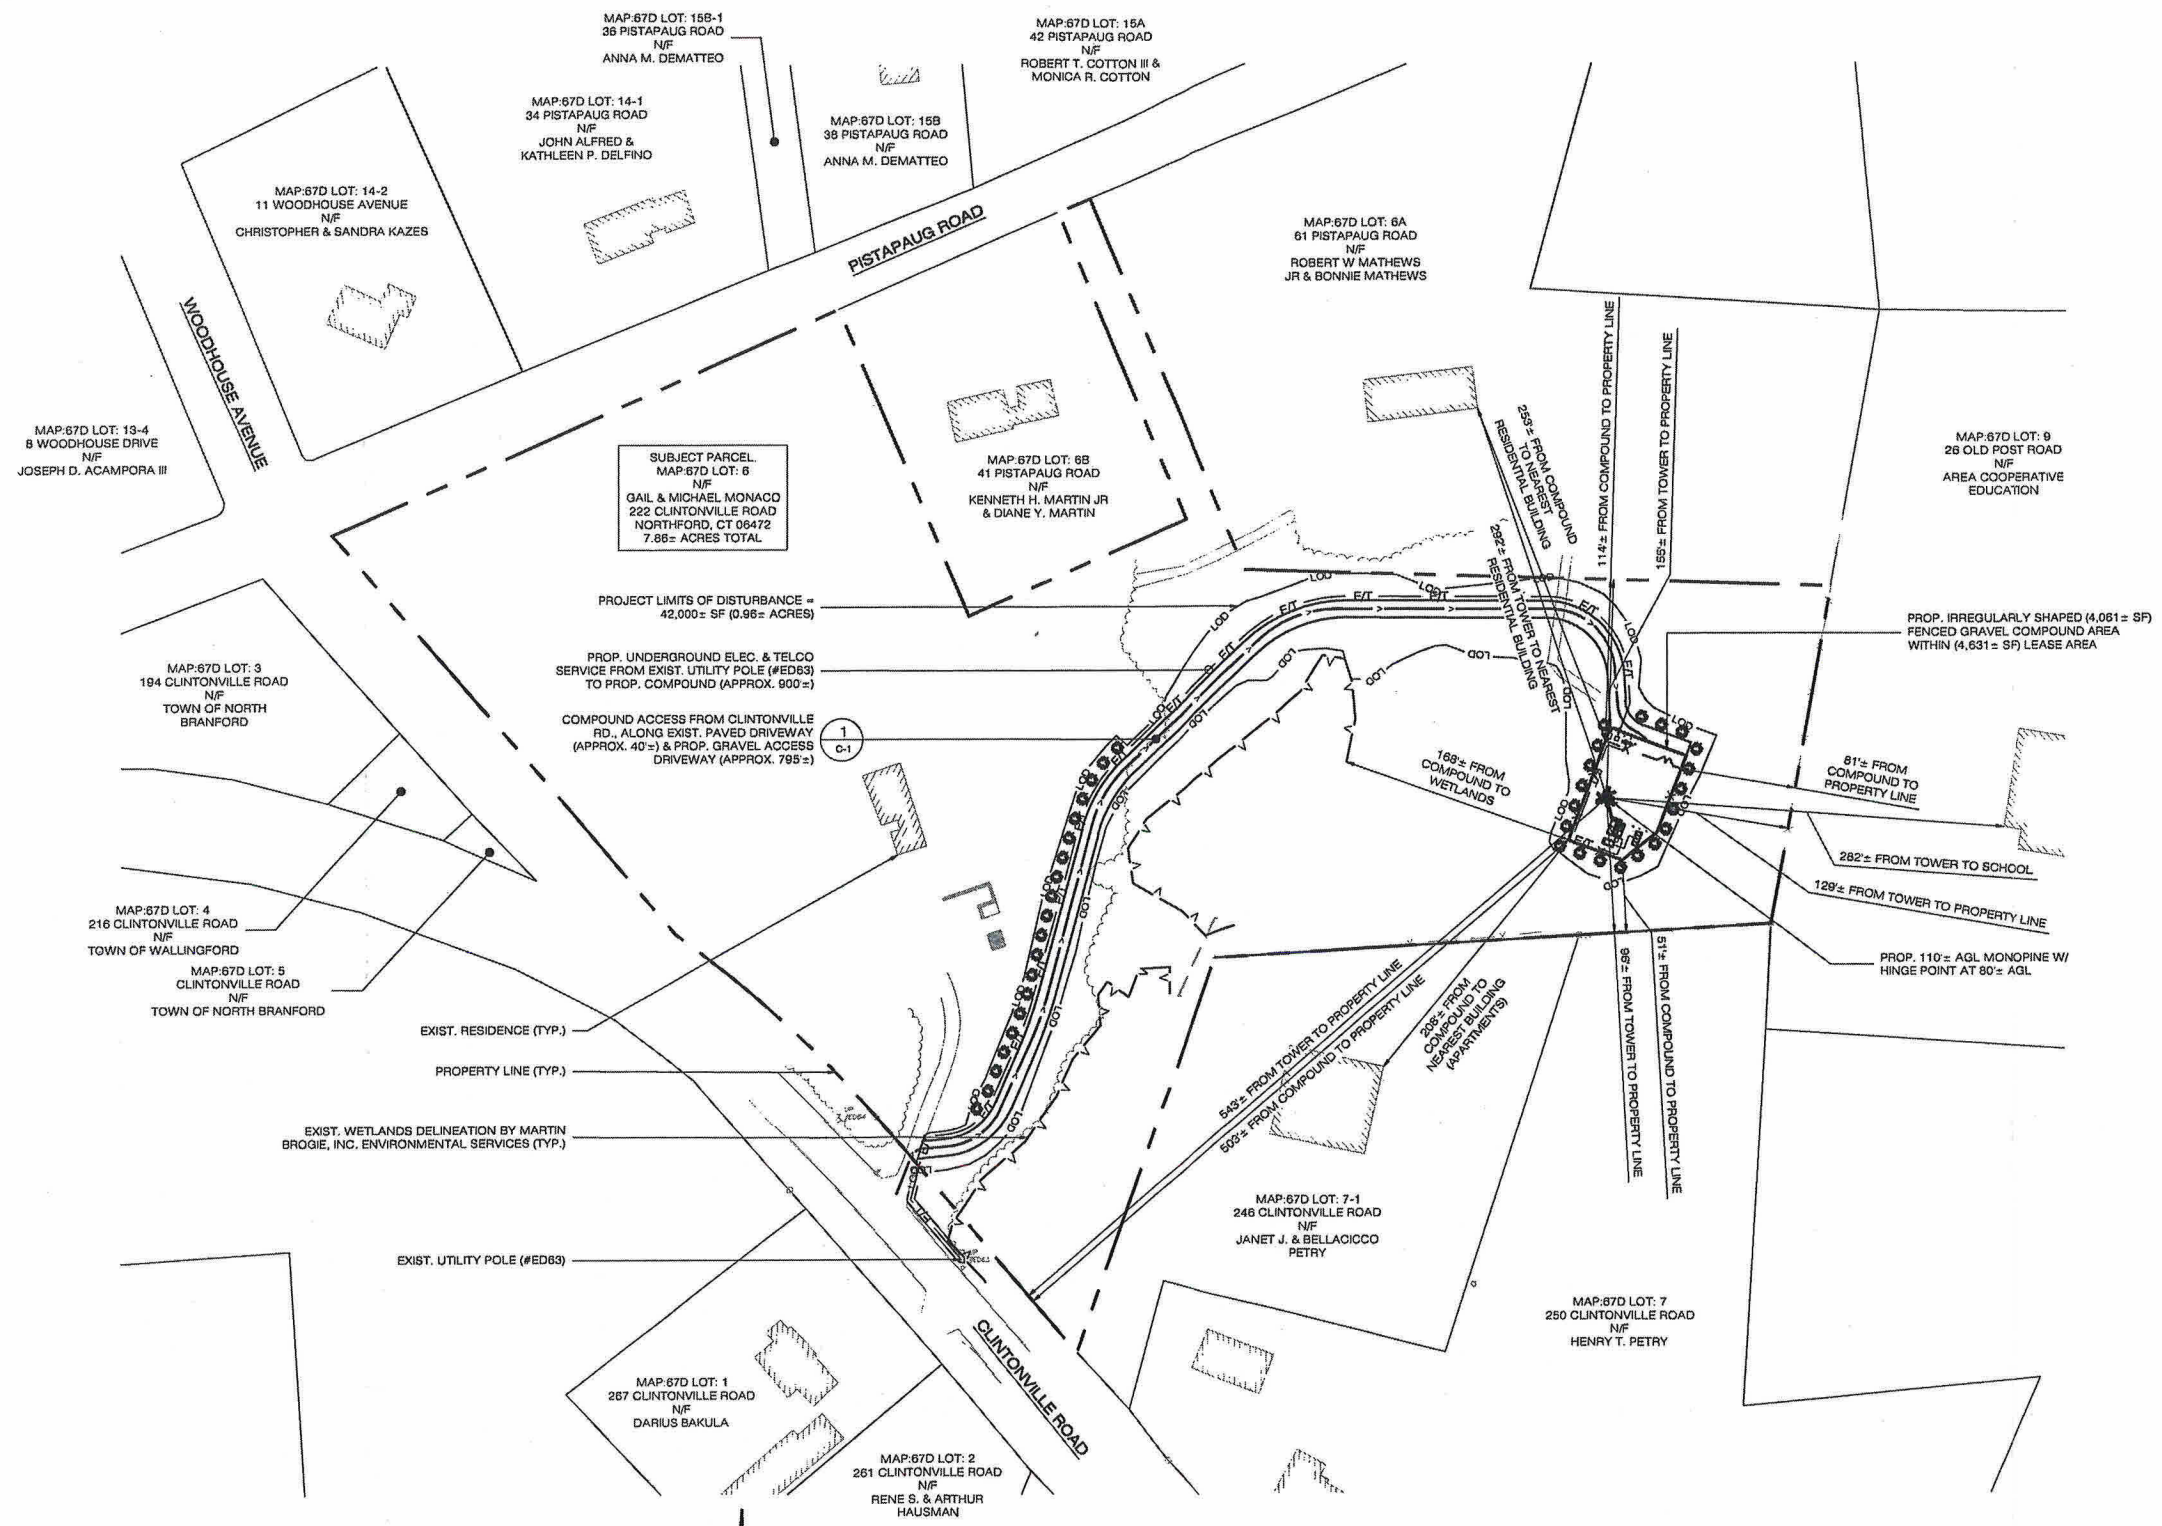


**SUBJECT PARCEL**  
 MAP-67D LOT: 6  
 N/F  
 GAIL & MICHAEL MONACO  
 222 CLINTONVILLE ROAD  
 NORTHFORD, CT 06472  
 7.86± ACRES TOTAL

PROJECT LIMITS OF DISTURBANCE =  
 42,000± SF (0.96± ACRES)

PROP. UNDERGROUND ELEC. & TELCO  
 SERVICE FROM EXIST. UTILITY POLE (#EDB3)  
 TO PROP. COMPOUND (APPROX. 900±)

COMPOUND ACCESS FROM CLINTONVILLE  
 RD., ALONG EXIST. PAVED DRIVEWAY  
 (APPROX. 40±) & PROP. GRAVEL ACCESS  
 DRIVEWAY (APPROX. 785±)

**1 SITE PLAN**  
 SP-1 SCALE: 1" = 60'-0"

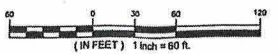

MAP REFERENCES:  
 1. PROPERTY & TOPOGRAPHIC SURVEY LAND OF GAIL & MICHAEL  
 MONACO, 222 CLINTONVILLE ROAD, NORTHFORD, CT, 1 OF 1;  
 PREPARED BY MARTIN SURVEYING ASSOCIATES, LLC, 201  
 CHRISTIAN LANE, BERLIN, CT 06037, DATED: MARCH 23, 2021.

**HOMELAND TOWERS, LLC**  
 9 HARMONY STREET  
 2ND FLOOR  
 DANBURY, CT 06810  
 (203) 297-6345

Cellco Partnership d/b/a  
**verizon**  
 WIRELESS

20 ALEXANDER DRIVE  
 WALLINGFORD, CT 06492

**ALL-POINTS**  
 TECHNOLOGY CORPORATION

587 VAUXHALL STREET EXTENSION - SUITE 311  
 WATERFORD, CT 06385 PHONE: (860)-683-1897  
 WWW.ALLPOINTSTECH.COM FAX: (860)-683-0935

**PERMITTING DOCUMENTS**

NO	DATE	REVISION
0	07/23/21	FOR REVIEW: RCB
1	07/28/21	CLIENT COMMENTS: RCB
2	07/29/21	CLIENT COMMENTS: RCB
3	08/30/21	CLIENT COMMENTS: RCB
4	01/11/22	CLIENT COMMENTS: RCB
5	01/14/22	CLIENT COMMENTS: RCB
6	01/18/22	CLIENT COMMENTS: RCB

**DESIGN PROFESSIONALS OF RECORD**

PROF: ROBERT C. BURNS P.E.  
 COMP: ALL-POINTS TECHNOLOGY CORPORATION, P.C.  
 ADD: 587 VAUXHALL STREET EXT. SUITE 311 WATERFORD, CT 06385

DEVELOPER: HOMELAND TOWERS, LLC  
 ADDRESS: 9 HARMONY STREET 2ND FLOOR DANBURY, CT 06810

**HOMELAND TOWERS NORTH BRANFORD**

SITE 222 CLINTONVILLE ROAD  
 ADDRESS: NORTHFORD, CT 06472


APT FILING NUMBER: CT283990

DATE: 07/23/21 DRAWN BY: CSH  
 CHECKED BY: RCB

SHEET TITLE:  
**SITE PLAN & ABUTTERS MAP**

SHEET NUMBER:  
**SP-1**



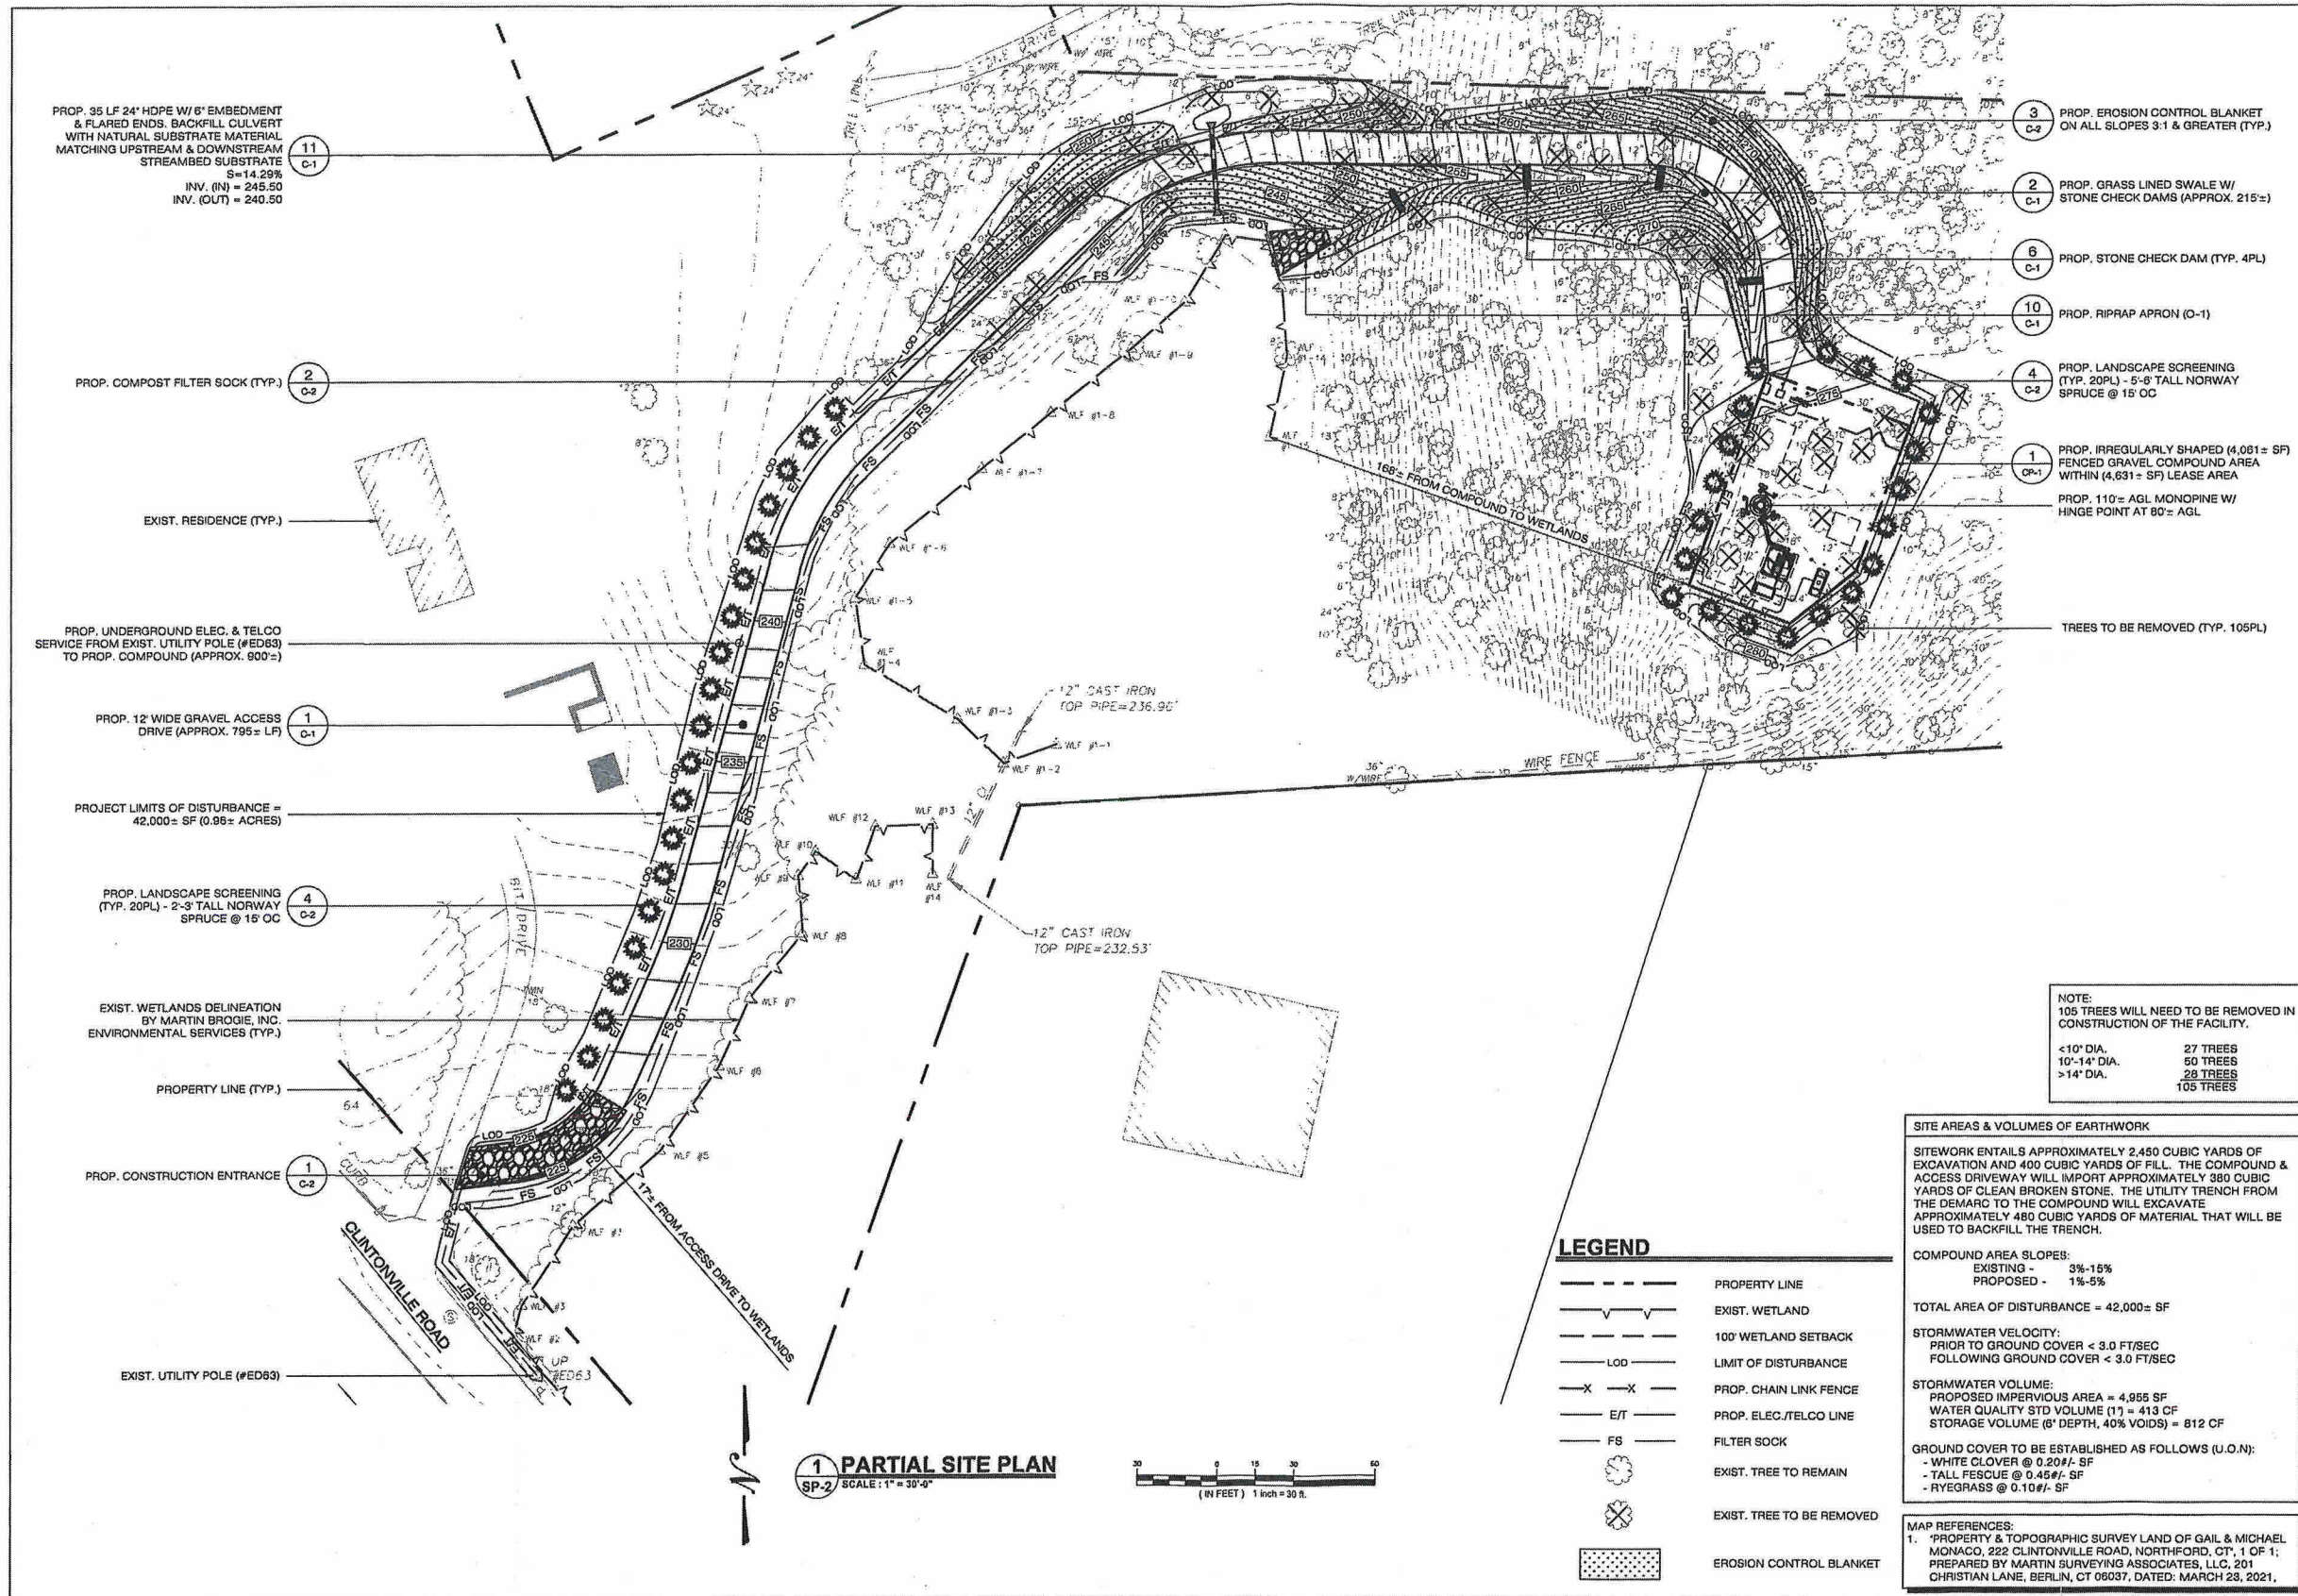

PROP. 36 LF 24" HDPE W/ 6" EMBEDMENT & FLARED ENDS. BACKFILL CULVERT WITH NATURAL SUBSTRATE MATERIAL. MATCHING UPSTREAM & DOWNSTREAM STREAMBED SUBSTRATE  
 S=14.29%  
 INV. (IN) = 245.50  
 INV. (OUT) = 240.50

PROP. COMPOST FILTER SOCK (TYP.)

EXIST. RESIDENCE (TYP.)

PROP. UNDERGROUND ELEC. & TELCO SERVICE FROM EXIST. UTILITY POLE (#ED63) TO PROP. COMPOUND (APPROX. 900'±)

PROP. 12' WIDE GRAVEL ACCESS DRIVE (APPROX. 795± LF)

PROJECT LIMITS OF DISTURBANCE = 42,000± SF (0.98± ACRES)

PROP. LANDSCAPE SCREENING (TYP. 20PL) - 2'-3" TALL NORWAY SPRUCE @ 15' OC

EXIST. WETLANDS DELINEATION BY MARTIN BROOKS, INC. ENVIRONMENTAL SERVICES (TYP.)

PROPERTY LINE (TYP.)

PROP. CONSTRUCTION ENTRANCE

EXIST. UTILITY POLE (#ED63)

3 PROP. EROSION CONTROL BLANKET ON ALL SLOPES 3:1 & GREATER (TYP.)

2 PROP. GRASS LINED SWALE W/ STONE CHECK DAMS (APPROX. 215'±)

6 PROP. STONE CHECK DAM (TYP. 4PL)

10 PROP. RIPRAP APRON (C-1)

4 PROP. LANDSCAPE SCREENING (TYP. 20PL) - 5'-6" TALL NORWAY SPRUCE @ 15' OC

1 PROP. IRREGULARLY SHAPED (4,061± SF) FENCED GRAVEL COMPOUND AREA WITHIN (4,631± SF) LEASE AREA

PROP. 110± AGL MONOPINE W/ HINGE POINT AT 80± AGL

TREES TO BE REMOVED (TYP. 105PL)

NOTE:  
105 TREES WILL NEED TO BE REMOVED IN CONSTRUCTION OF THE FACILITY.

<10" DIA.	27 TREES
10"-14" DIA.	50 TREES
>14" DIA.	28 TREES
	105 TREES

**SITE AREAS & VOLUMES OF EARTHWORK**

SITework entails approximately 2,450 cubic yards of excavation and 400 cubic yards of fill. The compound & access driveway will import approximately 380 cubic yards of clean broken stone. The utility trench from the demarc to the compound will excavate approximately 480 cubic yards of material that will be used to backfill the trench.

COMPOUND AREA SLOPES:  
 EXISTING - 3%-15%  
 PROPOSED - 1%-5%

TOTAL AREA OF DISTURBANCE = 42,000± SF

STORMWATER VELOCITY:  
 PRIOR TO GROUND COVER < 3.0 FT/SEC  
 FOLLOWING GROUND COVER < 3.0 FT/SEC


STORMWATER VOLUME:  
 PROPOSED IMPERVIOUS AREA = 4,955 SF  
 WATER QUALITY STD VOLUME (1") = 413 CF  
 STORAGE VOLUME (6" DEPTH, 40% VOIDS) = 812 CF

GROUND COVER TO BE ESTABLISHED AS FOLLOWS (U.O.N.):  
 - WHITE CLOVER @ 0.20#/ SF  
 - TALL FESCUE @ 0.45#/ SF  
 - RYEGRASS @ 0.10#/ SF

**LEGEND**

- PROPERTY LINE
- - - - - EXIST. WETLAND
- - - - - 100' WETLAND SETBACK
- LOD --- LIMIT OF DISTURBANCE
- X-X- PROP. CHAIN LINK FENCE
- EIT- PROP. ELEC./TELCO LINE
- FS --- FILTER SOCK
- ⊗ EXIST. TREE TO REMAIN
- ⊗ EXIST. TREE TO BE REMOVED
- ▨ EROSION CONTROL BLANKET

**1 PARTIAL SITE PLAN**  
 SP-2 SCALE: 1" = 30'-0"

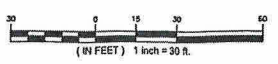

HOMELAND TOWERS, LLC  
 9 HARMONY STREET  
 2ND FLOOR  
 DANBURY, CT 06810  
 (203) 297-6345

Cellco Partnership d/b/a  
**verizon**  
 WIRELESS  
 20 ALEXANDER DRIVE  
 WALLINGFORD, CT 06492

**ALL-POINTS**  
 TECHNOLOGY CORPORATION  
 567 VAUXHALL STREET EXTENSION - SUITE 311  
 WATERFORD, CT 06355 PHONE: (860) 693-1697  
 WWW.ALLPOINTSTECH.COM FAX: (860) 693-0935

PERMITTING DOCUMENTS		
NO	DATE	REVISION
0	07/23/21	FOR REVIEW: RCB
1	07/28/21	CLIENT COMMENTS: RCB
2	07/29/21	CLIENT COMMENTS: RCB
3	08/20/21	CLIENT COMMENTS: RCB
4	01/11/22	CLIENT COMMENTS: RCB
5	01/14/22	CLIENT COMMENTS: RCB
6	01/18/22	CLIENT COMMENTS: RCB

**DESIGN PROFESSIONALS OF RECORD**

PROF: ROBERT C. BURNS P.E.  
 COMP: ALL-POINTS TECHNOLOGY CORPORATION, P.C.  
 ADD: 567 VAUXHALL STREET EXT. SUITE 311 WATERFORD, CT 06385

DEVELOPER: HOMELAND TOWERS, LLC  
 ADDRESS: 9 HARMONY STREET 2ND FLOOR DANBURY, CT 06810

**HOMELAND TOWERS NORTH BRANFORD**

SITE 222 CLINTONVILLE ROAD  
 ADDRESS: NORTHFORD, CT 06472


APT FILING NUMBER: CT283990

DATE: 07/23/21 DRAWN BY: GSH  
 CHECKED BY: RCB


SHEET TITLE:  
**PARTIAL SITE PLAN**

SHEET NUMBER:  
**SP-2**



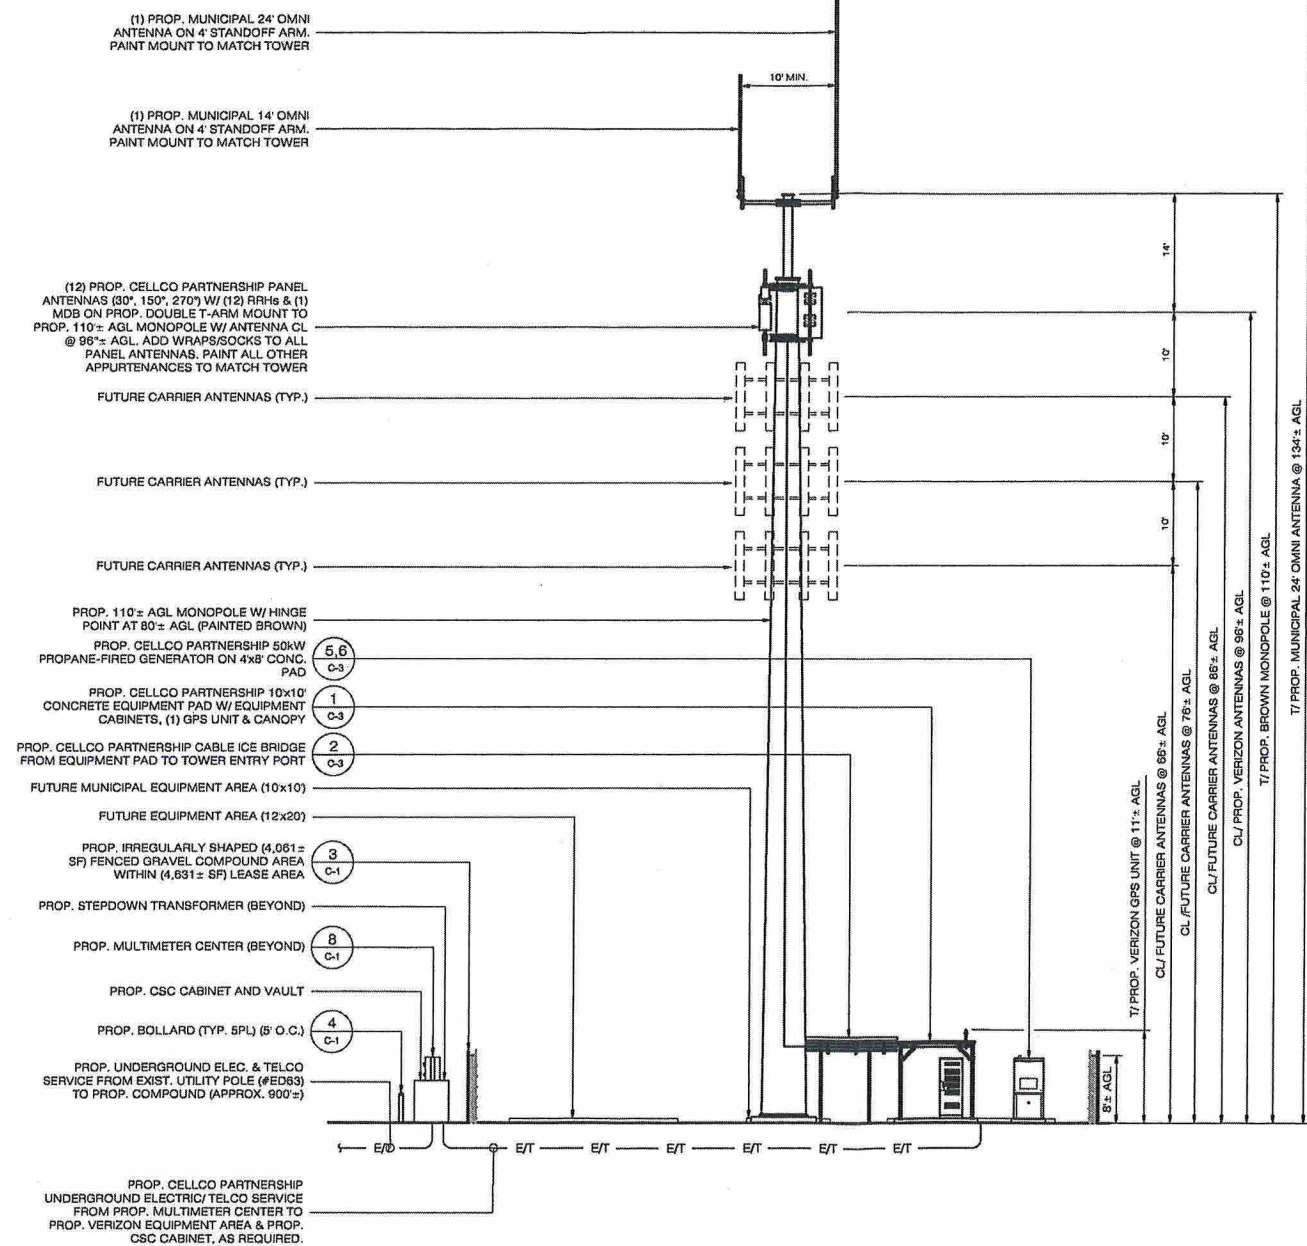

**2 WEST ELEVATION**  
SCALE: 1" = 10'-0"

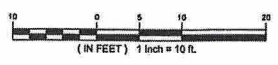



**HOMELAND TOWERS, LLC**  
9 HARMONY STREET  
2nd FLOOR  
DANBURY, CT 06810  
(203) 297-8345

---

Cellco Partnership d/b/a



20 ALEXANDER DRIVE  
WALLINGFORD, CT 06492

---



597 VAUXHALL STREET EXTENSION - SUITE 311  
WATERFORD, CT 06385 PHONE: (860)-663-1697  
WWW.ALLPOINTSTECH.COM FAX: (860)-663-0935

---

PERMITTING DOCUMENTS		
NO	DATE	REVISION
0	07/23/21	FOR REVIEW: RCB
1	07/28/21	CLIENT COMMENTS: RCB
2	07/29/21	CLIENT COMMENTS: RCB
3	08/30/21	CLIENT COMMENTS: RCB
4	01/11/22	CLIENT COMMENTS: RCB
5	01/14/22	CLIENT COMMENTS: RCB
6	01/18/22	CLIENT COMMENTS: RCB

---

**DESIGN PROFESSIONALS OF RECORD**

PROF: ROBERT C. BURNS P.E.  
COMP: ALL-POINTS TECHNOLOGY CORPORATION, P.C.  
ADD: 597 VAUXHALL STREET EXT. SUITE 311 WATERFORD, CT 06385

DEVELOPER: HOMELAND TOWERS, LLC  
ADDRESS: 9 HARMONY STREET 2ND FLOOR DANBURY, CT 06810

---

**HOMELAND TOWERS NORTH BRANFORD**

SITE 222 CLINTONVILLE ROAD  
ADDRESS: NORTHFORD, CT 06472

APT FILING NUMBER: CT283990

DATE: 07/23/21 DRAWN BY: CSH  
CHECKED BY: RCB

---

SHEET TITLE:









**ALTERNATE MONOPOLE ELEVATION**

---

SHEET NUMBER:

**A-1**



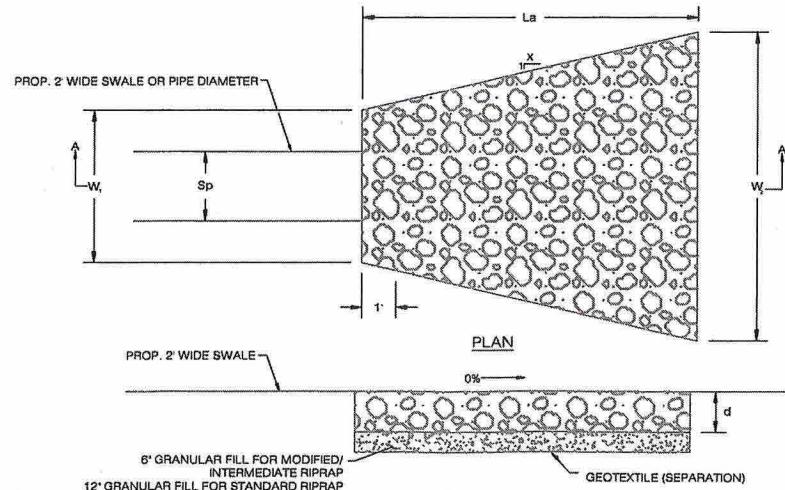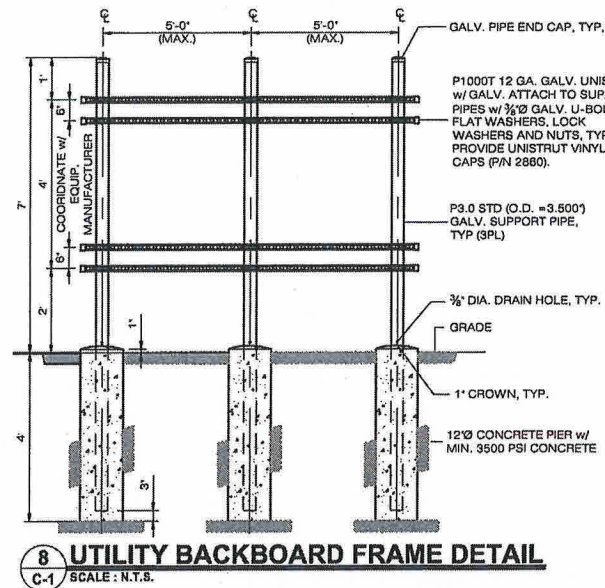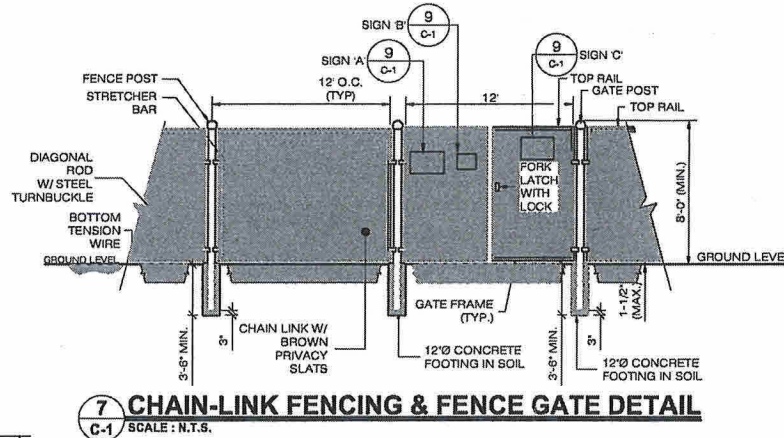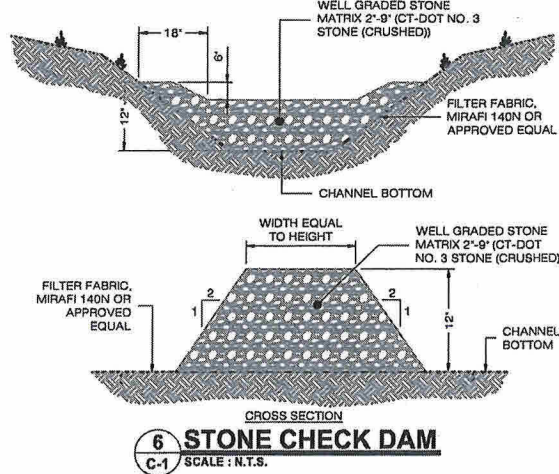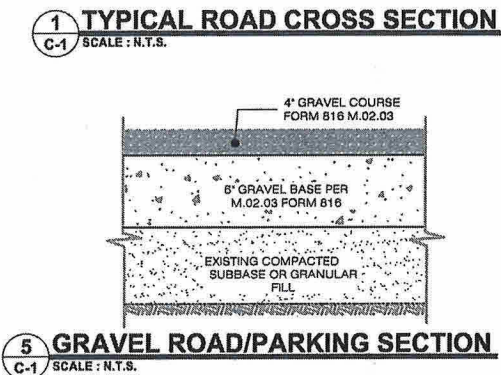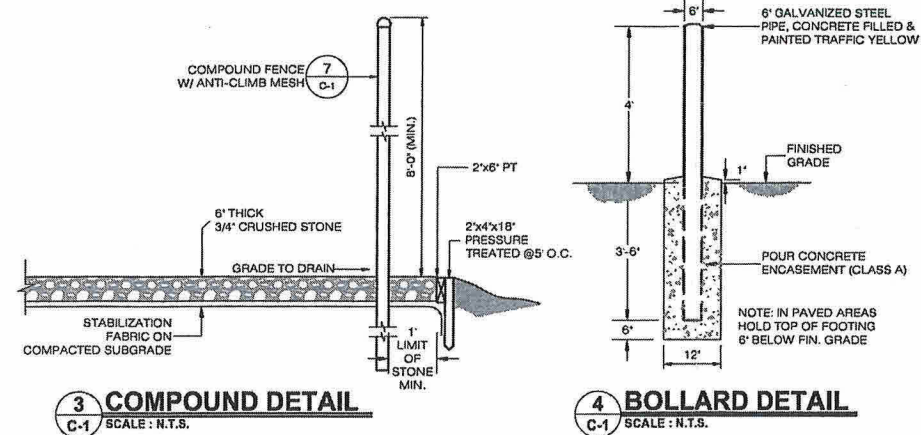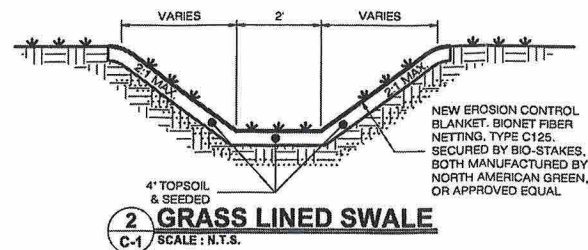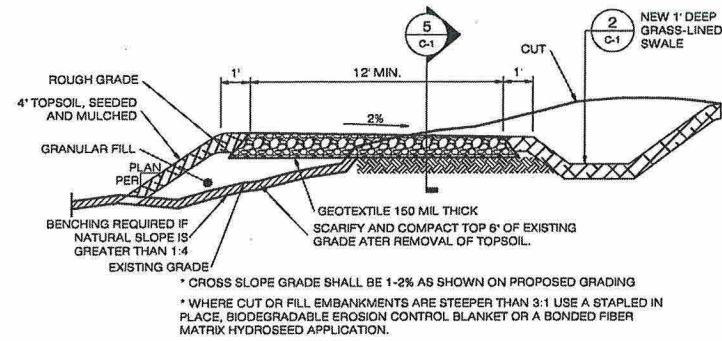

PIPE DIA.	MIN. TRENCH WIDTH
6"	23"
8"	26"
10"	28"
12"	30"
15"	34"
18"	39"
24"	48"
30"	58"
36"	64"
48"	80"
60"	96"

MIN. TRENCH WIDTH (SEE TABLE)

NOTES:  
1. ALL PIPE SYSTEMS SHALL BE INSTALLED IN ACCORDANCE WITH ASTM D2321, "STANDARD PRACTICE FOR UNDERGROUND INSTALLATION OF THERMOPLASTIC PIPE FOR SEWERS AND OTHER GRAVITY FLOW APPLICATIONS", LATEST EDITION.  
2. MEASURES SHOULD BE TAKEN TO PREVENT MIGRATION OF NATIVE PINES INTO BACKFILL MATERIAL, WHEN REQUIRED.  
3. FOUNDATION: WHERE THE TRENCH BOTTOM IS UNSTABLE, THE CONTRACTOR SHALL EXCAVATE TO A DEPTH REQUIRED BY THE ENGINEER AND REPLACE WITH SUITABLE MATERIAL AS SPECIFIED BY THE ENGINEER, AS AN ALTERNATIVE AND AT THE DISCRETION OF THE DESIGN ENGINEER, THE TRENCH BOTTOM MAY BE STABILIZED USING A GEOTEXTILE MATERIAL.  
4. BEDDING: SUITABLE MATERIAL SHALL BE CLASS I, II OR III. THE CONTRACTOR SHALL PROVIDE DOCUMENTATION FOR MATERIAL SPECIFICATION TO ENGINEER, UNLESS OTHERWISE NOTED BY THE ENGINEER. MINIMUM BEDDING THICKNESS SHALL BE 4" (100mm) FOR 4'-24" (100mm-600mm); 6" (150mm) FOR 30'-60" (750mm-900mm).  
5. INITIAL BACKFILL: SUITABLE MATERIAL SHALL BE CLASS I, II OR III IN THE PIPE ZONE EXTENDING NOT LESS THAN 8' ABOVE CROWN OF PIPE. THE CONTRACTOR SHALL PROVIDE DOCUMENTATION FOR MATERIAL SPECIFICATION TO ENGINEER. MATERIAL SHALL BE INSTALLED AS REQUIRED IN ASTM D2321, LATEST EDITION.  
6. MINIMUM COVER: MINIMUM COVER, H, IN NON-TRAFFIC APPLICATIONS (GRASS OR LANDSCAPE AREAS) IS 12" FROM THE TOP OF PIPE TO GROUND SURFACE. ADDITIONAL COVER MAY BE REQUIRED TO PREVENT FLOATATION. FOR TRAFFIC APPLICATIONS, MINIMUM COVER, H, IS 12" UP TO 48" DIAMETER PIPE AND 24" OF COVER FOR 54"-60" DIAMETER PIPE, MEASURED FROM TOP OF PIPE TO BOTTOM OF FLEXIBLE PAVEMENT OR TO TOP OF RIGID PAVEMENT.



HOMELAND TOWERS, LLC  
9 HARMONY STREET  
2nd FLOOR  
DANBURY, CT 06810  
(203) 297-6345

Cellco Partnership d/b/a  
**verizon**  
WIRELESS

20 ALEXANDER DRIVE  
WALLINGFORD, CT 06492

567 VAUXHALL STREET EXTENSION - SUITE 311  
WATERFORD, CT 06385 PHONE: (860) 453-1897  
WWW.ALLPOINTSTECH.COM FAX: (860) 453-0835

ALL-POINTS  
TECHNOLOGY CORPORATION

PERMITTING DOCUMENTS

NO	DATE	REVISION
0	07/23/21	FOR REVIEW: RCB
1	07/28/21	CLIENT COMMENTS: RCB
2	07/29/21	CLIENT COMMENTS: RCB
3	08/20/21	CLIENT COMMENTS: RCB
4	01/11/22	CLIENT COMMENTS: RCB
5	01/14/22	CLIENT COMMENTS: RCB
6	01/18/22	CLIENT COMMENTS: RCB

DESIGN PROFESSIONALS OF RECORD  
PROF: ROBERT C. BURNS P.E.  
COMP: ALL-POINTS TECHNOLOGY CORPORATION, P.C.  
ADD: 567 VAUXHALL STREET EXT. SUITE 311 WATERFORD, CT 06385  
DEVELOPER: HOMELAND TOWERS, LLC  
ADDRESS: 9 HARMONY STREET 2ND FLOOR DANBURY, CT 06810

HOMELAND TOWERS  
NORTH BRANFORD


SITE: 222 CLINTONVILLE ROAD  
ADDRESS: NORTHFORD, CT 06472

APT FILING NUMBER: CT283990  
DATE: 07/23/21 DRAWN BY: CSH  
CHECKED BY: RCB

SHEET TITLE:  
**SITE DETAILS**

SHEET NUMBER:  
C-1

STATE OF CONNECTICUT  
REGISTERED PROFESSIONAL ENGINEER

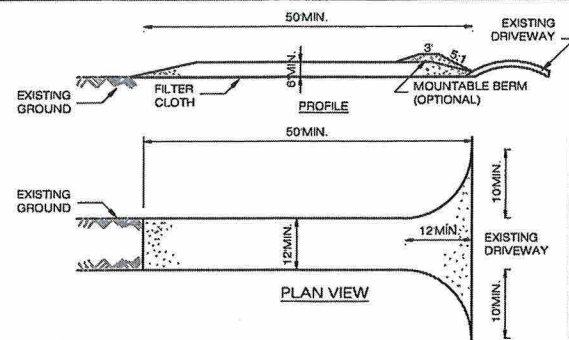


- CONSTRUCTION SPECIFICATIONS:**
- STONE SIZE - USE 1-4 INCH STONE, OR RECLAIMED OR RECYCLED CONCRETE EQUIVALENT.
  - LENGTH - NOT LESS THAN 50 FEET (EXCEPT ON A SINGLE RESIDENCE LOT WHERE A 30 FOOT MINIMUM LENGTH WOULD APPLY).
  - THICKNESS - NOT LESS THAN SIX (6) INCHES.
  - WIDTH - TWELVE (12) FOOT MINIMUM, BUT NOT LESS THAN THE FULL WIDTH AT POINTS WHERE INGRESS OR EGRESS OCCURS. TWENTY-FOUR (24) FOOT IF SINGLE ENTRANCE TO SITE.
  - GEOTEXTILE - WILL BE PLACED OVER THE ENTIRE AREA PRIOR TO PLACING OF STONE.
  - SURFACE WATER - ALL SURFACE WATER FLOWING OR DIVERTED TOWARD CONSTRUCTION ACCESS SHALL BE PIPED BENEATH THE ENTRANCE. IF PIPING IS IMPRACTICAL, A MOUNTABLE BERM WITH 5:1 SLOPES WILL BE PERMITTED.
  - MAINTENANCE - THE ENTRANCE SHALL BE MAINTAINED IN A CONDITION WHICH WILL PREVENT TRACKING OR FLOWING OF SEDIMENT ONTO PUBLIC RIGHTS-OF-WAY, ALL SEDIMENT SPILLED, DROPPED, WASHED OR TRACKED ONTO PUBLIC RIGHTS-OF-WAY MUST BE REMOVED IMMEDIATELY.
  - WHEN WASHING IS REQUIRED, IT SHALL BE DONE ON A AREA STABILIZED WITH STONE AND WHICH DRAINS INTO AN APPROVED SEDIMENT TRAPPING DEVICE.
  - PERIODIC INSPECTION AND NEEDED MAINTENANCE SHALL BE PROVIDED AFTER EACH RAIN.


**1 CONSTRUCTION ENTRANCE DETAIL**  
C-2 SCALE: N.T.S.

- SEQUENCE OF CONSTRUCTION**
- PREPARE SOIL BEFORE INSTALLING ROLLED EROSION CONTROL PRODUCTS (RECPs), INCLUDING ANY NECESSARY APPLICATION OF LIME, FERTILIZER, AND SEED.
  - BEGIN AT THE TOP OF THE SLOPE BY ANCHORING THE RECPs IN A 6" DEEP X 6" WIDE TRENCH WITH APPROXIMATELY 12" OF RECPs EXTENDED BEYOND THE UP-SLOPE PORTION OF THE TRENCH. ANCHOR THE RECPs WITH A ROW OF STAPLES/STAKES APPROXIMATELY 12" APART IN THE BOTTOM OF THE TRENCH. BACKFILL AND COMPACT THE TRENCH AFTER STAPLING. APPLY SEED TO THE COMPACTED SOIL AND FOLD THE REMAINING 12" PORTION OF RECPs BACK OVER THE SEED AND COMPACTED SOIL. SECURE RECPs OVER COMPACTED SOIL WITH A ROW OF STAPLES/STAKES SPACED APPROXIMATELY 12" APART ACROSS THE WIDTH OF THE RECPs.
  - ROLL THE RECPs DOWN HORIZONTALLY ACROSS THE SLOPE. RECPs WILL UNROLL WITH APPROPRIATE SIDE AGAINST THE SOIL SURFACE. ALL RECPs MUST BE SECURELY FASTENED TO SOIL SURFACE BY PLACING STAPLES/STAKES IN APPROPRIATE LOCATIONS AS SHOWN IN THE STAPLE PATTERN GUIDE.
  - THE EDGES OF PARALLEL RECPs MUST BE STAPLED WITH APPROXIMATELY 2" - 5" OVERLAP DEPENDING ON THE RECPs TYPE.
  - CONSECUTIVE RECPs SPICED DOWN THE SLOPE MUST BE END OVER END (SHINGLE STYLE) WITH AN APPROXIMATE 3" OVERLAP. STAPLE THROUGH OVERLAPPED AREA, APPROXIMATELY 12" APART ACROSS ENTIRE RECPs WIDTH.

- NOTES:**
- PROVIDE ANCHOR TRENCH AT TOE OF SLOPE IN SIMILAR FASHION AS AT TOP OF SLOPE.
  - SLOPE SURFACE SHALL BE FREE OF ROCKS, CLODS, STICKS, AND GRASS.
  - BLANKET SHALL HAVE GOOD CONTINUOUS CONTACT WITH UNDERLYING SOIL THROUGHOUT ENTIRE LENGTH. LAY BLANKET LOOSELY AND STAKE OR STAPLE TO MAINTAIN DIRECT CONTACT WITH SOIL. DO NOT STRETCH BLANKET.
  - THE BLANKET SHALL BE STAPLED IN ACCORDANCE WITH THE MANUFACTURER'S RECOMMENDATIONS.
  - BLANKETED AREAS SHALL BE INSPECTED WEEKLY AND AFTER EACH RUNOFF EVENT UNTIL PERENNIAL VEGETATION IS ESTABLISHED TO A MINIMUM UNIFORM 70% COVERAGE THROUGHOUT THE BLANKETED AREA. DAMAGED OR DISPLACED BLANKETS SHALL BE RESTORED OR REPLACED WITHIN 4 CALENDAR DAYS.

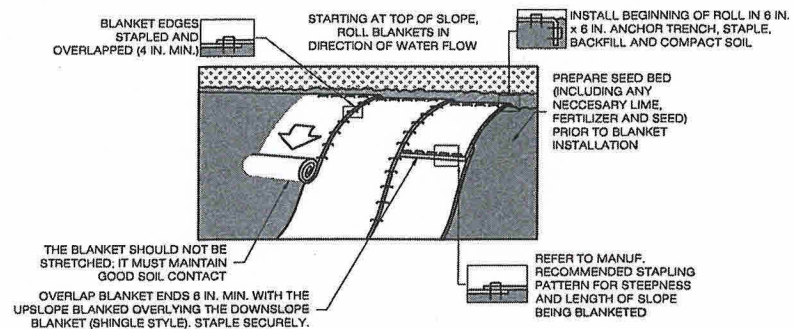


**3 EROSION CONTROL BLANKET STEEP SLOPES**  
C-2 SCALE: N.T.S.

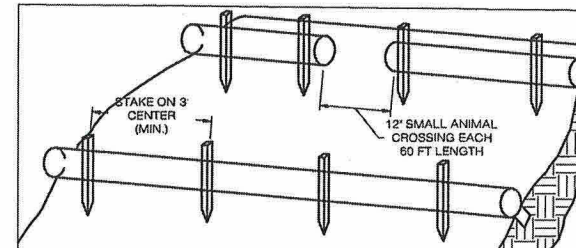

- BEGIN AT THE LOCATION WHERE THE SOCK IS TO BE INSTALLED BY EXCAVATING A 2-3' (6-7.5 CM) DEEP X 9' (22.9 CM) WIDE TRENCH ALONG THE CONTOUR OF THE SLOPE. EXCAVATED SOIL SHOULD BE PLACED UP SLOPE FROM THE ANCHOR TRENCH.
- PLACE THE SOCK IN THE TRENCH SO THAT IT CONTOURS TO THE SOIL SURFACE. COMPACT SOIL FROM THE EXCAVATED TRENCH AGAINST THE SOCK ON THE UPHILL SIDE. SOCKS SHALL BE INSTALLED IN 60 FT CONTINUOUS LENGTHS WITH ADJACENT SOCKS TIGHTLY ABUT. EVERY 60 FT THE SOCK ROW SHALL BE SPACED 12 INCHES CLEAR, END TO END, FOR AMPHIBIAN AND REPTILE TRAVEL. THE OPEN SPACES SHALL BE STAGGERED MID LENGTH OF THE NEXT DOWN GRADIENT SOCK.
- SECURE THE SOCK WITH 18-24' (45.7-61 CM) STAKES EVERY 3-4' (0.9-1.2 M) AND WITH A STAKE ON EACH END. STAKES SHOULD BE DRIVEN THROUGH THE MIDDLE OF THE SOCK LEAVING AT LEAST 2-3' (6-7.5 CM) OF STAKE EXTENDING ABOVE THE SOCK. STAKES SHOULD BE DRIVEN PERPENDICULAR TO THE SLOPE FACE.

**2 COMPOST FILTER SOCK SEDIMENTATION CONTROL BARRIER**  
C-2 SCALE: N.T.S.

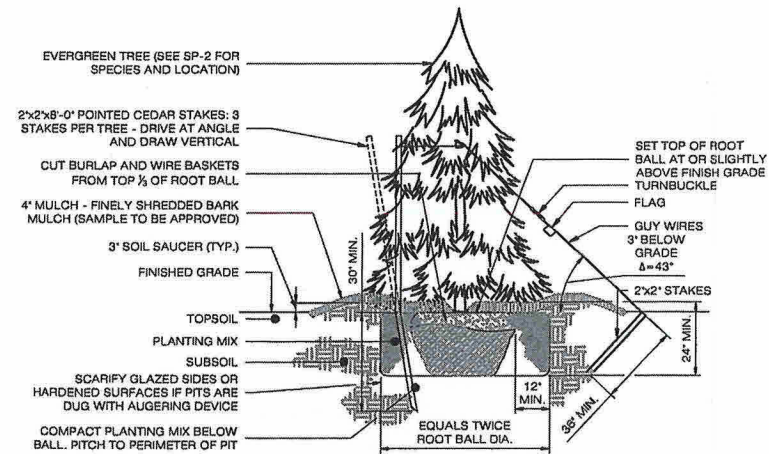

STAKING FOR EVERGREEN TREES OVER 6' HIGH

**4 EVERGREEN TREE PLANTING**  
C-2 SCALE: N.T.S.

**HOMELAND TOWERS, LLC**  
9 HARMONY STREET  
2ND FLOOR  
DANBURY, CT 06810  
(203) 297-8345

**Cellco Partnership d/b/a**  
**verizon**  
WIRELESS

20 ALEXANDER DRIVE  
WALLINGFORD, CT 06492

**ALL-POINTS**  
TECHNOLOGY CORPORATION

567 VAUXHALL STREET EXTENSION - SUITE 311  
WATERFORD, CT 06385 PHONE: (860)-683-1697  
WWW.ALLPOINTSTECH.COM FAX: (860)-683-0935

**PERMITTING DOCUMENTS**

NO	DATE	REVISION
0	07/23/21	FOR REVIEW; RCB
1	07/28/21	CLIENT COMMENTS; RCB
2	07/29/21	CLIENT COMMENTS; RCB
3	08/30/21	CLIENT COMMENTS; RCB
4	01/11/22	CLIENT COMMENTS; RCB
5	01/14/22	CLIENT COMMENTS; RCB
6	01/18/22	CLIENT COMMENTS; RCB

**DESIGN PROFESSIONALS OF RECORD**

PROF: ROBERT C. BURNS P.E.  
COMP: ALL-POINTS TECHNOLOGY CORPORATION, P.C.  
ADD: 567 VAUXHALL STREET EXT. SUITE 311 WATERFORD, CT 06385

DEVELOPER: HOMELAND TOWERS, LLC  
ADDRESS: 9 HARMONY STREET 2ND FLOOR DANBURY, CT 06810

**HOMELAND TOWERS NORTH BRANFORD**

SITE 222 CLINTONVILLE ROAD  
ADDRESS: NORTHFORD, CT 06472

APT FILING NUMBER: CT283990

DATE: 07/23/21 DRAWN BY: CSH  
CHECKED BY: RCB

SHEET TITLE:  
**EROSION CONTROL & LANDSCAPING DETAILS**

SHEET NUMBER:  
**C-2**

STATE OF CONNECTICUT  
REGISTERED PROFESSIONAL ENGINEER




(1) PROP. MUNICIPAL 24' OMNI ANTENNA (dbSpectra MODEL DS7C09P36D-D, AS7C09P36D2D & DS7C09P36D6D) ON 4" STANDOFF ARM. PAINT MOUNT TO MATCH TOWER

3  
C-4

(1) PROP. MUNICIPAL 14' OMNI ANTENNA (dbSpectra MODELS DS7C09P36U-SERIES) ON 4" STANDOFF ARM. PAINT MOUNT TO MATCH TOWER

2  
C-4

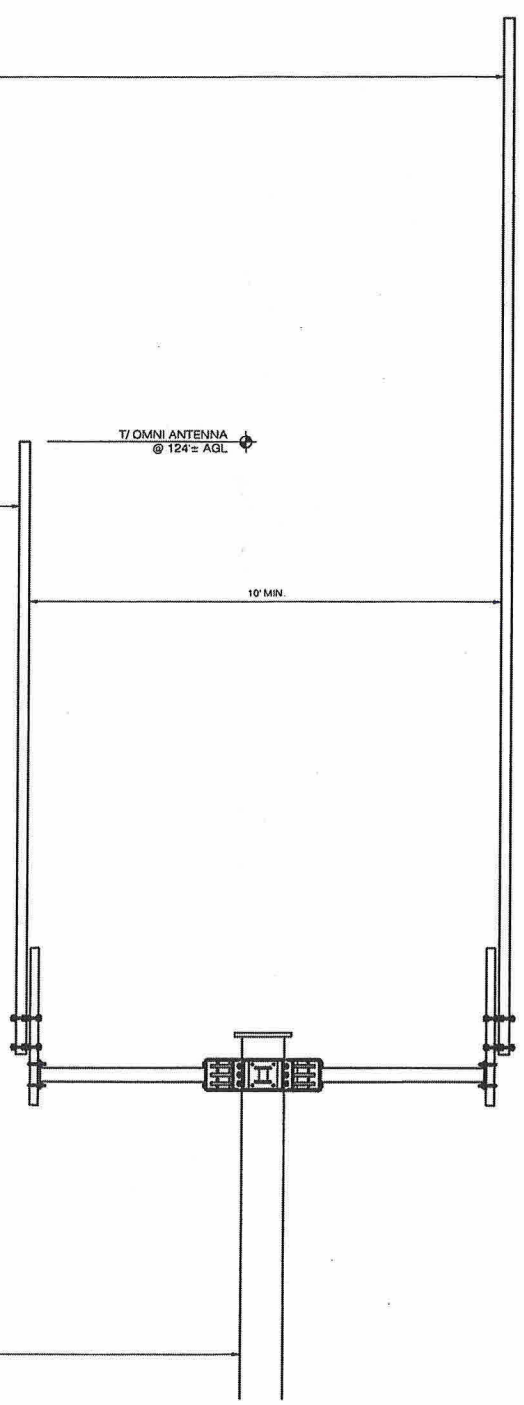

1 MUNICIPAL ANTENNA MOUNT  
SCALE: 1/2" = 1'-0"

T/ OMNI ANTENNA @ 184'± AGL


T/ OMNI ANTENNA @ 124'± AGL

10' MIN.

**700/800 MHz Antenna - Omnidirectional, Low-PIM/Hi-PIP, 8.8 dBd**  
Models DS7C09P36U-Series Antennas

Specifications	
Design Type	True Corporate Feed
Frequency Range	764-869 MHz
Passive Intermodulation - PIM (2 x 10W sources)	-150 dBc, 3 <sup>rd</sup> Order
Bandwidth	105 MHz
Gain (average over BW)	8.8 dBd
Configuration	Single antenna
Beam Tilt (electrical downtilt)	0°, -2°, 3°, 4°, or 6 degrees
Vertical Beamwidth (E-Plane) typ.	6.7°
Impedance	50 ohms
VSWR / Return Loss	1.5:1 / 14 dB (min.)
Average Power Rating	500 W
Peak Instantaneous Power	25 kW
Polarization	Vertical
Lightning Protection	Direct Ground
Connector	7/16 DIN (F)
DS7C09P36U(X)ID	4.3-10 (F)
DS7C09P36U(X)JM	4.3-10 Connector
Equivalent Flat-Plate Area	2.35 sq. ft.
Lateral Windload Thrust @100mph	99 lbf.
Rated Wind Speed	125 mph (without ice) 189 mph (with 1" radial ice)
Total Length	18.2 feet
Mounting Mast Length	35 inches
Mounting Hardware (included)	DSH-3V4IN
Mast O.D.	2.6 inches
Radome color	Horizon Blue
Radome O.D.	3.0 inches
Weight, antenna and hardware	84 lbs.
Shipping Weight	84 lbs.
Invertibility	Antennas are not invertible. For invertible tilt options contact dbSpectra at tech@dbSpectra.com.
Ordering Information	1. Replace (F) in model number with Beam Tilt options. 2. "JM" in the beam tilt options represents 2° down tilt.

**Features and Benefits**  
Tested to stringent Peak Instantaneous Power (PIP) levels of 25 KW using dbSpectra's multi-channel P25 PIP test bed. High PIP level is demanded by today's digital systems.  
PIM-rated Design - 3<sup>rd</sup>-Order performance better than -150 dBc!  
Sturdy Construction - Heavy-wall fiberglass radome minimizes tip deflection.  
Excellent Lightning Protection - heavy internal conductor DC ground.

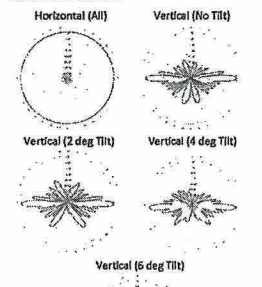


2 14' OMNI ANTENNA  
SCALE: NTS

dbSpectra  
Always a Better Value

**700/800 MHz DUAL Antenna, Low-PIM, Hi-PIP, 9 dBd**  
Models DS7C09P36D-D, DS7C09P36D2D, and DS7C09P36D6D

Specifications	
Design Type	True Corporate Feed/Dual
Frequency Range	764-869 MHz
Passive Intermodulation - PIM (2 x 10W)	-150 dBc, 3 <sup>rd</sup> Order
Bandwidth	105 MHz
Gain - dBd (average over BW)	9.0 dBd (lower antenna) 8.7 dBd (top antenna)
Isolation (typical)	45 dB
Beam Tilt (electrical downtilt)	0° (none), 2°, or 6°
Vertical Beamwidth (E-Plane) typ.	6°
Impedance - Ohms	50
VSWR / Return Loss - dB	1.5:1 / 14 dB (min.)
Average Power Rating	500 W (each antenna)
Peak Instantaneous Power	25 kW (each antenna)
Polarization	Vertical
Lightning Protection	Direct Ground
Connector	7/16 DIN female (x2)
Equivalent Flat-Plate Area	4.8 sq. ft.
Lateral Windload Thrust @100mph	179 lbf.
Rated Wind Speed	125 mph (without ice)
Total Length	26 feet
Mounting Mast Length	35 inches
Mounting Hardware (included)	DSH-3V4IN (No Torsion)
Mast O.D.	3.5 inches
Radome color	Horizon Blue
Weight (approx.)	82 lbs.
Shipping Weight (approx.)	105 lbs.
Configuration: Dual	"Two antennas in one"

**Features and Benefits**  
Dual-antenna configuration saves overall cost - allows two antennas in one tower slot!  
High RF Isolation between the independent antennas provides greater system performance and interference protection.  
Tested to stringent Peak Instantaneous Power (PIP) levels of 25 KW using dbSpectra's 12-channel P25 PIP test bed. High PIP level is demanded by today's digital systems.

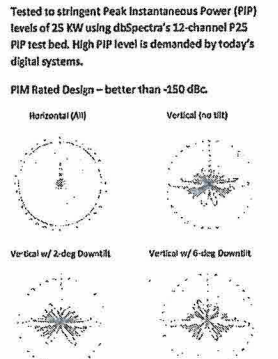

3 24' OMNI ANTENNA  
SCALE: NTS

dbSpectra  
Always a Better Value

HOMELAND TOWERS, LLC  
9 HARMONY STREET  
2nd FLOOR  
DANBURY, CT 06810  
(203) 297-6345

Cellco Partnership d/b/a

**verizon**  
WIRELESS

20 ALEXANDER DRIVE  
WALLINGFORD, CT 06492

**ALL-POINTS**  
TECHNOLOGY CORPORATION

567 VAUXHALL STREET EXTENSION • SUITE 311  
WATERFORD, CT 06385 PHONE: (860)-863-1697  
WWW.ALLPOINTSTECH.COM FAX: (860)-863-0835

PERMITTING DOCUMENTS

NO	DATE	REVISION
0	07/23/21	FOR REVIEW: RCB
1	07/28/21	CLIENT COMMENTS: RCB
2	07/29/21	CLIENT COMMENTS: RCB
3	08/30/21	CLIENT COMMENTS: RCB
4	01/11/22	CLIENT COMMENTS: RCB
5	01/14/22	CLIENT COMMENTS: RCB
6	01/18/22	CLIENT COMMENTS: RCB

DESIGN PROFESSIONALS OF RECORD

PROF: ROBERT C. BURNS P.E.  
COMP: ALL-POINTS TECHNOLOGY CORPORATION, P.C.  
ADD: 567 VAUXHALL STREET EXT. SUITE 311 WATERFORD, CT 06385

DEVELOPER: HOMELAND TOWERS, LLC  
ADDRESS: 9 HARMONY STREET, 2ND FLOOR DANBURY, CT 06810

HOMELAND TOWERS  
NORTH BRANFORD

SITE 222 CLINTONVILLE ROAD  
ADDRESS: NORTHFORD, CT 06472

APT FILING NUMBER: CT283980

DATE: 07/23/21 DRAWN BY: CSH  
CHECKED BY: RCB

SHEET TITLE:  
**MUNICIPAL ANTENNA  
PLAN & DETAILS**

SHEET NUMBER:  
**C-4**