

JULIE D. KOHLER

PLEASE REPLY TO: Bridgeport
WRITER'S DIRECT DIAL: (203) 337-4157
E-Mail Address: jkohler@cohenandwolf.com

December 23, 2014

Attorney Melanie Bachman
Acting Executive Director
Connecticut Siting Council
Ten Franklin Square
New Britain, CT 06051

**Re: Notice of Exempt Modification
Connecticut State Police Facility/T-Mobile equipment upgrade
Site ID CT11070B
150 Butternut Hollow Road, Greenwich, CT**


Dear Attorney Bachman:

On December 22, 2014 T-Mobile Northeast LLC ("T-Mobile") filed a notice of exempt modification for the above referenced site. In that filing, T-Mobile indicated (in footnote 2) that the plans provided contained a typographical error and incorrectly referenced the proposed antenna elevation at the 135 foot centerline.

Enclosed please find revised plans dated December 23, 2014. The enclosed plans accurately reflect T-Mobile antennas at a centerline of 137 feet and the inclusion of its tower mounted amplifiers as referenced in the exempt modification filing. Please accept these revisions to T-Mobile's request for exempt modification.

Please do not hesitate to let me know if you have any questions.

Sincerely,

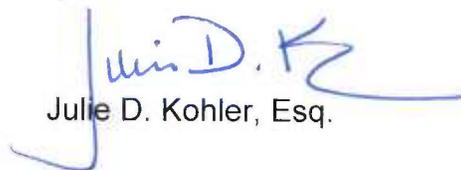
Julie D. Kohler, Esq.

JDK/lcc

cc: First Selectman Peter Tesei, Town of Greenwich
Department of Emergency Services and Public Protection – Division of State Police
Samuel Simons, T-Mobile Northeast LLC
Robert Stanford, Vertical Development, LLC

T-Mobile

NORTHEAST LLC.

SITE NAME: **GREENWICH-EAST**

SITE NUMBER: **CT11070B**

SITE ADDRESS: **150 BUTTERNUT HOLLOW ROAD
GREENWICH, CT 06830**

TECTONIC

• PLANNING
• ENGINEERING

• SURVEYING
• CONSTRUCTION
MANAGEMENT

TECTONIC Engineering & Surveying
Consultants P.C.

1279 Route 300
Newburgh, NY 12550
Phone: (845) 567-6656
Fax: (845) 567-8703

T-Mobile
NORTHEAST LLC.

T-MOBILE NORTHEAST, LLC.
35 GRIFFIN ROAD SOUTH
BLOOMFIELD, CT 06002

APPROVALS

T-MOBILE LANDLORD _____
RF _____
CONSTRUCTION _____
PROJECT NUMBER _____
6203.CT11070B

DESIGNED BY _____
CL _____
DRAWN BY _____
MP _____
SP _____
DC _____

REV. DATE REVISION
 03/07/13 FOR COMMENT MP
 04/16/13 PER COMMENTS SP
 12/23/14 GENERAL REVISIONS DC

ISSUED BY _____ DATE _____

SITE INFORMATION
 CT11070B
 150 BUTTERNUT HOLLOW RD
 GREENWICH, CT
 06830

SHEET TITLE
 TITLE SHEET

SHEET NUMBER
 20

T-1


PROJECT SUMMARY

SITE NUMBER: CT11070B
 SITE NAME: GREENWICH-EAST
 SITE ADDRESS: 150 BUTTERNUT HOLLOW ROAD
 GREENWICH, CT 06830
 COUNTY: FAIRFIELD
 PROPERTY OWNER: CONNECTICUT STATE POLICE
 APPLICANT: T-MOBILE NORTHEAST LLC.
 35 GRIFFIN ROAD SOUTH
 BLOOMFIELD, CT 06002
 (860) 692-7100
 ENGINEER: TECTONIC ENGINEERING &
 SURVEYING CONSULTANTS P.C.
 1279 ROUTE 300
 NEWBURGH, NY 12550
 JAMES QUICKSELL
 (845) 567-6656 EXT. 2835
 CONTACT: PHONE:
 SITE ACQUISITION: HPC WIRELESS
 46 MILL PLAIN ROAD, 2ND FLOOR
 DANBURY, CT 06811
 CONTACT: AMY ENGLISH
 PHONE: 716-880-6430
 LATITUDE: (NAD 83) 41.09697209° N
 LONGITUDE: (NAD 83) -73.63885729° W

SITE DIRECTIONS

HEAD NORTHEAST ON GRIFFIN ROAD SOUTH TOWARD W. NEWBERRY RD. TAKE THE 2ND RIGHT ONTO DAY HILL RD. SLIGHT RIGHT ONTO CT-187 S/BUE HILLS AVE. TURN LEFT ONTO CT-305 E. TAKE THE RAMP ONTO 1-91 S. KEEP LEFT AT THE FORK, FOLLOW SIGNS FOR INTERSTATE 95 S/N.Y. CITY AND MERGE ONTO I-95 S. TAKE EXIT 19 TOWARD US-1/S PORT. MERGE ONTO PEASE AVE. SLIGHT RIGHT ONTO POST ROAD. CONTINUE ONTO U.S. 1 S/POST RD.

LOCATION MAP

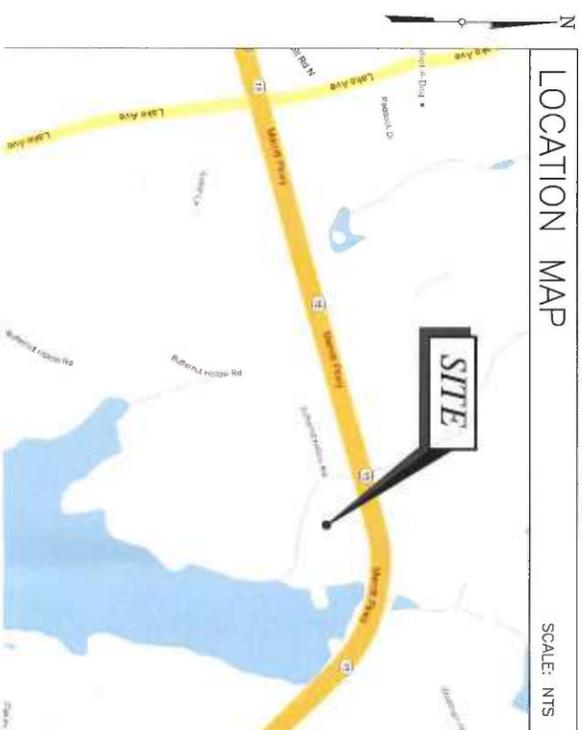


SHEET INDEX

SHEET NO	DESCRIPTION	REV NO
T-1	TITLE SHEET	2
A-1	SITE PLAN	2
A-2	ELEVATION	2
A-3	ANTENNA PLAN & DETAIL	2
A-4	UTILITY, GROUNDING & CONFIG. DIAGRAMS	2
A-5	NOTES	2
A-6	NOTES	2

THIS SET OF PLANS SHALL NOT BE UTILIZED AS CONSTRUCTION DOCUMENTS UNTIL ALL ITEMS HAVE BEEN ADDRESSED AND EACH OF THE DRAWINGS HAS BEEN REVISED AND ISSUED "FOR CONSTRUCTION".




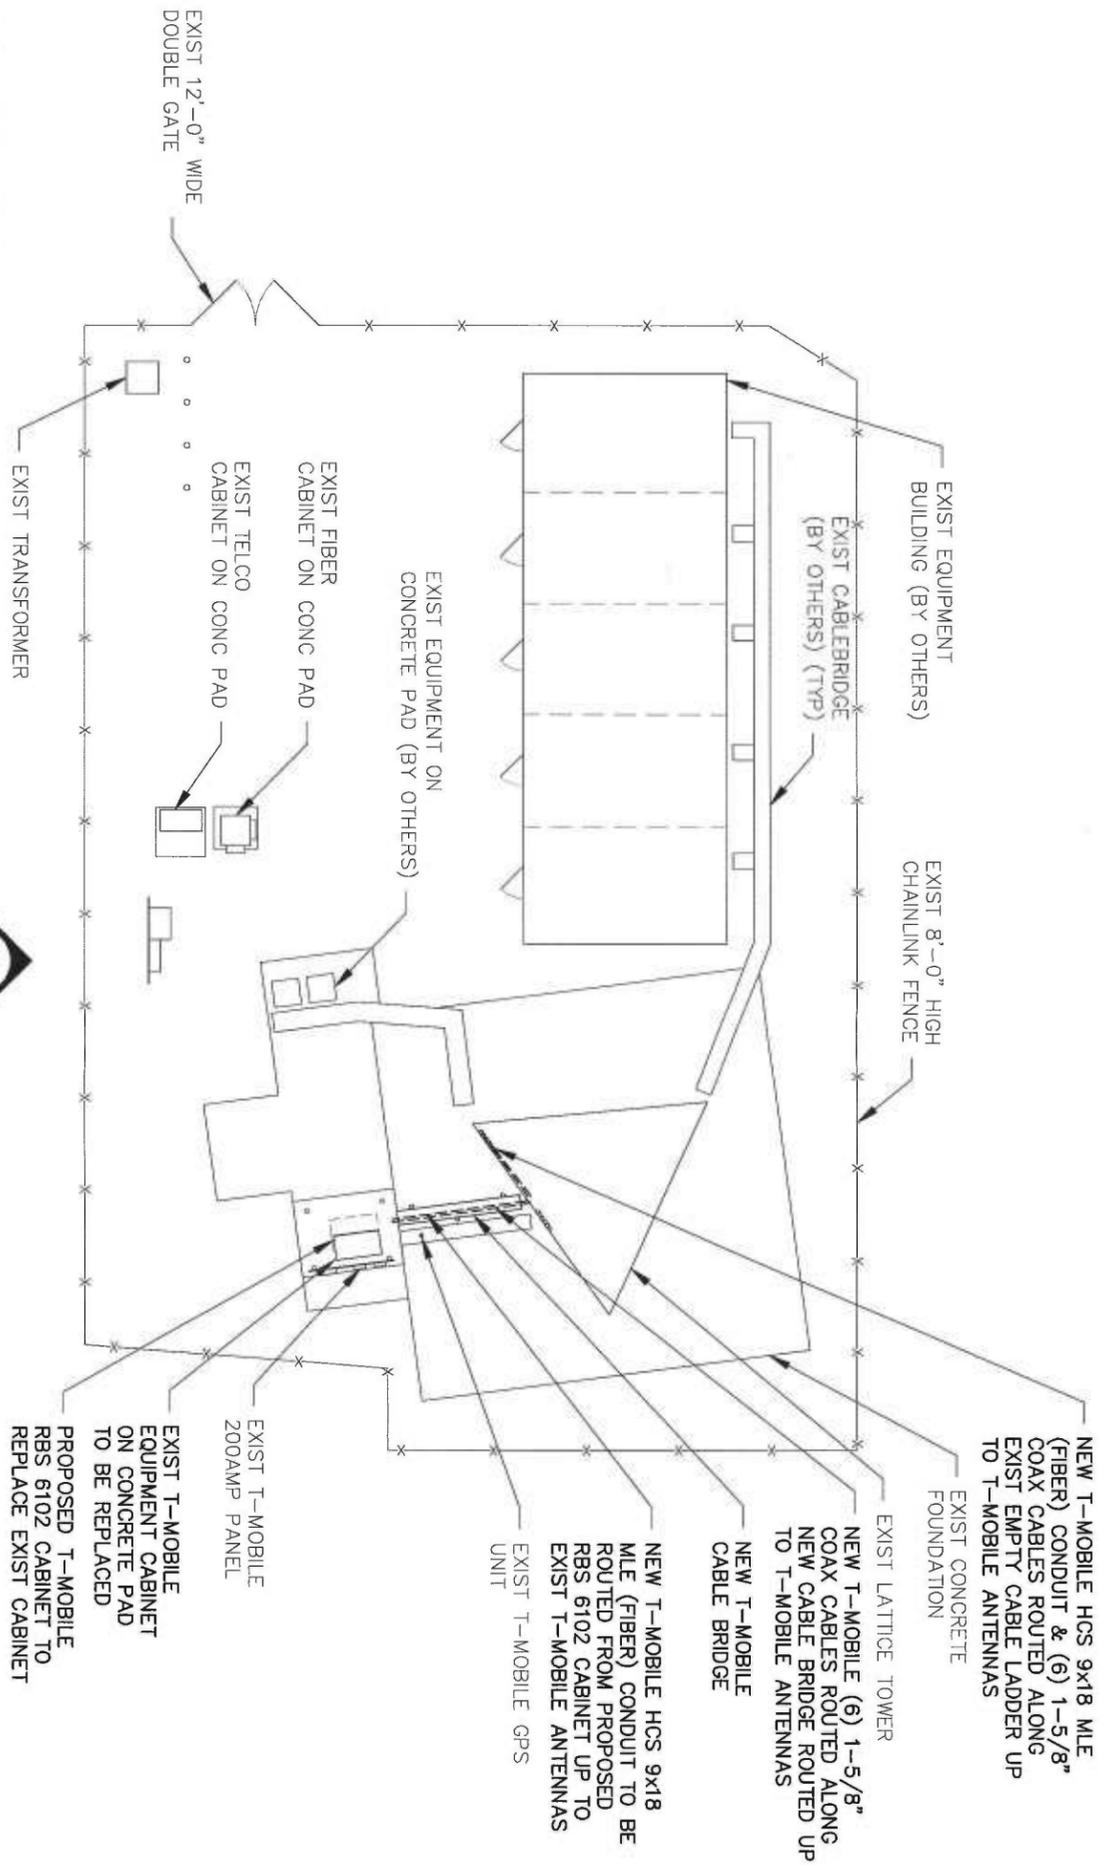

HCS LENGTH			
FROM EQUIPMENT CABINET TO ANTENNAS			
SECTOR	ALPHA	BETA	GAMMA
LENGTH	160'±	160'±	160'±
SIZE	1"		
9x18 MLE (1" OD, 1.03 LB/FT)			

- NOTES:
1. CONTRACTOR SHALL FIELD VERIFY THE ADEQUACY TO ROUTE THE HCS 9X18 MLE (FIBER) CABLES WITHIN THE EXISTING CABLE TRAY PRIOR TO CONSTRUCTION.
 2. CONTRACTOR TO MATCH ANTENNA AZIMUTHS AND DOWNLITS TO EXISTING CONDITION AND NOTIFY RF ENGINEER FOR ANY DISCREPANCY.
 3. CONTRACTOR TO RE-VERIFY CABLE LENGTHS PRIOR TO CONSTRUCTION.
 4. CONTRACTOR SHALL FIELD VERIFY EXISTING ANTENNA MOUNT CONDITIONS, AND TIGHTEN ALL LOOSE ASSOCIATED HARDWARE IF REQUIRED.
 5. NOT ALL SITE FEATURES ARE SHOWN FOR CLARITY.

1
A-1
SITE PLAN
SCALE: 1/16" = 1'-0"

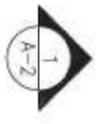

CONFIGURATION
2C

TECTONIC

PLANNING : SURVEYING
ENGINEERING : CONSTRUCTION MANAGEMENT
TECTONIC Engineering & Surveying Consultants P.C.

1279 Route 300
Newburgh, NY 12550
Phone: (845) 597-6656
Fax: (845) 597-8703

T-Mobile

NORTHEAST LLC.

T-MOBILE NORTHEAST, LLC
55 GREENFIELD ROAD SOUTH
BLOOMFIELD, CT 06002

APPROVALS

T-MOBILE LANDLORD _____
RF _____
CONSTRUCTION _____

PROJECT NUMBER 6203.011070B DESIGNED BY GL
REV DATE REVISION DRAWN BY

03/07/13	FOR COMMENT	MP
04/16/13	PER COMMENTS	SP
12/23/14	GENERAL REVISIONS	DC

ISSUED BY _____ DATE _____

SITE INFORMATION

CT11070B
150 BUTTERNUT HOLLOW RD
GREENWICH, CT
06830

SHEET TITLE
SITE PLAN

SHEET NUMBER
A-1

APPROVALS

T-MOBILE LANDLORD	RF	DESIGNED BY	GL
CONSTRUCTION		DRAWN BY	
PROJECT NUMBER	6203.CT11070B	REV. DATE	REVISION


Δ	03/07/13	FOR COMMENT	MP
Δ	04/16/13	PER COMMENTS	SP
Δ	12/23/14	GENERAL REVISIONS	DC

ISSUED BY	DATE

SITE INFORMATION	
CT11070B	150 BUTTERNUT HOLLOW RD GREENWICH, CT 06830

SHEET TITLE	
ELEVATION	
SHEET NUMBER	

CONFIGURATION
2C

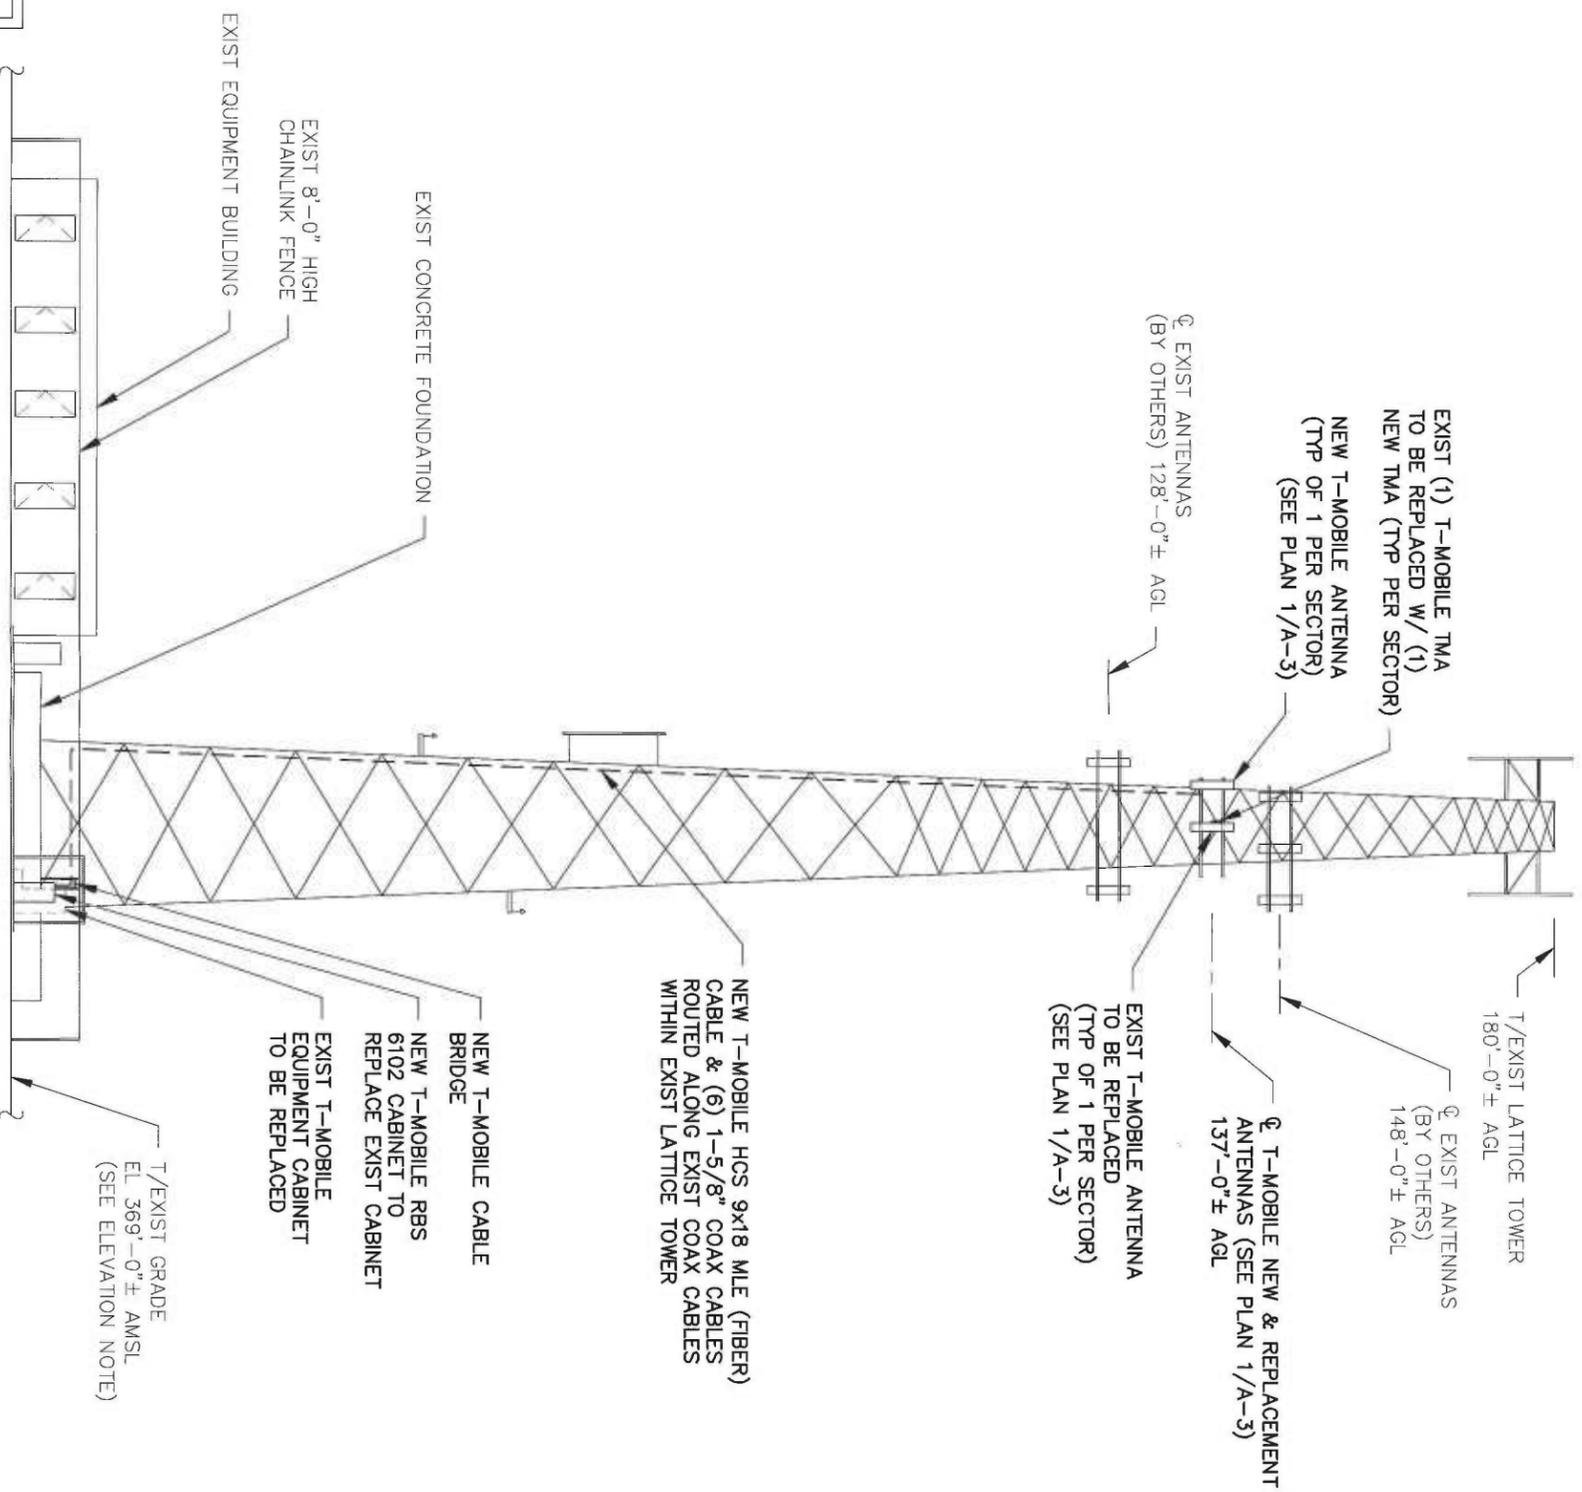

STRUCTURAL NOTE:
EXIST TOWER AND FOUNDATION EVALUATED FOR PROPOSED INSTALLATION BY URS CORPORATION AS OUTLINED IN THE DETAILED STRUCTURAL ANALYSIS REPORT DATED APRIL 15, 2013


ELEVATION NOTE:
ELEVATION OF EXIST SITE HAS BEEN ARBITRARILY ASSIGNED AS EL. 369'-0" ± TAKEN FROM U.S.G.S. QUAD MAP, AND DOES NOT NECESSARILY CORRESPOND TO ACTUAL ELEVATION ABOVE SEA LEVEL. ALL OTHER ELEVATIONS INDICATED WERE DETERMINED ON THIS BASIS.

NOTE: PROPOSED RAC24 CABINET NOT SHOWN FOR CLARITY.


ELEVATION
SCALE: 1" = 20'-0"

1
A-2

A-2

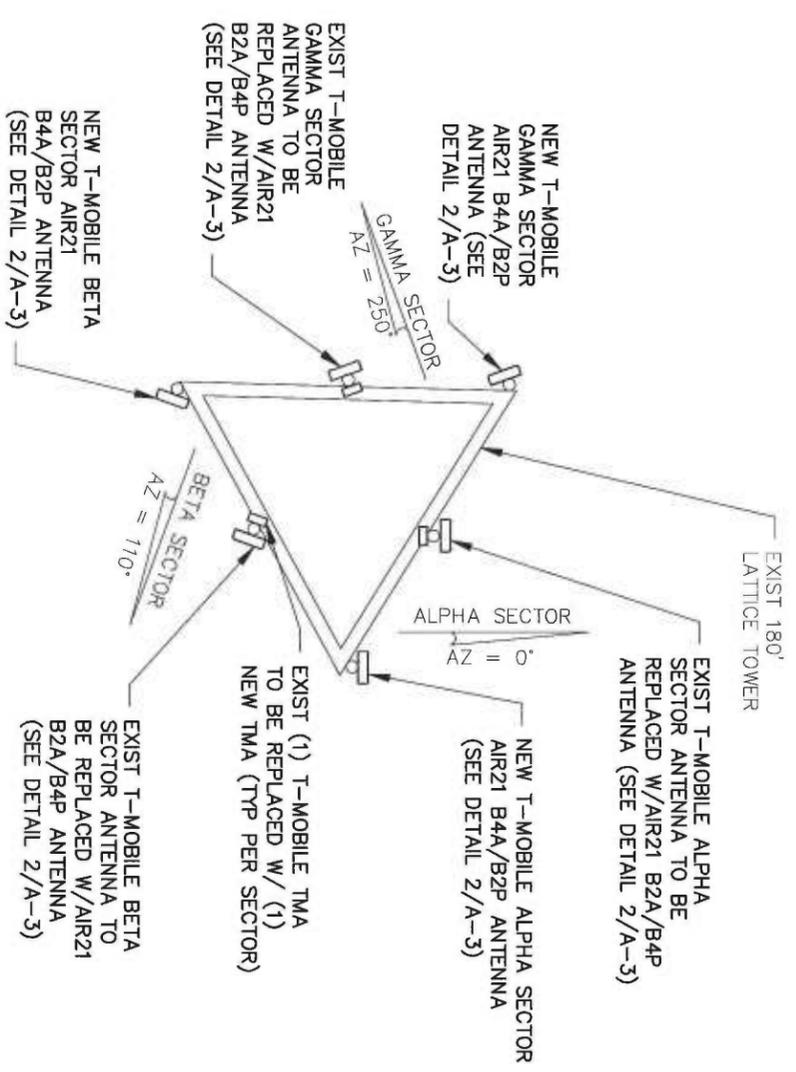

2 ANTENNA PLAN
SCALE: 3/16" = 1'-0"

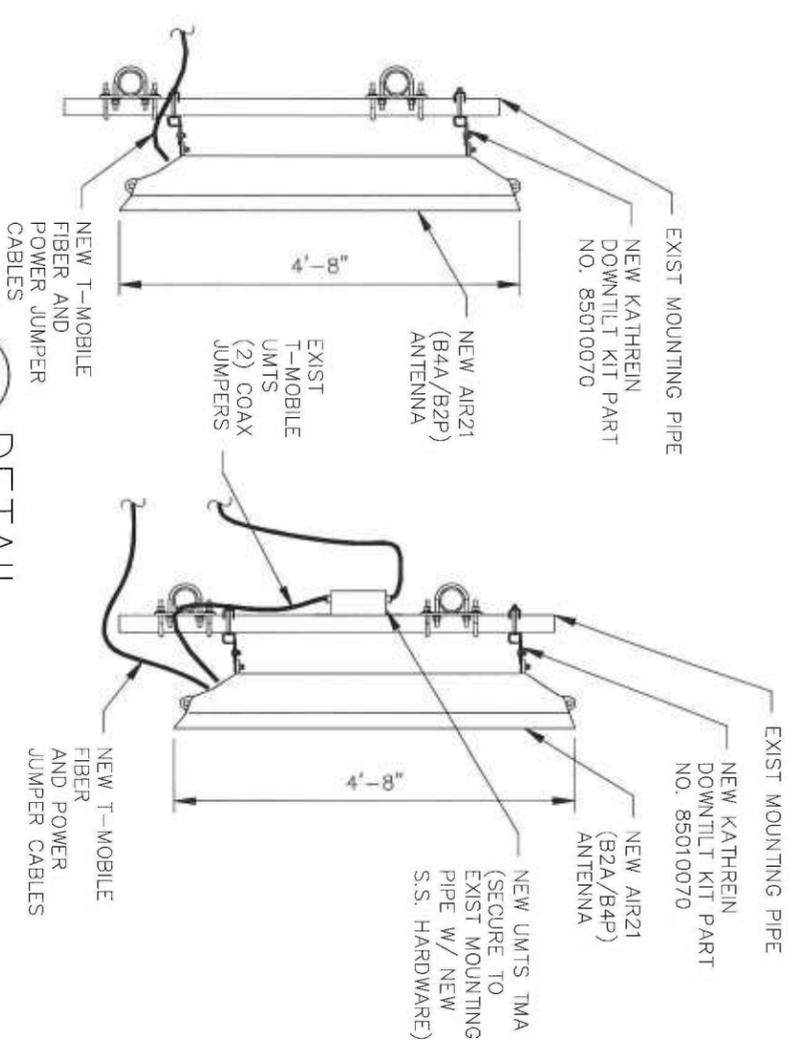

2 DETAIL
SCALE: 1/2" = 1'-0"



CONFIGURATION
2C

TECTONIC

• PLANNING • SURVEYING
• ENGINEERING • CONSTRUCTION MANAGEMENT
• CONSTRUCTION MANAGEMENT

TECTONIC Engineering & Surveying
Consultants P.C.

1279 Route 300
Newburgh, NY 12550
Phone: (845) 587-6656
Fax: (845) 587-8703

T-Mobile

NORTHEAST LLC.

T-MOBILE NORTHEAST, LLC
55 GREEN ROAD SOUTH
BLOOMFIELD, CT 06002

APPROVALS

LANDLORD _____

DESIGNED BY _____

PROJECT NUMBER 6203.011070B

DATE 03/07/13

REV	DATE	REVISION	DRAWN BY
Δ	03/07/13	FOR COMMENT	MP
Δ	04/16/13	PER COMMENTS	SP
Δ	12/23/14	GENERAL REVISIONS	DC

ISSUED BY	DATE

SITE INFORMATION

CT11070B
150 BUTTERNUT HOLLOW RD
GREENWICH, CT
06830

SHEET TITLE
ANTENNA PLAN &
DETAIL

SHEET NUMBER
A-3

GENERAL NOTES

1. CONTRACTOR SHALL NOT COMMENCE ANY WORK UNTIL HE OBTAINS, AT HIS OWN EXPENSE, ALL INSURANCE REQUIRED BY T-MOBILE, THE PROPERTY OWNER AND/OR PROPERTY MANAGEMENT COMPANY.
2. THIS SET OF PLANS HAS BEEN PREPARED FOR THE PURPOSES OF MUNICIPAL AND AGENCY REVIEW AND APPROVAL. THIS SET OF PLANS SHALL NOT BE UTILIZED AS CONSTRUCTION DOCUMENTS UNTIL ALL CONDITIONS OF APPROVAL HAVE BEEN SATISFIED AND EACH OF THE DRAWINGS HAVE BEEN REVISED TO INDICATE "ISSUED FOR CONSTRUCTION".
3. THIS PLAN IS SUBJECT TO ALL EASEMENTS AND RESTRICTIONS OF RECORD.
4. THE CONTRACTOR SHALL COMPLY WITH ALL APPLICABLE CODES, ORDINANCES, LAWS AND REGULATIONS OF ALL MUNICIPALITIES, UTILITIES OR OTHER PUBLIC AUTHORITIES.
5. THE CONTRACTOR SHALL BE RESPONSIBLE FOR OBTAINING ALL PERMITS AND INSPECTIONS THAT MAY BE REQUIRED BY ANY FEDERAL, STATE, COUNTY OR MUNICIPAL AUTHORITIES.
6. THE CONTRACTOR SHALL NOTIFY THE CONSTRUCTION MANAGER, IN WRITING, OF ANY CONFLICTS, ERRORS OR OMISSIONS PRIOR TO THE SUBMISSION OF BIDS OR PERFORMANCE OF WORK. MINOR OMISSIONS OR ERRORS IN THE BID DOCUMENTS SHALL NOT EXCUSE SAID CONTRACTOR FROM COMPLETING THIS PROJECT IN ACCORDANCE WITH THE OVERALL INTENT OF THESE DRAWINGS.
7. THE CONTRACTOR SHALL BE RESPONSIBLE FOR PROTECTING ALL EXISTING SITE IMPROVEMENTS PRIOR TO COMMENCING CONSTRUCTION. THE CONTRACTOR SHALL REPAIR ANY DAMAGE CAUSED AS A RESULT OF CONSTRUCTION OF THIS FACILITY.
8. THE SCOPE OF WORK FOR THIS PROJECT SHALL INCLUDE PROVIDING ALL MATERIALS, EQUIPMENT AND LABOR REQUIRED TO COMPLETE THIS PROJECT. ALL EQUIPMENT SHALL BE INSTALLED IN ACCORDANCE WITH THE MANUFACTURER'S RECOMMENDATIONS.
9. THE CONTRACTOR SHALL VISIT THE PROJECT SITE PRIOR TO SUBMITTING A BID TO VERIFY THAT THE PROJECT CAN BE CONSTRUCTED IN ACCORDANCE WITH THE CONTRACT DOCUMENTS.
10. POWER TO THE FACILITY IS MONITORED BY AN EXISTING METER.
11. ALL STRUCTURAL ELEMENTS SHALL BE HOT DIP GALVANIZED STEEL.
12. CONTRACTOR SHALL MAKE A UTILITY "ONE CALL" TO LOCATE ALL UTILITIES PRIOR TO EXCAVATING.
13. IF ANY PIPING EXISTS BENEATH THE SITE AREA, CONTRACTOR MUST LOCATE IT AND CONTACT OWNER'S REPRESENTATIVE.
14. THE CONSTRUCTION CONTRACTOR IS SOLELY RESPONSIBLE FOR DETERMINING ALL CONSTRUCTION MEANS AND METHODS. THE CONSTRUCTION CONTRACTOR IS ALSO RESPONSIBLE FOR ALL JOB SITE SAFETY.
15. CONTRACTOR SHALL FIELD VERIFY ALL DIMENSIONS, ELEVATIONS, ANGLES AND EXISTING CONDITIONS AT THE SITE PRIOR TO FABRICATION AND/OR INSTALLATION OF ANY WORK IN THE CONTRACT AREA AND SUBMIT TO THE ENGINEER ANY DISCREPANCIES FROM THE DRAWINGS.
16. THE CONTRACTOR IS TO REVIEW ALL DRAWINGS AND SPECIFICATIONS IN THE CONTRACT DOCUMENT SET. THE CONTRACTOR SHALL COORDINATE ALL WORK SHOWN IN THE SET OF DRAWINGS. THE CONTRACTOR SHALL PROVIDE A COMPLETE SET OF DRAWINGS TO ALL SUB-CONTRACTORS AND RELATED PARTIES. THE SUB-CONTRACTOR SHALL EXAMINE ALL THE DRAWINGS AND SPECIFICATIONS FOR THE INFORMATION THAT AFFECTS THEIR WORK.
17. DETAILS ARE INTENDED TO SHOW END RESULT OF DESIGN. MINOR MODIFICATIONS MAY BE REQUIRED TO SUIT JOB DIMENSIONS OR CONDITIONS, AND SUCH MODIFICATIONS SHALL BE INCLUDED AS PART OF THE WORK.
18. ALL MATERIAL PROVIDED BY T-MOBILE IS TO BE REVIEWED BY THE CONTRACTOR AND ALL APPLICABLE SUB-CONTRACTORS PRIOR TO INSTALLATION. ANY DEFICIENCIES TO PROVIDE MATERIALS SHALL BE BROUGHT TO THE CONSTRUCTION MANAGER'S ATTENTION IMMEDIATELY.
19. THE MATERIALS INSTALLED SHALL MEET REQUIREMENTS OF CONTRACTORS DOCUMENTS. NO SUBSTITUTIONS ARE ALLOWED.

GENERAL NOTES

20. THE CONTRACTOR SHALL RECEIVE CLARIFICATION AND AUTHORIZATION IN WRITING TO PROCEED BEFORE STARTING WORK ON ANY ITEMS NOT CLEARLY DEFINED OR IDENTIFIED BY THE CONSTRUCTION DOCUMENTS.
21. THE CONTRACTOR SHALL NOTIFY THE CONSTRUCTION MANAGER OF ALL PRODUCTS OR ITEMS NOTED AS "EXISTING" WHICH ARE NOT FOUND TO BE IN THE FIELD.
22. ERECTION SHALL BE DONE IN A WORKMANLIKE MANNER BY COMPETENT EXPERIENCED WORKMEN IN ACCORDANCE WITH APPLICABLE CODES AND THE BEST-ACCEPTED PRACTICE. ALL MEMBERS SHALL BE LAID PLUMB AND TRUE AS INDICATED ON THE DRAWINGS.
23. THE CONTRACTOR SHALL COORDINATE HIS WORK AND SCHEDULE HIS ACTIVITIES AND WORKING HOURS IN ACCORDANCE WITH THE REQUIREMENTS OF THE PROPERTY OWNER AND/OR PROPERTY MANAGEMENT COMPANY.
24. THE CONTRACTOR SHALL BE RESPONSIBLE FOR COORDINATING HIS WORK WITH THE WORK OF OTHERS AS IT MAY RELATE TO RADIO EQUIPMENT, ANTENNAS AND ANY OTHER PORTIONS OF THE WORK.
25. THE CONTRACTOR SHALL INSTALL ALL EQUIPMENT AND MATERIALS IN ACCORDANCE WITH THE MANUFACTURER'S RECOMMENDATIONS UNLESS SPECIFICALLY INDICATED OR WHERE LOCAL CODES OR REGULATIONS MAY TAKE PRECEDENCE.
26. THE CONTRACTOR SHALL REPAIR ALL EXISTING SURFACES DAMAGED DURING CONSTRUCTION SUCH THAT THEY MATCH AND BLEND WITH ADJACENT SURFACES.
27. THE CONTRACTOR SHALL KEEP CONTRACT AREA CLEAN, HAZARD FREE AND DISPOSE OF ALL DEBRIS AND RUBBISH. EQUIPMENT NOT SPECIFIED AS REMAINING ON THE PROPERTY OF THE OWNER SHALL BE REMOVED. LEAVE PREMISES IN CLEAN CONDITIONS AND FREE FROM PAINT SPOTS, DUST OR SMUDGES OF ANY NATURE. THE CONTRACTOR SHALL BE RESPONSIBLE FOR MAINTAINING ALL ITEMS UNTIL COMPLETION OF CONSTRUCTION.
28. BEFORE FINAL ACCEPTANCE OF THE WORK, THE CONTRACTOR SHALL REMOVE ALL EQUIPMENT, TEMPORARY WORK, UNUSED AND USELESS MATERIALS, RUBBISH AND TEMPORARY STRUCTURES.
29. CONSTRUCTION SHALL BE IN ACCORDANCE WITH 2005 STATE OF CONNECTICUT BUILDING CODE AND THE TIA/EIA-222-F STRUCTURAL STANDARD FOR STEEL ANTENNA TOWERS AND ANTENNA SUPPORTING STRUCTURES.

CONFIGURATION
2C



TECTONIC
 • PLANNING • SURVEYING
 • ENGINEERING • CONSTRUCTION
 • MANAGEMENT

TECTONIC Engineering & Surveying
 Consultants P.C.
 1279 Route 300
 Newburgh, NY 12550
 Phone: (845) 567-6856
 Fax: (845) 567-8703

T-Mobile
 NORTHEAST LLC.

T-MOBILE NORTHEAST, LLC
 35 GREEN ROAD SOUTH
 BLOOMFIELD, CT 06002

APPROVALS
 T-MOBILE _____
 LANDLORD _____
 RE: _____
 CONSTRUCTION _____

PROJECT NUMBER 6203.CT11070B	DESIGNED BY GL
REV DATE REVISION	DRAWN BY
03/07/13 FOR COMMENT	MP
04/16/13 PER COMMENTS	SP
12/23/14 GENERAL REVISIONS	DC

ISSUED BY	DATE

SITE INFORMATION
 CT11070B
 150 BUTTERNUT HOLLOW RD
 GREENWICH, CT
 06830

NOTES
 SHEET TITLE
 SHEET NUMBER

A-5

GROUNDING NOTES

1. THE ENTIRE ELECTRICAL INSTALLATION SHALL BE GROUNDED AS REQUIRED BY ALL APPLICABLE CODES.
2. ALL GROUNDING WORK SHALL BE IN ACCORDANCE WITH T-MOBILE STANDARD PRACTICE.
3. ALL BUS CONNECTORS SHALL BE TWO-HOLE, LONG-BARREL TYPE COMPRESSION LUGS, T&B OR EQUAL, UNLESS OTHERWISE NOTED ON DRAWINGS. ALL LUGS SHALL BE ATTACHED TO BUSES USING BOLTS, NUTS, AND LOCK WASHERS. NO WASHERS ARE ALLOWED BETWEEN THE ITEMS BEING GROUNDED.
4. ALL CONNECTORS SHALL BE CRIMPED USING HYDRAULIC CRIMPING TOOLS, T&B #TBM 8 OR EQUIVALENT.
5. ALL CONNECTIONS SHALL BE MADE TO BARE METAL. ALL PAINTED SURFACES SHALL BE FILED TO ENSURE PROPER CONTACT. NO WASHERS ARE ALLOWED BETWEEN THE ITEMS BEING GROUNDED. ALL CONNECTIONS ARE TO HAVE A NON-OXIDIZING AGENT APPLIED PRIOR TO INSTALLATION.
6. ALL COPPER BUSES SHALL BE CLEANED, POLISHED, AND A NON-OXIDIZING AGENT APPLIED. NO FINGERPRINTS OR DISCOLORED COPPER WILL BE PERMITTED.
7. ALL BENDS SHALL BE AS SHALLOW AS POSSIBLE, WITH NO TURN SHORTER THAN AN 8-INCH NOMINAL RADIUS.
8. GROUNDING CONDUCTORS SHALL BE SOLID TINNED COPPER AND ANNEALED #2. ALL GROUNDING CONDUCTORS SHALL RUN THROUGH PVC SLEEVES WHEREVER CONDUCTORS RUN THROUGH WALLS, FLOORS, OR CEILINGS. IF CONDUCTORS MUST RUN THROUGH EMT, BOTH ENDS OF CONDUIT SHALL BE GROUNDED. SEAL BOTH ENDS OF CONDUIT WITH SILICONE CAULK.
9. GROUNDING SYSTEM RESISTANCE SHALL NOT EXCEED 10 OHMS. IF THE RESISTANCE VALUE IS EXCEEDED, NOTIFY THE PROJECT MANAGER FOR FURTHER INSTRUCTION ON METHODS FOR REDUCING THE RESISTANCE VALUE.
10. ALL ROOF TOP ANTENNA MOUNTS SHALL BE GROUNDED WITH A #2 GROUND WIRE CONNECTED TO THE NEAREST GROUND BUS. ALL CONNECTIONS ARE TO BE CAD-WELDED IF POSSIBLE.
11. UPON COMPLETION OF WORK, CONDUCT CONTINUITY, SHORT CIRCUIT, AND FALL OF POTENTIAL GROUNDING TESTS FOR APPROVAL. SUBMIT TEST REPORTS TO THE PROJECT MANAGER.
12. GROUNDING CONNECTION TO TRAVEL IN A DOWNWARD DIRECTION.
13. ALL EXPOSED #2 WIRE MUST BE TINNED BTW.
14. TECTONIC TAKES NO RESPONSIBILITY OR LIABILITY FOR THE GROUNDING SYSTEM AS SHOWN ON THIS SITE. THIS IS A STANDARD GROUNDING SYSTEM.

TECTONIC
 • PLANNING • SURVEYING
 • ENGINEERING • CONSTRUCTION
 MANAGEMENT
Tectonic Engineering & Surveying
 Consultants P.C.
 1279 Route 300
 Newburgh, NY 12550
 Phone: (845) 567-6656
 Fax: (845) 567-6703

T-Mobile
 NORTHEAST LLC.
 T-MOBILE NORTHEAST, LLC.
 35 GREEN RIDGE SOUTH
 BLOOMFIELD, CT 06002

T-MOBILE _____
 LANDLORD _____
 RF _____
 CONSTRUCTION _____
 APPROVALS _____

PROJECT NUMBER	6203.0T11070B	DESIGNED BY	SL
REV DATE	03/07/13	REVISION	FOR COMMENT
	04/16/13		PER COMMENTS
	12/23/14		GENERAL REVISIONS
			DC

ISSUED BY	DATE

SITE INFORMATION
 CT11070B
 150 BUTTERNUT HOLLOW RD
 GREENWICH, CT
 06830

CONFIGURATION
 2C



NOTES

SHEET TITLE

SHEET NUMBER

A-6