Google Maps 265 S Orange St



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265 S Orange St













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265 S Orange St, New Haven, CT 06510



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A2204 PROJECT NUMBER PROJECT NAME SITE PLA Parcel 1C, Reasearch Lab/Office Building SITE PL ISSUE DATE 11/17/22

ARCHITECT OF RECORD

PELLI CLARKE AND PARTNERS

1056 CHAPEL ST
NEW HAVEN, CT 06510
CONTACT NAME: Mariko Masuoka
PHONE: 203-777-2515
EMAIL: mmasuoka@pcparch.com

ASSOCIATE ARCHITECT

JACOBS

120 ST JAMES AVE #5
BOSTON, MA 20116
CONTACT NAME: Chris Leary
PHONE: 617-242-9222
EMAIL: chris.leary@jacobs.com

CIVIL ENGINEER

FUSS AND O'NEILL

59 ELM STREET, SUITE 500 NEW HAVEN, CT 06510 CONTACT NAME: Joe Lenehan PHONE: 203-374-3748 EMAIL: jlenehan@fando.com



STRUCTURAL ENGINEER

McNAMARA SALVIA

10 FEDERAL ST, SUITE 1100
BOSTON, MA 02110
CONTACT NAME: Adam McCarthy
PHONE: 617-737-0040
EMAIL: mccarthy@mcsal.com

MEP ENGINEER

BR + A CONSULTING ENGINEERS

10 GUEST ST, 4th FLOOR BOSTON, MA 02135 CONTACT NAME: Jonathan Chan PHONE: 617-254-0016 EMAIL: jchan@brplusa.com

SUSTAINABILITY & LIGHTING CONSULTANT

ATELIER TEN

104 WEST 29th STREET, 8th FLOOR
NEW YORK, NY 10001
CONTACT NAME: Junko Nakagawa
PHONE: 212-254-4500
EMAIL: junko.nakagawa@atelierten.com

LANDSCAPE ARCHITECT

WESLEY STOUT ASSOCIATES

96 MAIN STREET
NEW CANAAN, CT 06840
CONTACT NAME: Wesley Stout
PHONE: 203-966-3100
EMAIL: wstout@wesleystout.com

FACADE ENGINEER

WISS, JANNEY, ELSTNER ASSOCIATES

2 TRAP FALLS ROAD, SUITE 502 SHELTON, CT 06484 CONTACT NAME: SARAH SINUSAS PHONE: 203-447-5933 EMAIL: ssinusas@wje.com VERTICAL TRANSPORTATION ENGINEER

LERCH BATES


600 WEST FULTON, SUITE 501
CHICAGO, IL 60661
CONTACT NAME: Theresa Christy
PHONE: 860-214-4272
EMAIL: theresa.christy@lerchbates.com



701 MAIN STREET, SUITE 200, DURHAM, NC 27701

SQUARE 10
PARCEL 1C RESEARCH LAB/OFFICE BUILDING
275 South Orange Street, New Haven, CT 06510
November 17, 2022

EXAMINED BY:	DATE:										

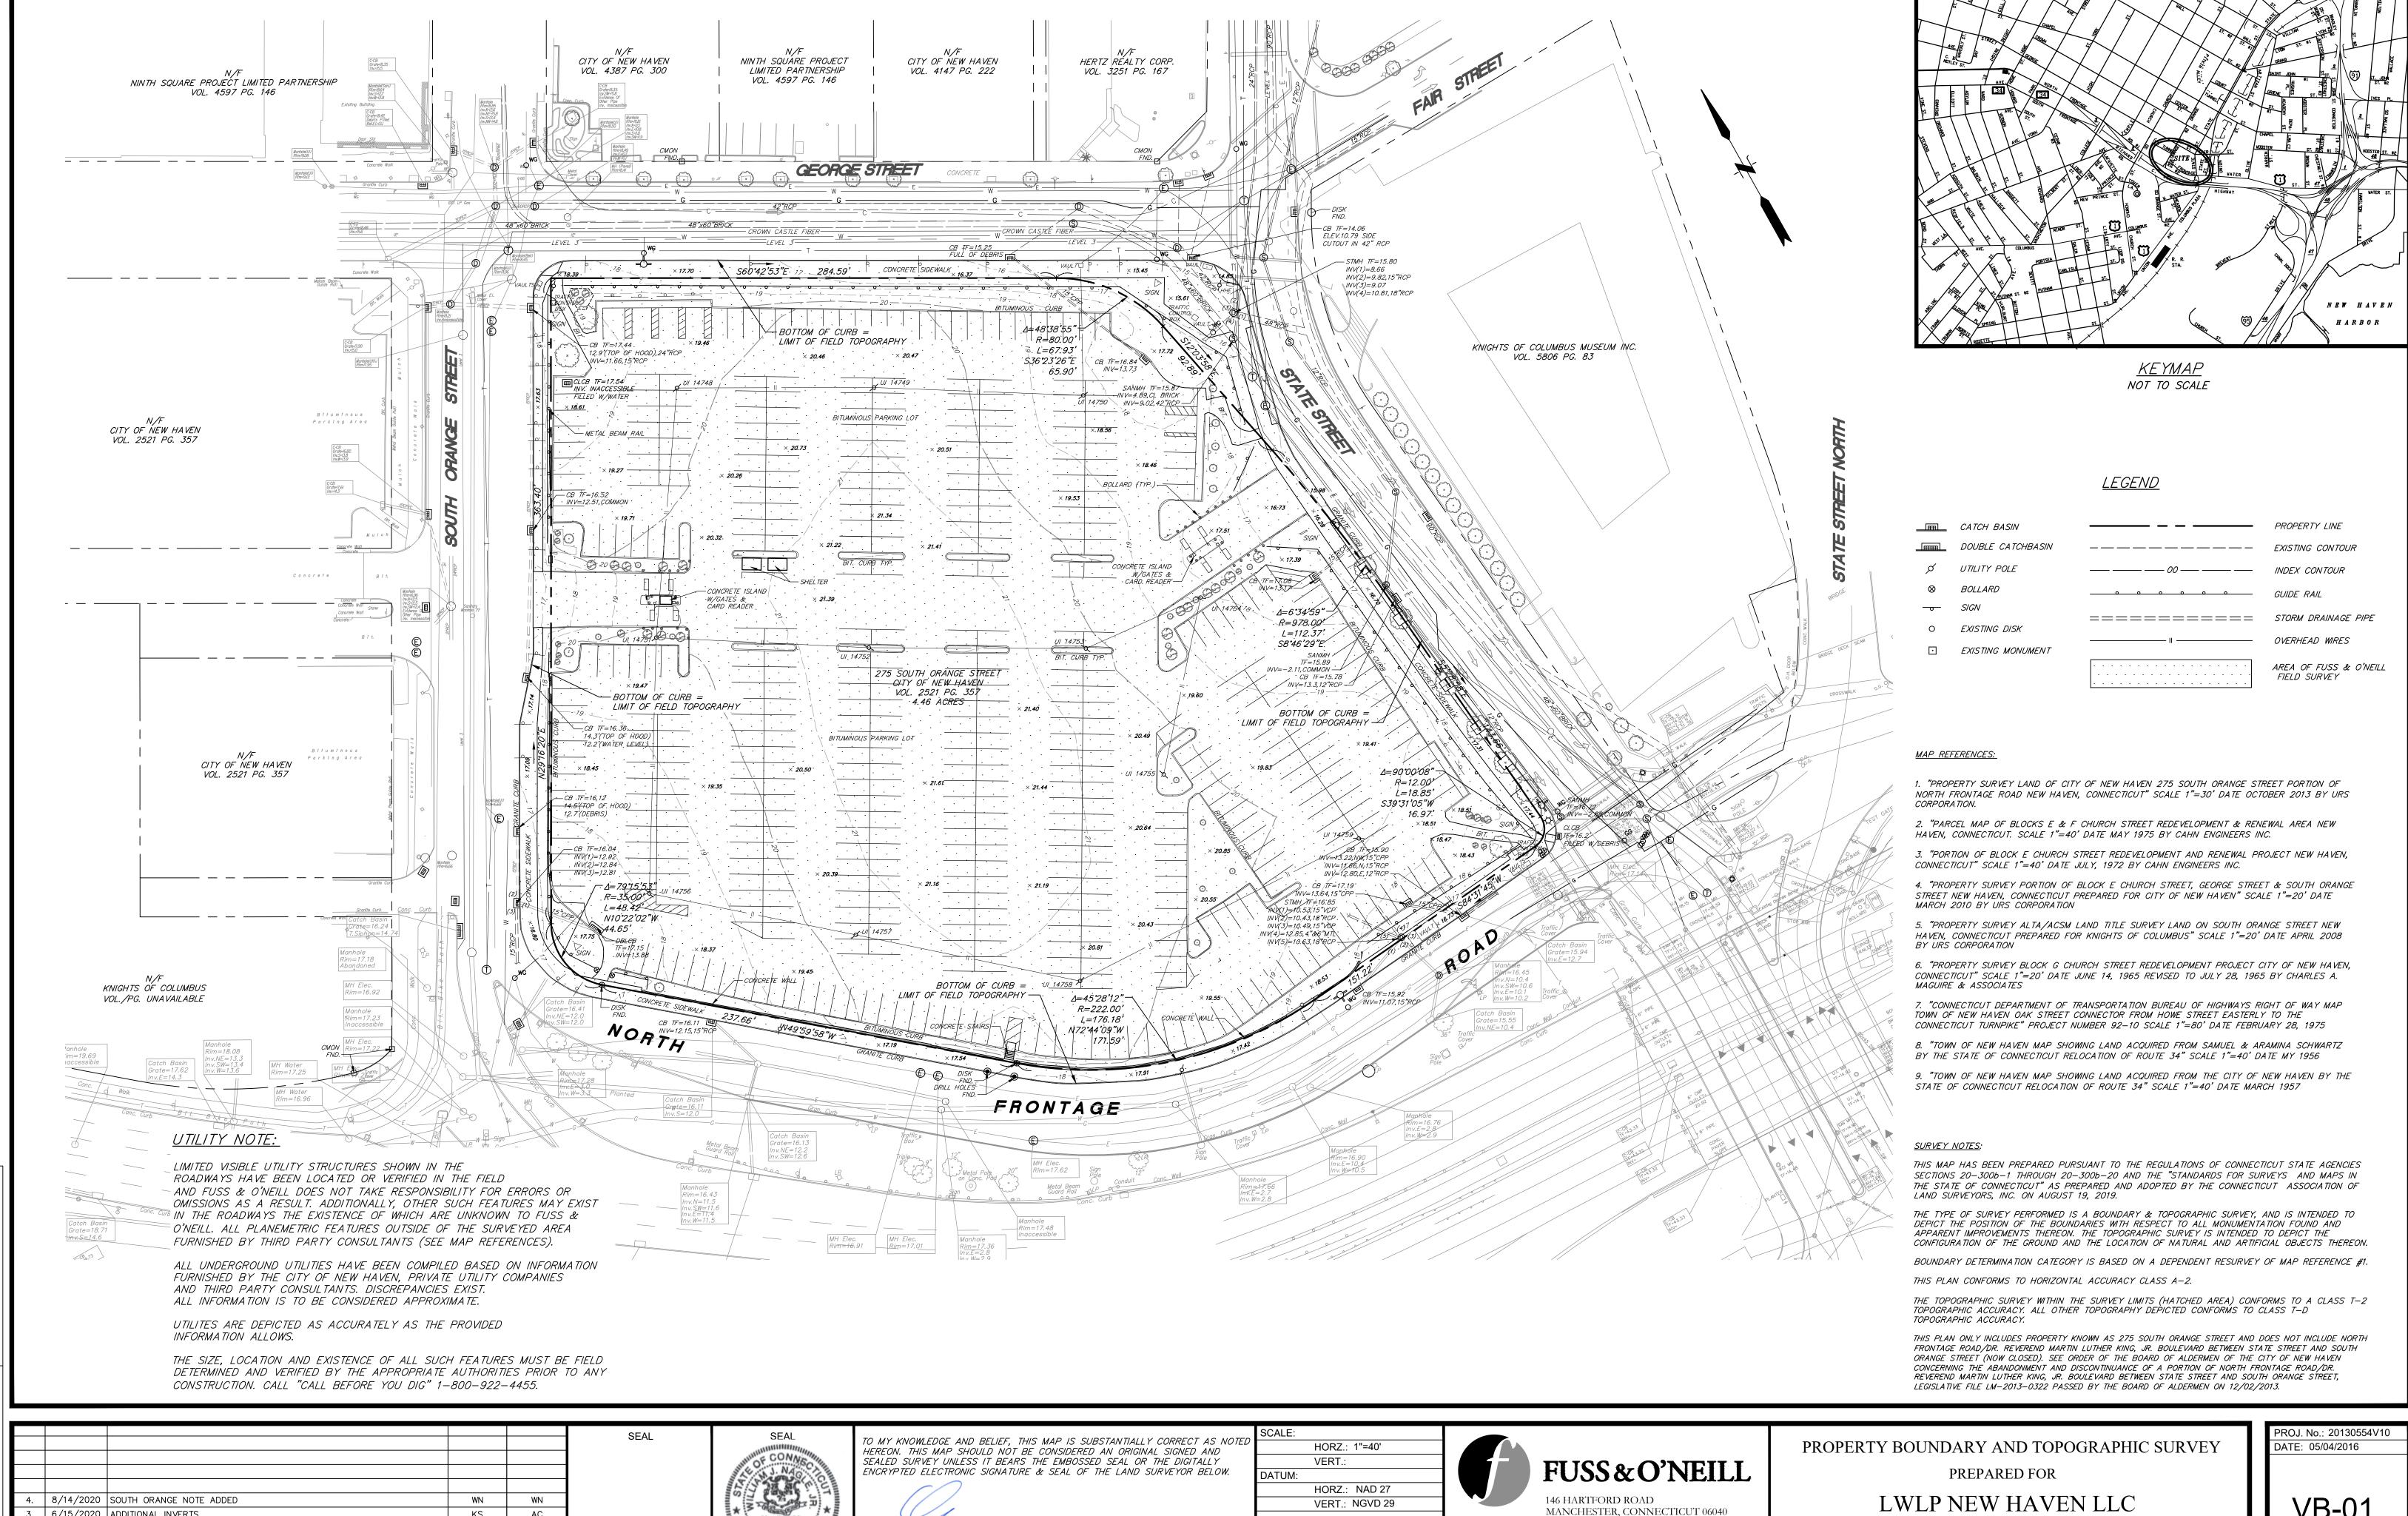

LICENSE # 70269

GRAPHIC SCALE

6/15/2020 ADDITIONAL INVERTS

DATE

6/9/2020 EXTENDED FIELD SHOT TOPOGRAPHY TO INCLUDE CURBING ALONG STREET

DESCRIPTION

5/13/2020 ADD UTILITIES GEORGE STREET AND STATE STREET

KS

KS

DESIGNER | REVIEWE

AC


WN

WILLIAM J. NAGLE, JR.

860.646.2469

www.fando.com

275 SOUTH ORANGE STREET NEW HAVEN, CONNECTICUT

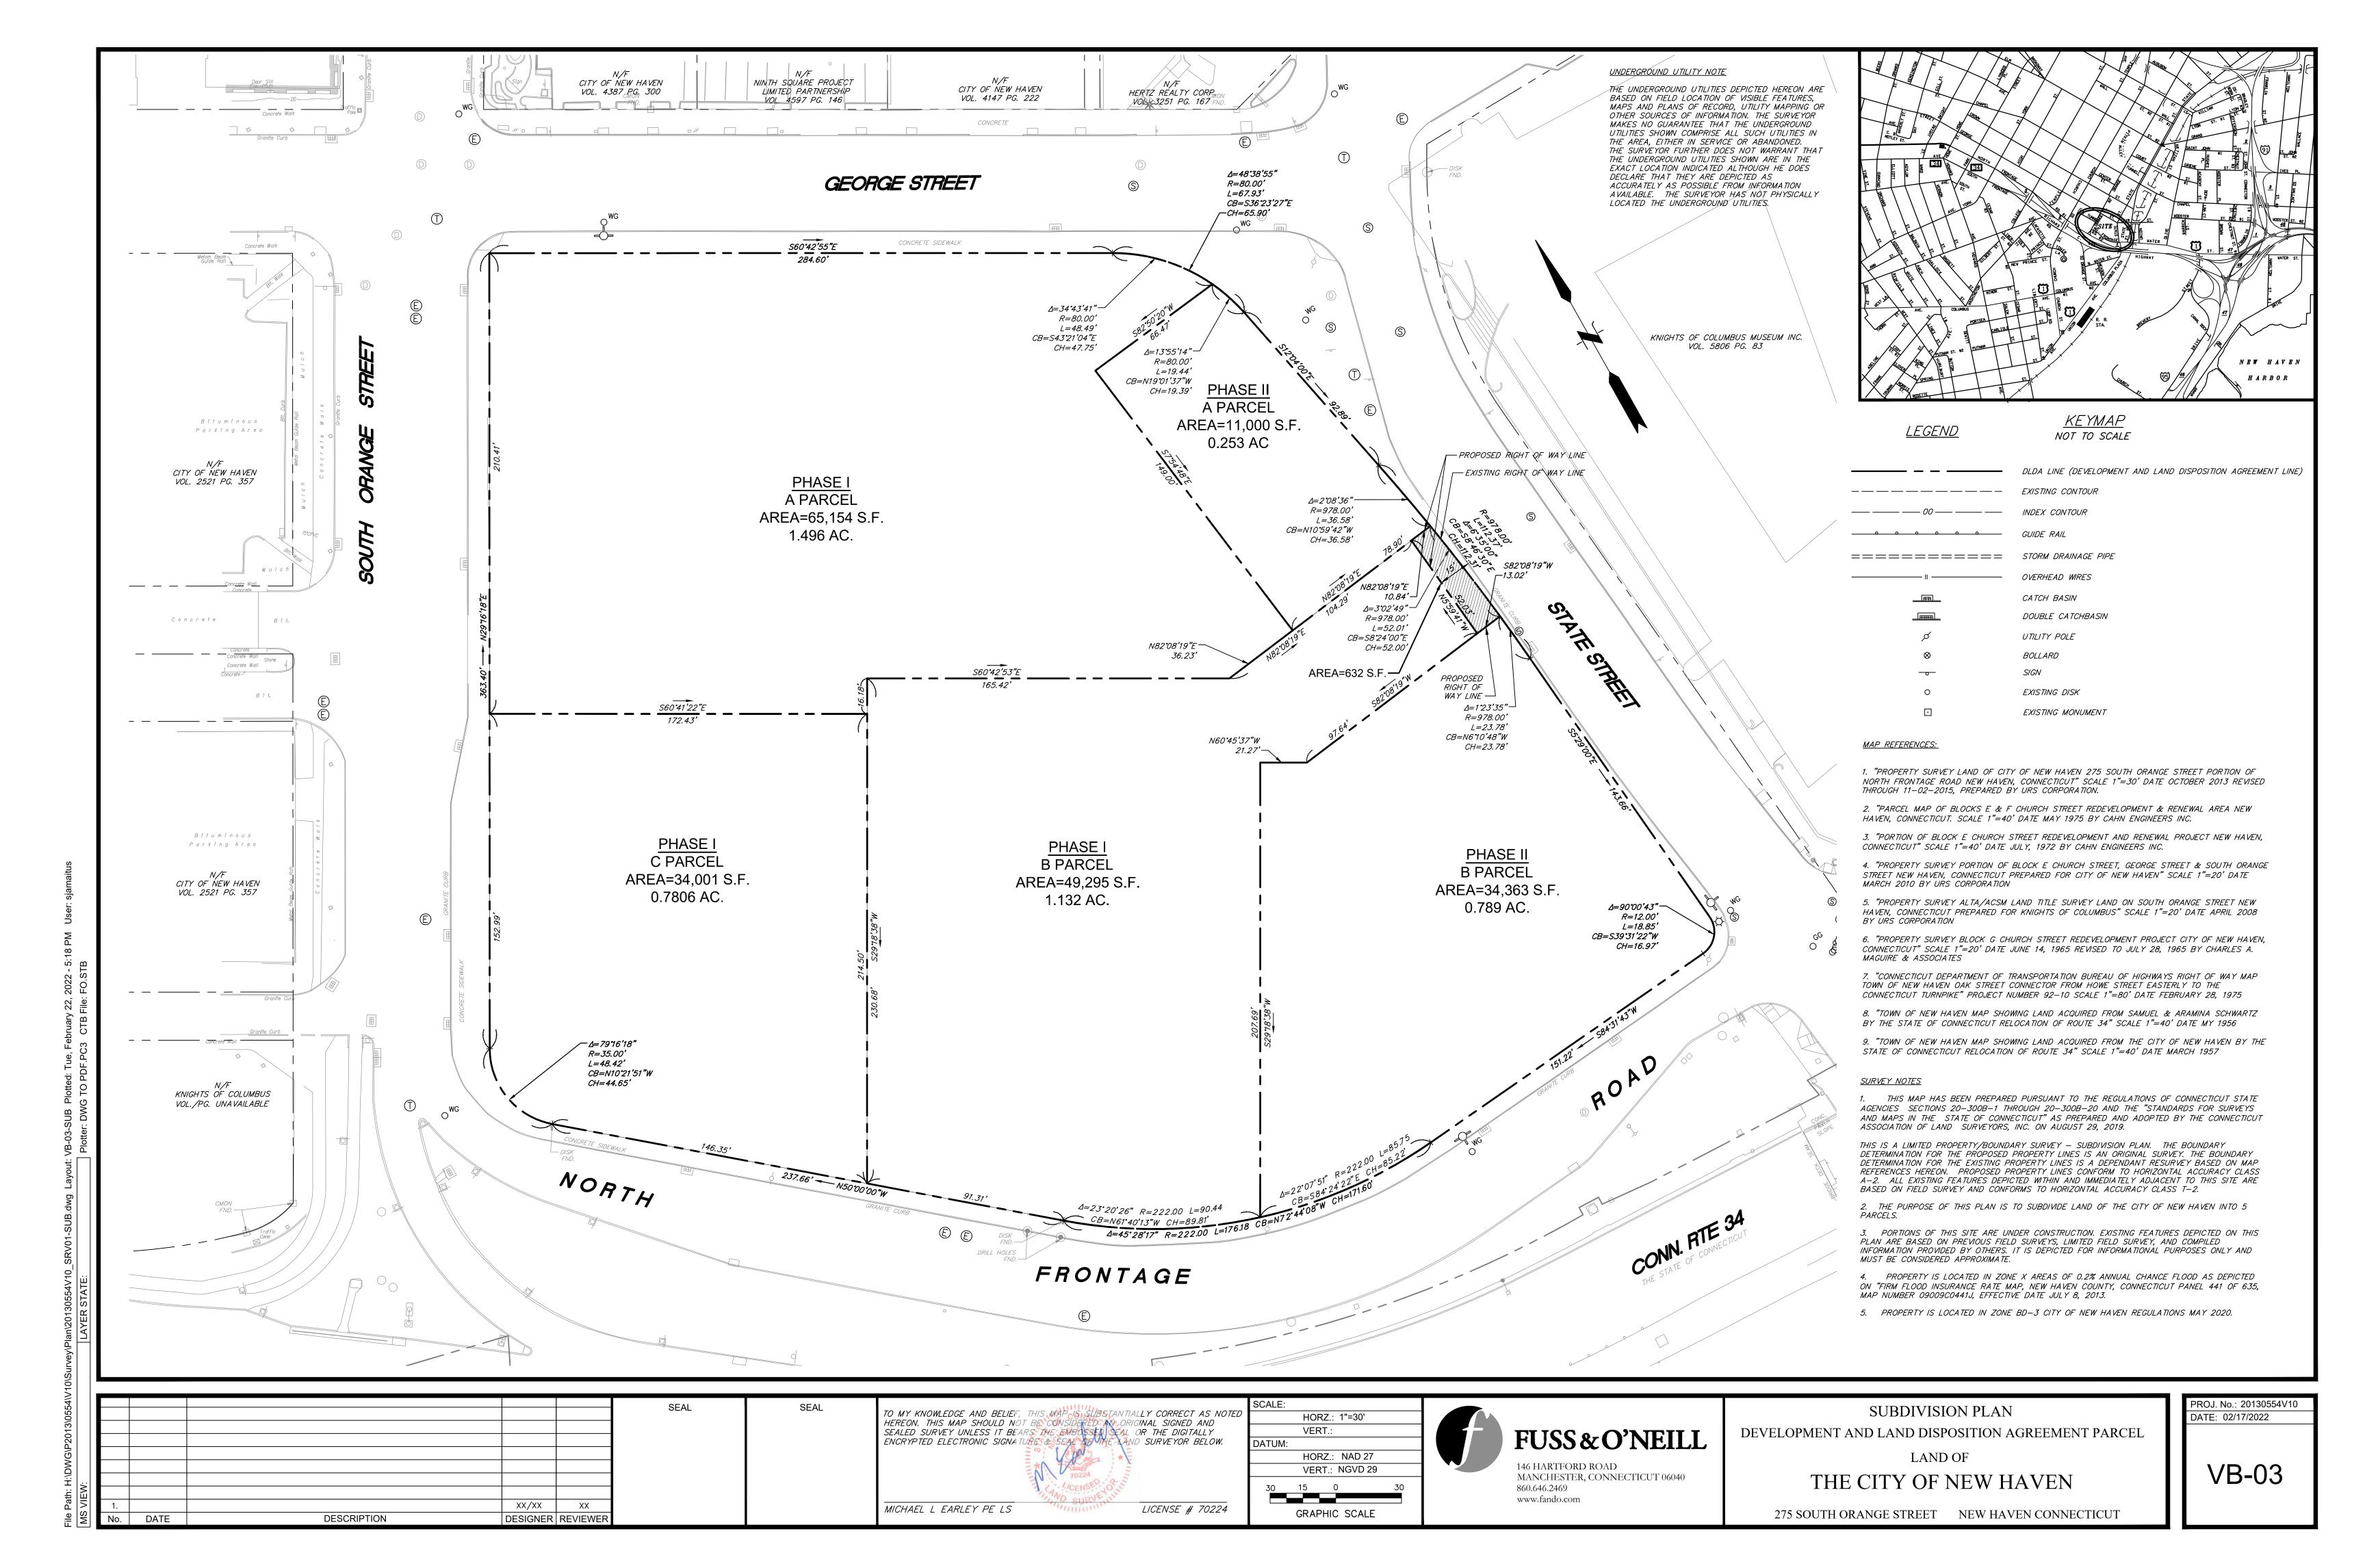

CIVIL GENERAL NOTES

GENERAL

- 1. SYMBOLS AND LEGENDS OF PROJECT FEATURES ARE GRAPHIC REPRESENTATIONS AND ARE NOT NECESSARILY SHOWN ON THE DRAWINGS TO SCALE OR TO THEIR ACTUAL DIMENSION OR LOCATION. COORDINATE DETAIL SHEET DIMENSIONS, MANUFACTURERS' LITERATURE, SHOP DRAWINGS AND FIELD MEASUREMENTS OF SUPPLIED PRODUCTS FOR LAYOUT OF THE PROJECT FEATURES.
- 2. DO NOT RELY SOLELY ON ELECTRONIC VERSIONS OF DRAWINGS. SPECIFICATIONS. AND DATA FILES THAT ARE PROVIDED BY THE ENGINEER. FIELD VERIFY LOCATION OF PROJECT FEATURES.
- 3. PERFORM NECESSARY CONSTRUCTION NOTIFICATIONS. APPLY FOR AND OBTAIN NECESSARY PERMITS, PAY FEES, AND POST BONDS ASSOCIATED WITH THE WORK AS REQUIRED BY THE CONTRACT DOCUMENTS.
- 4. SEE ARCHITECTURAL DRAWINGS FOR DIMENSIONS OF BUILDINGS AND ADJACENT SITE ELEMENTS INCLUDING SIDEWALKS, RAMPS, BUILDING ENTRANCES, STAIRWAYS, UTILITY PENETRATIONS, CONCRETE DOOR PADS, COMPACTOR PAD, LOADING DOCKS, BOLLARDS, ETC.
- 5. BASE PLAN: THE PROPERTY LINES SHOWN WERE DETERMINED BY AN ACTUAL FIELD SURVEY CONDUCTED BY FUSS & O'NEILL, INC. AND FROM PLANS OF RECORD, "CITY OF NEW HAVEN CONNECTICUT PLANIMETRIC MAP", SCALE 1"=40', AND "DOWNTOWN CROSSING PHASE 2 ORANGE STREET GATEWAY - GENERAL ROADWAY PLAN", SCALE 1"=40', DATED 4/20/21 - REV'D 4/21/21. THE TOPOGRAPHY AND PHYSICAL FEATURES ARE BASED ON AN ACTUAL FIELD SURVEY PERFORMED ON THE GROUND BY FUSS & O'NEILL. INC.
- 6. PROJECT SUBJECT TO STATE AND LOCAL PERMITS AND DEVELOPMENT AND LAND DISPOSITION AGREEMENT (DLDA) WITH CITY OF NEW HAVEN.
- 7. PRIOR TO COMPLETION OF PROJECT CONSTRUCTION AND FINAL CLOSEOUT OF PROJECT, SURVEY MARKERS SHALL BE INSTALLED ALONG THE RIGHT OF WAY LINES AT ALL ANGLE POINTS, AS PER CITY OF NEW HAVEN STANDARDS.

WORK RESTRICTIONS

1. DO NOT CLOSE OR OBSTRUCT ROADWAYS, SIDEWALKS, FIRE HYDRANTS, AND UTILITIES WITHOUT APPROPRIATE PERMITS.

REGULATORY REQUIREMENTS

- 1. WITHIN LOCAL RIGHTS-OF-WAY, PERFORM THE WORK IN ACCORDANCE WITH LOCAL MUNICIPAL STANDARDS.
- 2. WITHIN STATE RIGHTS-OF-WAY, PERFORM THE WORK IN ACCORDANCE WITH THE LATEST EDITION OF THE DEPARTMENT OF TRANSPORTATION'S STANDARD SPECIFICATIONS AND ISSUED REVISIONS/SUPPLEMENTS.
- PROVIDE TRAFFIC SIGNAGE AND PAVEMENT MARKINGS IN CONFORMANCE WITH THE LATEST EDITION OF THE MANUAL OF UNIFORM TRAFFIC CONTROL DEVICES.
- 4. BE RESPONSIBLE FOR SITE SECURITY AND JOB SAFETY. PERFORM CONSTRUCTION ACTIVITIES IN ACCORDANCE WITH OSHA STANDARDS AND LOCAL REQUIREMENTS.
- 5. DISPOSE OF DEMOLITION DEBRIS IN ACCORDANCE WITH APPLICABLE FEDERAL, STATE AND LOCAL REGULATIONS, ORDINANCES AND STATUTES.
- 6. THE OVERALL PROJECT DISTURBANCE WILL BE LESS THAN 5 ACRES AND IS LOCALLY APPROVABLE, THEREFORE A CT-DEEP GENERAL PERMIT FOR THE DISCHARGE OF STORMWATER AND DEWATERING WASTEWATERS FROM

EROSION AND SEDIMENT CONTROL

CONSTRUCTION ACTIVITIES IS NOT REQUIRED.

- 1. INSTALL EROSION CONTROL MEASURES PRIOR TO STARTING ANY WORK ON THE SITE. REFER TO THE EROSION AND SEDIMENT CONTROL DRAWINGS.
- 2. IMPLEMENT ALL NECESSARY MEASURES REQUIRED TO CONTROL STORMWATER RUNOFF, DUST, SEDIMENT, AND DEBRIS FROM EXITING THE SITE. PERFORM CORRECTIVE ACTION AS NEEDED FOR EROSION CLEANUP AND REPAIRS TO OFF SITE AREAS, IF ANY, AT NO COST TO OWNER.
- 3. INSPECT AND MAINTAIN EROSION CONTROL MEASURES PER THE SCHEDULE IN THE EROSION AND SEDIMENT CONTROL DRAWINGS. DISPOSE OF SEDIMENT IN AN UPLAND AREA. DO NOT ENCUMBER OTHER DRAINAGE STRUCTURES AND PROTECTED AREAS.
- 4. PERFORM CONSTRUCTION SEQUENCING IN SUCH A MANNER TO CONTROL EROSION AND TO MINIMIZE THE TIME THAT EARTH MATERIALS ARE EXPOSED BEFORE THEY ARE COVERED, SEEDED, OR OTHERWISE STABILIZED.
- 5. UPON COMPLETION OF CONSTRUCTION AND ESTABLISHMENT OF PERMANENT GROUND COVER, REMOVE AND DISPOSE OF TEMPORARY EROSION CONTROL MEASURES. CLEAN SEDIMENT AND DEBRIS FROM TEMPORARY MEASURES AND FROM PERMANENT STORM DRAIN AND SANITARY SEWER SYSTEMS.

DEMOLITION

1. REMOVE AND DISPOSE OF EXISTING UTILITIES. FOUNDATIONS AND UNSUITABLE MATERIAL BENEATH AND FOR A DISTANCE OF 10 FEET BEYOND THE PROPOSED BUILDING FOOTPRINT INCLUDING EXTERIOR COLUMNS, UNLESS OTHERWISE NOTED.

CONSTRUCTION LAYOUT

- 1. PROVIDE PROPER TRANSITIONS BETWEEN EXISTING AND PROPOSED SITE IMPROVEMENTS. FIELD VERIFY EXISTING PAVEMENT AND GROUND ELEVATIONS AT THE INTERFACE WITH PROPOSED PAVEMENTS AND DRAINAGE STRUCTURES BEFORE START OF CONSTRUCTION.
- PRIOR TO ORDERING MATERIALS AND BEGINNING CONSTRUCTION, FIELD VERIFY PROPOSED UTILITY ROUTES AND IDENTIFY ANY INTERFERENCES OR OBSTRUCTIONS WITH EXISTING UTILITIES OR PUBLIC RIGHTS-OF-WAY.
- 3. IMMEDIATELY INFORM THE ENGINEER IN WRITING IF EXISTING UTILITY CONDITIONS CONFLICT OR DIFFER FROM THAT INDICATED AND IF THE WORK CANNOT BE COMPLETED AS INDICATED.
- 4. DIMENSIONS ARE FROM FACE OF CURB, FACE OF BUILDING, FACE OF WALL, AND CENTER LINE OF PAVEMENT MARKINGS, UNLESS NOTED OTHERWISE.
- 5. BOUNDS OR MONUMENTATION DISTURBED DURING CONSTRUCTION SHALL BE SET OR RESET BY A PROFESSIONAL LICENSED SURVEYOR.

EARTHWORK

- 1. NOTIFY UTILITY LOCATOR SERVICE AT LEAST 72 HOURS BEFORE STARTING EXCAVATION. "CALL BEFORE YOU DIG" AT 1-800-922-4455.
- 2. STOP WORK IN THE VICINITY OF SUSPECTED CONTAMINATED SOIL, GROUNDWATER OR OTHER MEDIA. IMMEDIATELY NOTIFY THE OWNER SO THAT APPROPRIATE TESTING AND SUBSEQUENT ACTION CAN BE TAKEN. RESUME WORK IN THE IMMEDIATE VICINITY ONLY UPON DIRECTION BY THE OWNER.
- WITHIN THE LIMITS OF THE BUILDING FOOTPRINT, PERFORM EARTHWORK OPERATIONS TO SUBGRADE ELEVATIONS. SEE DRAWINGS BY OTHERS FOR WORK ABOVE SUBGRADE.


- TERMINATE EXISTING UTILITIES IN CONFORMANCE WITH LOCAL, STATE AND INDIVIDUAL UTILITY COMPANY STANDARD SPECIFICATIONS AND DETAILS. COORDINATE UTILITY SERVICE DISCONNECTS WITH UTILITY REPRESENTATIVES.
- . THE TYPE, SIZE AND LOCATION OF DEPICTED UNDERGROUND UTILITIES ARE APPROXIMATE REPRESENTATIONS OF INFORMATION OBTAINED FROM FIELD LOCATIONS OF VISIBLE FEATURES, EXISTING MAPS AND PLANS OF RECORD UTILITY MAPPING, AND OTHER SOURCES OF INFORMATION OBTAINED BY THE ENGINEER. ASSUME NO GUARANTEE AS TO THE COMPLETENESS, SERVICEABILITY, EXISTENCE, OR ACCURACY OF UNDERGROUND FACILITIES. FIELD VERIFY THE EXACT LOCATIONS, SIZES, AND ELEVATIONS OF THE POINTS OF CONNECTIONS TO EXISTING UTILITIES.
- 3. PAY ALL FEES AND COSTS ASSOCIATED WITH UTILITY MODIFICATIONS AND CONNECTIONS, REGARDLESS OF THE ENTITY THAT PERFORMS THE WORK.
- 4. COORDINATE THE WORK AND WORK SCHEDULE WITH UTILITY COMPANIES. PROVIDE ADEQUATE NOTICE TO UTILITIES TO PREVENT DELAYS IN CONSTRUCTION.
- 5. INTERIOR DIAMETERS OF STORM DRAIN AND SANITARY SEWER STRUCTURES SHALL BE DETERMINED BY THE PRECAST MANUFACTURER, BASED ON THE INDICATED PIPE SYSTEM LAYOUT AND LOCAL MUNICIPAL STANDARDS
 - MINIMUM INTERIOR DIAMETERS: O TO 20 FEET DEEP; 4 FEET. 20 FEET OR GREATER; 5 FEET.
- 6. RIM ELEVATIONS FOR MANHOLES, VALVE COVERS, GATE AND PULL BOXES, AND OTHER STRUCTURES ARE APPROXIMATE. SET OR RESET RIM ELEVATIONS AS FOLLOWS:
 - IN PAVEMENTS AND CONCRETE SURFACES: FLUSH
 - IN SURFACES ALONG ACCESSIBLE ROUTES: FLUSH IN LANDSCAPE, SEEDED, AND OTHER EARTH SURFACE AREAS: 1 INCH ABOVE SURROUNDING AREA; TAPER EARTH TO RIM ELEVATION.
- 7. INSTALL PROPOSED PRIVATE UTILITY SERVICES ACCORDING TO THE REQUIREMENTS PROVIDED BY. AND APPROVED BY THE AUTHORITY HAVING JURISDICTION (WATER, SEWER, GAS, TELEPHONE, ELECTRIC, FIRE ALARM, ETC.) COORDINATE FINAL DESIGN LOADS AND LOCATIONS WITH OWNER AND ARCHITECT.

PAVEMENT

1. AT A MINIMUM, CONSTRUCT ACCESSIBLE ROUTES, PARKING SPACES, RAMPS, SIDEWALKS AND WALKWAYS IN CONFORMANCE WITH THE FEDERAL AMERICANS WITH DISABILITIES ACT AND WITH STATE AND LOCAL LAWS AND REGULATIONS (WHICHEVER ARE MORE STRINGENT).

SITE RESTORATION

- 1. PROVIDE 6 INCHES OF TOPSOIL AND SEED TO AREAS DISTURBED DURING CONSTRUCTION AND NOT DESIGNATED TO BE RESTORED WITH IMPERVIOUS SURFACES (BUILDINGS, PAVEMENTS, WALKS, ETC.) UNLESS OTHERWISE NOTED.
- 2. REPAIR DAMAGES RESULTING FROM CONSTRUCTION LOADS, AT NO ADDITIONAL COST TO OWNER.
- . RESTORE AREAS DISTURBED BY CONSTRUCTION OPERATIONS TO THEIR ORIGINAL CONDITION OR BETTER, AT NO ADDITIONAL COST TO OWNER.
- 4. RESTORE ANY TRAFFIC CONTROLS OR PAVEMENT MARKINGS THAT HAVE BEEN MODIFIED TEMPORARILY FOR CONSTRUCTION BACK TO THEIR ORIGINAL CONDITION OR BETTER, UNLESS OTHERWISE SPECIFIED

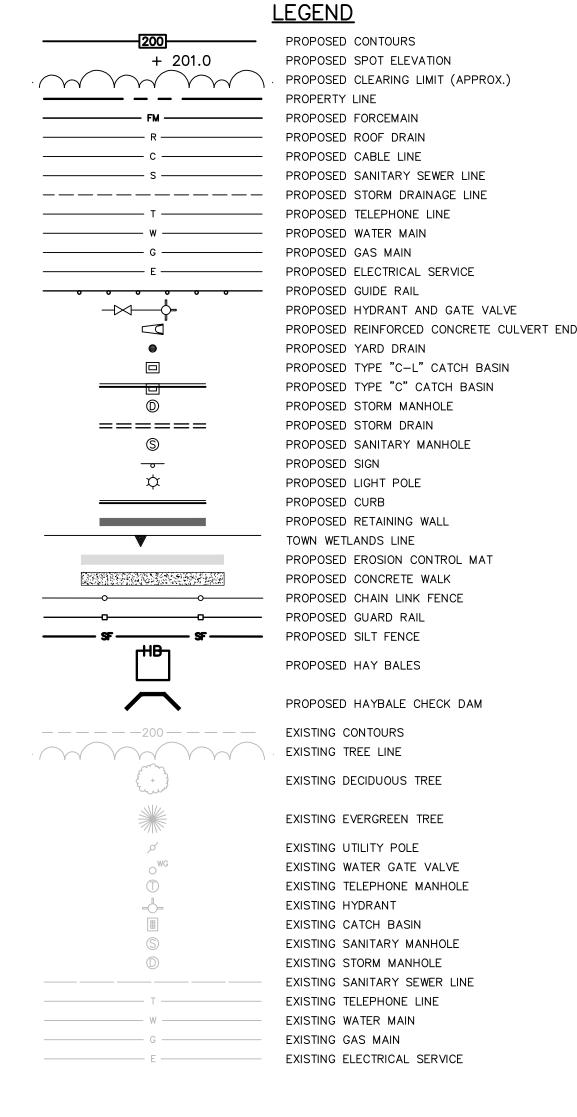



CALL-BEFORE-YOU-DIG: THE CONTRACTOR SHALL BE RESPONSIBLE FOR NOTIFYING "CALL BEFORE YOU DIG" AT 1-800-922-4455 TO ARRANGE FOR MARKING OUT EXISTING UNDERGROUND UTILITIES 1-800-922-4455 AT LEAST TWO WORKING DAYS PRIOR TO

SURVEY MAP REFERENCE

"PROPERTY BOUNDARY AND TOPOGRAPHIC SURVEY PREPARED FOR LWLP NEW HAVEN LLC" PREPARED BY FUSS & O'NEILL, INC., SHEET 1 OF 1, DATED MAY 4, 2016, REVISED THROUGH JUNE 15, 2020, SCALE: 1"=40', DATUM: NAD27/NGVD29.

PLAN CERTIFICATION

FUSS & O'NEILL CERTIFIES TO THE BEST OF ITS KNOWLEDGE, BELIEF, AND ABILITY, AND AFTER RESEARCH AND INQUIRY, THAT THE PROPOSED SITE PLANS INCLUDED HEREIN MEET ALL OF THE STANDARDS OF THE NEW HAVEN ZONING ORDINANCE UNLESS OTHERWISE NOTED.

STORMWATER MANAGEMENT OPERATIONS AND MAINTENANCE NOTES:

LONG TERM STORMWATER MANAGEMENT MAINTENANCE SHOULD BE COMPLETED IN ACCORDANCE WITH THE 2004 CONNECTICUT STORMWATER QUALITY MANUAL.

STORMWATER TREATMENT UNIT / CATCH BASIN / INLET SUMPS — STORMWATER TREATMENT UNIT / CATCH BASIN / INLET SUMPS MUST BE INSPECTED AT REGULAR INTERVALS AND CLEANED WHEN NECESSARY. AT A MINIMUM, INSPECTIONS SHOULD BE CONDUCTED TWICE PER YEAR. ONCE IN THE SPRING AND AGAIN IN THE FALL. MORE INSPECTIONS MAY BE REQUIRED DURING WINTER MONTHS WHERE HEAVY SANDING OPERATIONS MAY LEAD TO RAPID SEDIMENT ACCUMULATION WITHIN THE STRUCTURE. CATCH BASINS SHOULD BE CLEANED IF THE DEPTH OF SEDIMENT IN THE SUMP IS GREATER THAN OR EQUAL TO 1/2 THE DEPTH FROM THE BOTTOM OF THE BASIN TO THE INVERT OF THE LOWEST PIPE IN THE BASIN. CLEANING OPERATIONS ARE TYPICALLY DONE USING A VACUUM TRUCK.


BIOSWALE PLANTERS / DEPRESSED GRASSED ISLAND - REGULAR MAINTENANCE IS CRITICAL FOR THE EFFECTIVENESS OF THESE FEATURES. SEMI-ANNUAL INSPECTIONS ARE RECOMMENDED DURING THE FIRST YEAR (AND ANNUALLY THEREAFTER). THESE AREAS SHOULD BE INSPECTED FOR EROSION, BARE SPOTS, AND OVERALL HEALTH. TRASH AND DEBRIS SHOULD BE REMOVED ON A REGULAR BASIS.

SUBSURFACE INFILTRATION SYSTEM - AT A MINIMUM, ANNUAL INSPECTIONS OF THE SUBSURFACE INFILTRATION SYSTEM SHOULD BE CONDUCTED. INITIALLY, THE ISOLATOR ROW SHOULD BE INSPECTED EVERY 6 MONTHS FOR THE FIRST YEAR OF OPERATION. FOR SUBSEQUENT YEARS, THE INSPECTION SHOULD BE ADJUSTED BASED UPON PREVIOUS OBSERVATION OF SEDIMENT DEPOSITION. THE SYSTEM INCORPORATES A COMBINATION OF A STANDARD MANHOLE AND STRATEGICALLY LOCATED INSPECTION PORTS TO VISUALLY INSPECT THE SYSTEM. THE INSPECTION PORTS ALLOW FOR EASY ACCESS TO THE SYSTEM FROM THE SURFACE, ELIMINATING THE NEED TO PERFORM A CONFINED SPACE ENTRY FOR INSPECTION PURPOSES. IF UPON VISUAL INSPECTION IT IS FOUND THAT SEDIMENT HAS ACCUMULATED, A STADIA ROD SHOULD BE INSERTED TO DETERMINE THE DEPTH OF SEDIMENT. WHEN THE AVERAGE DEPTH OF SEDIMENT EXCEEDS 3 INCHES THROUGHOUT THE LENGTH OF THE FIRST ROW OF THE SYSTEM, CLEAN-OUT SHOULD BE PERFORMED.

THE PROPERTY OWNER / MANAGER SHALL BE RESPONSIBLE FOR STORMWATER MANAGEMENT SYSTEM AND MAINTENANCE.

THE PROPERTY OWNER / MANAGER SHALL MAINTAIN AND CLEAN THE STORMWATER TREATMENT UNIT / CATCH BASIN / INLET DRAIN SUMPS, INFILTRATION SYSTEM, AND BIOSWALES TO ENSURE EFFECTIVE OPERATION OF THE STORMWATER MANAGEMENT SYSTEM.



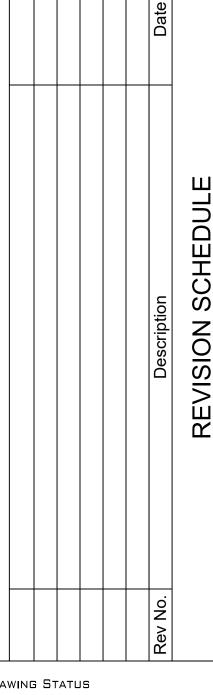

DRAWING STATUS

PERMIT SET NOT FOR CONSTRUCTION



PROJECT

SQUARE 10 Phase 1C

New Haven, Connecticut


DWG TITLE **GENERAL NOTES &** LEGEND

JOB NO. 20130554.S14 11/17/22


SCALE N.T.S.

GRAPHIC SCALE

DC, DF

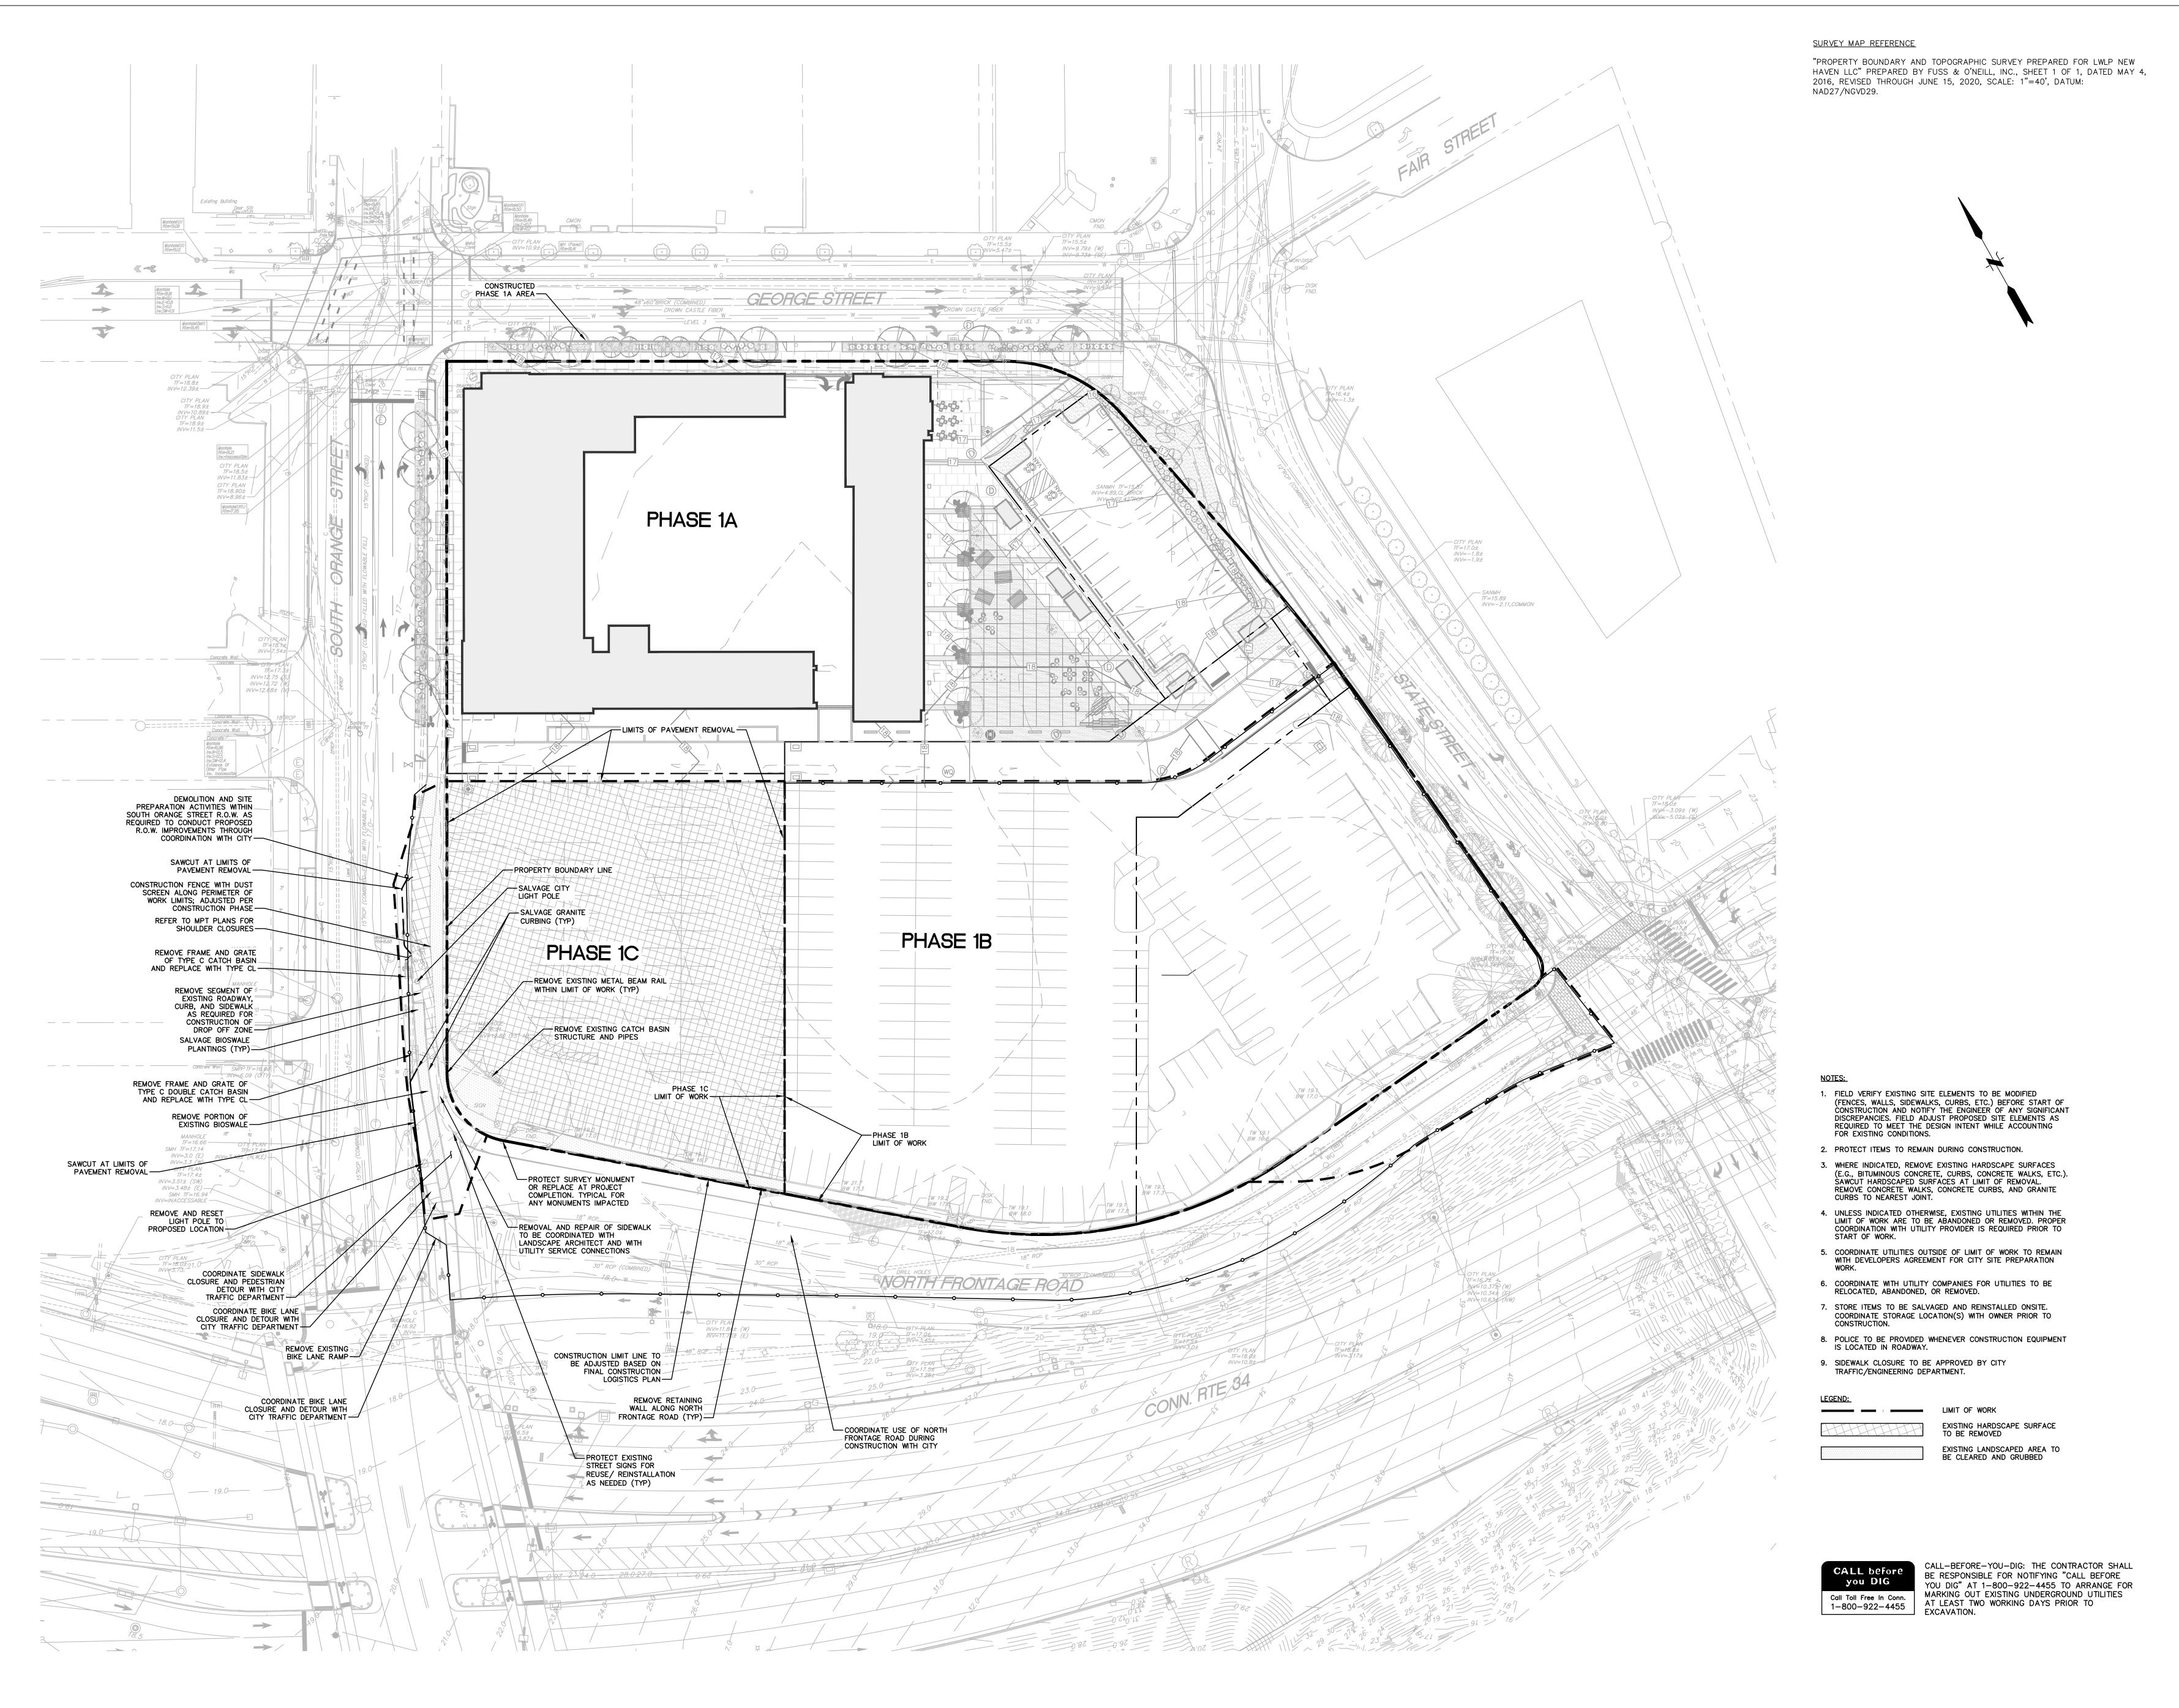

FUSS & O'NEILL
59 ELM STREET, SUITE 500
NEW HAVEN, CONNECTICUT 06510
203.374.3748
www.fando.com

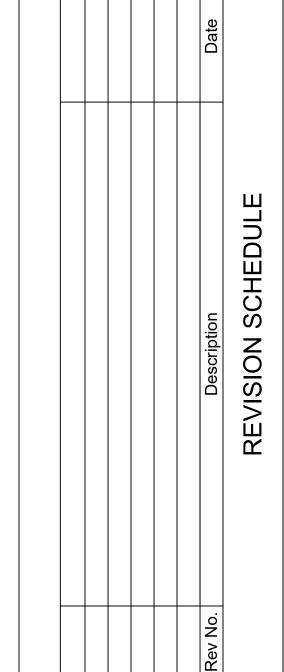

DRAWING STATUS

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PROJECT

DWG TITLE

SCALE

SQUARE 10 Phase 1C

DRESS

New Haven, Connecticut


SITE PREPARATION PLAN

JOB NO. 20130554.S14


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"PROPERTY BOUNDARY AND TOPOGRAPHIC SURVEY PREPARED FOR LWLP NEW HAVEN LLC" PREPARED BY FUSS & O'NEILL, INC., SHEET 1 OF 1, DATED MAY 4, 2016, REVISED THROUGH JUNE 15, 2020, SCALE: 1"=40', DATUM:



- 1. SYMBOLS AND LEGENDS OF PROJECT FEATURES ARE GRAPHIC REPRESENTATIONS AND ARE NOT NECESSARILY SHOWN ON THE DRAWINGS TO SCALE OR TO THEIR ACTUAL DIMENSION OR LOCATION. COORDINATE DETAIL SHEET DIMENSIONS, MANUFACTURERS' LITERATURE, SHOP DRAWINGS AND FIELD MEASUREMENTS OF SUPPLIED PRODUCTS FOR LAYOUT OF THE PROJECT
- 2. DO NOT RELY SOLELY ON ELECTRONIC VERSIONS OF DRAWINGS, SPECIFICATIONS, AND DATA FILES THAT ARE PROVIDED BY THE ENGINEER. FIELD VERIFY LOCATION OF PROJECT FEATURES.
- 3. PERFORM NECESSARY CONSTRUCTION NOTIFICATIONS, APPLY FOR AND OBTAIN NECESSARY PERMITS, PAY FEES, AND POST BONDS ASSOCIATED WITH THE WORK AS REQUIRED BY THE CONTRACT DOCUMENTS.
- 4. SEE ARCHITECTURAL DRAWINGS FOR DIMENSIONS OF BUILDINGS AND ADJACENT SITE ELEMENTS INCLUDING SIDEWALKS, RAMPS, BUILDING ENTRANCES, STAIRWAYS, UTILITY PENETRATIONS, CONCRETE DOOR PADS, ETC.
- 1. PROVIDE PROPER TRANSITIONS BETWEEN EXISTING AND PROPOSED SITE IMPROVEMENTS. FIELD VERIFY EXISTING PAVEMENT AND GROUND ELEVATIONS AT THE INTERFACE WITH PROPOSED PAVEMENTS AND SITE ELEMENTS BEFORE
- 2. PRIOR TO ORDERING MATERIALS AND BEGINNING CONSTRUCTION, FIELD VERIFY PROPOSED UTILITY ROUTES AND IDENTIFY ANY INTERFERENCES OR
- 3. IMMEDIATELY INFORM THE ENGINEER IN WRITING IF EXISTING UTILITY CONDITIONS CONFLICT OR DIFFER FROM THAT INDICATED AND IF THE WORK CANNOT BE
- 4. DIMENSIONS ARE FROM FACE OF CURB, FACE OF BUILDING, FACE OF WALL, AND CENTER LINE OF PAVEMENT MARKINGS, UNLESS NOTED OTHERWISE.
- 5. BOUNDS OR MONUMENTATION DISTURBED DURING CONSTRUCTION SHALL BE SET OR RESET BY A PROFESSIONAL LICENSED SURVEYOR.
- NOTIFY UTILITY LOCATOR SERVICE AT LEAST 72 HOURS BEFORE STARTING
- "CALL BEFORE YOU DIG" AT 1-800-922-4455.
- STOP WORK IN THE VICINITY OF SUSPECTED CONTAMINATED SOIL, GROUNDWATER OR OTHER MEDIA. IMMEDIATELY NOTIFY THE OWNER SO THAT APPROPRIATE TESTING AND SUBSEQUENT ACTION CAN BE TAKEN. RESUME WORK IN THE IMMEDIATE VICINITY ONLY UPON DIRECTION BY THE OWNER.
- THE TYPE, SIZE AND LOCATION OF DEPICTED UNDERGROUND UTILITIES ARE APPROXIMATE REPRESENTATIONS OF INFORMATION OBTAINED FROM FIELD LOCATIONS OF VISIBLE FEATURES, EXISTING MAPS AND PLANS OF RECORD, UTILITY MAPPING, AND OTHER SOURCES OF INFORMATION OBTAINED BY THE ENGINEER. ASSUME NO GUARANTEE AS TO THE COMPLETENESS, SERVICEABILITY, EXISTENCE, OR ACCURACY OF UNDERGROUND FACILITIES. FIELD VERIFY THE EXACT LOCATIONS, SIZES, AND ELEVATIONS OF THE POINTS OF
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- PROVIDE 6 INCHES OF TOPSOIL AND SEED TO AREAS DISTURBED DURING CONSTRUCTION AND NOT DESIGNATED TO BE RESTORED WITH IMPERVIOUS SURFACES (BUILDINGS, PAVEMENTS, WALKS, ETC.) UNLESS OTHERWISE NOTED.
- 2. REPAIR DAMAGES RESULTING FROM CONSTRUCTION LOADS, AT NO ADDITIONAL
- 3. RESTORE AREAS DISTURBED BY CONSTRUCTION OPERATIONS TO THEIR ORIGINAL CONDITION OR BETTER, AT NO ADDITIONAL COST TO OWNER.
- 4. REFER TO LANDSCAPING PLANS.

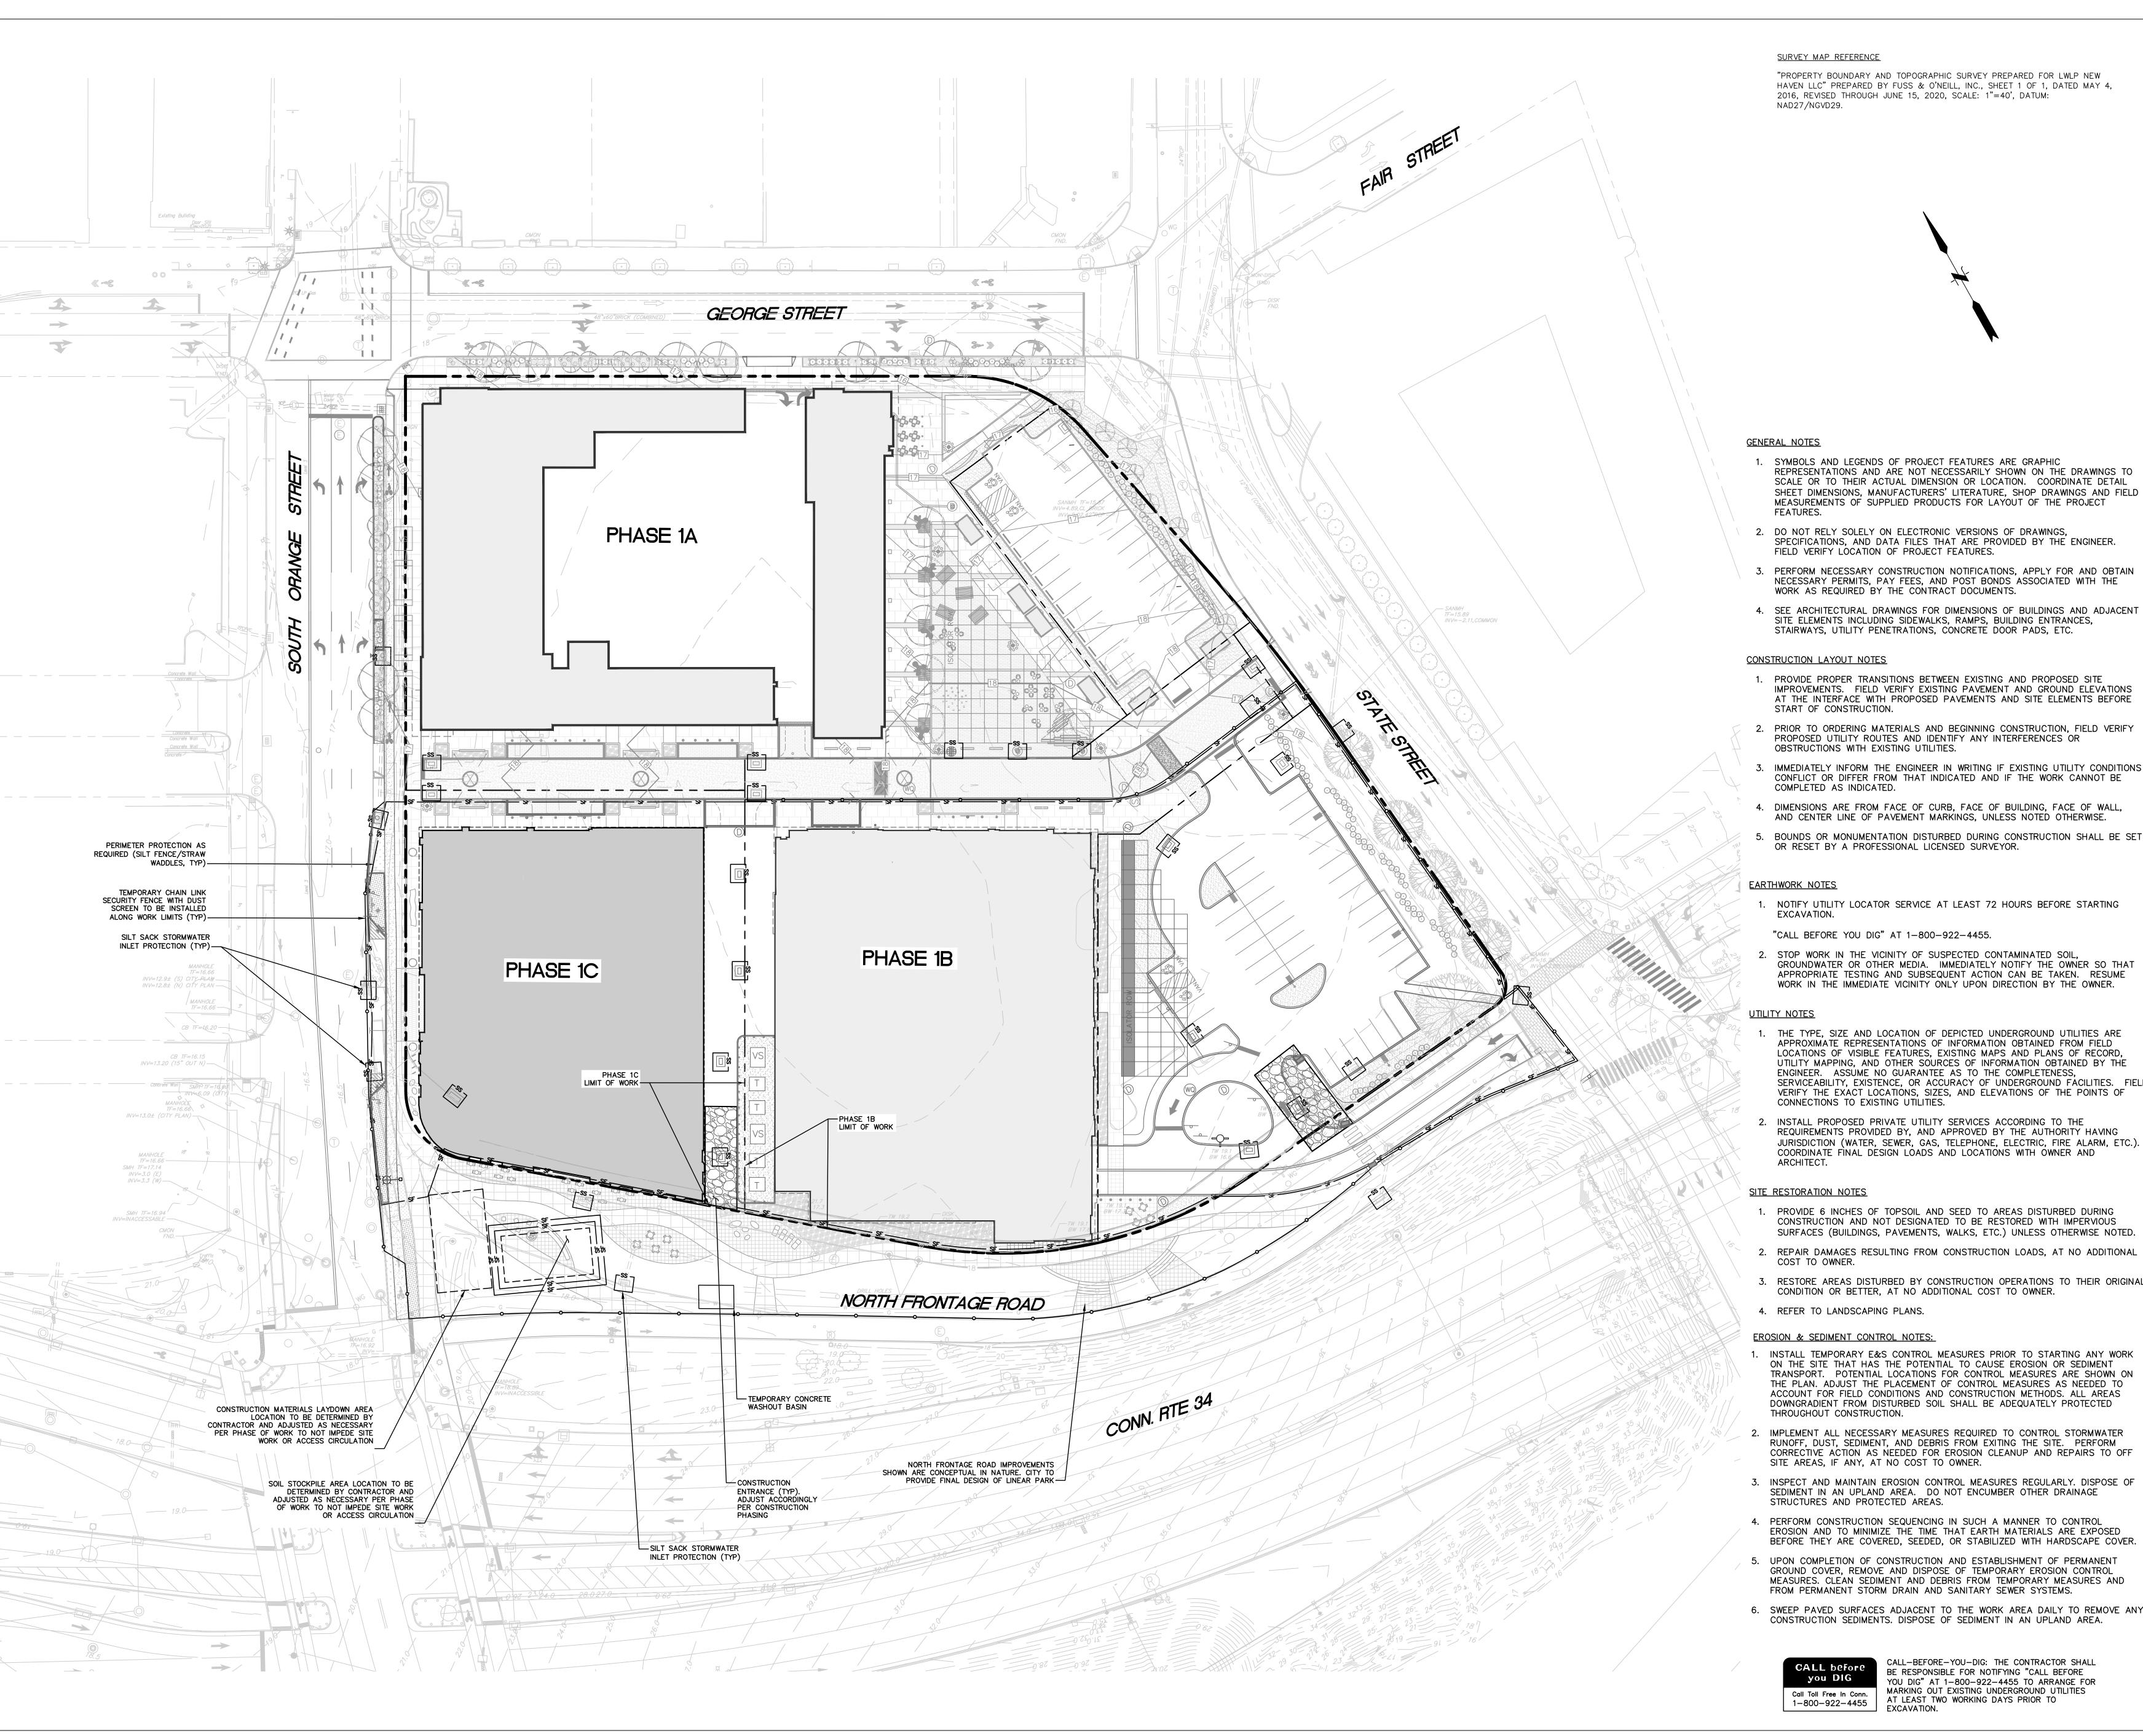
EROSION & SEDIMENT CONTROL NOTES:

- 1. INSTALL TEMPORARY E&S CONTROL MEASURES PRIOR TO STARTING ANY WORK ON THE SITE THAT HAS THE POTENTIAL TO CAUSE EROSION OR SEDIMENT TRANSPORT. POTENTIAL LOCATIONS FOR CONTROL MEASURES ARE SHOWN ON THE PLAN. ADJUST THE PLACEMENT OF CONTROL MEASURES AS NEEDED TO ACCOUNT FOR FIELD CONDITIONS AND CONSTRUCTION METHODS. ALL AREAS DOWNGRADIENT FROM DISTURBED SOIL SHALL BE ADEQUATELY PROTECTED
- IMPLEMENT ALL NECESSARY MEASURES REQUIRED TO CONTROL STORMWATER RUNOFF, DUST, SEDIMENT, AND DEBRIS FROM EXITING THE SITE. PERFORM CORRECTIVE ACTION AS NEEDED FOR EROSION CLEANUP AND REPAIRS TO OFF
- 3. INSPECT AND MAINTAIN EROSION CONTROL MEASURES REGULARLY. DISPOSE OF SEDIMENT IN AN UPLAND AREA. DO NOT ENCUMBER OTHER DRAINAGE STRUCTURES AND PROTECTED AREAS.
- 4. PERFORM CONSTRUCTION SEQUENCING IN SUCH A MANNER TO CONTROL EROSION AND TO MINIMIZE THE TIME THAT EARTH MATERIALS ARE EXPOSED
- 5. UPON COMPLETION OF CONSTRUCTION AND ESTABLISHMENT OF PERMANENT GROUND COVER, REMOVE AND DISPOSE OF TEMPORARY EROSION CONTROL MEASURES. CLEAN SEDIMENT AND DEBRIS FROM TEMPORARY MEASURES AND
- 6. SWEEP PAVED SURFACES ADJACENT TO THE WORK AREA DAILY TO REMOVE ANY CONSTRUCTION SEDIMENTS. DISPOSE OF SEDIMENT IN AN UPLAND AREA.

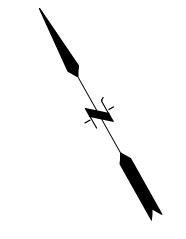

CALL-BEFORE-YOU-DIG: THE CONTRACTOR SHALL BE RESPONSIBLE FOR NOTIFYING "CALL BEFORE YOU DIG" AT 1-800-922-4455 TO ARRANGE FOR MARKING OUT EXISTING UNDERGROUND UTILITIES AT LEAST TWO WORKING DAYS PRIOR TO EXCAVATION.



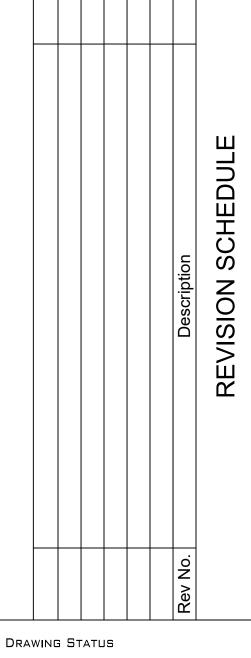

PERMIT SET NOT FOR CONSTRUCTION



SQUARE 10 Phase 1C

New Haven, Connecticut


EROSION AND SEDIMENT

CONTROL PLAN


JOB NO. 20130554.S14

11/17/22 SCALE 1" = 30"

GRAPHIC SCALE DRAWN BY DC, DF

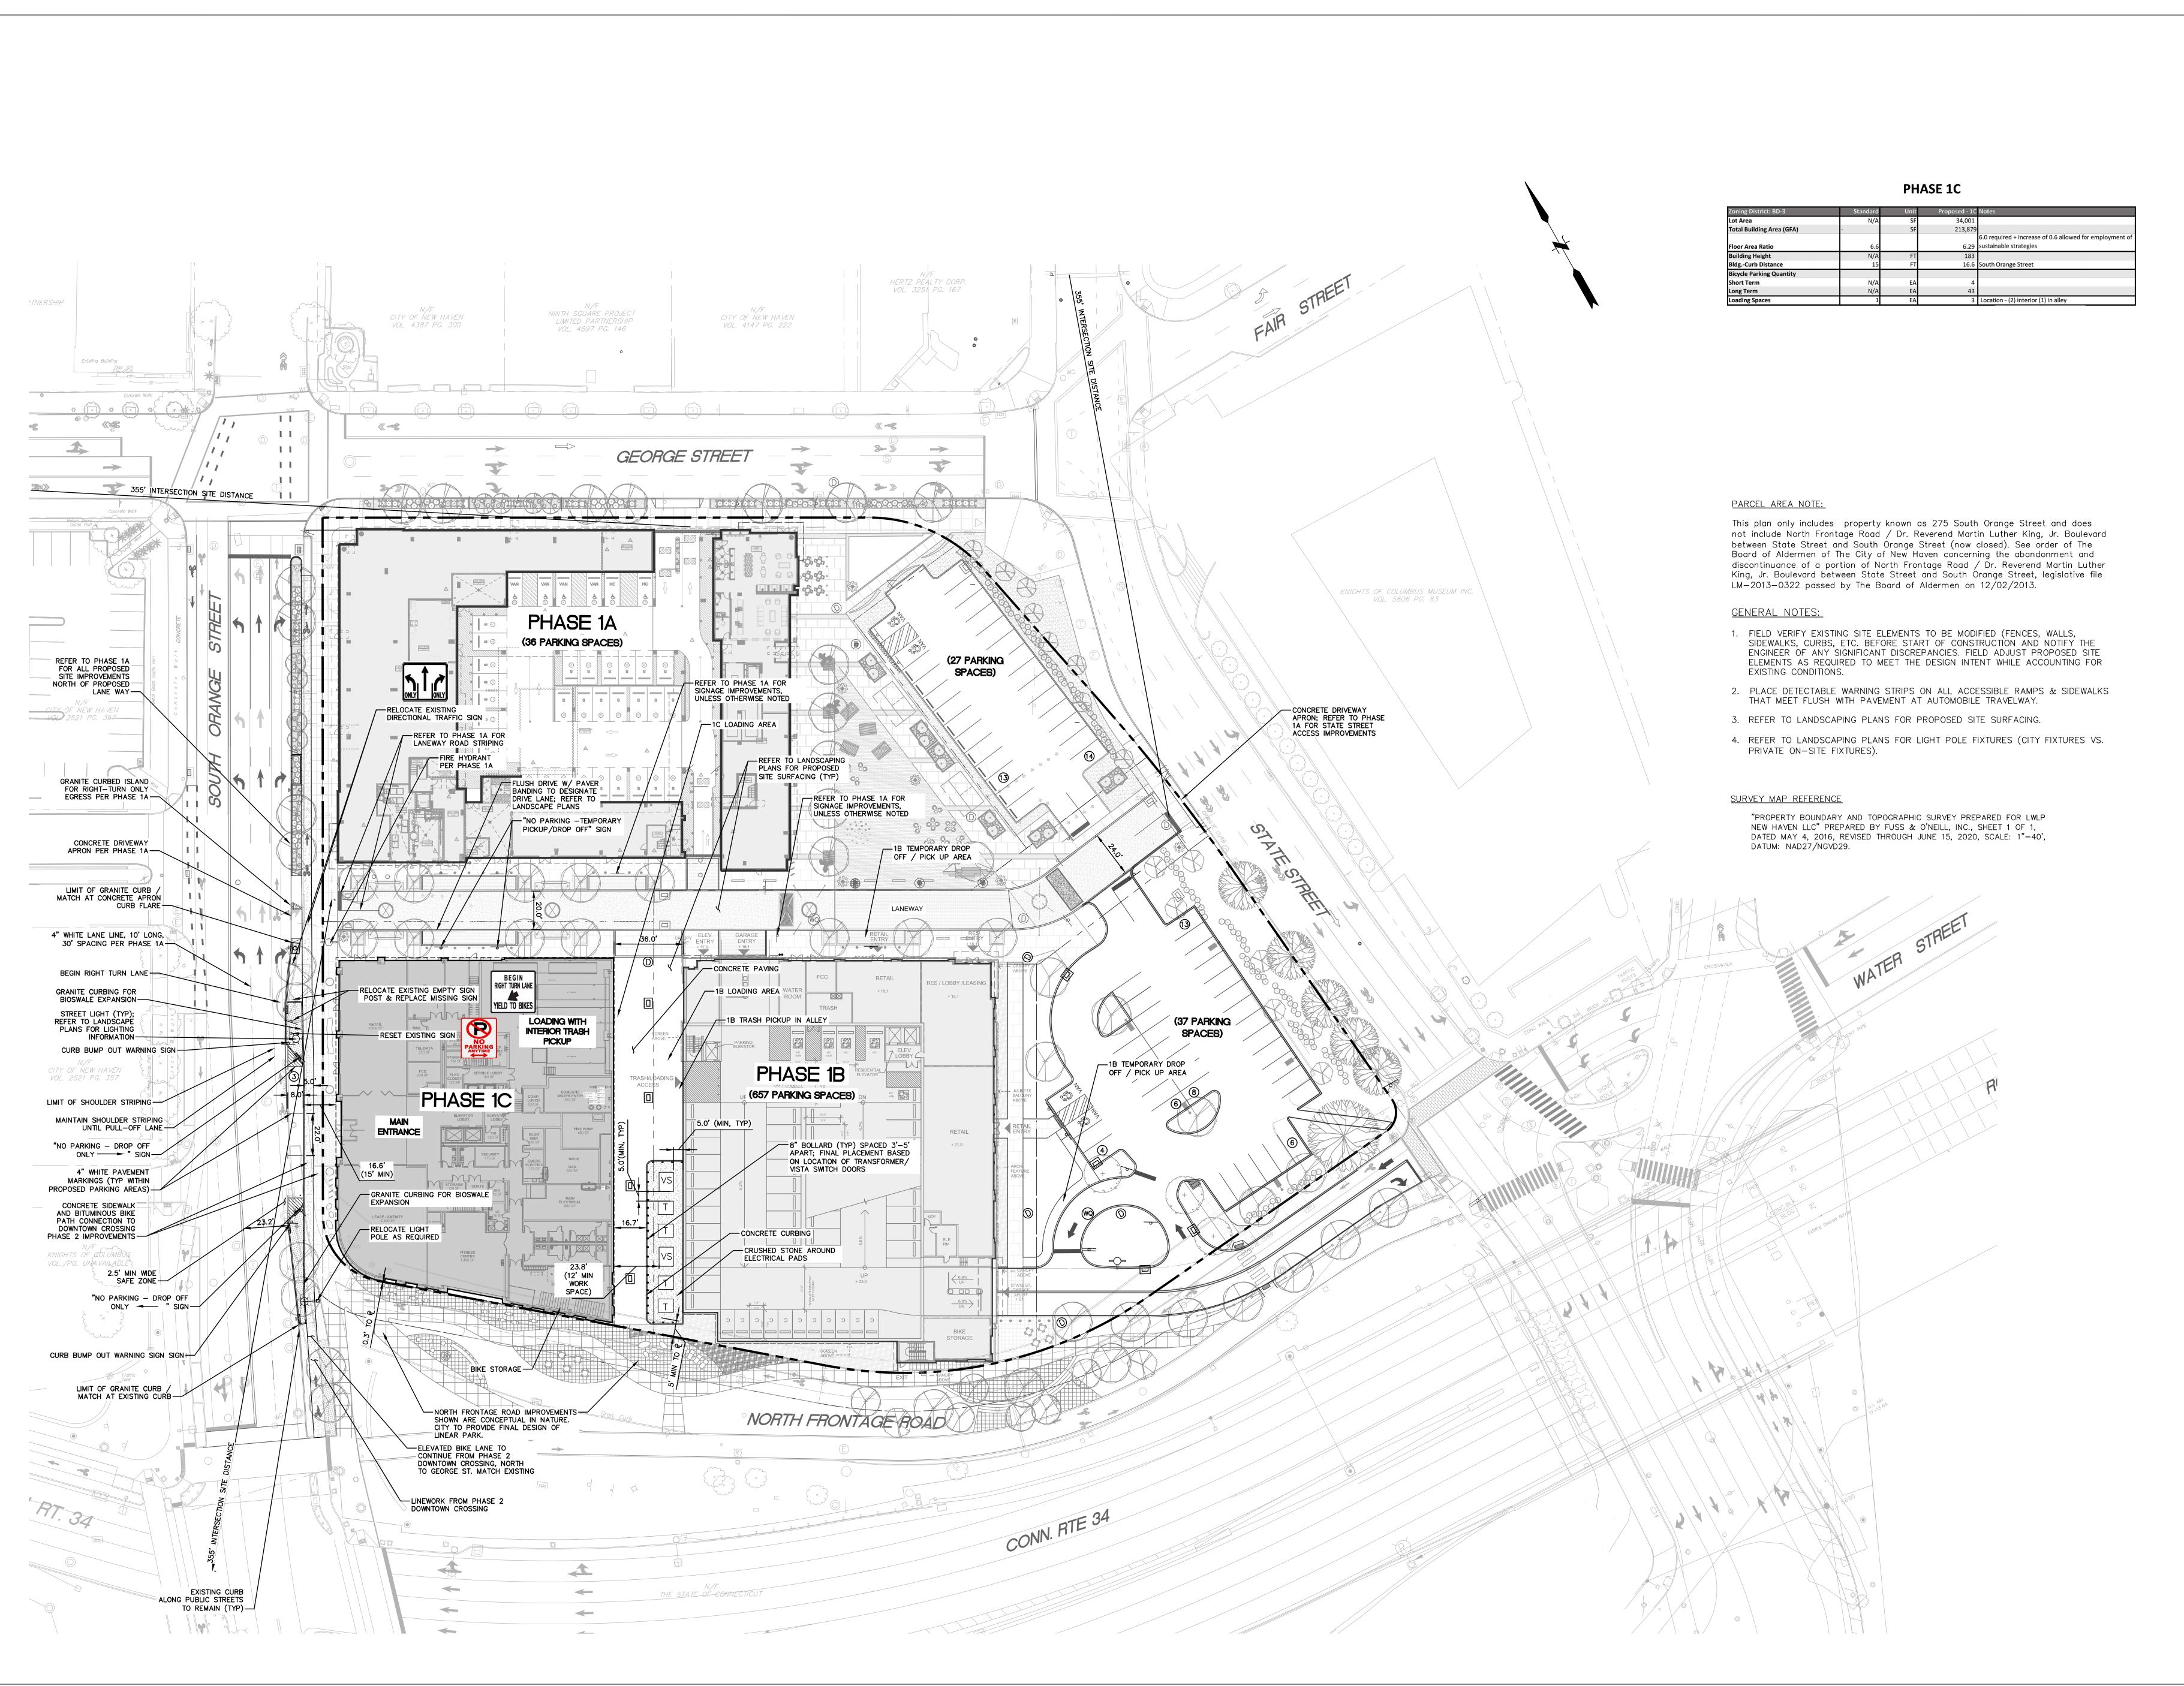



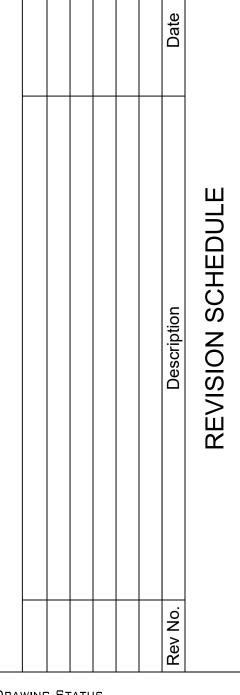

DRAWING STATUS

PERMIT SET

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PROJECT

Phase 1C

SQUARE 10

New Haven, Connecticut

DWG TITLE

SITE LAYOUT PLAN

JOB NO. 20130554.S14


11/17/22


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1" = 30'

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CS-101



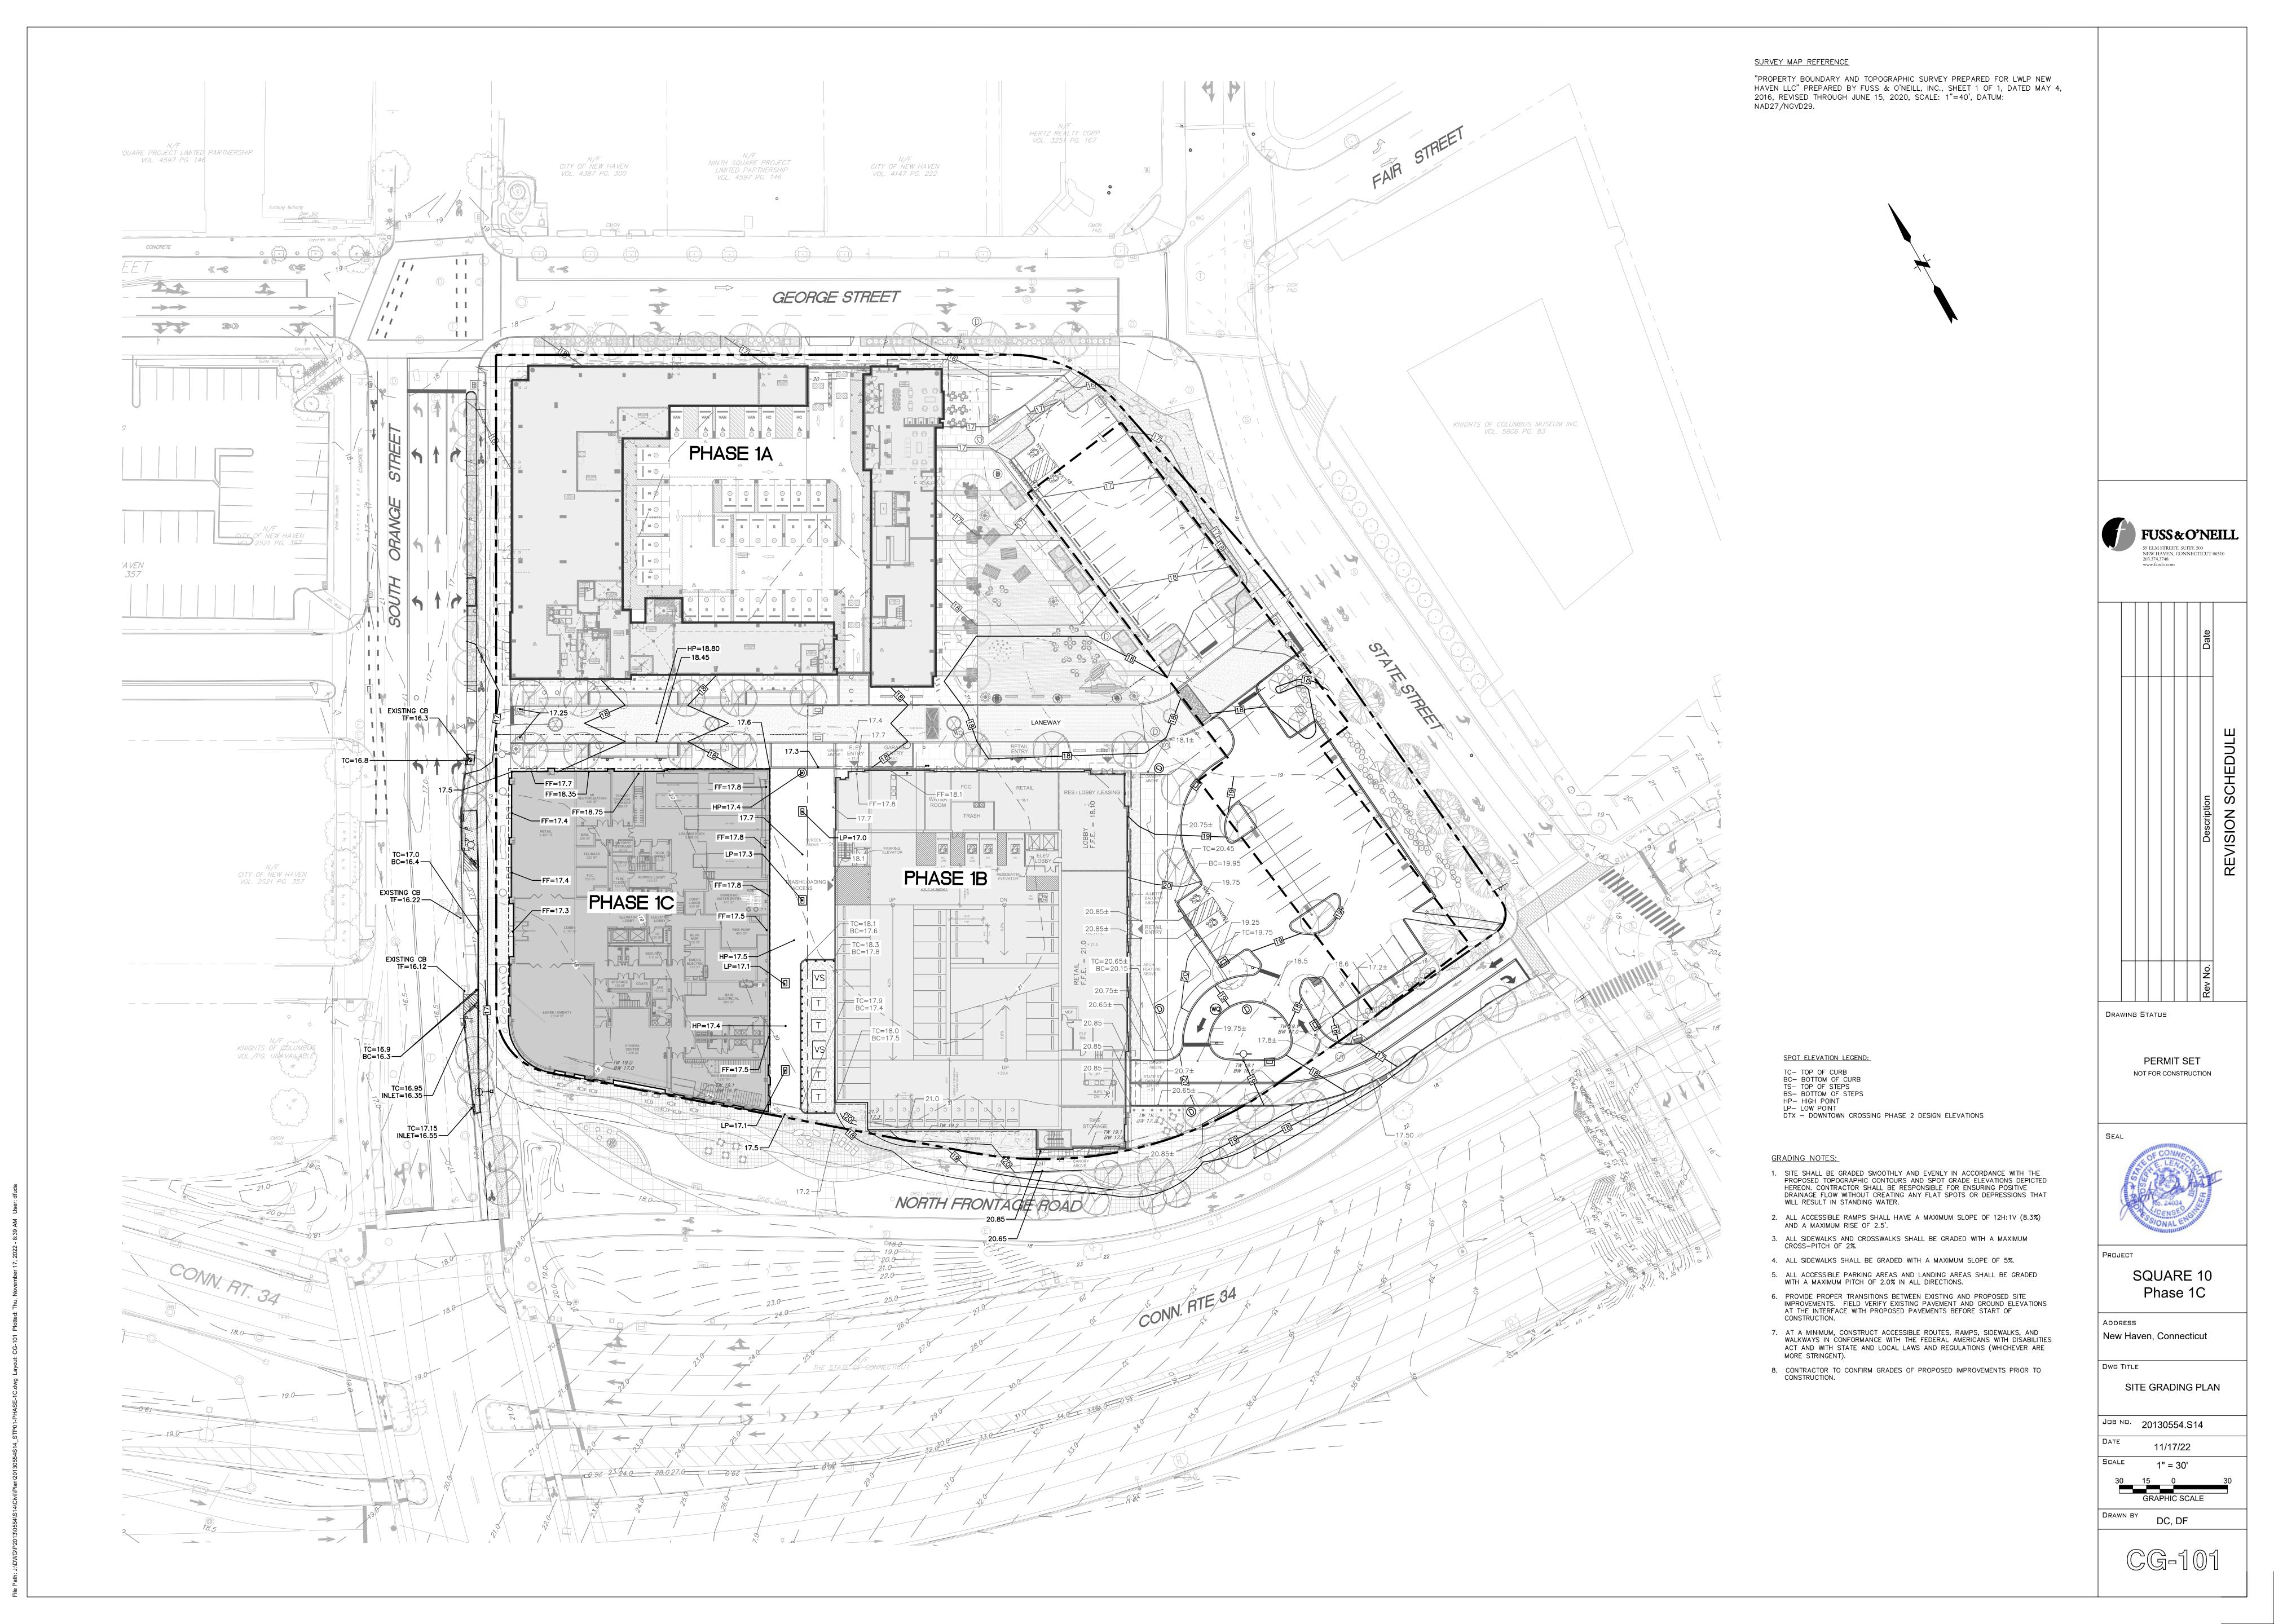

"PROPERTY BOUNDARY AND TOPOGRAPHIC SURVEY PREPARED FOR LWLP NEW HAVEN LLC" PREPARED BY FUSS & O'NEILL, INC., SHEET 1 OF 1, DATED MAY 4, 2016, REVISED THROUGH JUNE 15, 2020, SCALE: 1"=40', DATUM:

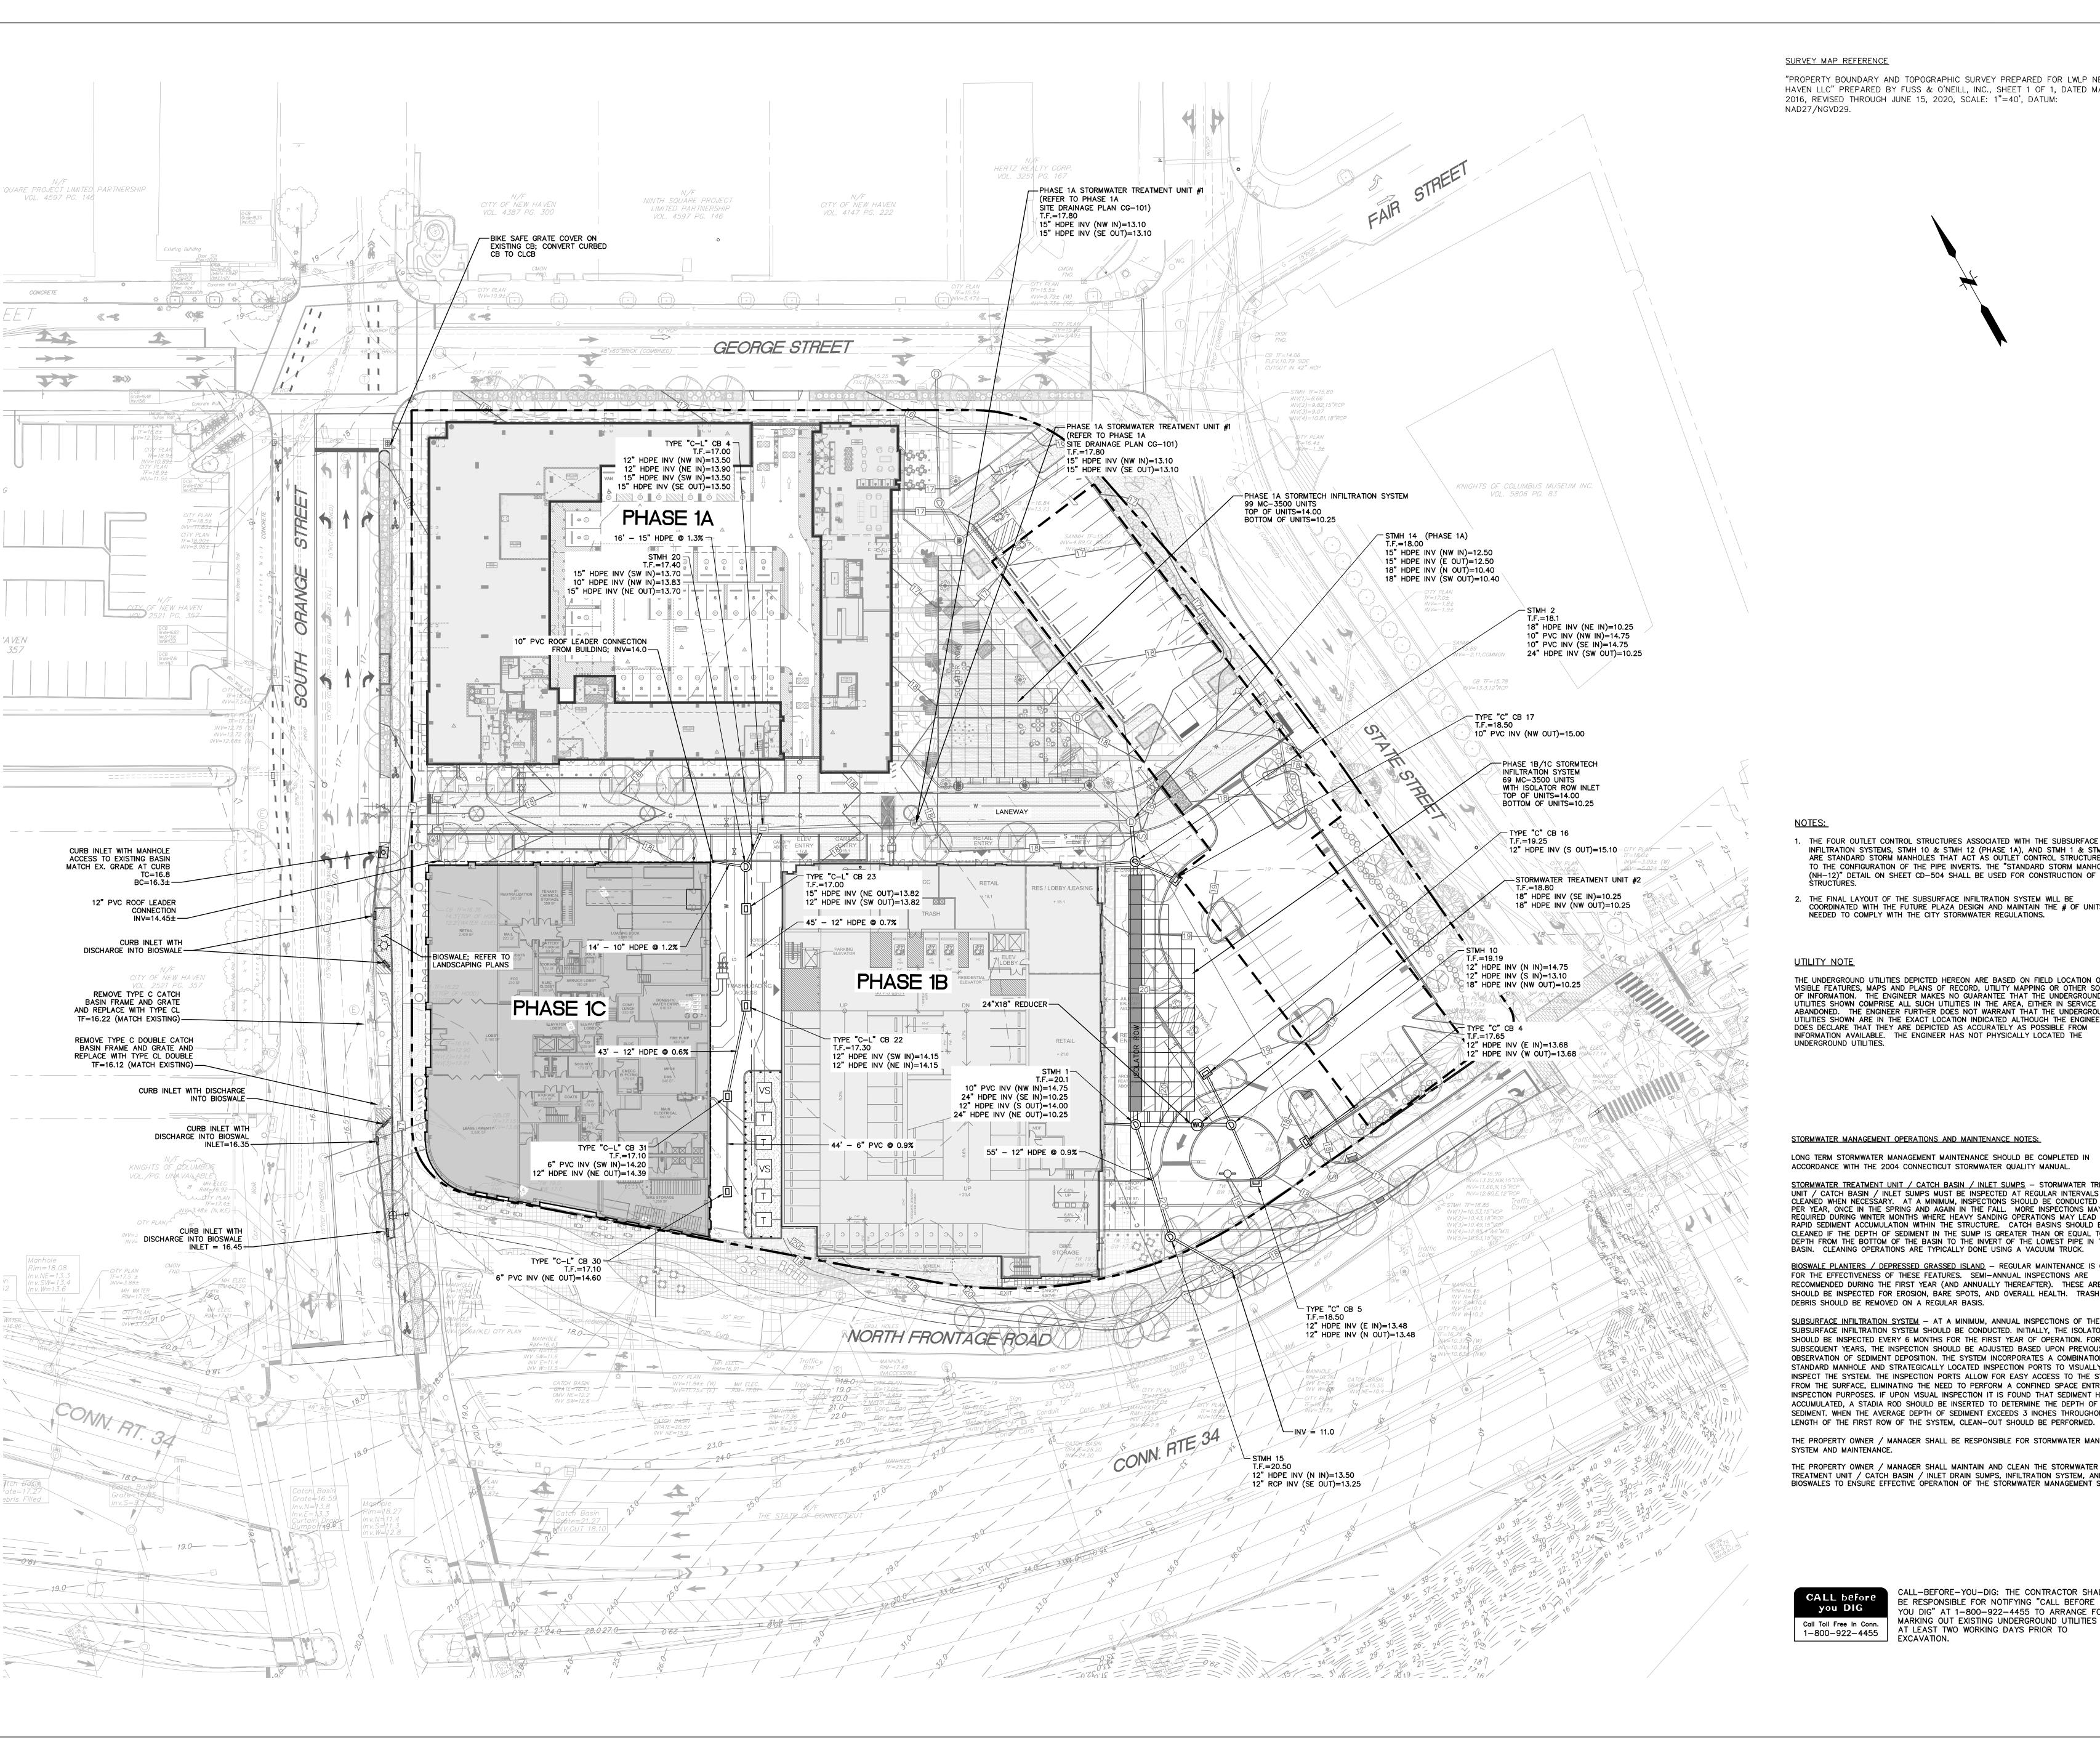

- 1. THE FOUR OUTLET CONTROL STRUCTURES ASSOCIATED WITH THE SUBSURFACE INFILTRATION SYSTEMS, STMH 10 & STMH 12 (PHASE 1A), AND STMH 1 & STMH 2 ARE STANDARD STORM MANHOLES THAT ACT AS OUTLET CONTROL STRUCTURES DUE TO THE CONFIGURATION OF THE PIPE INVERTS. THE "STANDARD STORM MANHOLES (NH-12)" DETAIL ON SHEET CD-504 SHALL BE USED FOR CONSTRUCTION OF THESE
- 2. THE FINAL LAYOUT OF THE SUBSURFACE INFILTRATION SYSTEM WILL BE COORDINATED WITH THE FUTURE PLAZA DESIGN AND MAINTAIN THE # OF UNITS NEEDED TO COMPLY WITH THE CITY STORMWATER REGULATIONS.

THE UNDERGROUND UTILITIES DEPICTED HEREON ARE BASED ON FIELD LOCATION OF VISIBLE FEATURES, MAPS AND PLANS OF RECORD, UTILITY MAPPING OR OTHER SOURCES OF INFORMATION. THE ENGINEER MAKES NO GUARANTEE THAT THE UNDERGROUND UTILITIES SHOWN COMPRISE ALL SUCH UTILITIES IN THE AREA, EITHER IN SERVICE OR ABANDONED. THE ENGINEER FURTHER DOES NOT WARRANT THAT THE UNDERGROUND UTILITIES SHOWN ARE IN THE EXACT LOCATION INDICATED ALTHOUGH THE ENGINEER DOES DECLARE THAT THEY ARE DEPICTED AS ACCURATELY AS POSSIBLE FROM

STORMWATER MANAGEMENT OPERATIONS AND MAINTENANCE NOTES:

LONG TERM STORMWATER MANAGEMENT MAINTENANCE SHOULD BE COMPLETED IN

STORMWATER TREATMENT UNIT / CATCH BASIN / INLET SUMPS - STORMWATER TREATMENT UNIT / CATCH BASIN / INLET SUMPS MUST BE INSPECTED AT REGULAR INTERVALS AND CLEANED WHEN NECESSARY. AT A MINIMUM, INSPECTIONS SHOULD BE CONDUCTED TWICE PER YEAR, ONCE IN THE SPRING AND AGAIN IN THE FALL. MORE INSPECTIONS MAY BE REQUIRED DURING WINTER MONTHS WHERE HEAVY SANDING OPERATIONS MAY LEAD TO RAPID SEDIMENT ACCUMULATION WITHIN THE STRUCTURE. CATCH BASINS SHOULD BE CLEANED IF THE DEPTH OF SEDIMENT IN THE SUMP IS GREATER THAN OR EQUAL TO ½ THE DEPTH FROM THE BOTTOM OF THE BASIN TO THE INVERT OF THE LOWEST PIPE IN THE

BIOSWALE PLANTERS / DEPRESSED GRASSED ISLAND - REGULAR MAINTENANCE IS CRITICAL FOR THE EFFECTIVENESS OF THESE FEATURES. SEMI-ANNUAL INSPECTIONS ARE RECOMMENDED DURING THE FIRST YEAR (AND ANNUALLY THEREAFTER). THESE AREAS SHOULD BE INSPECTED FOR EROSION, BARE SPOTS, AND OVERALL HEALTH. TRASH AND

SUBSURFACE INFILTRATION SYSTEM - AT A MINIMUM, ANNUAL INSPECTIONS OF THE SUBSURFACE INFILTRATION SYSTEM SHOULD BE CONDUCTED. INITIALLY, THE ISOLATOR ROW SHOULD BE INSPECTED EVERY 6 MONTHS FOR THE FIRST YEAR OF OPERATION. FOR SUBSEQUENT YEARS, THE INSPECTION SHOULD BE ADJUSTED BASED UPON PREVIOUS OBSERVATION OF SEDIMENT DEPOSITION. THE SYSTEM INCORPORATES A COMBINATION OF A STANDARD MANHOLE AND STRATEGICALLY LOCATED INSPECTION PORTS TO VISUALLY INSPECT THE SYSTEM. THE INSPECTION PORTS ALLOW FOR EASY ACCESS TO THE SYSTEM FROM THE SURFACE, ELIMINATING THE NEED TO PERFORM A CONFINED SPACE ENTRY FOR INSPECTION PURPOSES. IF UPON VISUAL INSPECTION IT IS FOUND THAT SEDIMENT HAS ACCUMULATED, A STADIA ROD SHOULD BE INSERTED TO DETERMINE THE DEPTH OF SEDIMENT. WHEN THE AVERAGE DEPTH OF SEDIMENT EXCEEDS 3 INCHES THROUGHOUT THE

THE PROPERTY OWNER / MANAGER SHALL BE RESPONSIBLE FOR STORMWATER MANAGEMENT

THE PROPERTY OWNER / MANAGER SHALL MAINTAIN AND CLEAN THE STORMWATER TREATMENT UNIT / CATCH BASIN / INLET DRAIN SUMPS, INFILTRATION SYSTEM, AND BIOSWALES TO ENSURE EFFECTIVE OPERATION OF THE STORMWATER MANAGEMENT SYSTEM.

CALL—BEFORE—YOU—DIG: THE CONTRACTOR SHALL BE RESPONSIBLE FOR NOTIFYING "CALL BEFORE YOU DIG" AT 1—800—922—4455 TO ARRANGE FOR MARKING OUT EXISTING UNDERGROUND UTILITIES AT LEAST TWO WORKING DAYS PRIOR TO EXCAVATION.



PERMIT SET

NOT FOR CONSTRUCTION

DRAWING STATUS

PROJECT SQUARE 10

Phase 1C

New Haven, Connecticut


DWG TITLE SITE DRAINAGE PLAN

JOB NO. 20130554.S14

11/17/22 SCALE 1" = 30'


GRAPHIC SCALE DRAWN BY DC, DF

CG-102

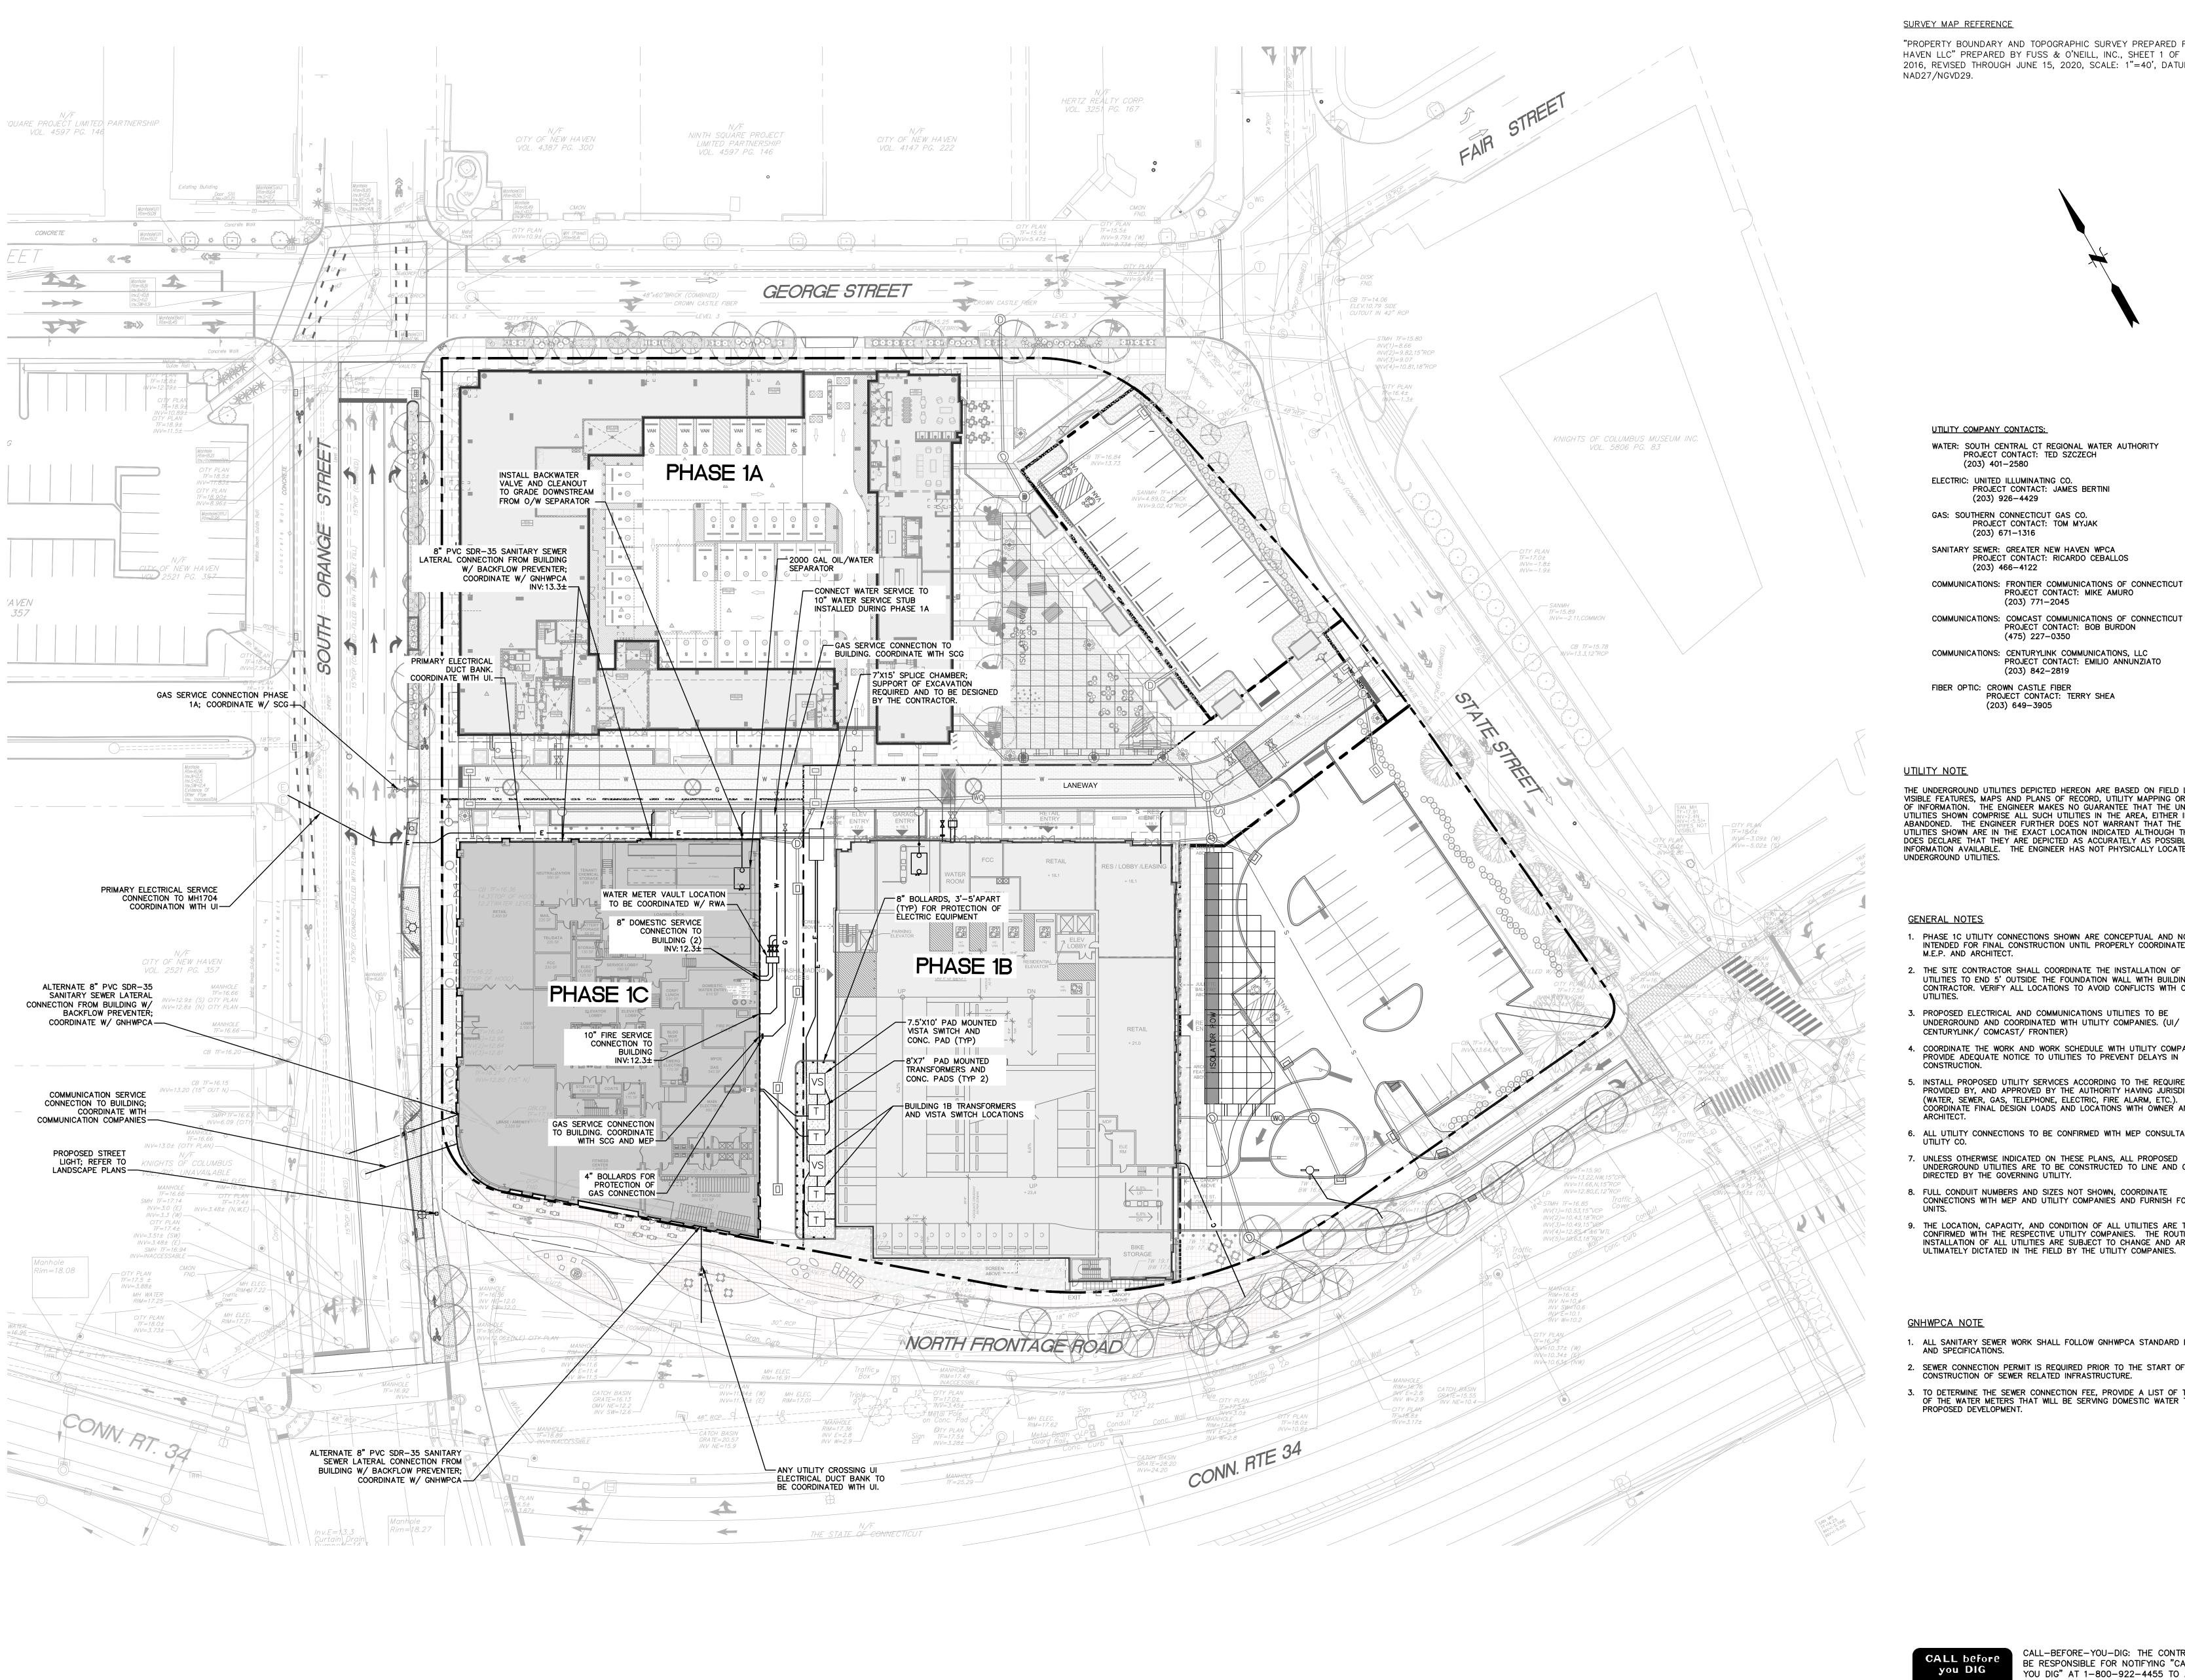

SURVEY MAP REFERENCE

"PROPERTY BOUNDARY AND TOPOGRAPHIC SURVEY PREPARED FOR LWLP NEW HAVEN LLC" PREPARED BY FUSS & O'NEILL, INC., SHEET 1 OF 1, DATED MAY 4, 2016, REVISED THROUGH JUNE 15, 2020, SCALE: 1"=40', DATUM: NAD27/NGVD29.

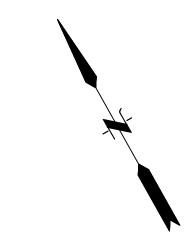

UTILITY COMPANY CONTACTS:

WATER: SOUTH CENTRAL CT REGIONAL WATER AUTHORITY PROJECT CONTACT: TED SZCZECH (203) 401-2580

ELECTRIC: UNITED ILLUMINATING CO.
PROJECT CONTACT: JAMES BERTINI (203) 926-4429

GAS: SOUTHERN CONNECTICUT GAS CO.

(203) 671-1316 SANITARY SEWER: GREATER NEW HAVEN WPCA

PROJECT CONTACT: TOM MYJAK

PROJECT CONTACT: RICARDO CEBALLOS (203) 466-4122 COMMUNICATIONS: FRONTIER COMMUNICATIONS OF CONNECTICUT

PROJECT CONTACT: MIKE AMURO (203) 771-2045

PROJECT CONTACT: BOB BURDON (475) 227-0350 COMMUNICATIONS: CENTURYLINK COMMUNICATIONS, LLC

PROJECT CONTACT: EMILIO ANNUNZIATO (203) 842-2819

FIBER OPTIC: CROWN CASTLE FIBER
PROJECT CONTACT: TERRY SHEA (203) 649-3905

UTILITY NOTE

THE UNDERGROUND UTILITIES DEPICTED HEREON ARE BASED ON FIELD LOCATION OF VISIBLE FEATURES, MAPS AND PLANS OF RECORD, UTILITY MAPPING OR OTHER SOURCES OF INFORMATION. THE ENGINEER MAKES NO GUARANTEE THAT THE UNDERGROUND UTILITIES SHOWN COMPRISE ALL SUCH UTILITIES IN THE AREA, EITHER IN SERVICE OR ABANDONED. THE ENGINEER FURTHER DOES NOT WARRANT THAT THE UNDERGROUND UTILITIES SHOWN ARE IN THE EXACT LOCATION INDICATED ALTHOUGH THE ENGINEER DOES DECLARE THAT THEY ARE DEPICTED AS ACCURATELY AS POSSIBLE FROM INFORMATION AVAILABLE. THE ENGINEER HAS NOT PHYSICALLY LOCATED THE UNDERGROUND UTILITIES.

GENERAL NOTES

- 1. PHASE 1C UTILITY CONNECTIONS SHOWN ARE CONCEPTUAL AND NOT INTENDED FOR FINAL CONSTRUCTION UNTIL PROPERLY COORDINATED WITH
- 2. THE SITE CONTRACTOR SHALL COORDINATE THE INSTALLATION OF ALL UTILITIES TO END 5' OUTSIDE THE FOUNDATION WALL WITH BUILDING CONTRACTOR. VERIFY ALL LOCATIONS TO AVOID CONFLICTS WITH OTHER
- 3. PROPOSED ELECTRICAL AND COMMUNICATIONS UTILITIES TO BE UNDERGROUND AND COORDINATED WITH UTILITY COMPANIES. (UI/
- 4. COORDINATE THE WORK AND WORK SCHEDULE WITH UTILITY COMPANIES. PROVIDE ADEQUATE NOTICE TO UTILITIES TO PREVENT DELAYS IN
- 5. INSTALL PROPOSED UTILITY SERVICES ACCORDING TO THE REQUIREMENTS PROVIDED BY, AND APPROVED BY THE AUTHORITY HAVING JURISDICTION (WATER, SEWER, GAS, TELEPHONE, ELECTRIC, FIRE ALARM, ETC.). COORDINATE FINAL DESIGN LOADS AND LOCATIONS WITH OWNER AND
- 6. ALL UTILITY CONNECTIONS TO BE CONFIRMED WITH MEP CONSULTANT AND
- 7. UNLESS OTHERWISE INDICATED ON THESE PLANS, ALL PROPOSED UNDERGROUND UTILITIES ARE TO BE CONSTRUCTED TO LINE AND GRADE AS
- 8. FULL CONDUIT NUMBERS AND SIZES NOT SHOWN, COORDINATE CONNECTIONS WITH MEP AND UTILITY COMPANIES AND FURNISH FOR ALL
- 9. THE LOCATION, CAPACITY, AND CONDITION OF ALL UTILITIES ARE TO BE CONFIRMED WITH THE RESPECTIVE UTILITY COMPANIES. THE ROUTING & INSTALLATION OF ALL UTILITIES ARE SUBJECT TO CHANGE AND ARE ULTIMATELY DICTATED IN THE FIELD BY THE UTILITY COMPANIES.

GNHWPCA NOTE

- 1. ALL SANITARY SEWER WORK SHALL FOLLOW GNHWPCA STANDARD DETAILS AND SPECIFICATIONS.
- 2. SEWER CONNECTION PERMIT IS REQUIRED PRIOR TO THE START OF CONSTRUCTION OF SEWER RELATED INFRASTRUCTURE.
- 3. TO DETERMINE THE SEWER CONNECTION FEE, PROVIDE A LIST OF THE SIZE OF THE WATER METERS THAT WILL BE SERVING DOMESTIC WATER TO THE PROPOSED DEVELOPMENT.


CALL before
you DIG

Call Toll Free in Conn.

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AT 1 FAST TWO WORKING DAYS PRIOR TO 1-800-922-4455

AT LEAST TWO WORKING DAYS PRIOR TO EXCAVATION.



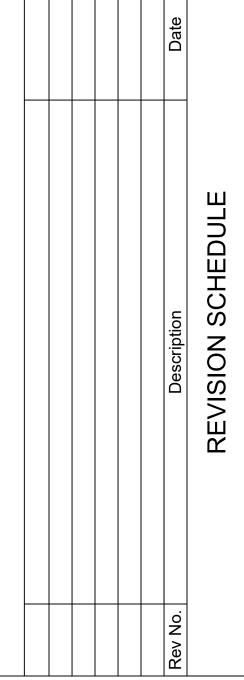

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PROJECT

SQUARE 10 Phase 1C

New Haven, Connecticut

DWG TITLE

SITE UTILITY PLAN

JOB NO. 20130554.S14

11/17/22 SCALE 1" = 30'

GRAPHIC SCALE

DC, DF